WATER HEATER SCHEDULE							
SYMBOL	LOCATION/	STORAGE	GPH		ELECTRICAL CRITERIA	NOTES	
MODEL NO.			REC./TEMP. RISE*	OUTLET TEMPERATURE	KW INPUT		
EWH-1	UNDER KITCHEN SINK (SEE PLAN) / CHRONOMITE #ER-90L/277_24900	INSTANT	1.5 GPM/70°	120°F	24.9	7, 8	
EWH-2	GUARDHOUSE TOILET / CHRONOMITE #CM-15L/208-ADJ	INSTANT	0.35 GPM/61°	104°F	3.12	7, 8	
EWH-3	OFFICE JANITOR ROOM /A.O. SMITH #DSE-80	80	61/80°	125°F	12.0	1-7	
EWH-4	SAFETY SHOWER AREA/ EEMAX #AP108480-EFD-N4-FDS	INSTANT	23 GPM/32°	85°F	108	7, 8	
EWH-5	JANITOR ROOM / A.O. SMITH #DEL-20	20	23/80°	125°F	4.5	1-7	
EWH-6	JANITOR ROOM / A.O. SMITH #DSE-80	80	31/80°	125°F	6	1-7	
EWH-7	JANITOR ROOM / A.O. SMITH #DSE-80	80	46/80°	125°F	9.0	1-7	
EWH-8	JANITOR ROOM / A.O. SMITH # DEL-10	10	23/80°	125°F	4.5	1-7	
EWH-9	TRUCKER TOILET / CHRONOMITE #CM-15L/277-ADJ	INSTANT	0.35 GPM/81°	104°F	4.15	7, 8	

. PROVIDE T&P RELIEF VALVE AND VACUUM RELIEF VALVE

- PROVIDE GATE/BALL VALVES WITH UNIONS AND DIELECTRIC FITTINGS ON WATER INLET AND OUTLET CONNECTIONS. . ALL UNITS SHALL MEET ASHRAE 90.1 AND ALL LOCAL CODE REQUIREMENTS. ALL GAS FIRED UNITS SHALL BE AGA CERTIFIED.
- 1. DESIGN BASIS: A.O. SMITH, CHRONOMITE AND EEMAX. PROVIDE HEAT TRAP OR HEAT TRAP NIPPLES AT WATER HEATER WATER SUPPLY CONNECTIONS.
- PROVIDE MANUFACTURED WATER EXPANSION RELIEF DEVICE, WATTS PLT-5 SERIES EXPANSION TANK(PROVIDE PLT-12 FOR EWH-3/6/7). COORDINATE ELECTRICAL REQUIREMENTS WITH ELECTRICAL.
- . PROVIDE BALL VALVE WITH UNION AND DIELECTRIC FITTINGS ON WATER INLET; PROVIDE UNION AND DIELECTRIC FITTINGS ON WATER OUTLET.

	FIXTURE CONNECT	TON SC	HEDULE			
		MINIMUM SIZE UTILITY TO FIXTURE				
FIXTURE #	FIXTURE TYPE	WASTE CONNECTION	HOT WATER SUPPLY	COLD WATER SUPPLY		
WC-1	WATER CLOSET - FLUSH VALVE WALL HUNG	4"		1"		
WC-1H	WATER CLOSET - FLUSH VALVE WALL HUNG - H.C.	4"		1"		
WC-2	WATER CLOSET - FLUSH VALVE FLOOR MOUNTED	4"		1"		
L-1	LAVATORY - WALL-HUNG	1 1/4"	1/2"	1/2"		
L-2	LAVATORY - UNDERMOUNT	1 1/4"	1/2"	1/2"		
UR-1	URINAL - WALL HUNG FLUSH VALVE	2"		3/4"		
UR-1H	URINAL - WALL HUNG FLUSH VALVE - H.C.	2"		3/4"		
MS-1	MOP SINK	3"	1/2"	1/2"		
MS-2	MOP SINK	3"	1/2"	1/2"		
KS-1	SINK - TWO COMPARTMENT	1 1/2"	1/2"	1/2"		
KS-2	SINK - SINGLE COMPARTMENT	1 1/2"	1/2"	1/2"		
EWC-1	DRINKING FOUNTAIN	1 1/2"		1/2"		
SS-1	SAFETY SHOWER	-	1-1/4" (TEPID WATER)	-		
HB/NFHB/ NFHB-R	HOSE BIBB	-		3/4"		
FOOTBATH STATION	FOOTBATH STATION	2"	1/2"	1/2"		

PUMP SCHEDULE							
SERVICE/ LOCATION	MANUFACTURER MODEL#	TYPE	FLOW (GPM)	HEAD (PSI/FT)	RPM	HP	NOTES
ELEVATOR/ ELEVATOR PIT	STANCOR SE-100	SUBMERSIBLE	50	15.48/36	3450	1	3
HOT WATER/ SEE PLAN	TACO 113	IN-LINE	5	6.9/16	1725	1/8	1, 3
HOT WATER/ SEE PLAN	TACO 112	IN-LINE	3.5	9/22	3450	1/3	1, 3
DOMESTIC WATER / SEE PLAN	VC SYSTEMS DUPLEX	END SUCTION	340 (TOTAL)	96/222	3500	20/20	2, 3
	LOCATION ELEVATOR/ ELEVATOR PIT HOT WATER/ SEE PLAN HOT WATER/ SEE PLAN DOMESTIC WATER / SEE PLAN	LOCATION MODEL # ELEVATOR/ ELEVATOR PIT STANCOR SE-100 HOT WATER/ SEE PLAN TACO 113 HOT WATER/ SEE PLAN TACO 112 DOMESTIC WATER / SEE PLAN VC SYSTEMS DUPLEX	LOCATION MODEL # ELEVATOR/ ELEVATOR PIT STANCOR SE-100 SUBMERSIBLE HOT WATER/ SEE PLAN TACO 113 IN-LINE HOT WATER/ SEE PLAN TACO 112 IN-LINE DOMESTIC WATER / SEE PLAN VC SYSTEMS DUPLEX END SUCTION	LOCATION MODEL # (GPM) ELEVATOR/ ELEVATOR PIT STANCOR SE-100 SUBMERSIBLE 50 HOT WATER/ SEE PLAN TACO 113 IN-LINE 5 HOT WATER/ SEE PLAN TACO 112 IN-LINE 3.5 DOMESTIC WATER VC SYSTEMS DUPLEX END SUCTION (TOTAL)	LOCATION MODEL # (GPM) (PSI/FT) ELEVATOR/ ELEVATOR PIT STANCOR SE-100 SUBMERSIBLE 50 15.48/36 HOT WATER/ SEE PLAN TACO 113 IN-LINE 5 6.9/16 HOT WATER/ SEE PLAN TACO 112 IN-LINE 3.5 9/22 DOMESTIC WATER VC SYSTEMS DUPLEX END SUCTION 340 96/222	LOCATION MODEL # (GPM) (PSI/FT) ELEVATOR/ ELEVATOR PIT STANCOR SE-100 SUBMERSIBLE 50 15.48/36 3450 HOT WATER/ SEE PLAN TACO 113 IN-LINE 5 6.9/16 1725 HOT WATER/ SEE PLAN TACO 112 IN-LINE 3.5 9/22 3450 DOMESTIC WATER / SEE PLAN VC SYSTEMS DUPLEX END SUCTION 340 (TOTAL) 96/222 3500	LOCATION MODEL # (GPM) (PSI/FT) ELEVATOR/ ELEVATOR PIT STANCOR SE-100 SUBMERSIBLE 50 15.48/36 3450 1 HOT WATER/ SEE PLAN TACO 113 IN-LINE 5 6.9/16 1725 1/8 HOT WATER/ SEE PLAN TACO 112 IN-LINE 3.5 9/22 3450 1/3 DOMESTIC WATER / SEE PLAN VC SYSTEMS DUPLEX END SUCTION 340 (TOTAL) 96/222 3500 20/20

TACO CIRCULATOR WITH 265-3 DIGITAL TIMER. SET FLOW RATE(GPM) PER ENLARGED PLANS. 2. DUPLEX SYSTEM FLOW: 340 GPM(TOTAL).

EACH DOMESTIC WATER BOOSTER PUMP AT 65% OF SYSTEM CAPACITY 221 GPM W/ 222' TDH. MODEL NO. 2VC-PMC-VH-20-430-460

3. COORDINATE ELECTRICAL REQUIREMENTS WITH ELECTRICAL

FLOW TEST DATA SCHEDULE UPON AWARD OF THE CONTRACT, THE FIRE PROTECTION CONTRACTOR SHALL PERFORM A FLOW TEST ON THE TWO HYDRANTS NEAREST THE SITE AND FORWARD THE TEST DATA TO THE ENGINEER AND ARCHITECT. THE FOLLOWING WATER PRESSURE/FLOW DATA WAS OBTAINED FROM: HARRINGTON GROUP, INC STATIC PRESSURE (PSI) 38 RESIDUAL PRESSURE (PSI) FLOW (GPM) 1281 **ELEVATION OF TEST HYDRANT** INTERSECTION OF CORPORATE LOCATION OF TEST HYDRANT DRIVE AND HWY 421 DATE OF TEST 04-26-2024 TIME OF DAY OF TEST 11:00 AM

DRAINAGE PRODUCTS/SPECIALTIES

UNLESS OTHERWISE INDICATED NUMBERS ARE JAY R. SMITH. APPROVED EQUAL PRODUCTS: ZURN, JOSAM, WADE, WATTS AND PRECISION PLUMBING PRODUCTS

CO-EXPOSED CLEANOUT - UNFINISHED AREAS JAY R. SMITH FIG. 4420 CAST BRONZE COUNTERSUNK PLUG WITH SLOT TO RECEIVE 1/2" THICK STEEL BAR STOCK.

WCO-WALL CLEANOUT - FINISHED AREAS JAY R. SMITH FIG. 4436 C.I. FERRULE FOR NO HUB OR SERVICE WEIGHT PIPE, NICKEL BRONZE ROUND FRAME AND COVER WITH SECURING SCREWS.

FCO-CONCRETE FLOORS JAY R. SMITH FIG. 4220 C.I. CLEANOUT WITH GASKET SEAL THREADED PLUG FOR EASY REMOVAL, ADJUSTABLE ROUND CAST IRON TOP WITH SECURING SCREW, SPEEDI-SET OUTLET

FCO-TILE FLOORS JAY R. SMITH FIG. 4020 C.I. CLEANOUT WITH GASKET SEAL THREADED PLUG, ADJUSTABLE ROUND NICKEL BRONZE TOP, SPEEDI-SET OUTLET CONNECTION.

FCO-CARPETED FLOORS JAY R. SMITH FIG. 4020-Y C.I. CLEANOUT WITH GASKET SEAL THREADED PLUG, ADJUSTABLE ROUND NICKEL BRONZE TOP COMPLETE WITH STAINLESS STEEL CARPET MARKER WITH SECURING SCREW, SPEEDI-SET OUTLET CONNECTION.

YCO-EXTERIOR PAVED/CONCRETE AREAS JAY R. SMITH FIG. 4261 C.I. FLANGED HOUSING WITH HEAVY DUTY C.I. COVER, LIFTING DEVICE, GASKET SEAL THREADED PLUG, V.P. SCREWS IN COVER.

YCO-EXTERIOR UNSURFACED AREAS JAY R. SMITH FIG. 4261 C.I. FLANGED HOUSING WITH HEAVY DUTY C.I. COVER. LIFTING

DEVICE, GASKET SEAL THREADED PLUG, V.P. SCREWS IN COVER. PROVIDE 24" x 12" CONCRETE PAD FLUSH WITH SURFACE.

FD "G" - FLOOR DRAINS-GENERAL/RESTROOMS JAY R. SMITH FIG. 2005-B6 SERIES C.I. FLOOR DRAIN WITH 6" DIAMETER SQUARE NICKEL BRONZE STRAINER, SPEEDI-SET OUTLET CONNECTION AND TRAP PRIMER CONNECTION.

FD "M" -FLOOR DRAINS-GENERAL PURPOSE/MECHANICAL ROOM JAY R. SMITH FIG. 3715 SERIES CAST IRON 12" DIAMETER DRAIN WITH SEDIMENT BUCKET, CAST IRON GRATE WITH INTEGRAL 4" FUNNEL, SPEEDI-SET OUTLET CONNECTION.

FS-1 - SANI-CEPTOR FLOOR & INDIRECT WASTE SINK JAY R. SMITH FIG. 3410-12 ACID RESISTANT FLOOR SINK WITH 1/2 GRATE AND DOME BOTTOM STRAINER.

FS-2 - SANI-CEPTOR FLOOR & INDIRECT WASTE SINK JAY R. SMITH FIG. 3430-12 ACID RESISTANT FLOOR SINK WITH 1/2 GRATE AND DOME BOTTOM STRAINER.

FS-3 - SANI-CEPTOR FLOOR SINK JAY R. SMITH FIG. 3410-12 ACID RESISTANT FLOOR SINK WITH FULL GRATE AND DOME BOTTOM

LAVATORY-WALL HUNG SUPPORT

JAY R. SMITH #700 FOR MASONRY WALLS AND #700-M31 FOR METAL STUD WALLS. ELECTRIC WATER COOLER CARRIER-WALL HUNG

JAY R. SMITH FIG. 830 SUPPORT WITH UPRIGHTS OF HIGH STRENGTH STEEL WITH WELDED BASES BOLTED TO FLOOR. FOR STEEL STUD WALLS, USE M31 RECTANGULAR UPRIGHTS.

TP-"A"-AUTOMATIC TRAP PRIMER PPP PRIME-PRO SERIES AUTOMATIC TRAP PRIMER WITH MULTIPLE OUTLET DISTRIBUTION UNITS AS REQUIRED.

P.P.P. SYSTEM RATED PLUS SERIES COPPER WATER HAMMER ARRESTORS. INSTALL IN AN UPRIGHT POSITION AT ALL FLUSH VALVES, DISHWASHERS, PRV STATIONS, AND OTHER QUICK CLOSING VALVES, SOLENOIDS AND PLUMBING FIXTURES. LOCATE AND SIZE AS INDICATED ON DRAWINGS. WHERE NOT SHOWN ON DRAWINGS, LOCATE AND SIZE IN ACCORDANCE WITH PDI STANDARD

HB-HOSE BIBB LOOSE KEY WOODFORD #24P WITH LOOSE TEE KEY AND VACUUM BREAKER HOSE BIBB. CHROME PLATED FOR USE IN PUBLIC AREAS.

NFHB-HOSEBIBB-EXTERIOR JAY R. SMITH FIG. 5609-QT NON FREEZE 3/4" CAST BRONZE EXPOSED HYDRANT INTEGRAL VACUUM BREAKER, NICKEL BRONZE FACE, AND SIZED IN ACCORDANCE WITH WALL THICKNESS.

3/4" ROOF MOUNT PEDESTAL NON-FREEZE HYDRANT COMPLETE WITH MOUNTING FLANGE AND SHROUD, MALE HOSE END OUTLET WITH VACUUM BREAKER, NO DRAIN LINE REQUIRED. WOODFORD MODEL SRH.

IMS - ICE MAKER SUPPLY IPS WATER-TITE MODEL AB9700HACP PLASTIC BOX, BRASS QTR TURN VALVES W/ INTERGRAL LEAD FREE HAMMER ARRESTERS, 1/2" COLD WATER CONNECTION. PROVIDE GUY GRAY FR-12 SERIES IN FIRE RATED WALLS.

DSN - DOWNSPOUT NOZZLE JAY R. SMITH FIG. 1770Y-ADA-NB. NICKEL BRONZE NOZZLE AND FLANGE, NO-HUB OUTLET.

RD - ROOF DRAIN

6" RD AND SMALLER: CAST IRON BODY WITH COMBINED FLASHING AND GRAVEL STOP. UNDERDECK CLAMP AND SUMP RECEIVER, ADJUSTABLE EXTENSION AND CAST IRON DOME. JAY R. SMITH 1015-R-C OR APPROVED EQUAL.

8" RD AND LARGER: HIGH CAPACITY WITH 216 SQ. IN. FREE AREA, HAVE A CAST IRON BODY WITH COMBINED FLASHING AND GRAVEL STOP, UNDERDECK CLAMP AND SUMP RECEIVER, ADJUSTABLE EXTENSION AND CAST IRON DOME. <u>ZURN MODEL Z101</u> OR APPROVED EQUAL.

ERD - EMERGENCY ROOF DRAIN 6" ERD AND SMALLER: CAST IRON BODY, COMBINED FLASHING AND GRAVEL STOP, CAST-IRON DOME, 3" MINIMUM PVC STANDPIPE, UNDER DECK CLAMP, SUMP RECEIVER AND EXTENSION AS REQUIRED. JAY R. SMITH 1070-C-R OR APPROVED EQUAL.

8" ERD AND LARGER: HIGH CAPACITY WITH 216 SQ. IN. FREE AREA, HAVE A CAST IRON BODY WITH COMBINED FLASHING AND GRAVEL STOP, CAST-IRON DOME, 3" MINIMUM INTERNAL WATER DAM, UNDERDECK CLAMP, SUMP RECEIVER AND ADJUSTABLE EXTENSION AS REQUIRED. ZURN MODEL Z101 OR APPROVED EQUAL.

TPV - ELECTRONIC TRAP PRIMER VALVE TPV-1: PPP MODEL #MPB-500-120V. TPV-2: PPP MODEL #PTS-6-120V.

PLUMBING NOTES

- REFER TO ARCHITECTURAL DRAWINGS FOR EXACT LOCATIONS AND ELEVATIONS OF ALL PLUMBING FIXTURES.
- ALL PLUMBING WORK SHALL BE INSTALLED IN ACCORDANCE WITH 2018 NORTH CAROLINA PLUMBING CODE (WITH LOCAL)AMENDMENTS AND ALL APPLICABLE LOCAL CODE AND
- ALL PIPING ABOVE GRADE SHALL BE PROPERLY SUPPORTED FROM THE BUILDING STRUCTURE AND SHALL NOT REST ON CEILING TILES OR BE SUPPORTED FROM CEILING TILES.
- WATER PIPING ROUTED ABOVE CEILING AND IN EXTERIOR WALLS SHALL BE ROUTED ON HEATED SIDE (UNDERSIDE) OF CEILING INSULATION AND HEATED SIDE (INSIDE)
- OF WALL INSULATION.
- SANITARY AND DRAINAGE PIPING 2" AND SMALLER SHALL BE SLOPED AT 1/4" PER FOOT MINIMUM, PIPING 3" AND LARGER SHALL BE SLOPED AT 1/8" PER FOOT MINIMUM.
- TOPS OF ALL FLOOR DRAINS AND CLEANOUTS SHALL BE SET FLUSH WITH FINISHED FLOOR. TRAP PRIMERS ARE TO BE PROVIDED ON ALL FLOOR DRAINS AND HUB DRAINS. TP "A" AUTOMATIC TRAP PRIMERS ARE TO BE PROVIDED IN ALL REQUIRE LOCATIONS, UON.
- LOCATE ALL SECTIONAL OR MAIN CONTROL VALVES WITHIN 1'-0" FROM ACCESS
- ALL COLD WATER, HOT WATER AND DRAIN PIPING AT HANDICAPPED FIXTURES SHALL BE INSULATED WITH HANDI-LAV GUARD MODELS 102 AND 105 INSULATION KITS.

PANELS, CEILING TILES, OR OTHER POINT OF ACCESS.

- PROVIDE SHOCK ABSORBERS SIZED PER PDI SPECIFICATIONS ON ALL DOMESTIC WATER LINES SERVING FLUSH VALVE FIXTURES, WASHING MACHINES SUPPLIES, PRV STATIONS AND OTHER INSTALLATIONS WITH QUICK CLOSING VALVES.
- PROVIDE A BASE CLEANOUT AT THE LOWEST LEVEL OF ALL SANITARY AND WASTE STACKS.
- PROVIDE REDUCED PRESSURE BACKFLOW PREVENTORS AT ALL DOMESTIC WATER CONNECTIONS TO MECHANICAL EQUIPMENT, POOL AND IRRIGATION CONNECTIONS, AND VENDING EQUIPMENT CONNECTIONS AS REQUIRED BY LOCAL CODE AND AUTHORITIES. BACKFLOW PREVENTORS ARE TO BE LOCATED WITH A MINIMUM OF 1'-0" CLEARANCE AT THE LOWEST POINT AND AT NO MORE THAN 5'-0" ABOVE FLOOR AT THE HIGHEST POINT OF THE DEVICE.
- PROVIDE MANUFACTURED EXPANSION DEVICE OR FABRICATED EXPANSION LOOP ON ALL PIPING SYSTEMS CROSSING BUILDING EXPANSION JOINTS.
- CONTRACTOR SHALL COORDINATE ELECTRICAL CHARACTERISTICS AND REQUIREMENTS OF ALL PLUMBING EQUIPMENT WITH THE ELECTRICAL DRAWINGS AND THE ELECTRICAL CONTRACTOR, AND SHALL FURNISH EQUIPMENT WIRED FOR THE VOLTAGES SHOWN THEREIN.
- ALL PLUMBING EQUIPMENT, PIPING, INSULATION, ETC. INSTALLED IN HVAC PLENUM SPACES SHALL MEET CODE REQUIREMENTS FOR SMOKE AND COMBUSTIBILITY.
- ALL PLUMBING EQUIPMENT AND SYSTEMS SHALL BE GUARANTEED FOR A MINIMUM PERIOD OF ONE YEAR AFTER FINAL ACCEPTANCE.
- ALL PIPE PENETRATIONS OF FIRE AND/OR SMOKE RATED ASSEMBLIES SHALL BE FIRE STOPPED AS REQUIRED TO RESTORE ASSEMBLY TO ORIGINAL INTEGRITY. FIRE BARRIER PRODUCTS SHALL BE AS MANUFACTURED BY 3M COMPANY, CP25 CAULK, CS195 COMPOSITE PANEL, FS195 WRAP/SRINK, TREMCO, HILTI, METACAULK, NELSON, OR PSS 7900 SERIES SYSTEMS AS RECOMMENDED BY MANUFACTURER FOR PARTICULAR APPLICATIONS, OR EQUIVALENT SYSTEM AS APPROVED BY LOCAL CODE OFFICIALS. ALSO, REFER TO DIVISION 7 - THERMAL AND MOISTURE PROTECTION.
- PROVIDE AN INLINE FILTER ON THE DOMESTIC WATER SUPPLY TO ALL ICE MACHINES, FILTRINE MODEL 4TM OR ENGINEER APPROVED EQUAL.
- 19. ALL VENT THRU ROOF PENETRATIONS SHALL BE ROUTED TO TERMINATE AT THE LEAST VISIBLE LOCATION FROM THE ENTRY VIEW.
- 20. PROVIDE A FLANGED DOUBLE SPHERE FLOATING FLANGE FLEXIBLE CONNECTOR COMPLETE WITH CONTROL RODS AT THE DOMESTIC BOOSTER PUMP SUCTION AND DISCHARGE CONNECTIONS (PRESSURE RATING AS REQUIRED BY SYSTEM PRESSURE). KINETICS KINFLE:
- PROVIDE PRVS AT ALL BRANCH LINES SERVING FIXTURES OFF THE CW MAIN DOWNSTREAM OF THE BOOSTER PUMP, WHERE PRESSURES EXCEED 80 PSI.
- THE MINIMUM CLEAR HEIGHT FOR ALL PLUMBING SYSTEMS: REFER TO ARCHITECTURAL DRAWING FOR CLEAR HEIGHTS.

WHA - WATER HAMMER ARRESTOR

P.P.P. SYSTEM RATED PLUS SERIES COPPER WATER HAMMER ARRESTORS. CONTRACTOR SHALL INSTALL THE WATER HAMMER ARRESTORS IN THE PIPING SYSTEM AS REQUIRED BY THE SIZE OF THE FIXTURE LOAD.

SYMBOL	FIXTURE UNIT	CONNECTION SIZE	PPP ARRESTOR SIZE	PART NUMBER
WHA"A"	1-11	1/2"	Α	SC-500A
WHA"B"	22-32	3/4"	В	SC-750B
WHA"C"	33-60	1"	С	SC-1000C
WHA"D"	61-113	1"	D	SC-1250D
WHA"E"	114-154	1"	Е	SC-1500E
WHA"F"	155-330	1"	F	SC-2000F

ABBREVIATION DESCRIPTION ABOVE CEILING AREA DRAIN

	A/F	ABOVE FLOOR
	AFF	ABOVE FINISHED FLOOR
	AFG	ABOVE FINISHED GRADE
	AP	ACCESS PANEL
	B/C	BELOW COUNTER
	B/F	BELOW FLOOR
	B/G	BELOW GRADE
—XI—	BV	HOT WATER RETURN BALANCING VALVE
	CV	CHECK VALVE
	CW	COLD WATER PIPING
S	DN	PIPING TURNING DOWN
	FCO	FLOOR CLEANOUT
<u> </u>	FD	FLOOR DRAIN
—G—	G	GAS PIPING - LOW PRESSURE
—MG—	MG	GAS PIPING - MEDIUM PRESSURE
\longrightarrow	GV	GATE/BALL VALVE
─ →,,	HB/NFHB	HOSE BIBB/NON-FREEZE HOSE BIBB
	H.C.	HANDICAPPED
©c—	HD	HUB DRAIN
	HW	HOT WATER PIPING
	HWR	HOT WATER RETURN PIPING
	O/H	OVER HEAD
∞—		P-TRAP
	PRV	PRESSURE REDUCING VALVE
0 0	RD	ROOF DRAIN
	RPBP	REDUCED PRESSURE BACKFLOW PREVENTOR
- s	S,W	SOIL, WASTE PIPING (ABOVE GROUND)
	TP	TRAP PRIMER
		UNION
——	UP	PIPING TURNING UP
	V	VENT PIPING
	VTR	VENT THRU ROOF
i	wco	WALL CLEANOUT
c—	WH/NFWH	WALL HYDRANT/NON-FREEZE WALL HYDRANT

PLUMBING LEGEND

SYMBOL

DESIGN CRITERIA:

SHEET NUMBER

REFER TO DESIGN CRITERIA

YCO

SEISMIC NOTE:

YARD CLEANOUT

VALVED WATER COOLER CONNECTION

ALL MECHANICAL EQUIPMENT SHALL BE PROVIDED WITH SEISMIC RESTRAINTS FOR THE SEISMIC USE GROUP IN WHICH THE BUILDING IS LOCATED IN (SEE STRUCTURAL DRAWINGS) AND ACCORDANCE WITH THE 2018 NORTH CAROLINA BUILDING CODE SECTION 1613 EARTHQUAKE LOADS. ASCE 7-05 CHAPTER 13 (FORMULAS 13.3-1. 13.3-2. AND 13.3-3). AND THE 2018 NORTH CAROLINA BUILDING CODE CHAPTER 17 STRUCTURAL TESTS AND SPECIAL INSPECTIONS, DESIGN OF SYSTEM AND ALL SUBMITTAL DATA TO INCLUDE SEISMIC CALCULATIONS CERTIFIED BY A PROFESSIONAL ENGINEER LICENSED IN THE STATE OF PROJECT LOCATION AND EMPLOYED BY THE RESTRAINT MANUFACTURER. SHOP DRAWINGS SHALL BE SUBMITTED FOR APPROVAL. SEISMIC RESTRAINTS SHALL BE BY MASON INDUSTRIES INC. OR AN APPROVED EQUAL. SEE SPECIFICATIONS FOR ADDITIONAL INFORMATION.

SHEET NAME

PLUMBING SHEET INDEX

SHEET NUMBER	SHEET INAINE
-001	GENERAL NOTES, LEGENDS AND SCHEDULES - PLUMBING
-002	PLUMBING DETAILS
-003	PLUMBING DETAILS
-201	OVERALL FLOOR PLAN - GROUND LEVEL - PLUMBING
-202	PARTIAL FLOOR PLAN - GROUND LEVEL A - PLUMBING
-203	PARTIAL FLOOR PLAN - GROUND LEVEL B - PLUMBING
-204	PARTIAL FLOOR PLAN - GROUND LEVEL C - PLUMBING
-205	PARTIAL FLOOR PLAN - GROUND LEVEL D - PLUMBING
-206	OVERALL FLOOR PLAN - LEVEL 2 - PLUMBING
-207	PARTIAL FLOOR PLAN - LEVEL 2 A - PLUMBING
-208	PARTIAL FLOOR PLAN - LEVEL 2 B - PLUMBING
-209	PARTIAL FLOOR PLAN - LEVEL 2 C - PLUMBING
·210	PARTIAL FLOOR PLAN - LEVEL 2 D - PLUMBING
·211	OVERALL FLOOR PLAN - LEVEL 3 - PLUMBING
-212	PARTIAL FLOOR PLAN - LEVEL 3 A - PLUMBING
-213	PARTIAL FLOOR PLAN - LEVEL 3 B - PLUMBING
-214	PARTIAL FLOOR PLAN - LEVEL 3 C - PLUMBING
·215	PARTIAL FLOOR PLAN - LEVEL 3 D - PLUMBING
-216	OVERALL FLOOR PLAN - LEVEL 4 - PLUMBING
-217	PARTIAL FLOOR PLAN - LEVEL 4 A - PLUMBING
-218	PARTIAL FLOOR PLAN - LEVEL 4 B - PLUMBING
-219	PARTIAL FLOOR PLAN - LEVEL 4 C - PLUMBING
-220	PARTIAL FLOOR PLAN - LEVEL 4 D - PLUMBING
-221	OVERALL FLOOR PLAN - LEVEL 5 - PLUMBING
-222	PARTIAL FLOOR PLAN - LEVEL 5 A - PLUMBING
-223	PARTIAL FLOOR PLAN - LEVEL 5 B - PLUMBING
-224	PARTIAL FLOOR PLAN - LEVEL 5 C - PLUMBING
-225	PARTIAL FLOOR PLAN - LEVEL 5 D - PLUMBING
-226	OVERALL ROOF PLAN - PLUMBING
-227	PARTIAL ROOF PLAN - A - PLUMBING
-228	PARTIAL ROOF PLAN - B - PLUMBING
-229	PARTIAL ROOF PLAN - C - PLUMBING
-230	PARTIAL ROOF PLAN - D - PLUMBING
-401	MAIN OFFICE PLAN - PLUMBING
-401S	MAIN OFFICE - SANITARY RISER
-401W	MAIN OFFICE - WATER RISER
-402A	MAIN OFFICE PLAN - SANITARY
-402B	MAIN OFFICE PLAN - WATER
-402S	MAIN OFFICE - SANITARY RISER
-402W	MAIN OFFICE - WATER RISER
-403A	ENLARGED REMOTE BREAKROOM PLANS - SANITARY
-403B	ENLARGED REMOTE BREAKROOM PLANS - WATER
-404A	ENLARGED RESTROOM PLANS - SANITARY
-404B	ENLARGED RESTROOM PLANS - WATER
-405A	ENLARGED RESTROOM PLANS - SANITARY
-405B	ENLARGED RESTROOM PLANS - WATER
-406A	ENLARGED RESTROOM PLANS - SANITARY
-406B	ENLARGED RESTROOM PLANS - WATER
-407A	ENLARGED RESTROOM PLANS - SANITARY
-407B	ENLARGED RESTROOM PLANS - WATER
-408	ENLARGED RESTROOM PLANS - PLUMBING
-409	ENLARGED PLANS - PLUMBING
OTAL DRAWINGS ISSUE	
22.234-	

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Drawn By:CF Checked By:JMW

UMBER DATE DESCRIPTION 06/10/24 PRICING SET

PRINT RECORD

PROJECT INFORMATION

PROJECT

WILMINGTON, NC

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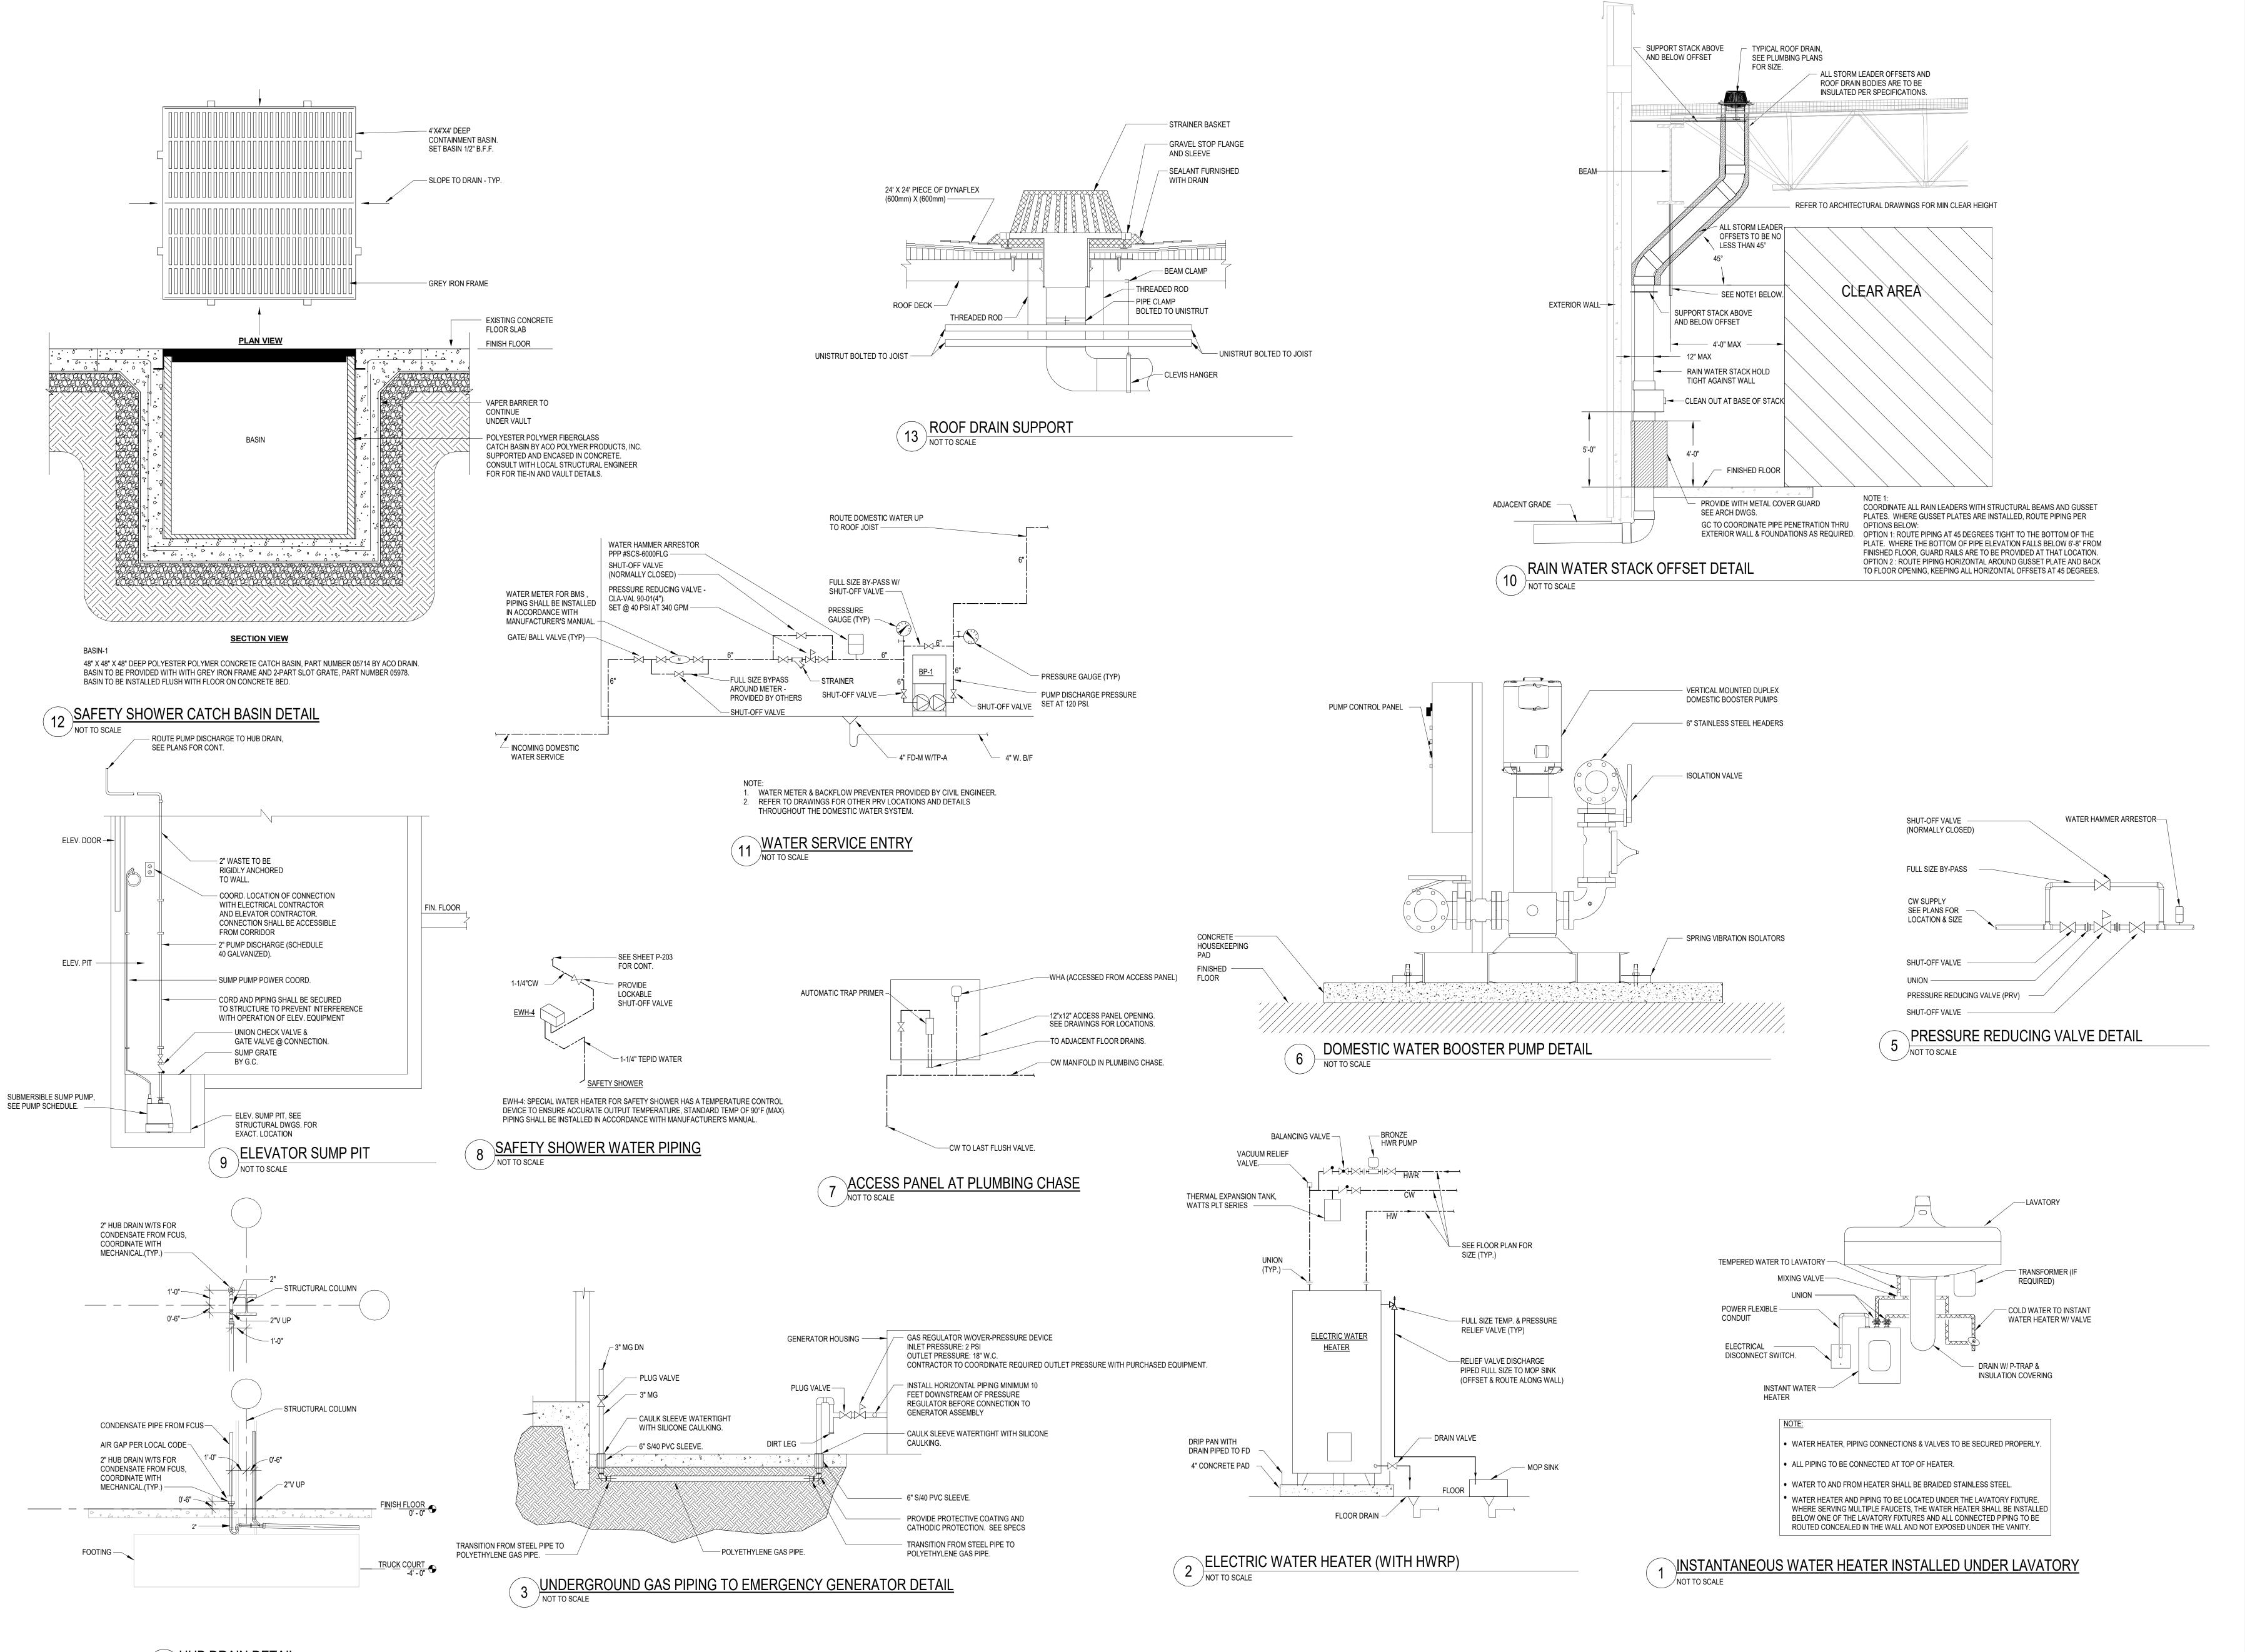
THE CONTRACTOR SHALL VERIFY ALL DIMENSIONS ND EXISTING CONDITIONS AT THE SITE BEFORI ROCEEDING WITH EACH PHASE OF HIS WORK. Macgregor Associates Architects, Inc. - 1987-2024 2024-013

SHEET TITLE GENERAL NOTES, LEGENDS AND **SCHEDULES -**

SHEET NUMBER

PLUMBING

P-001



LILL

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PROJECT INFORMATION

PROJECT WHALE

WILMINGTON, NC

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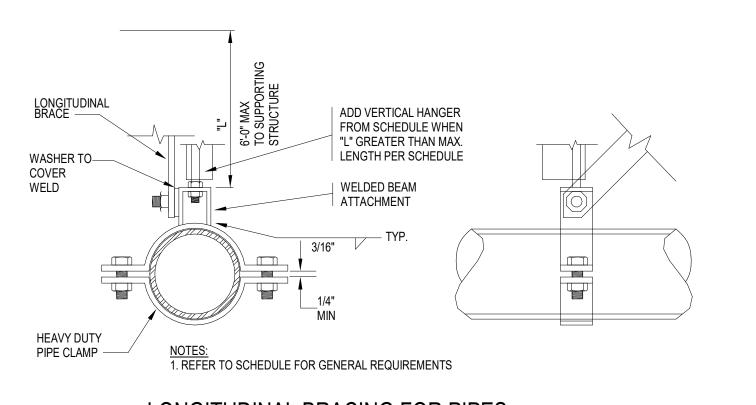
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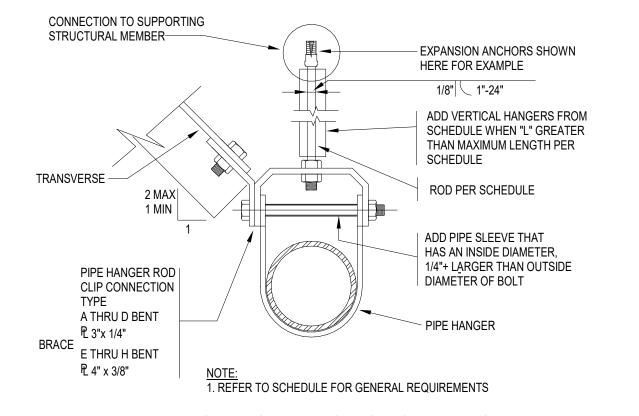
DATE
PROJECT NO
2024-013

SHEET TITLE

PLUMBING DETAILS

P-002






LONGITUDINAL BRACING FOR PIPES (1) NOT TO SCALE

TRANSVERSE BRACING FOR PIPES (2) NOT TO SCALE

SCHEDULE - PIPE BRACING	
SCHEDULE - PIPE BRACING	

PIPE SIZE (IN.)	MAX. WT. (lbs per foot)	VERTICAL HANGERS	TRANSVERSE BRACES (CABLE SIZE)	LONGITUDINAL BRACES (CABLE SIZE)	BOLT SIZE	CONNECTION TYPE TO STRUCTURAL MEMBER	ROD SIZE (in.)	MAX. LENGT FOR RODS
1 - 2-1/2	7.9	L2X2X16GA	L2-1/2x2-1/2x16GA (1/4" CABLE)	L2-1/2x2-1/2x16GA (1/4" CABLE)	3/8	A	1/2	25"
3	10.8	L2X2X16GA	L2-1/2x2-1/2x16GA (1/4" CABLE)	L2-1/2x2-1/2x16GA (1/4" CABLE)	3/8	A	1/2	25"
4	16.3	L2X2X16GA	L2-1/2x2-1/2x16GA (1/4" CABLE)	L2-1/2x2-1/2x16GA (1/4" CABLE)	3/8	А	5/8	31"

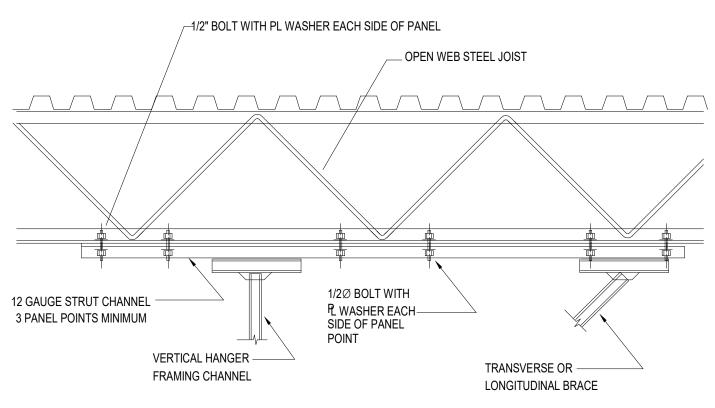


CONNECTIONS TO OPEN WEB STEEL JOIST (3) NOT TO SCALE


REFER TO FLOOR PLAN

CW----

FOR CONTINUATION


NOTE: SEE OVERALL DRAWINGS FOR EXACT BRACING LOCATIONS.

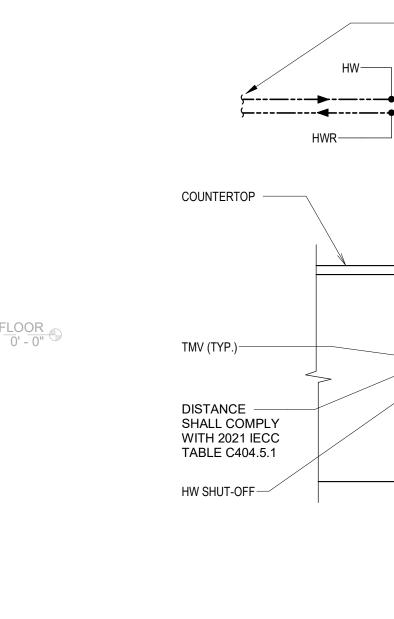

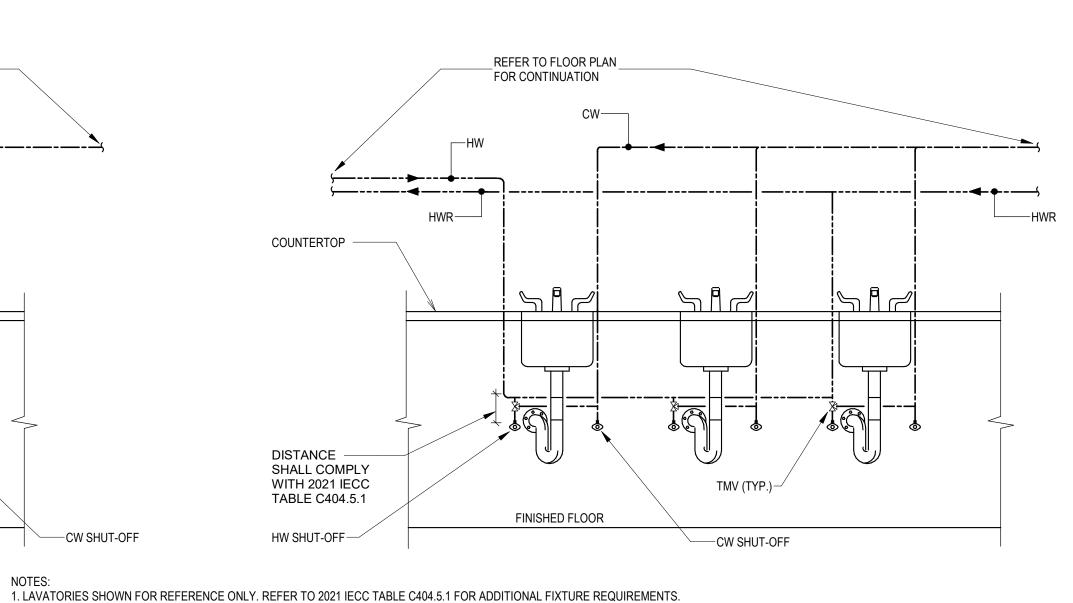

4 LAVATORY DOMESTIC WATER AND HOT WATER RECIRULATION PIPING NOT TO SCALE

FINISHED FLOOR

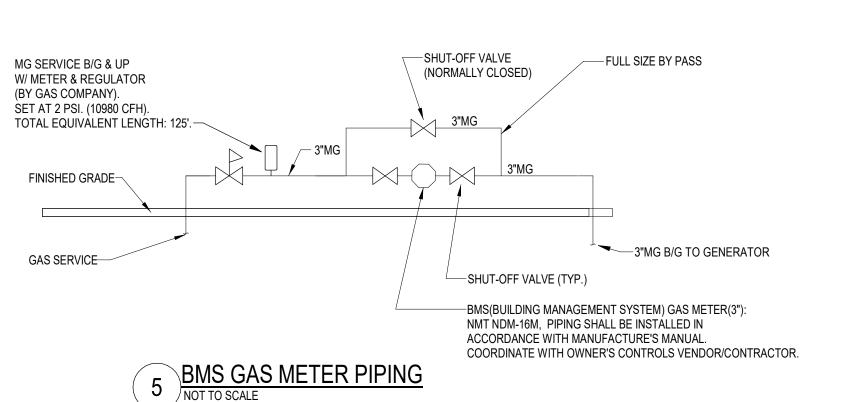

-CW SHUT-OFF

2. INSULATE DOMESTIC HOT WATER AND HOT WATER RECIRCULATION PIPING PER 2021 IECC CH. 4.

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PRINT RECORD NUMBER DATE DESCRIPTION 06/10/24 PRICING SET

PROJECT INFORMATION

PROJECT WHALE

WILMINGTON, NC

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2024-013 - -

SHEET TITLE PLUMBING DETAILS

SHEET NUMBER

NOT FOR CONSTRUCTION

A AA.9

RL WILL REMAIN DUCTILE IRON
THROUGH THE FOOTING, AND

6 RL(AT SPECIFIC LOCATIONS) MATERIAL DETAIL

NOT TO SCALE

EXTEND 3'-0" OUTSIDE OF FOOTING

-DUCTILE IRON TO PVC,

SEE CIVIL FOR CONT.

RL TO TRANSITION FROM PVC TO DUCTILE IRON BELOW SOG W/


WRAPPED ISOLATION MATERIAL

PER 2018 NC PLUMBING CODE:

DUCTILE IRON PIPE FITTING

AWWA C110/A21.10-

DUCTILE IRON-

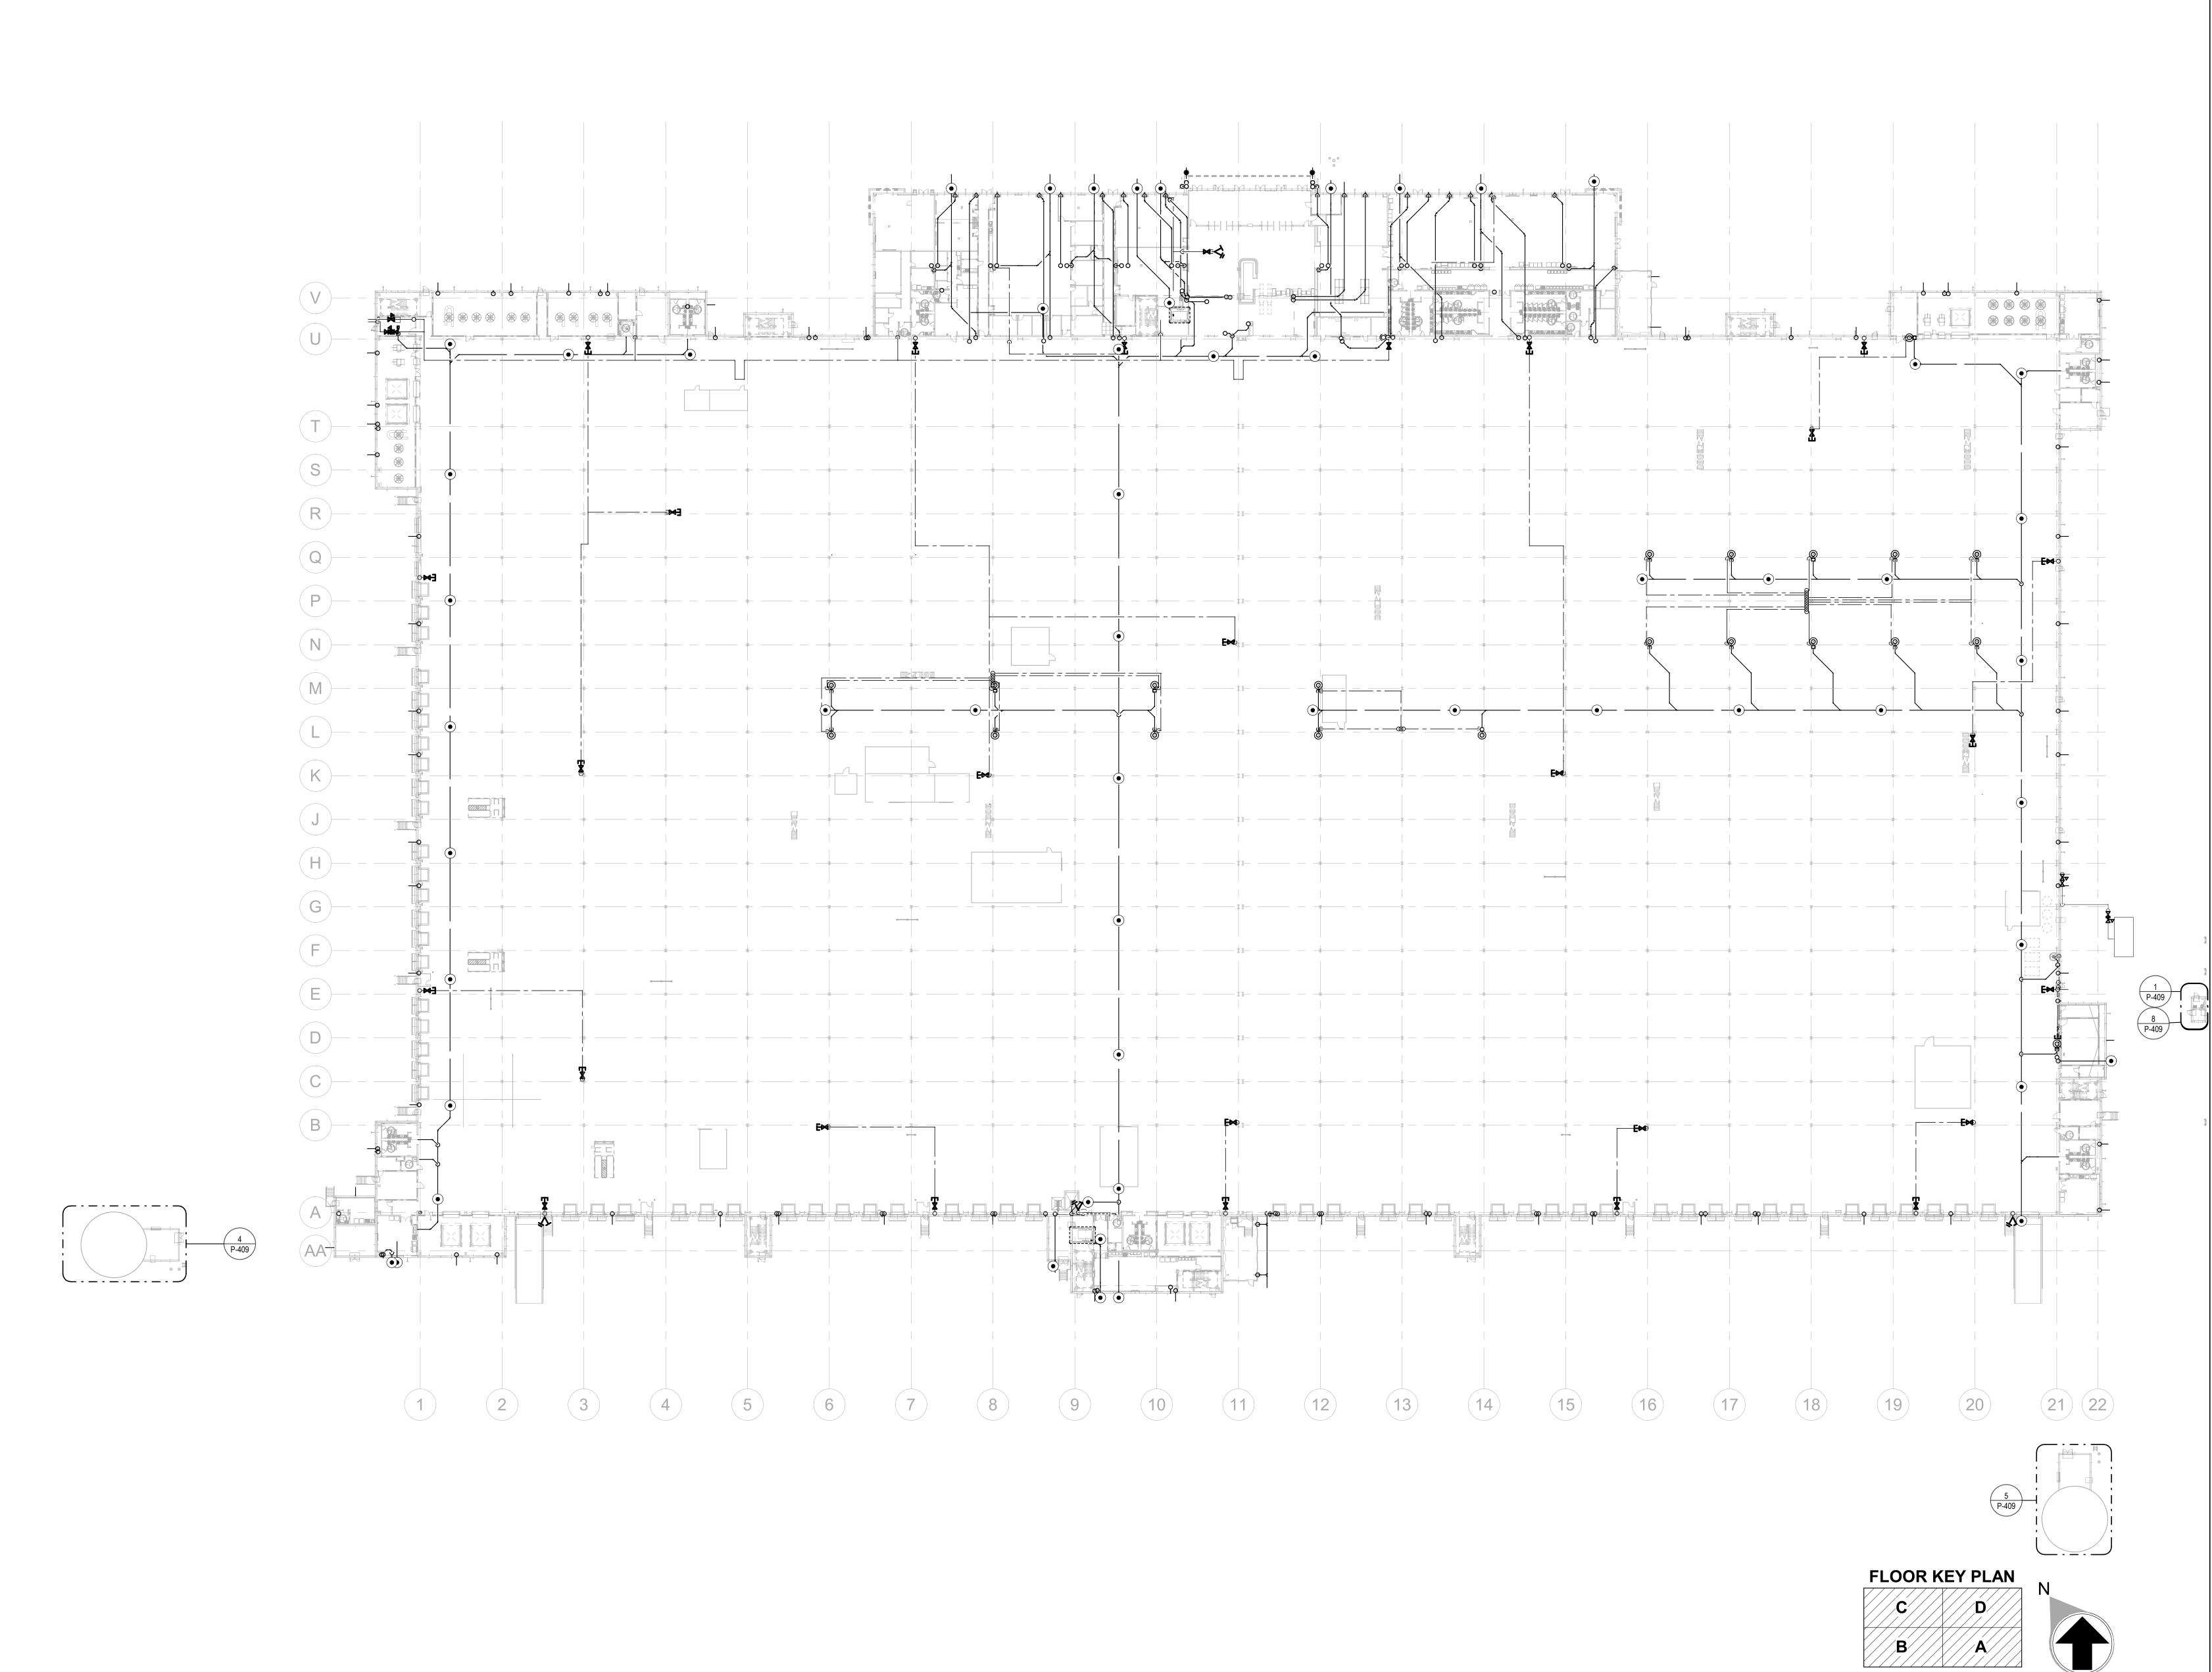

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DATE
PROJECT NO
2024-013

SHEET TITLE

OVERALL FLOOR PLAN -GROUND LEVEL - PLUMBING

SHEET NUMBER

P-201

SECONDARY ROOF DRAIN: BASED ON 100-YEAR, 15-MINUTE RAINFALL(8.5"/HOUR). ABOVE GROUND: OFFSET RAIN WATER LEADER AT ROOF 45-DEGREE ANGLE, WHILE MAINTAINING FLOOR CLEAR HEIGHT. WHERE 45-DEGREE OFFSETS ARE NOT POSSIBLE, ALL HORIZONTAL STORM PIPING ABOVE GROUND SHALL SLOPE AT 1/4" PER FOOT, MINIMUM, UON. DOWNSPOUT NOZZLE SHALL BE INSTALLED AT 24" ABOVE FINISHED GRADE, UON. FCO • ∕—8"RL UP __I.E.=3'-8" BFF. __8"ST B/G, SEE CIVIL FOR CONT. (9497 SF) MG SERVICE B/G & UP W/ METER & REGULATOR `—8"ST B/G, (BY GAS COMPANY). SEE CIVIL FOR CONT. SET AT 2 PSI. (10980 CFH). I.E.=3'-8" BFF. TOTAL EQUIVALENT LENGTH: 125'. 3"MG B/G-/ GAS REGULATOR INLET PRESSURE: 2 PSI OUTLET PRESSURE: 18" W.C., $\overline{\,\,\,}$ 6" LOW PRESSURE $\overline{\,\,\,\,}$ 6. SEE DETAIL ON P-002 <u>4"FD"M" W/TP.</u> COORDINATE WITH AIR COMPRESSOR LOCATION PRIOR TO INSTALLING FD. SEE CIVIL FOR CONT. (8020 SF) 1/2"CW FROM ELECTRONIC TRAP PRIMER 1-1/2" VALVED CW CONNECTION INSTALLED ABOVE CLEAR HEIGHT & PER MANUFACTURE'S INSTRUCTION. ----1-1/2"CW VALVE IN VERTICAL FOR THE GUARDHOUSE SUPPLY LINE. SERVING THE WCS ON LEVEL 1-2"CW SERVING WCS-1/2" PRIMING VALVE MAKEUP LINE 3/4" CW W/ WATTS 007 BF PROPERLY GRADED IN THE DIRECTION 1
P-409 UNDER LEVEL 2 SLAB, FOR CRAC UNITS. (COORDINATE WITH OF FLOW TO THE DRAINS(TYP.) MECHANICAL.)— 6"ST B/G, (3897 SF) 6"S—— (159 DFU) SEE CIVIL FOR CONT. DOWNSPOUT, REFER TO ARCHITECTURAL PLANS. 3"HD W/TP FOR CONDENSATE FROM ACS, COORDINATE SEE CIVIL FOR CONT. WITH MECHANICAL. ─_I<u>.E.=7'-8" B</u>FF. (161 DFU) 1-W121 •—1/2"CW SEE CIVIL FOR CONT. (1135 SF) 1-1/2" VALVED CW CONNECTION INSTALLED ABOVE CLEAR HEIGHT & 1-W125 6"S— (286 DFU) SERVING THE WCS ON LEVEL 1-1-1/2" VALVED CW CONNECTION INSTALLED ABOVE CLEAR HEIGHT & SERVING THE WCS ON LEVEL 1-8"ERL DN-2"CW SERVING WCS-W/ SHUT-OFF VALVE IN /−4"ST B/G, 8"RL DN-SEE CIVIL FOR CONT. VERTICAL-----8"ERL UP —I.E.=7'-8"∣BFF. ─I.E.=7'-8" BFF. 10"ST B/G, 10"ST B/G, -10"ST B/G, —8"ST B/G, —8"ST В/G, 12"ST B/G, 10"ST B/G, —10"ST B/G, (286 DFU) SEE CIVIL FOR CONT. -SEE CIVIL FOR CONT. (AA)SEE CIVIL FOR CONT. SEE CIVIL FOR CONT.-SEE CIVIL FOR CONT.-SEE CIVIL FOR CONT. SEE CIVIL FOR CONT. SEE CIVIL FOR CONT. SEE CIVIL FOR CONT. (19273 SF) (12877 SF) (13032 SF) (5071 SF) (14659 SF) (11102 SF) (8267 SF) ---6"ST FROM DOWNSPOUT, DOWNSPOUT, REFER TO ARCHITECTURAL PLANS. G-505 (1743 SF) SEE CIVIL FOR CONT. (14280 SF) (14)**FLOOR KEY PLAN**

STORM DRAINAGE NOTES:

STORM PIPING & ROOF DRAINS ARE SIZED BASED ON 2018 NORTH CAROLINA PLUMBING CODE.

(PRIMARY ROOF DRAIN: BASED ON RAINFALL RATE OF 4.5" ONE-HOUR DURATION AND A 100-YEAR RETURN PERIOD;

KEYNOTES

- PROVIDE 1/2" WATER TAP WITH BALL VALVE AND COPPER MANIFOLD. LOCATE BALL VALVE 8'-0" AFF. ROUTE 1/2" COPPER PIPING FROM TAP TO EACH OWNER PROVIDED WATER COOLER. STUB COPPER PIPING 24" ABOVE FLOOR AT WATER COOLER
- LOCATION. PROVIDE 1/2" X 3/8" ANGLE STOP SUPPLY VALVE. ALL LOCATIONS TO BE REVIEWED BY TENANT PRIOR TO INSTALLATION. PROVIDE LONGITUDINAL AND TRANSVERSE BRACING. SEE DETAILS
- 10" STORM PIPE, REFER TO DETAIL 11 ON ARCHITECTURAL SHEET
- 4 FOR THIS RL, SEE SHEET P-003 DETAIL 6 FOR PIPE MATERIAL.

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PROJECT INFORMATION

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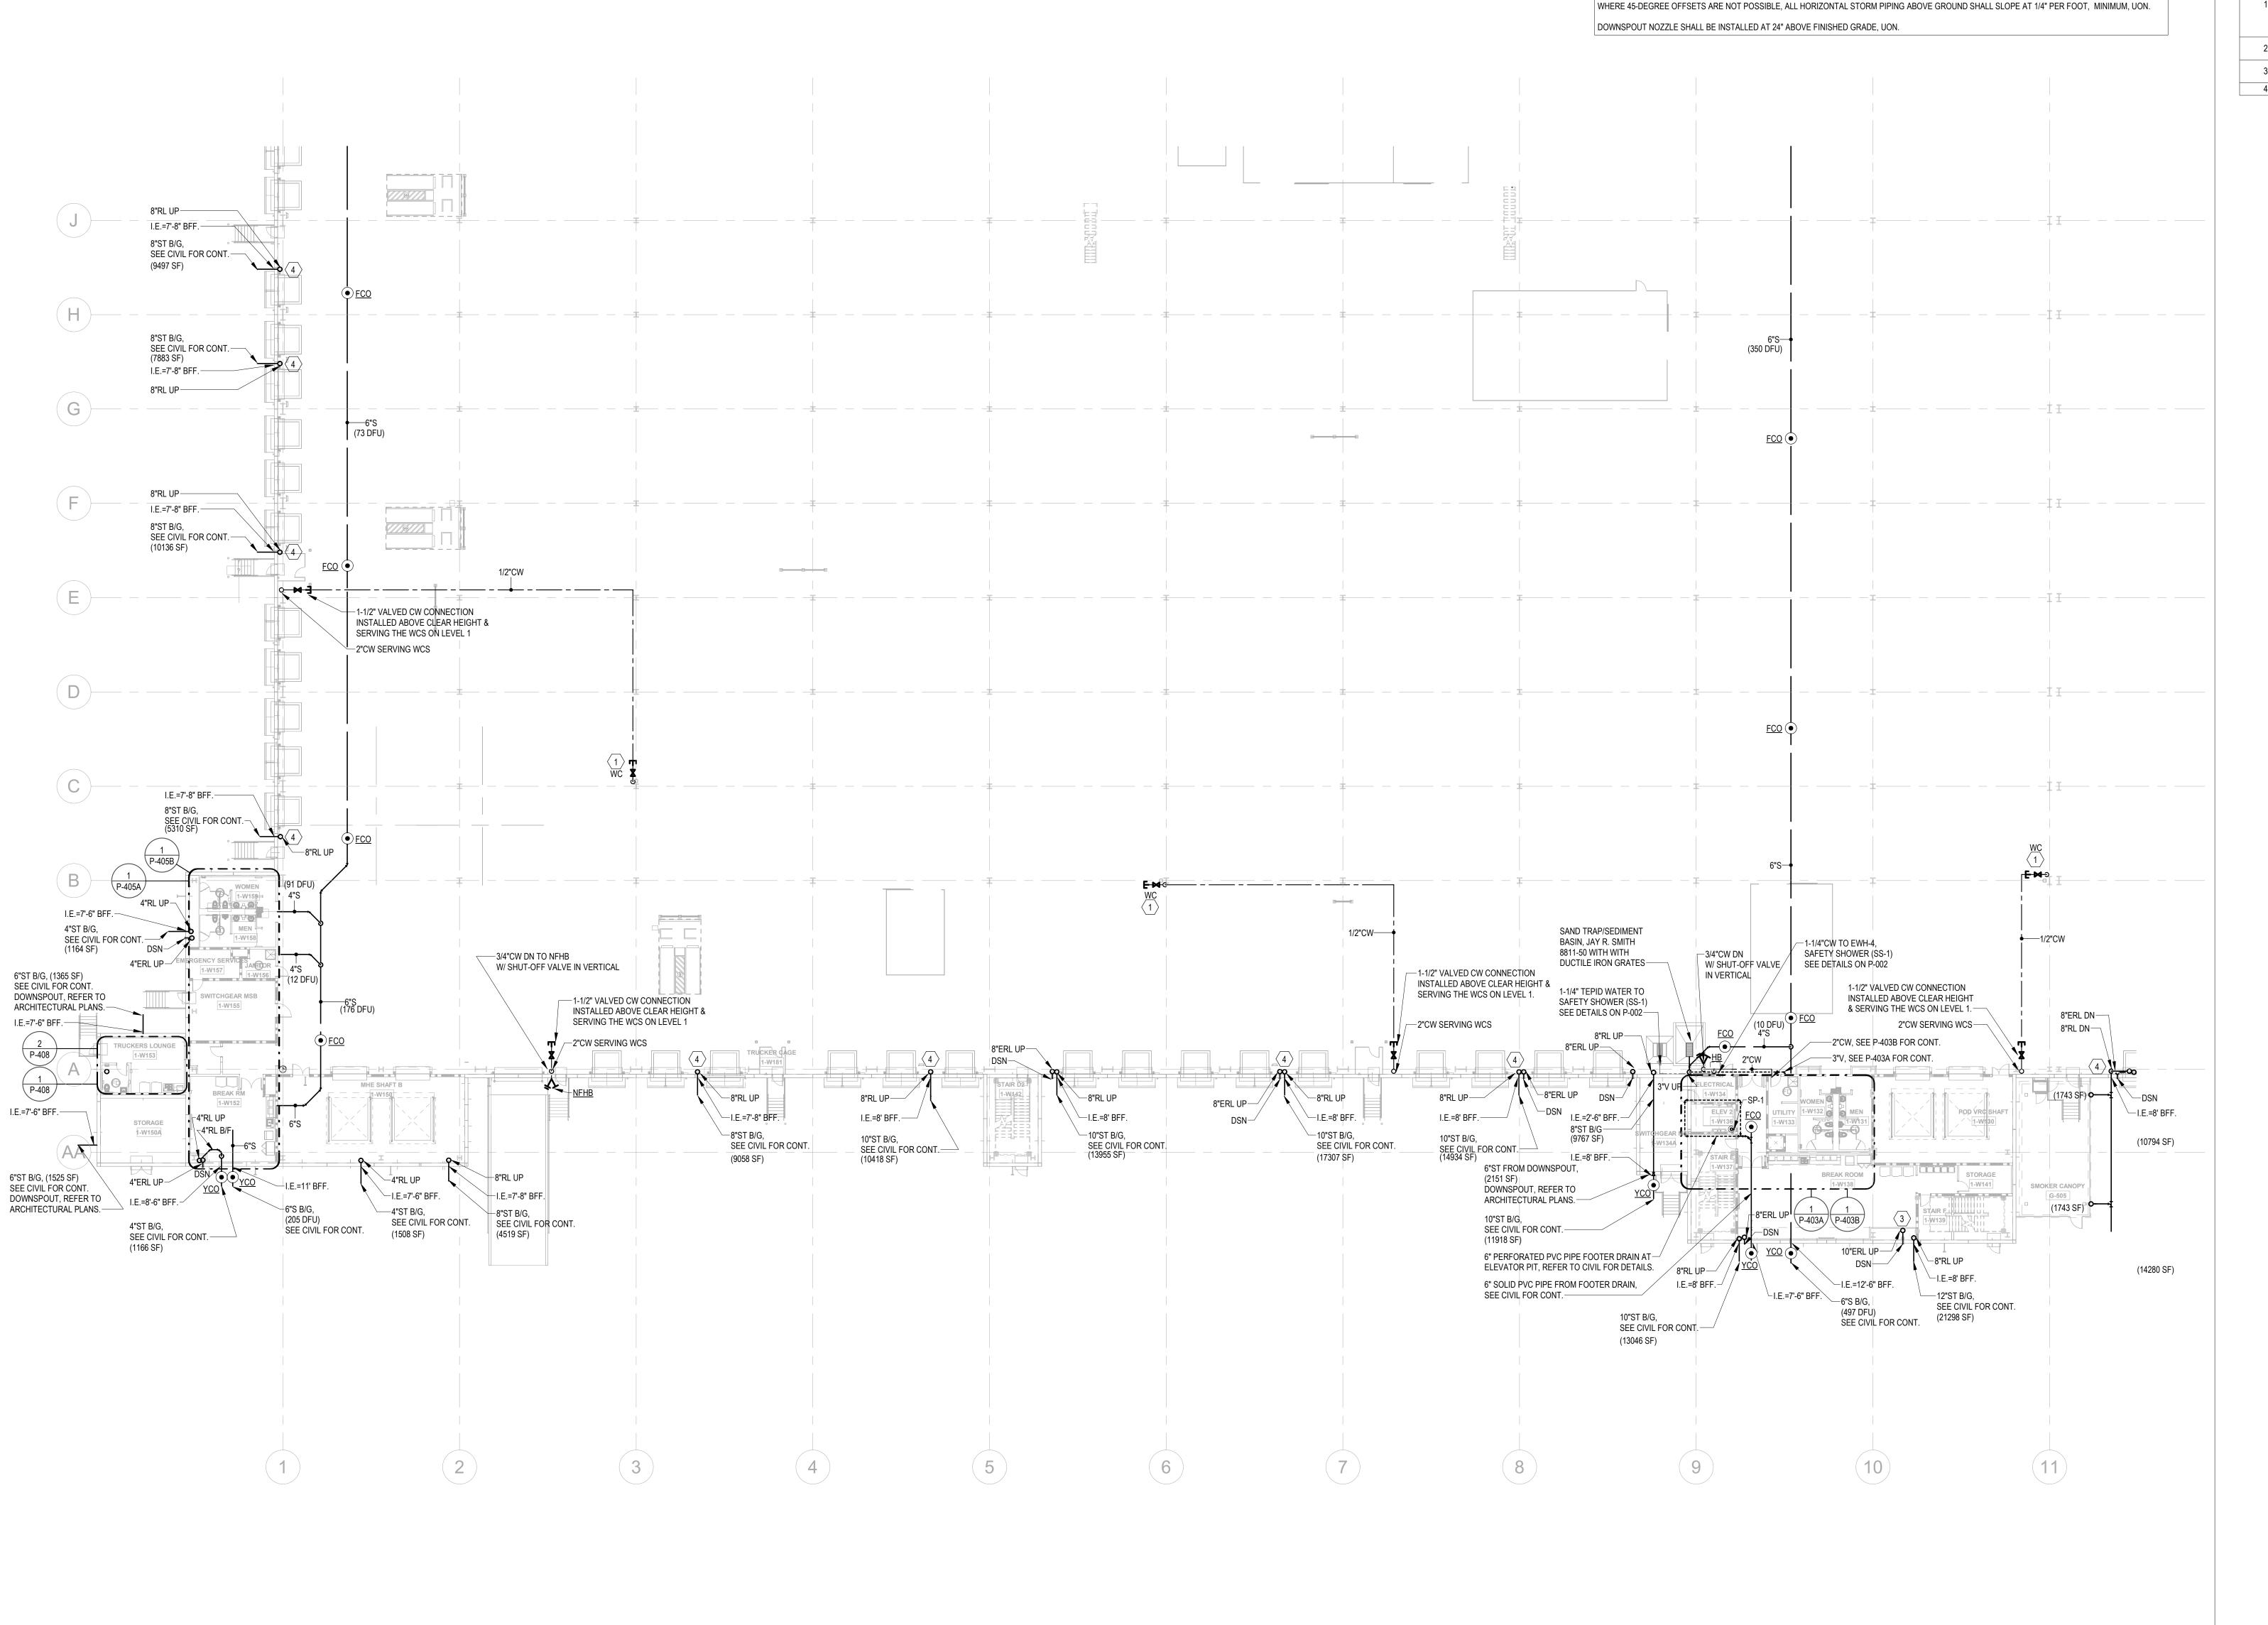
PARTIAL FLOOR PLAN -**GROUND LEVEL** A - PLUMBING

SHEET NUMBER

P-202

NOT FOR CONSTRUCTION

1" = 20'-0"



STORM DRAINAGE NOTES:

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SECONDARY ROOF DRAIN: BASED ON 100-YEAR, 15-MINUTE RAINFALL(8.5"/HOUR).

(PRIMARY ROOF DRAIN: BASED ON RAINFALL RATE OF 4.5" ONE-HOUR DURATION AND A 100-YEAR RETURN PERIOD;

ABOVE GROUND: OFFSET RAIN WATER LEADER AT ROOF 45-DEGREE ANGLE, WHILE MAINTAINING FLOOR CLEAR HEIGHT.

KEYNOTES

- PROVIDE 1/2" WATER TAP WITH BALL VALVE AND COPPER MANIFOLD. LOCATE BALL VALVE 8'-0" AFF. ROUTE 1/2" COPPER PIPING FROM TAP TO EACH OWNER PROVIDED WATER COOLER. STUB COPPER PIPING 24" ABOVE FLOOR AT WATER COOLER LOCATION. PROVIDE 1/2" X 3/8" ANGLE STOP SUPPLY VALVE. ALL
- LOCATIONS TO BE REVIEWED BY TENANT PRIOR TO INSTALLATION. PROVIDE LONGITUDINAL AND TRANSVERSE BRACING. SEE DETAILS
- 10" STORM PIPE, REFER TO DETAIL 11 ON ARCHITECTURAL SHEET

4 FOR THIS RL, SEE SHEET P-003 DETAIL 6 FOR PIPE MATERIAL.

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2024-013 SHEET TITLE PARTIAL

FLOOR PLAN -**GROUND LEVEL** B - PLUMBING

FLOOR KEY PLAN

SHEET NUMBER

P-203

STORM DRAINAGE NOTES: STORM PIPING & ROOF DRAINS ARE SIZED BASED ON 2018 NORTH CAROLINA PLUMBING CODE. (PRIMARY ROOF DRAIN: BASED ON RAINFALL RATE OF 4.5" ONE-HOUR DURATION AND A 100-YEAR RETURN PERIOD; SECONDARY ROOF DRAIN: BASED ON 100-YEAR, 15-MINUTE RAINFALL(8.5"/HOUR). ABOVE GROUND: OFFSET RAIN WATER LEADER AT ROOF 45-DEGREE ANGLE, WHILE MAINTAINING FLOOR CLEAR HEIGHT. WHERE 45-DEGREE OFFSETS ARE NOT POSSIBLE, ALL HORIZONTAL STORM PIPING ABOVE GROUND SHALL SLOPE AT 1/4" PER FOOT, MINIMUM, UON. DOWNSPOUT NOZZLE SHALL BE INSTALLED AT 24" ABOVE FINISHED GRADE, UON.

I.E.=6'-6" BFF.----

KEYNOTES

- PROVIDE 1/2" WATER TAP WITH BALL VALVE AND COPPER MANIFOLD. LOCATE BALL VALVE 8'-0" AFF. ROUTE 1/2" COPPER PIPING FROM TAP TO EACH OWNER PROVIDED WATER COOLER. STUB COPPER PIPING 24" ABOVE FLOOR AT WATER COOLER LOCATION. PROVIDE 1/2" X 3/8" ANGLE STOP SUPPLY VALVE. ALL
- LOCATIONS TO BE REVIEWED BY TENANT PRIOR TO INSTALLATION PROVIDE LONGITUDINAL AND TRANSVERSE BRACING. SEE DETAILS
- 10" STORM PIPE, REFER TO DETAIL 11 ON ARCHITECTURAL SHEET 4 FOR THIS RL, SEE SHEET P-003 DETAIL 6 FOR PIPE MATERIAL.



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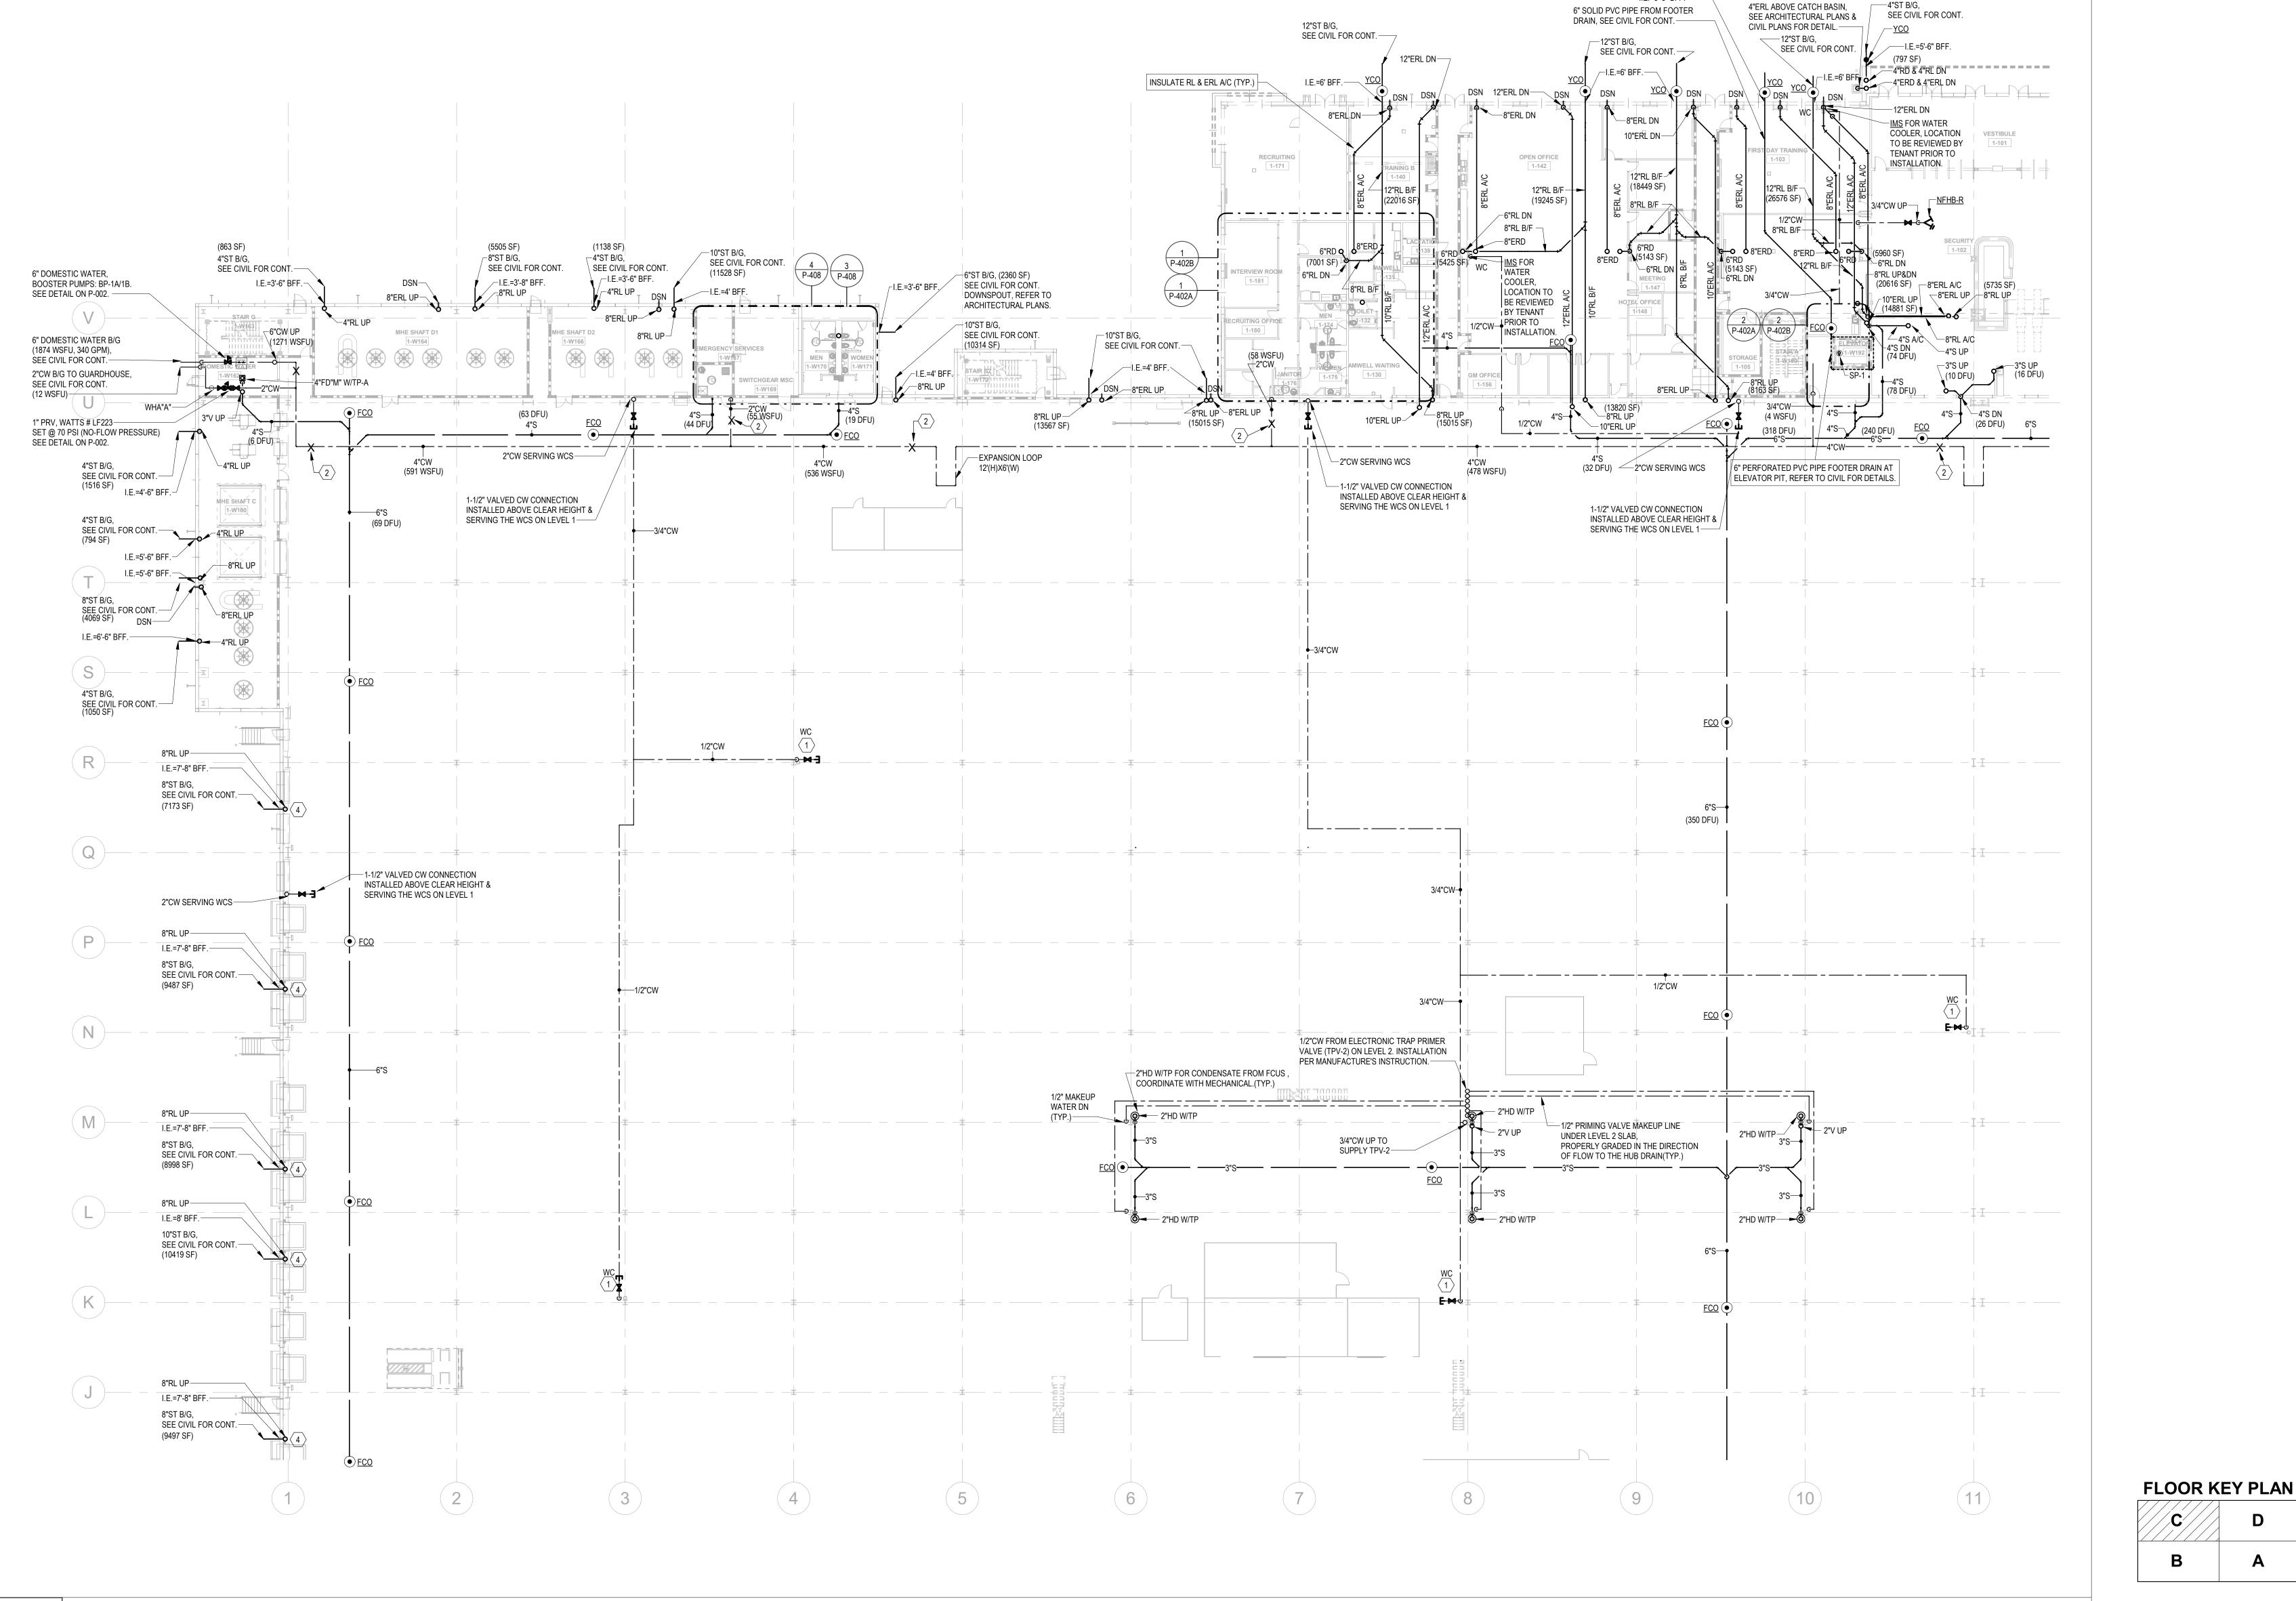
WILMINGTON, NC


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2024-013 SHEET TITLE PARTIAL

FLOOR PLAN -**GROUND LEVEL** C - PLUMBING

P-204



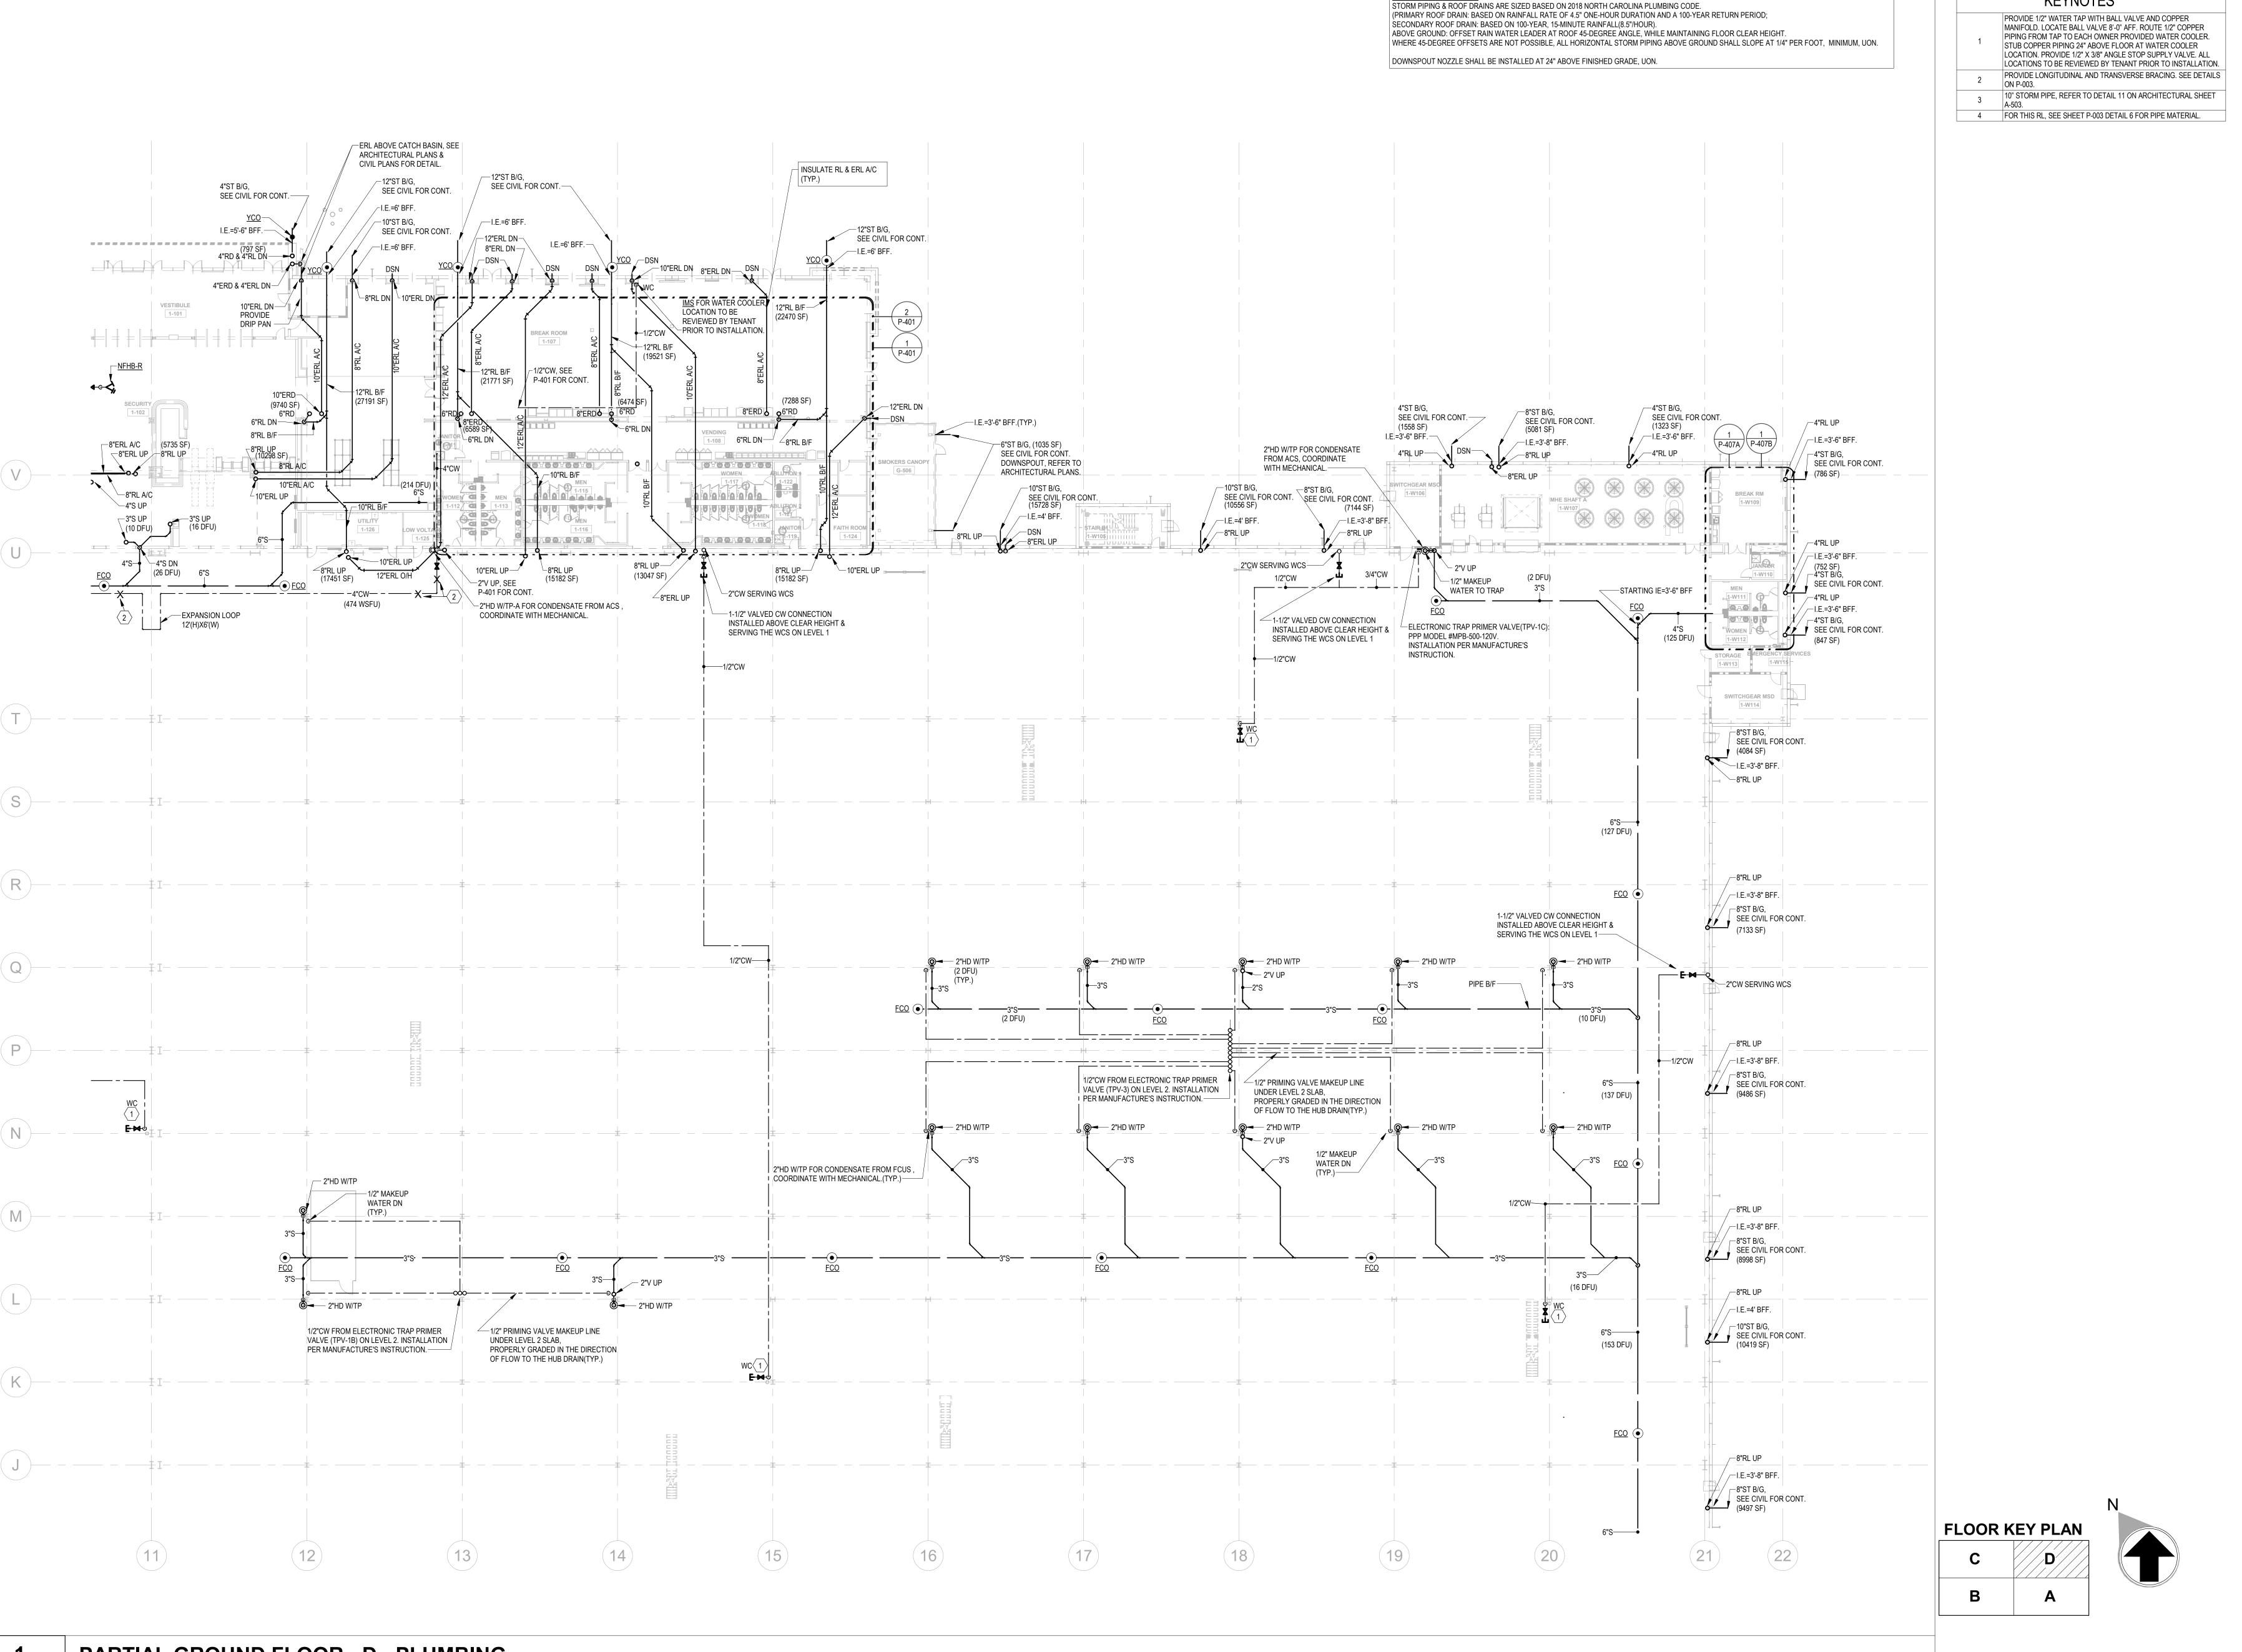

STORM DRAINAGE NOTES:

KEYNOTES

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Project Number:24010155
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PROJECT INFORMATION

PROJECT WHALE

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PROCEEDING WITH EACH PHASE OF HIS WORK.

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DATE
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2024-013

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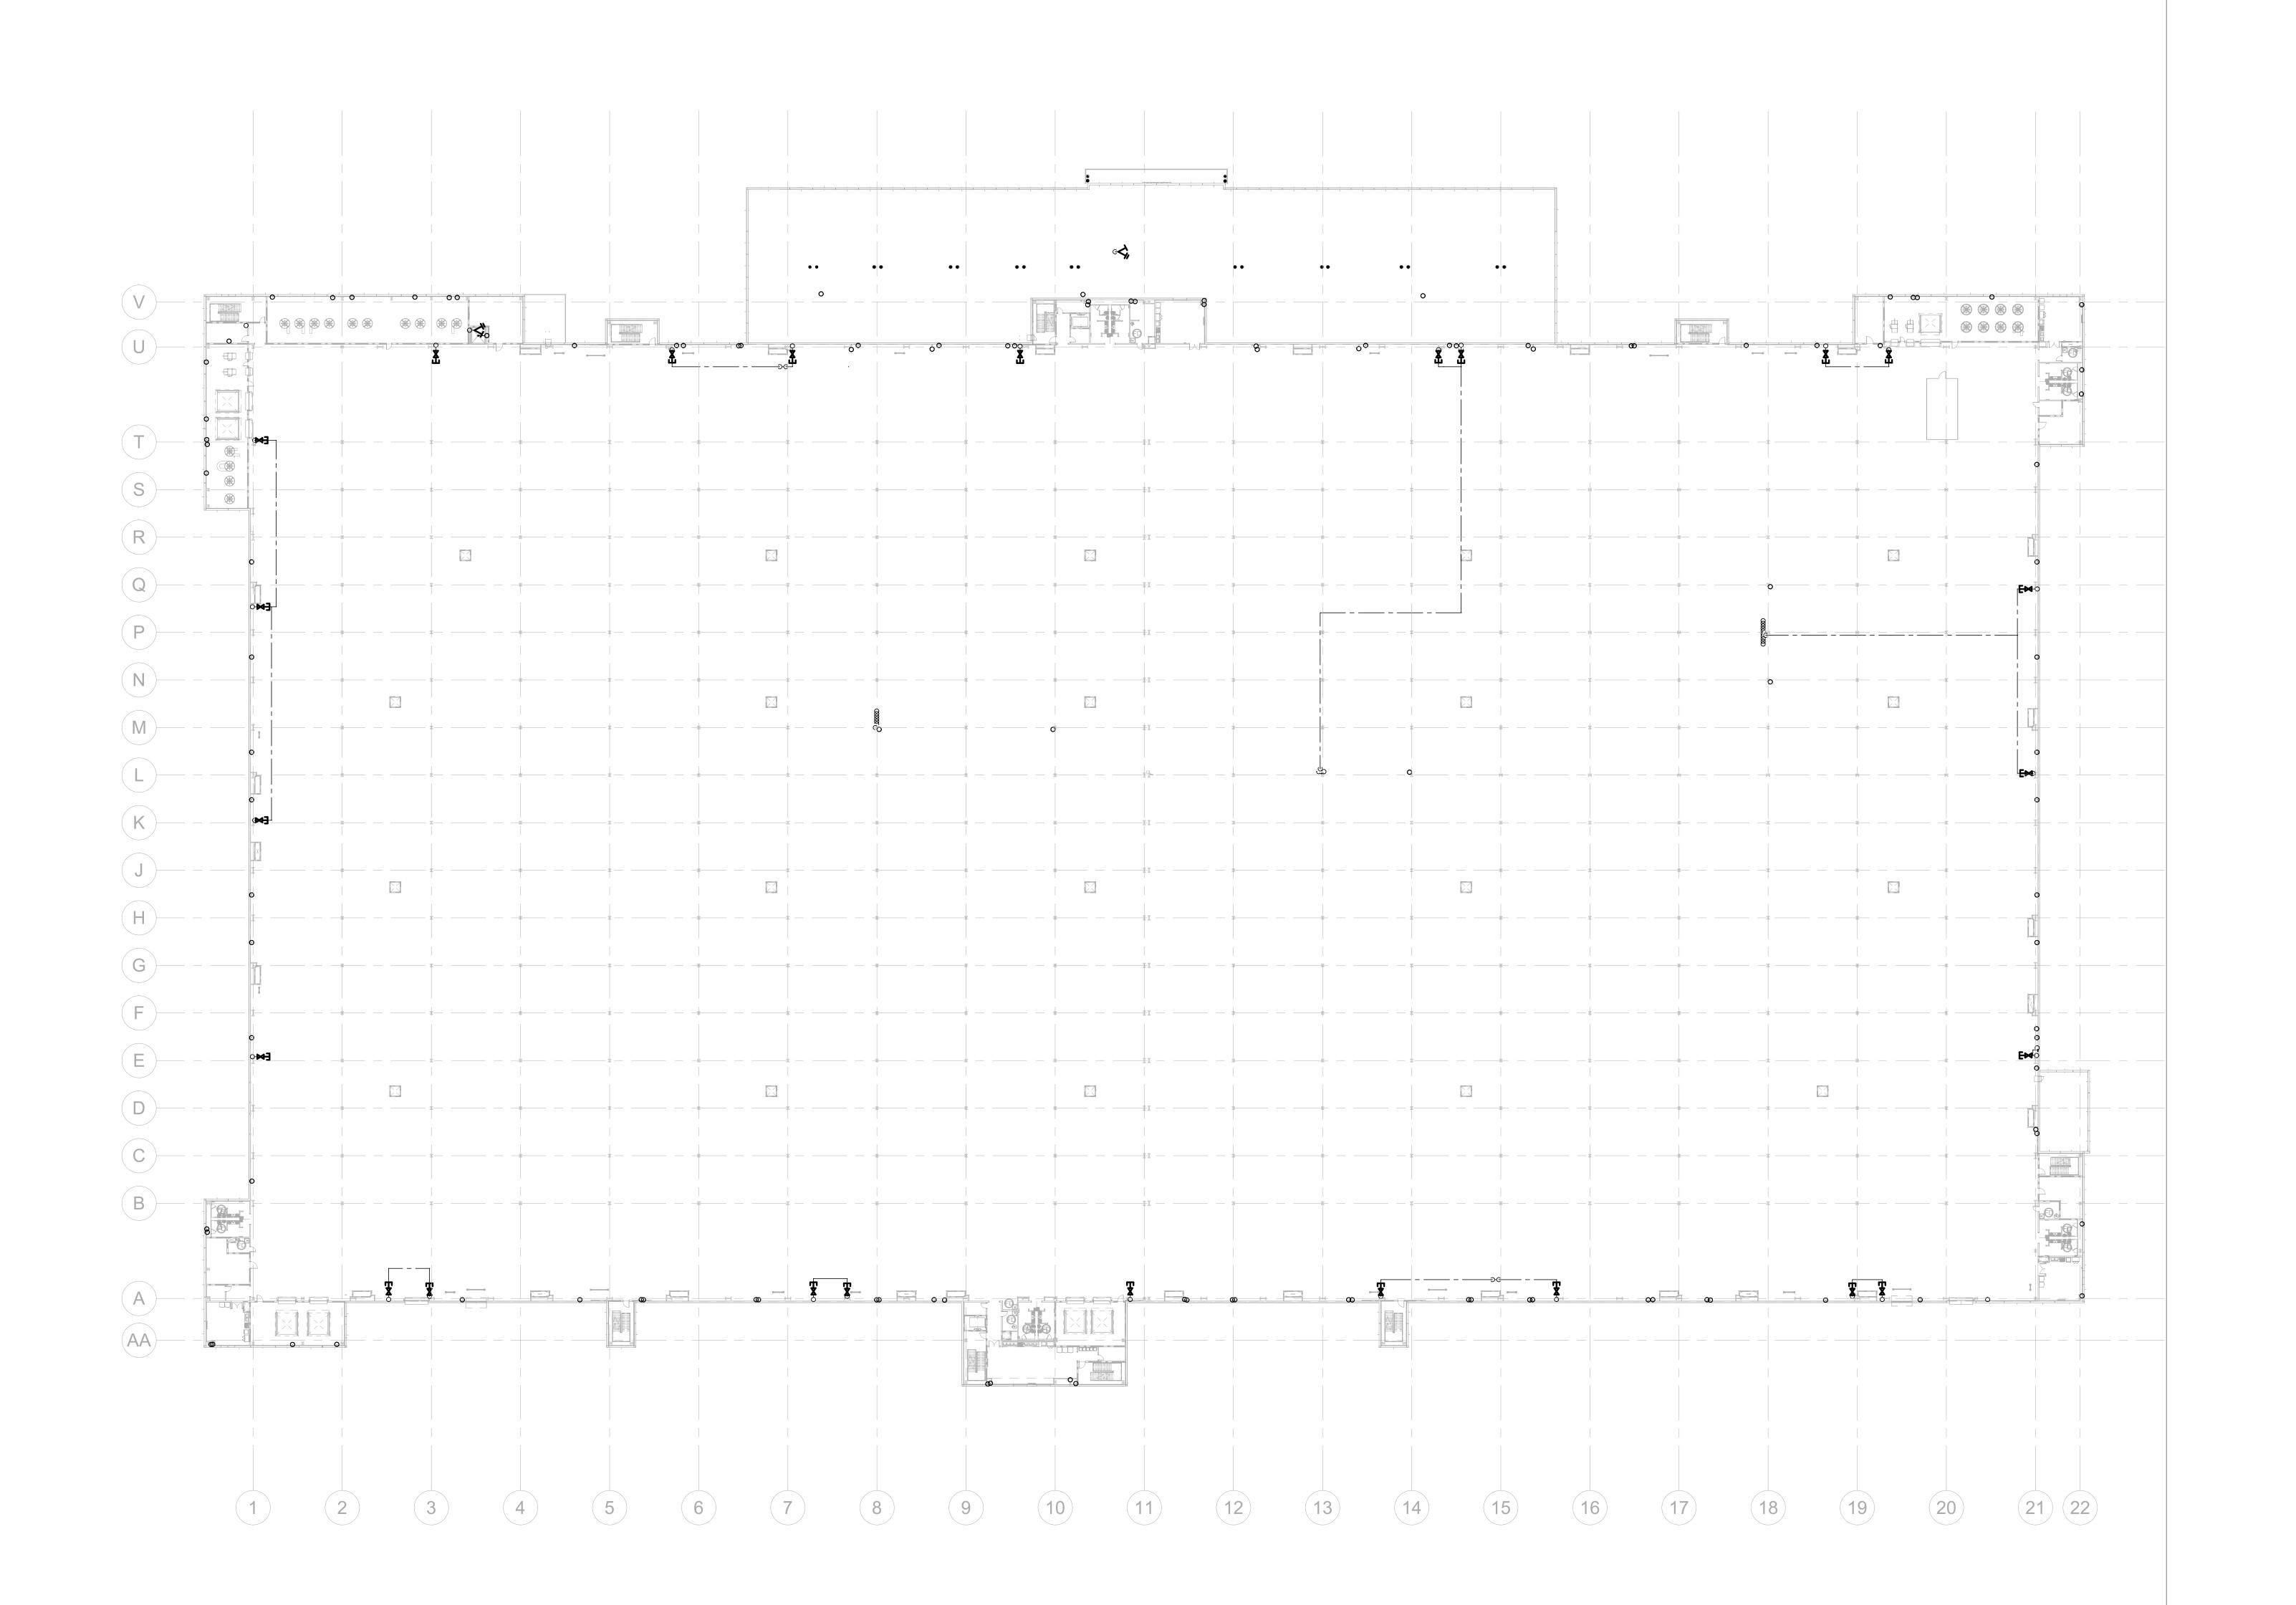
PARTIAL
FLOOR PLAN GROUND LEVEL
D - PLUMBING


SHEET NUMBER

P-205

NOT FOR CONSTRUCTION

1" = 20'-0"



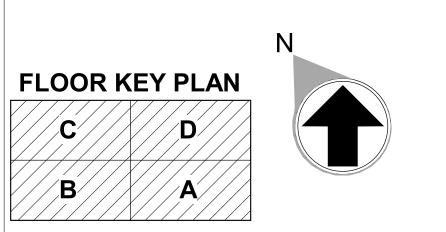

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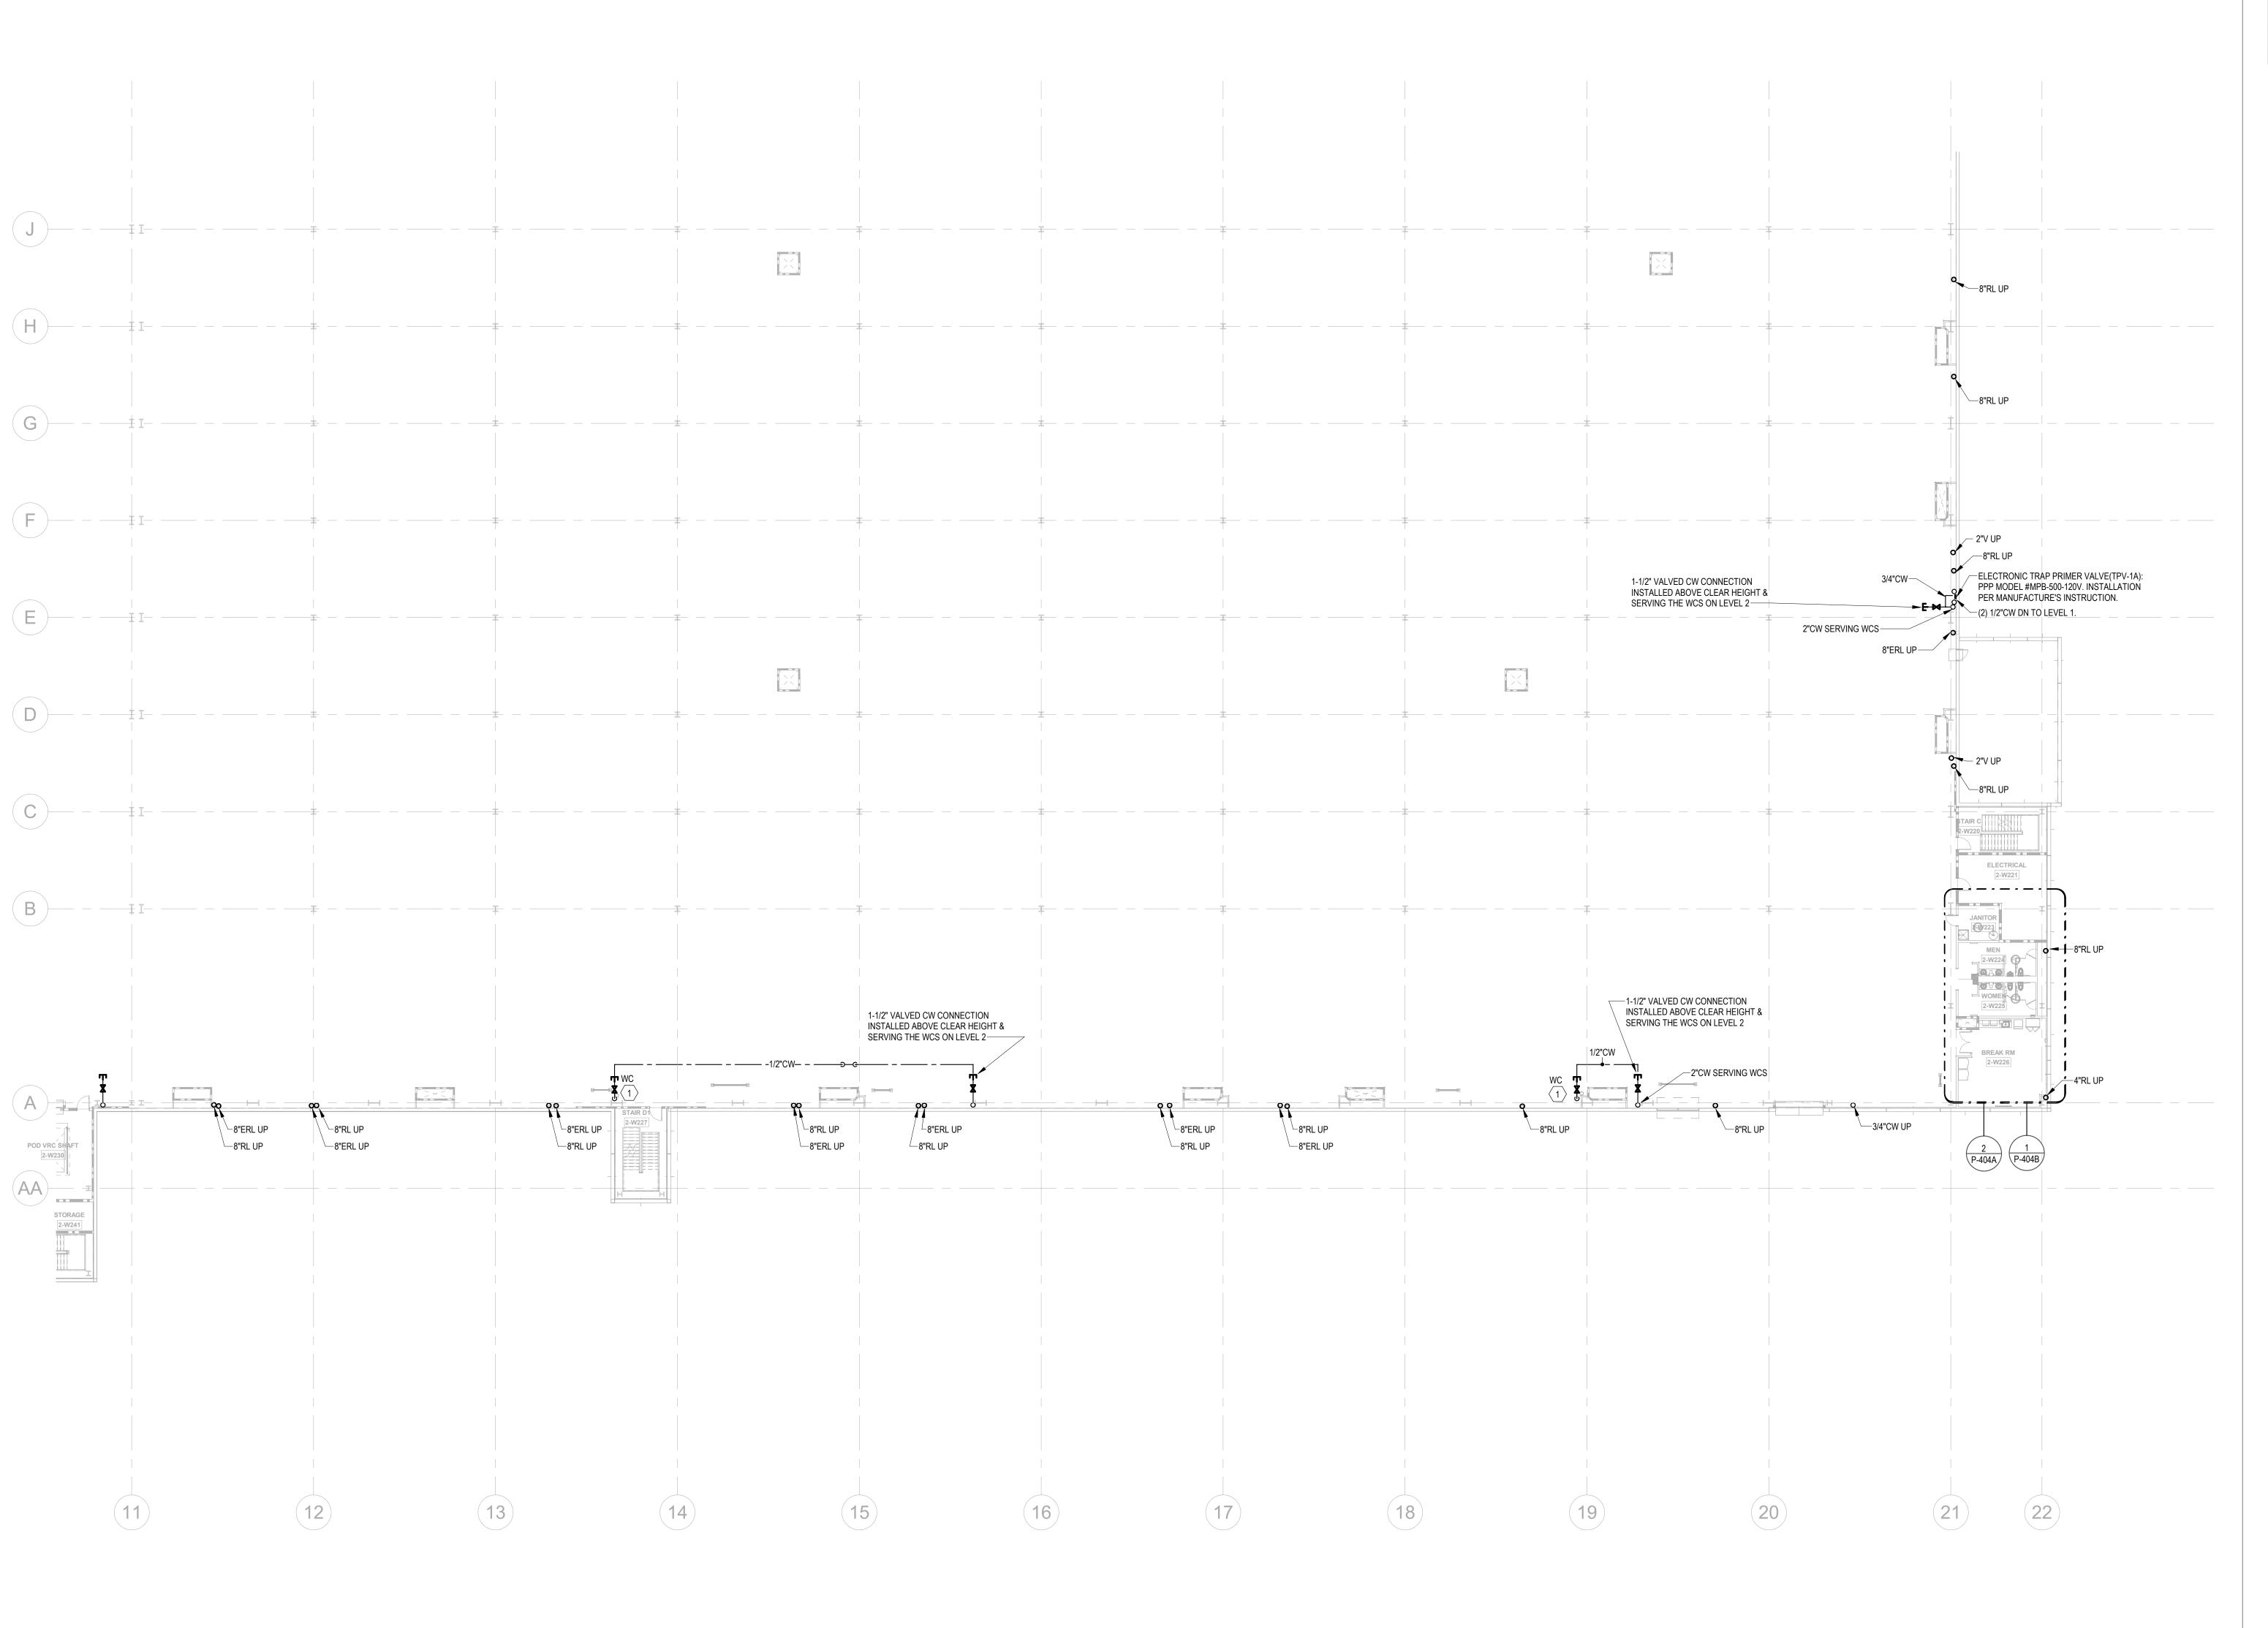
PROJECT WHALE

WILMINGTON, NC

2024-013 SHEET TITLE OVERALL FLOOR PLAN -LEVEL 2 -PLUMBING

SHEET NUMBER

P-206



PROVIDE 1/2" WATER TAP WITH BALL VALVE AND COPPER MANIFOLD. LOCATE BALL VALVE 8'-0" AFF. ROUTE 1/2" COPPER PIPING FROM TAP TO EACH OWNER PROVIDED WATER COOLER.

STUB COPPER PIPING 24" ABOVE FLOOR AT WATER COOLER LOCATION. PROVIDE 1/2" X 3/8" ANGLE STOP SUPPLY VALVE. ALL LOCATIONS TO BE REVIEWED BY TENANT PRIOR TO INSTALLATION.

10" STORM PIPE, REFER TO DETAIL 11 ON ARCHITECTURAL SHEET A-503. 4 FOR THIS RL, SEE SHEET P-003 DETAIL 6 FOR PIPE MATERIAL. MACGREGOR ASSOCIATES ARCHITECTS

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PROJECT WHALE

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2024-013 SHEET TITLE PARTIAL FLOOR PLAN -LEVEL 2 A -PLUMBING


SHEET NUMBER

FLOOR KEY PLAN N

P-207

PARTIAL FLOOR PLANS - LEVEL 2 - A - PLUMBING

1" = 20'-0"

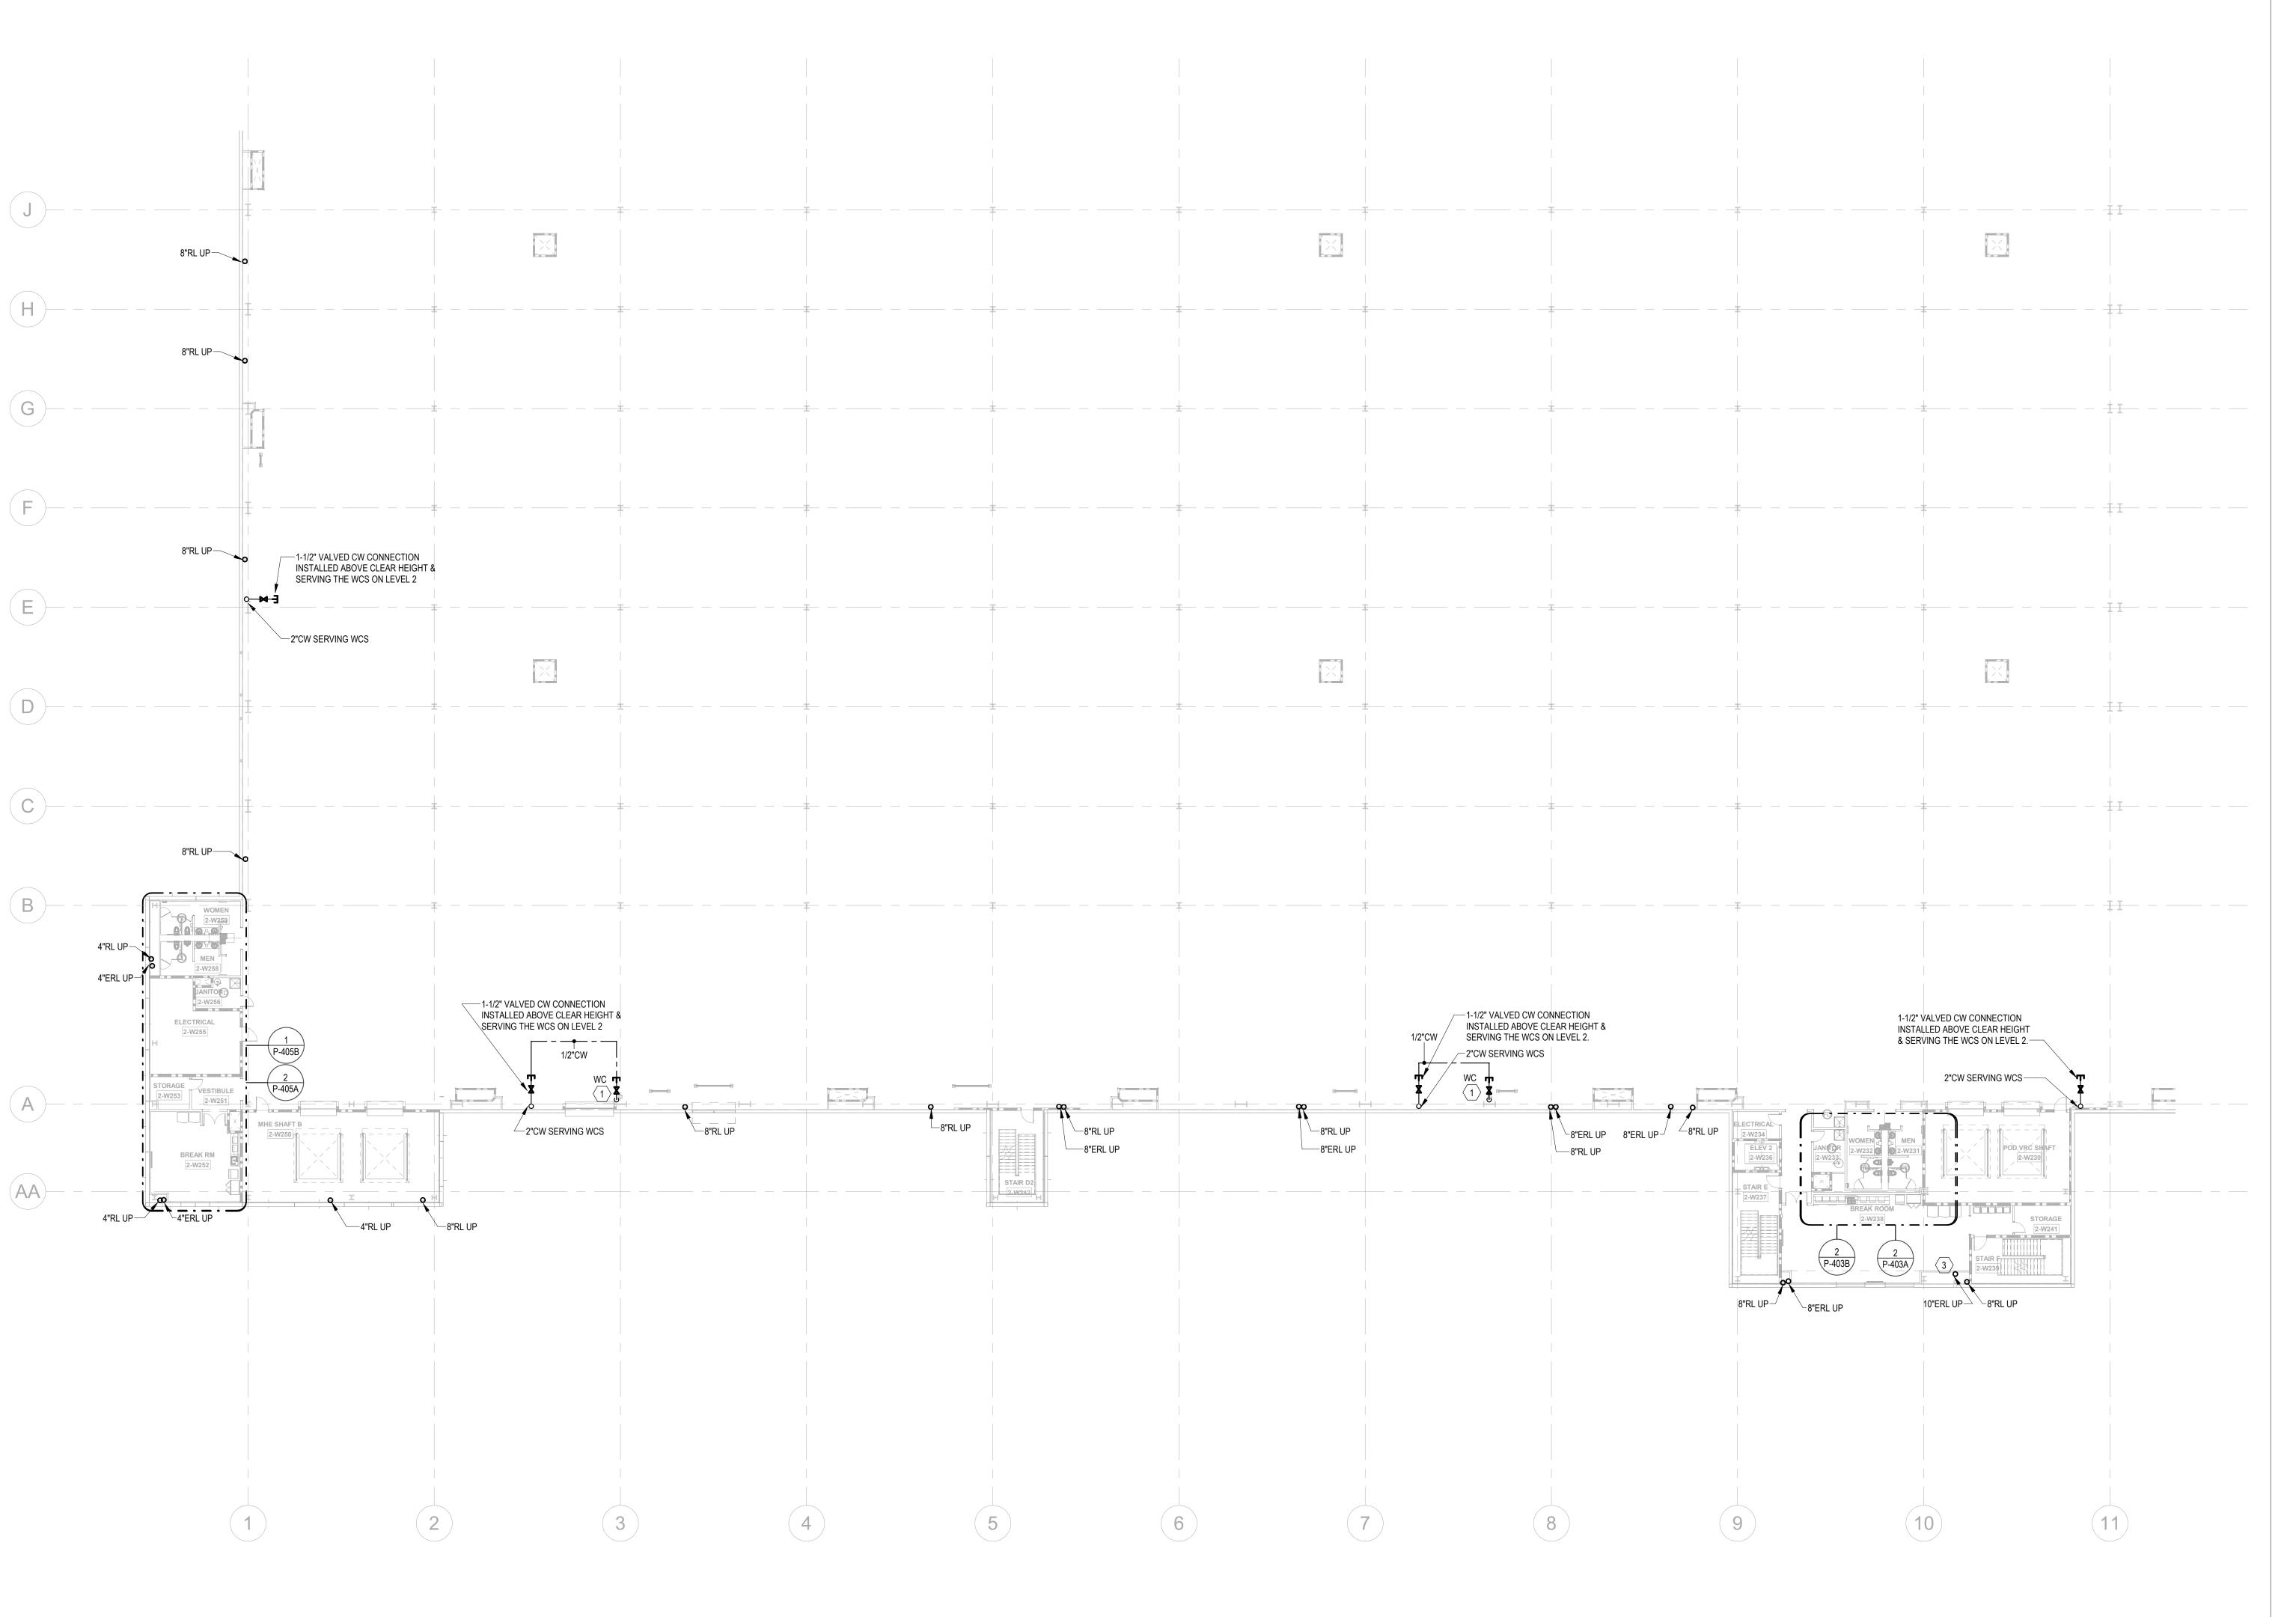

- PROVIDE 1/2" WATER TAP WITH BALL VALVE AND COPPER MANIFOLD. LOCATE BALL VALVE 8'-0" AFF. ROUTE 1/2" COPPER PIPING FROM TAP TO EACH OWNER PROVIDED WATER COOLER. STUB COPPER PIPING 24" ABOVE FLOOR AT WATER COOLER LOCATION. PROVIDE 1/2" X 3/8" ANGLE STOP SUPPLY VALVE. ALL LOCATIONS TO BE REVIEWED BY TENANT PRIOR TO INSTALLATION.

3 10" STORM PIPE, REFER TO DETAIL 11 ON ARCHITECTURAL SHEET A-503. 4 FOR THIS RL, SEE SHEET P-003 DETAIL 6 FOR PIPE MATERIAL. MACGREGOR ASSOCIATES ARCHITECTS

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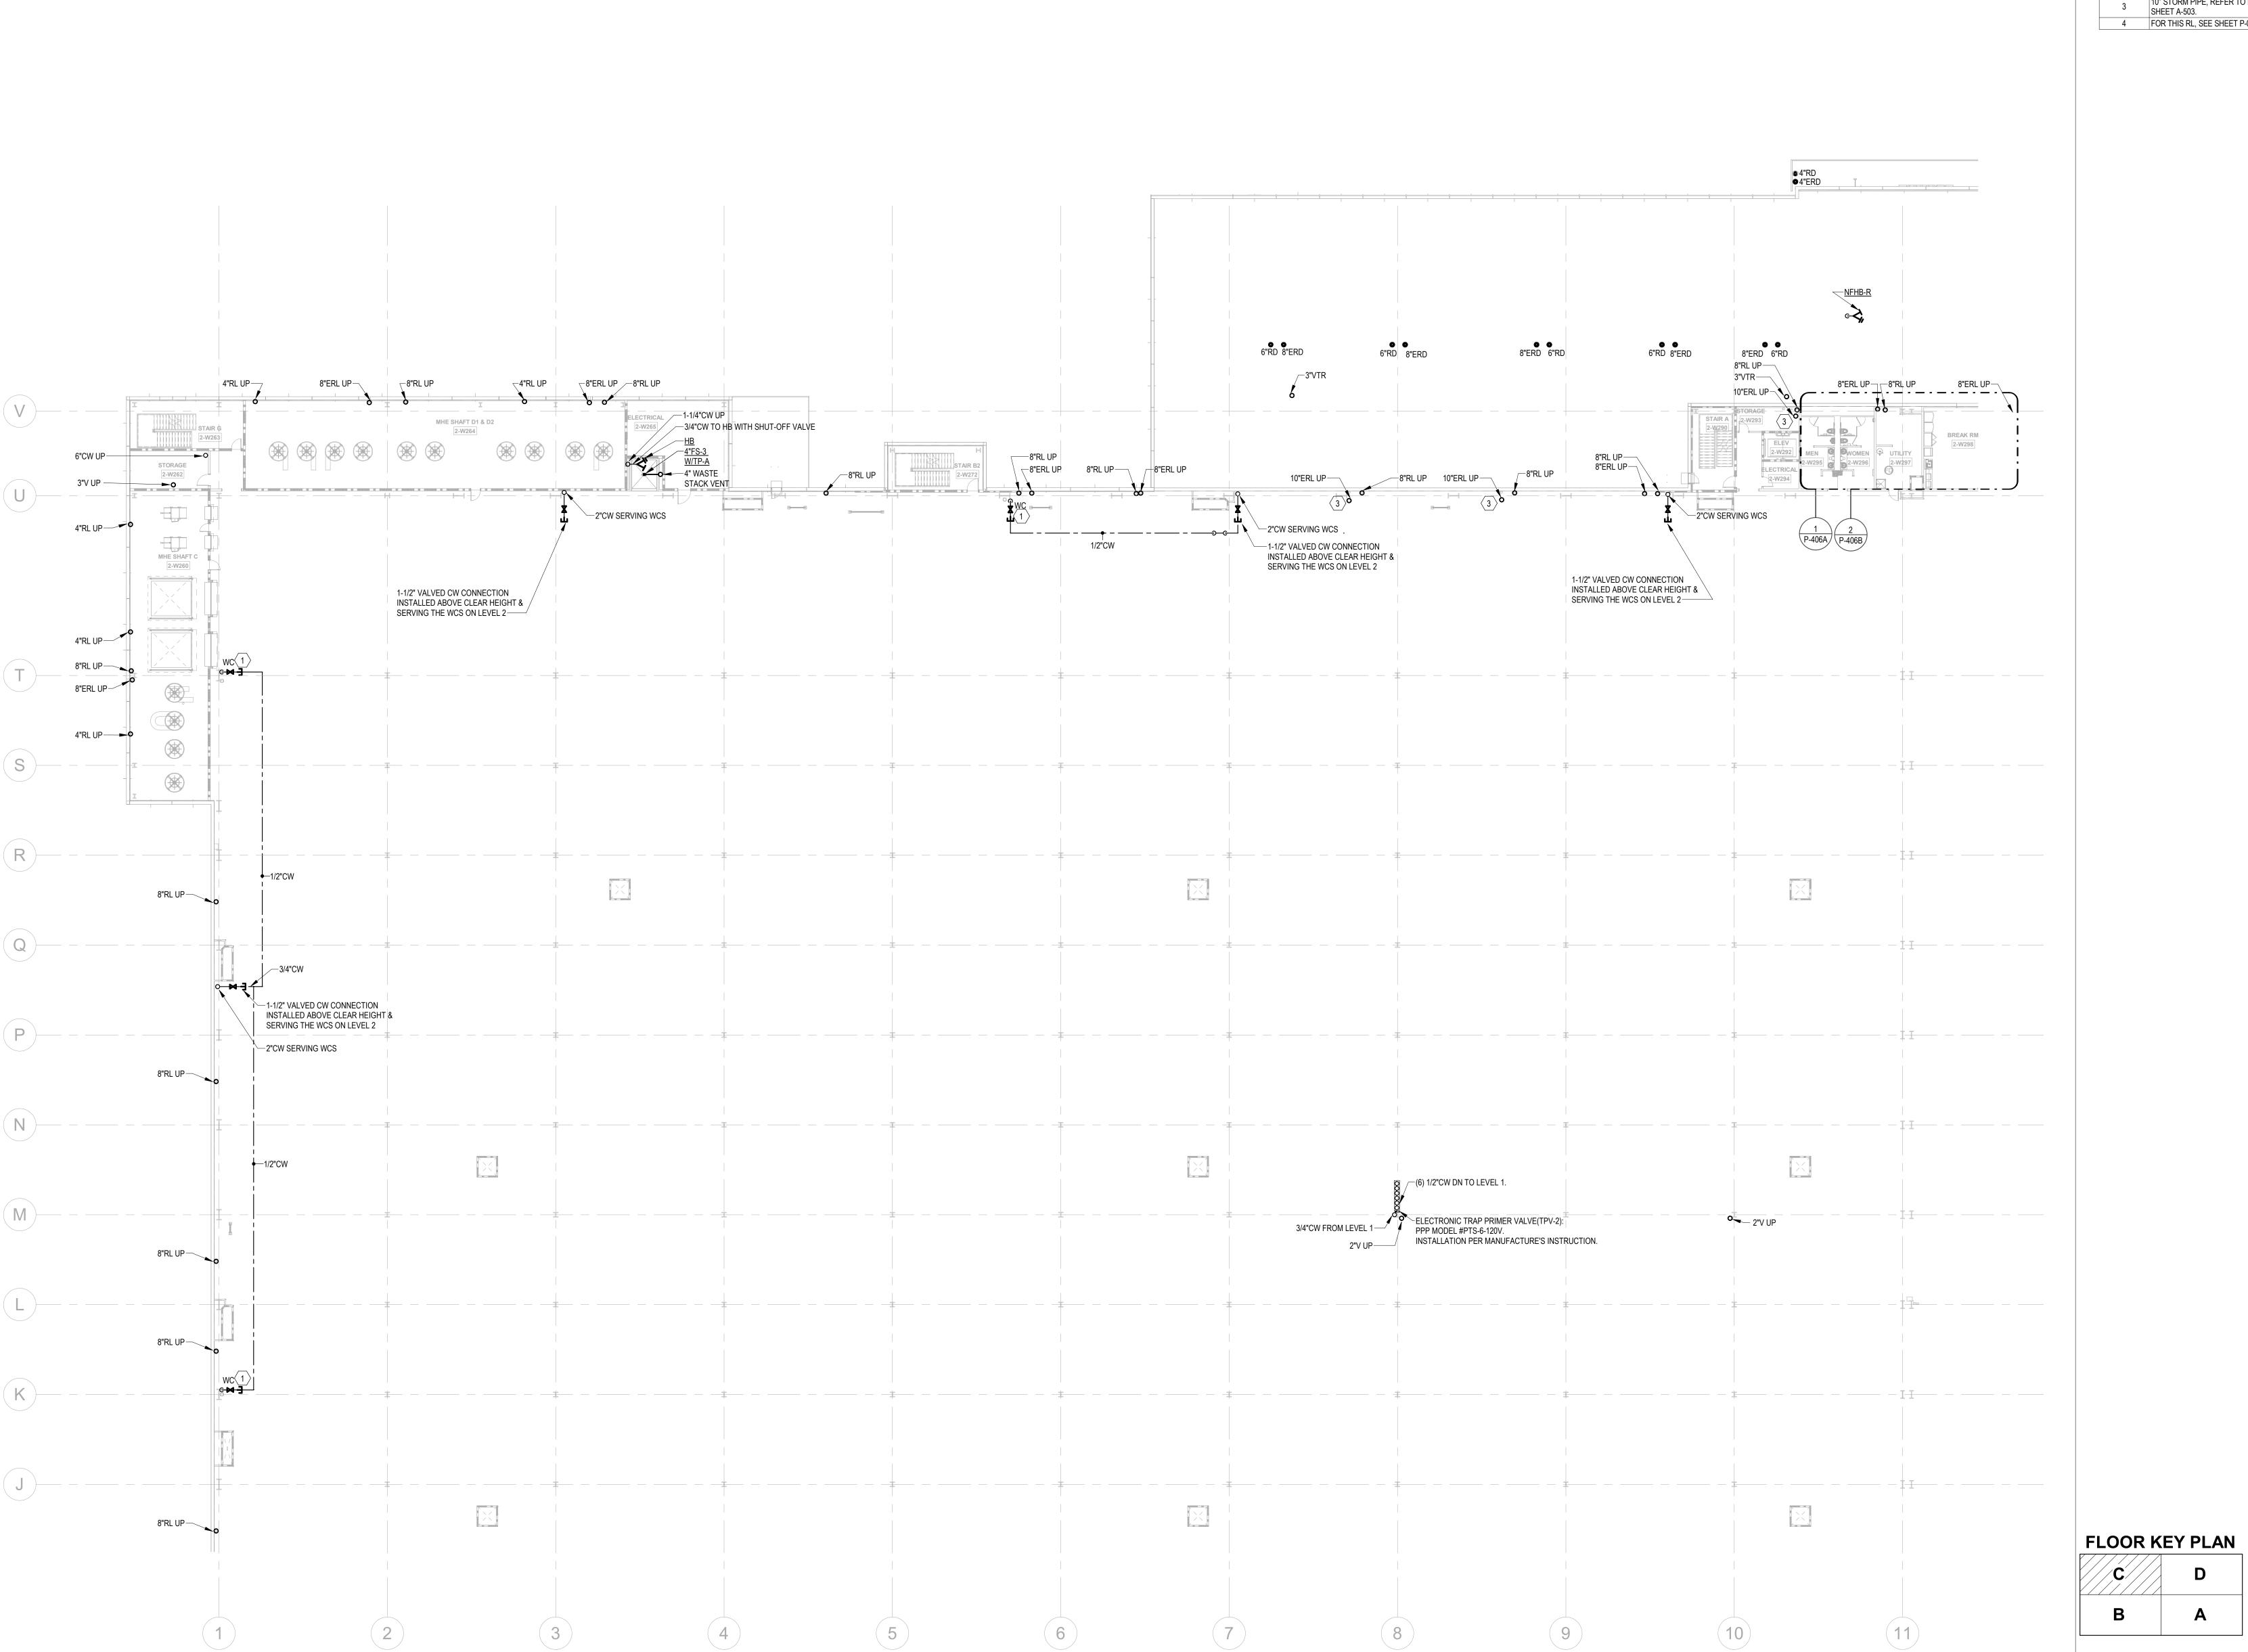
SHEET TITLE PARTIAL FLOOR PLAN -LEVEL 2 B -PLUMBING

NOT FOR CONSTRUCTION

SHEET NUMBER

FLOOR KEY PLAN N

P-208



- PROVIDE 1/2" WATER TAP WITH BALL VALVE AND COPPER MANIFOLD. LOCATE BALL VALVE 8'-0" AFF. ROUTE 1/2" COPPER PIPING FROM TAP TO EACH OWNER PROVIDED WATER COOLER. STUB COPPER PIPING 24" ABOVE FLOOR AT WATER COOLER LOCATION. PROVIDE 1/2" X 3/8" ANGLE STOP SUPPLY VALVE. ALL LOCATIONS TO BE REVIEWED BY TENANT PRIOR TO INSTALLATION.
- 10" STORM PIPE, REFER TO DETAIL 11 ON ARCHITECTURAL SHEET A-503. 4 FOR THIS RL, SEE SHEET P-003 DETAIL 6 FOR PIPE MATERIAL.

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PROJECT INFORMATION

PROJECT


WILMINGTON, NC

2024-013 SHEET TITLE

PARTIAL FLOOR PLAN -LEVEL 2 C -PLUMBING

NOT FOR CONSTRUCTION

P-209

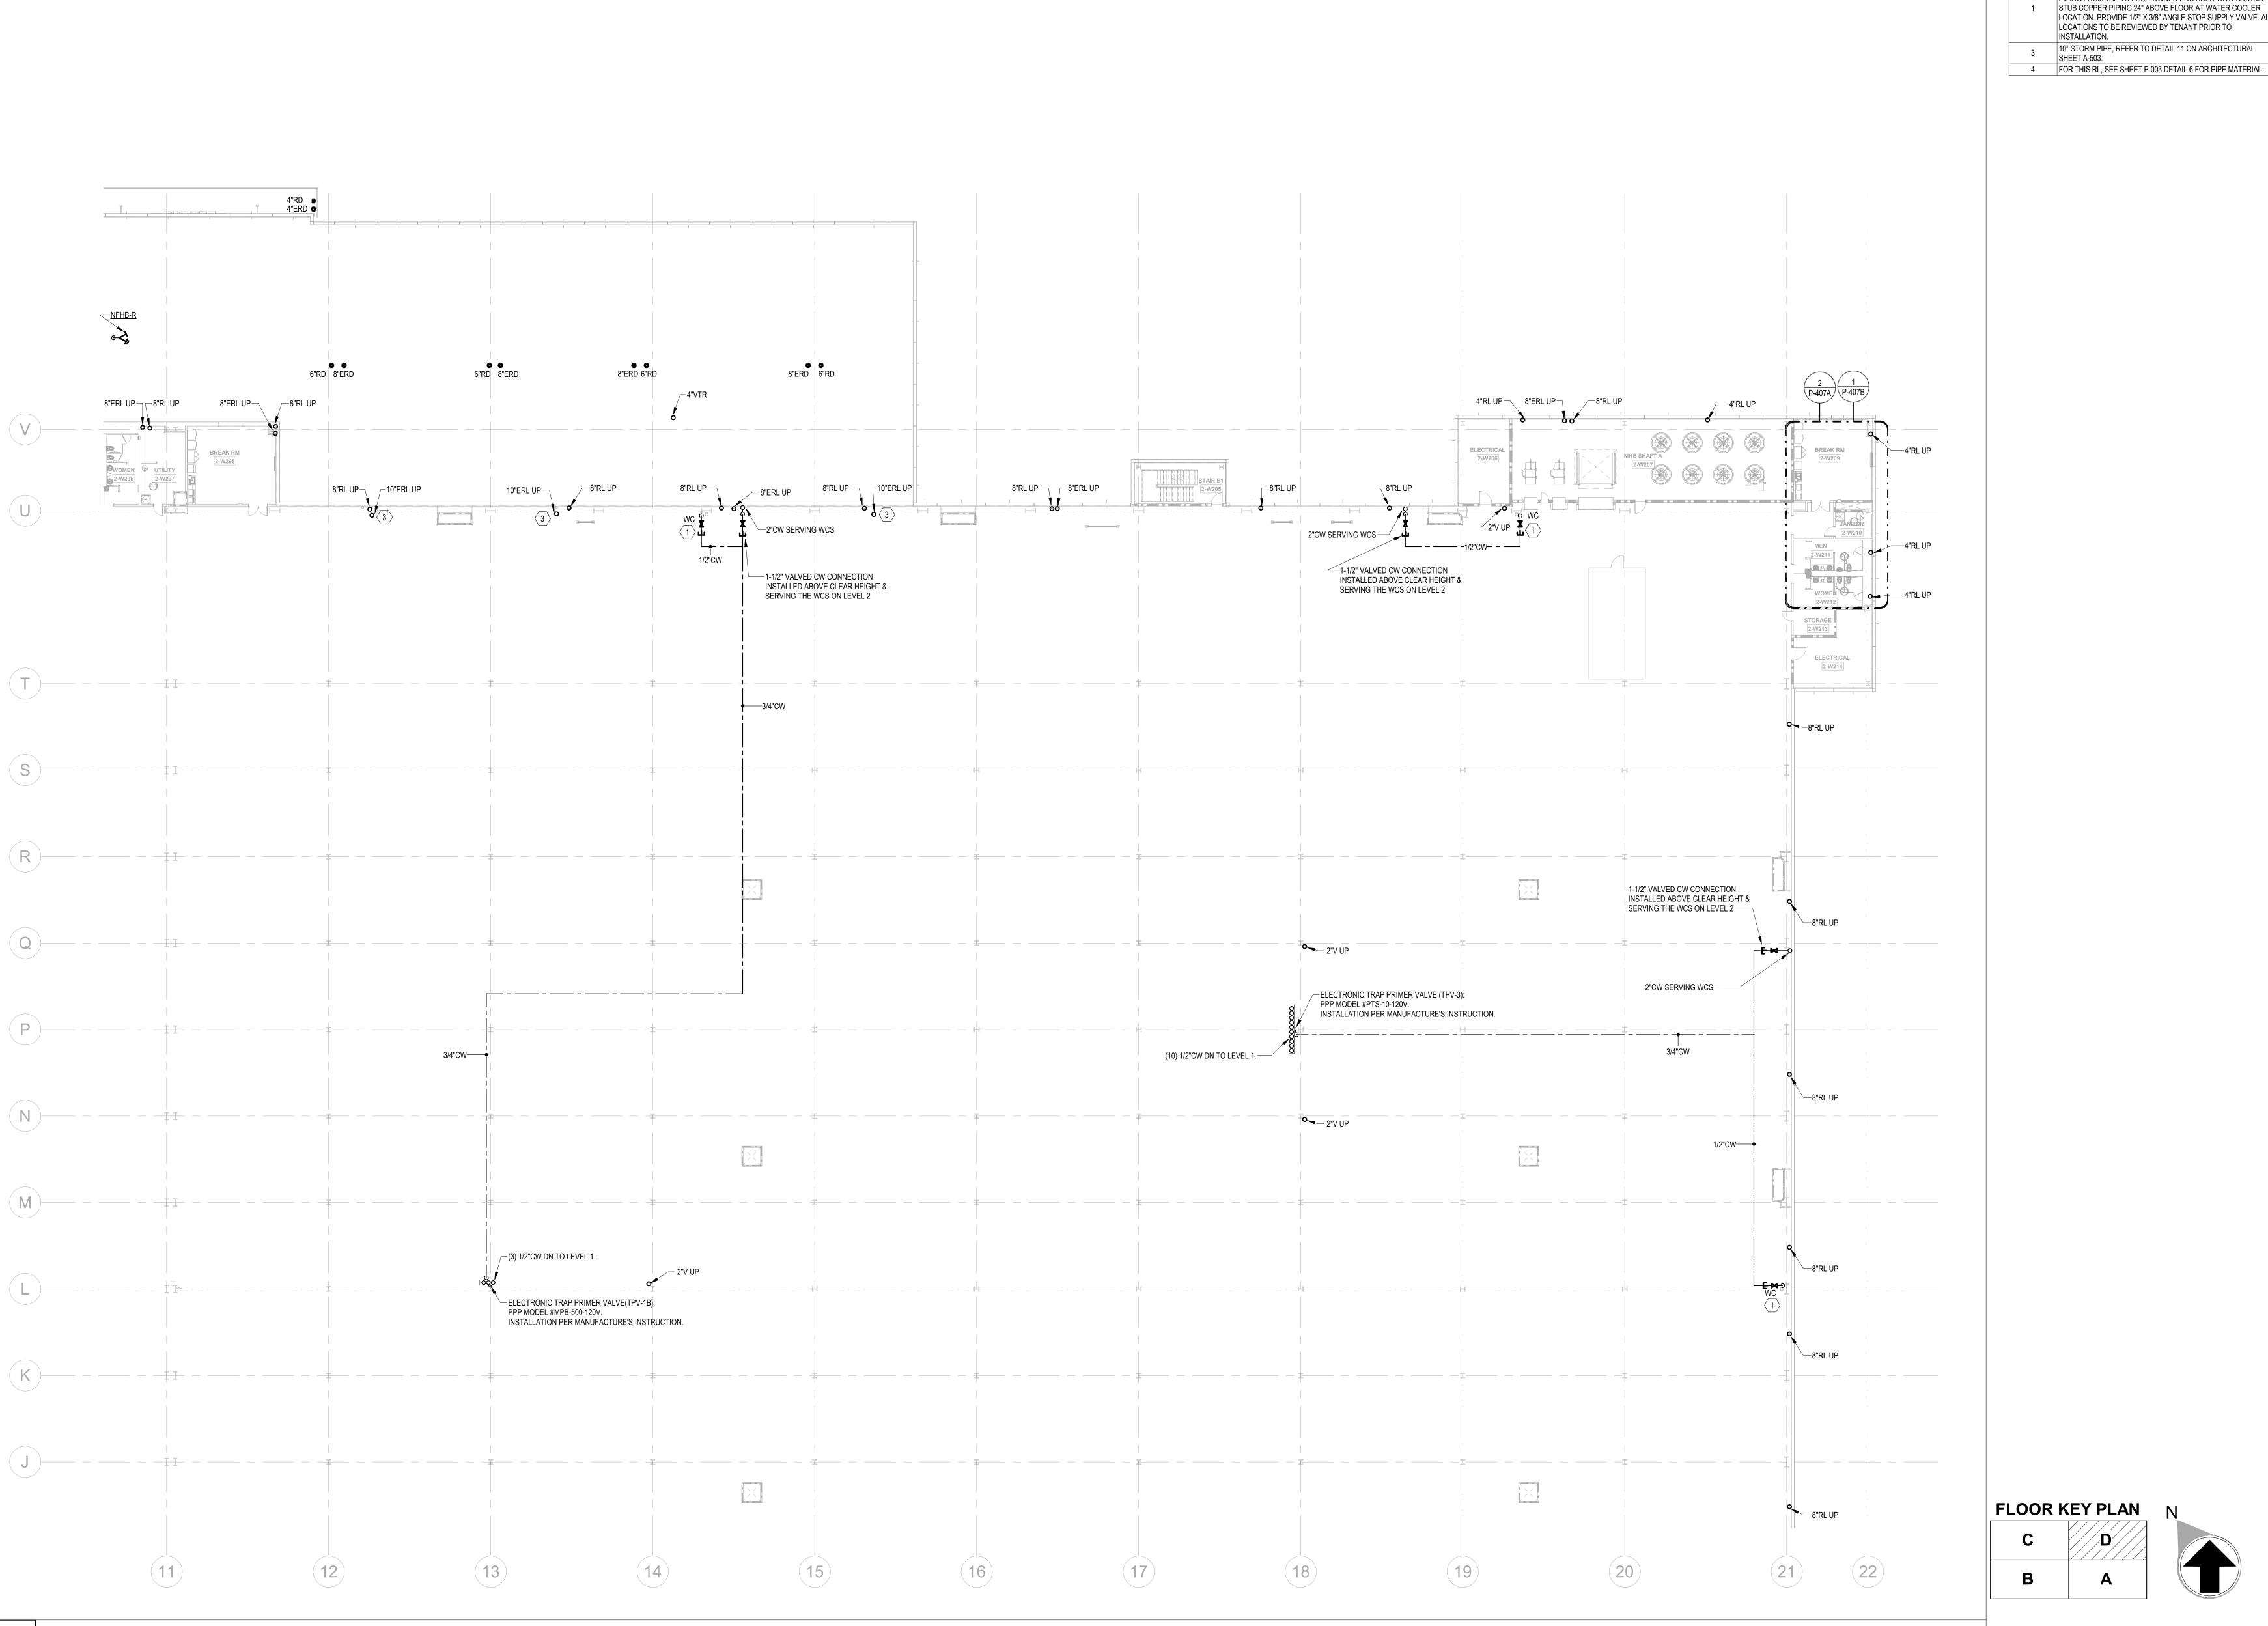

PROVIDE 1/2" WATER TAP WITH BALL VALVE AND COPPER MANIFOLD. LOCATE BALL VALVE 8'-0" AFF. ROUTE 1/2" COPPER PIPING FROM TAP TO EACH OWNER PROVIDED WATER COOLER. STUB COPPER PIPING 24" ABOVE FLOOR AT WATER COOLER LOCATION. PROVIDE 1/2" X 3/8" ANGLE STOP SUPPLY VALVE. ALL

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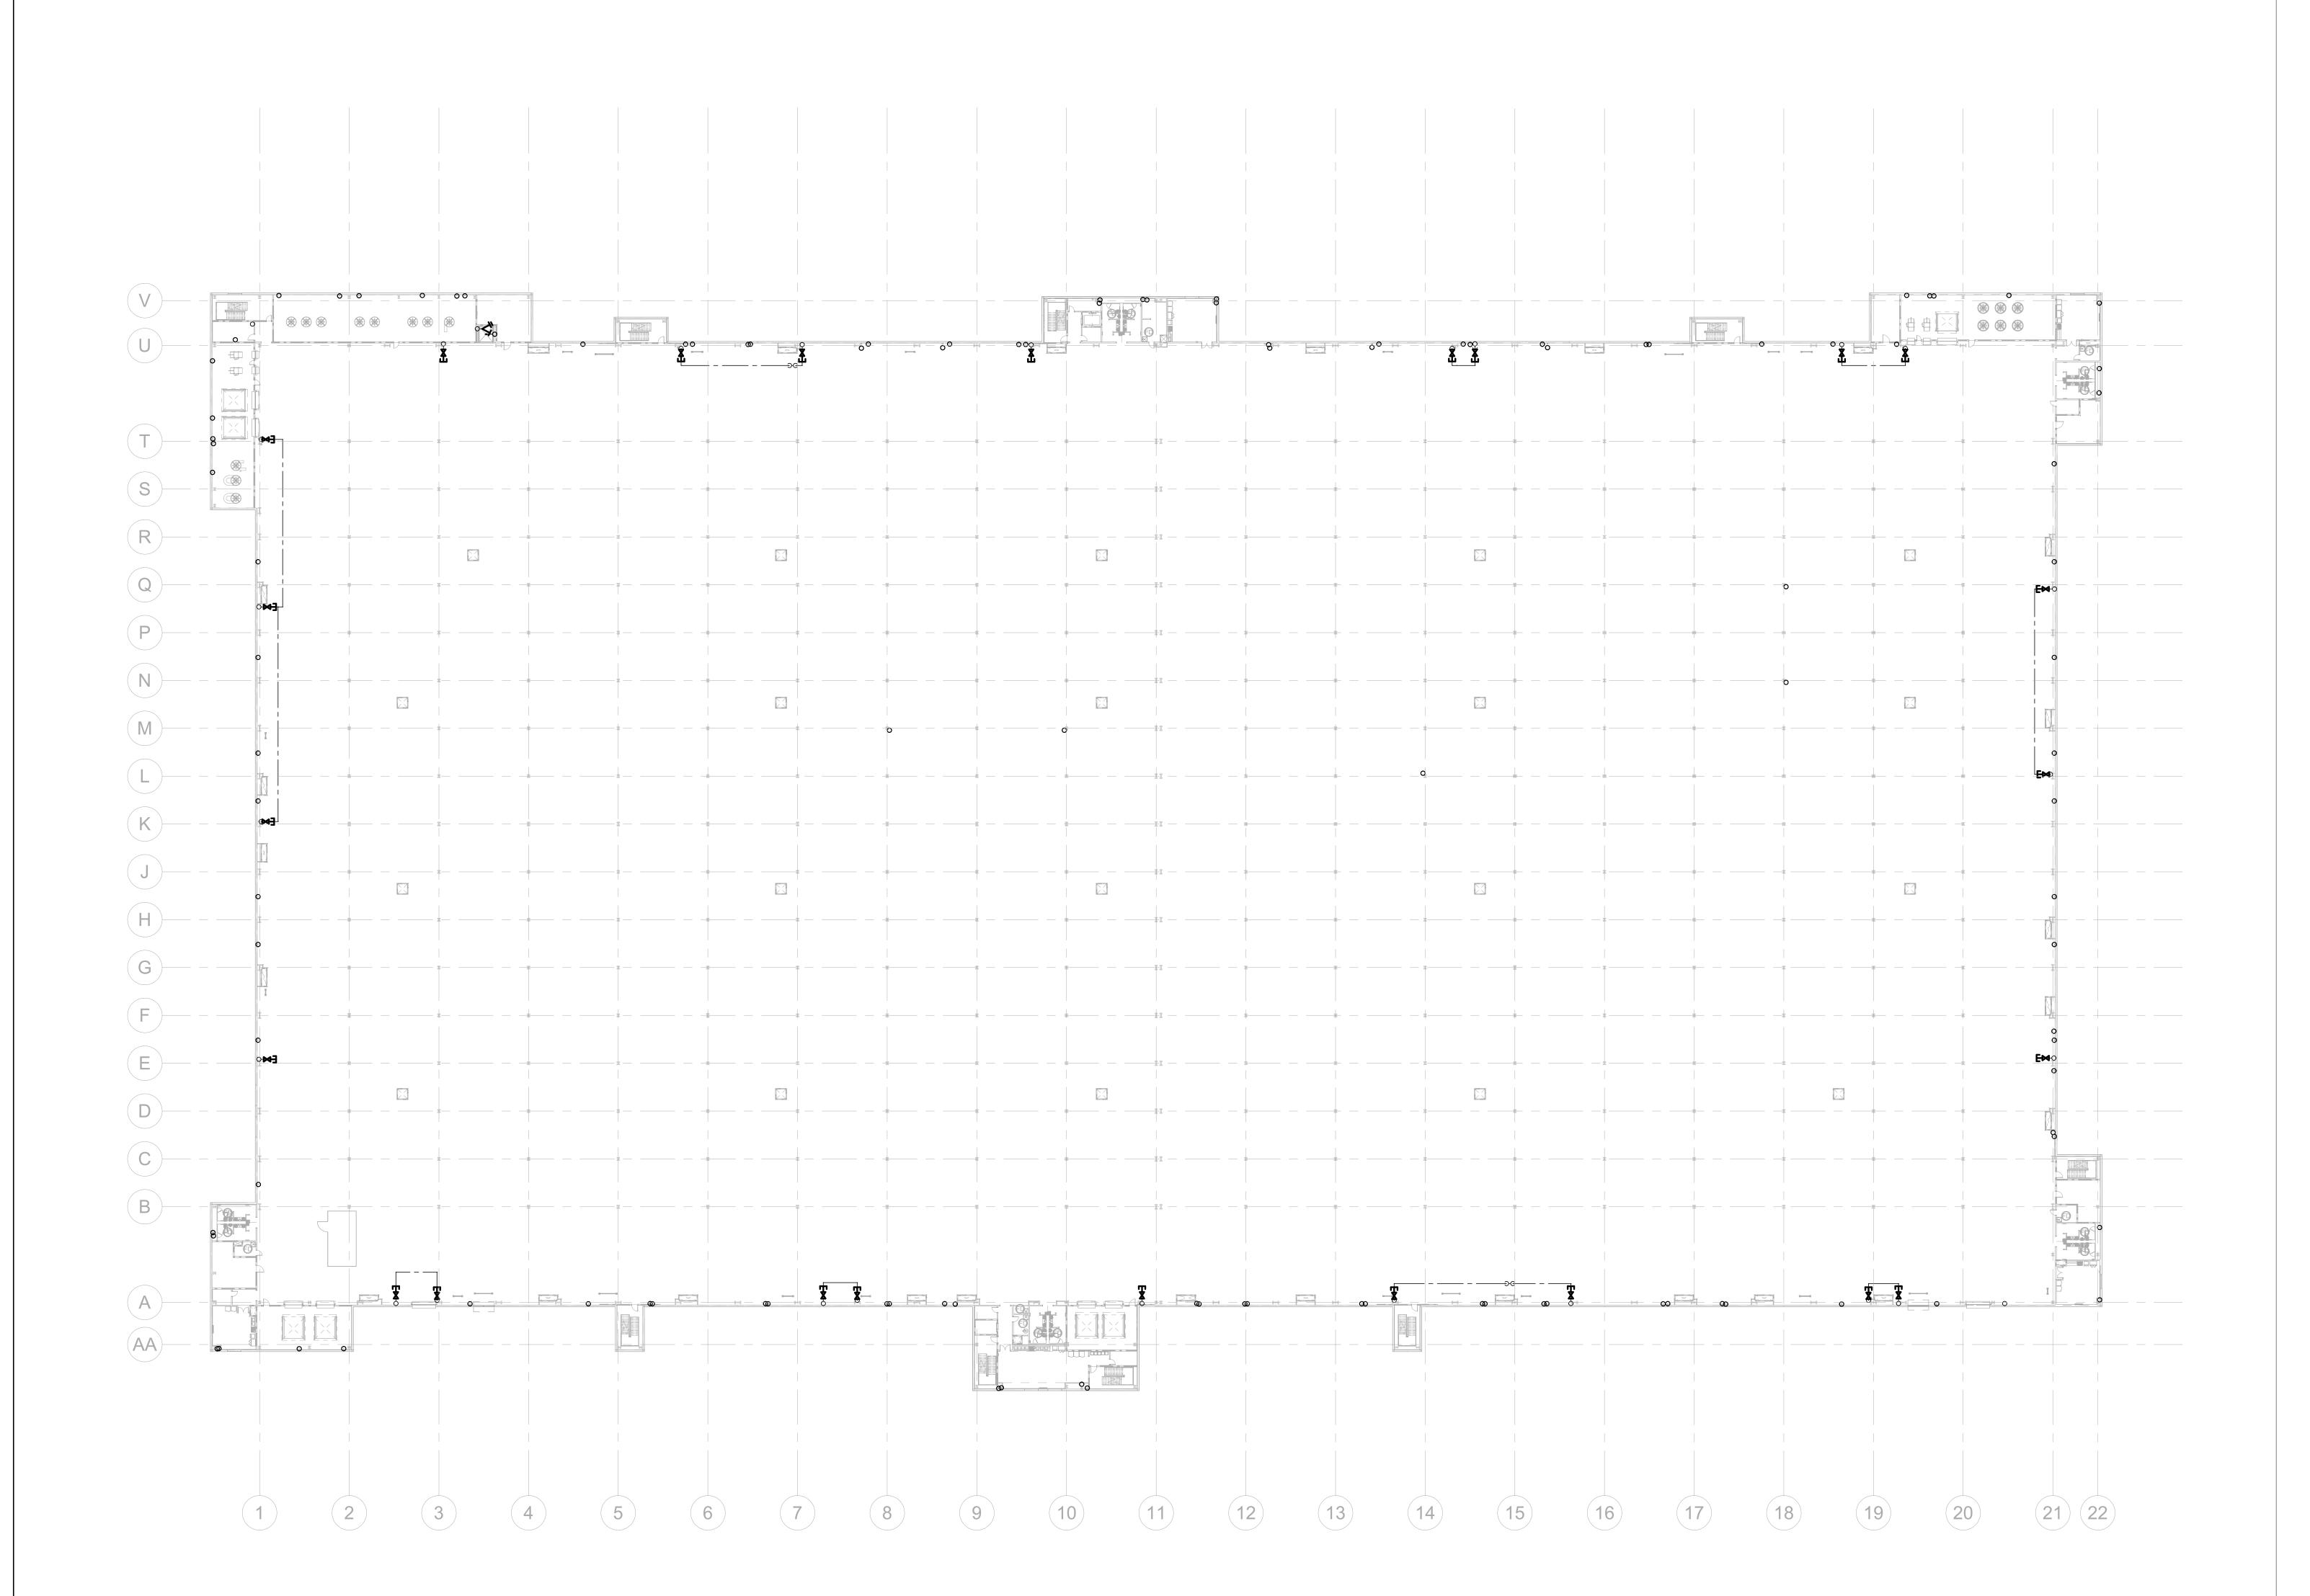
PROJECT

WILMINGTON, NC

2024-013

SHEET TITLE PARTIAL FLOOR PLAN -LEVEL 2 D -PLUMBING

SHEET NUMBER P-210



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PRINT RECORD

NUMBER DATE DESCRIPTION

06/10/24 PRICING SET

PROJECT WHALE

WILMINGTON, NC

SEEFRIED INDUSTRIAL PROPERTIES

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Macgregor Associates Architects, Inc. - 1987-2024

DATE
-- 2024-013

SHEET TITLE
OVERALL
FLOOR PLAN LEVEL 3 PLUMBING

P-211


NOT FOR CONSTRUCTION

FLOOR KEY PLAN

C

B

A

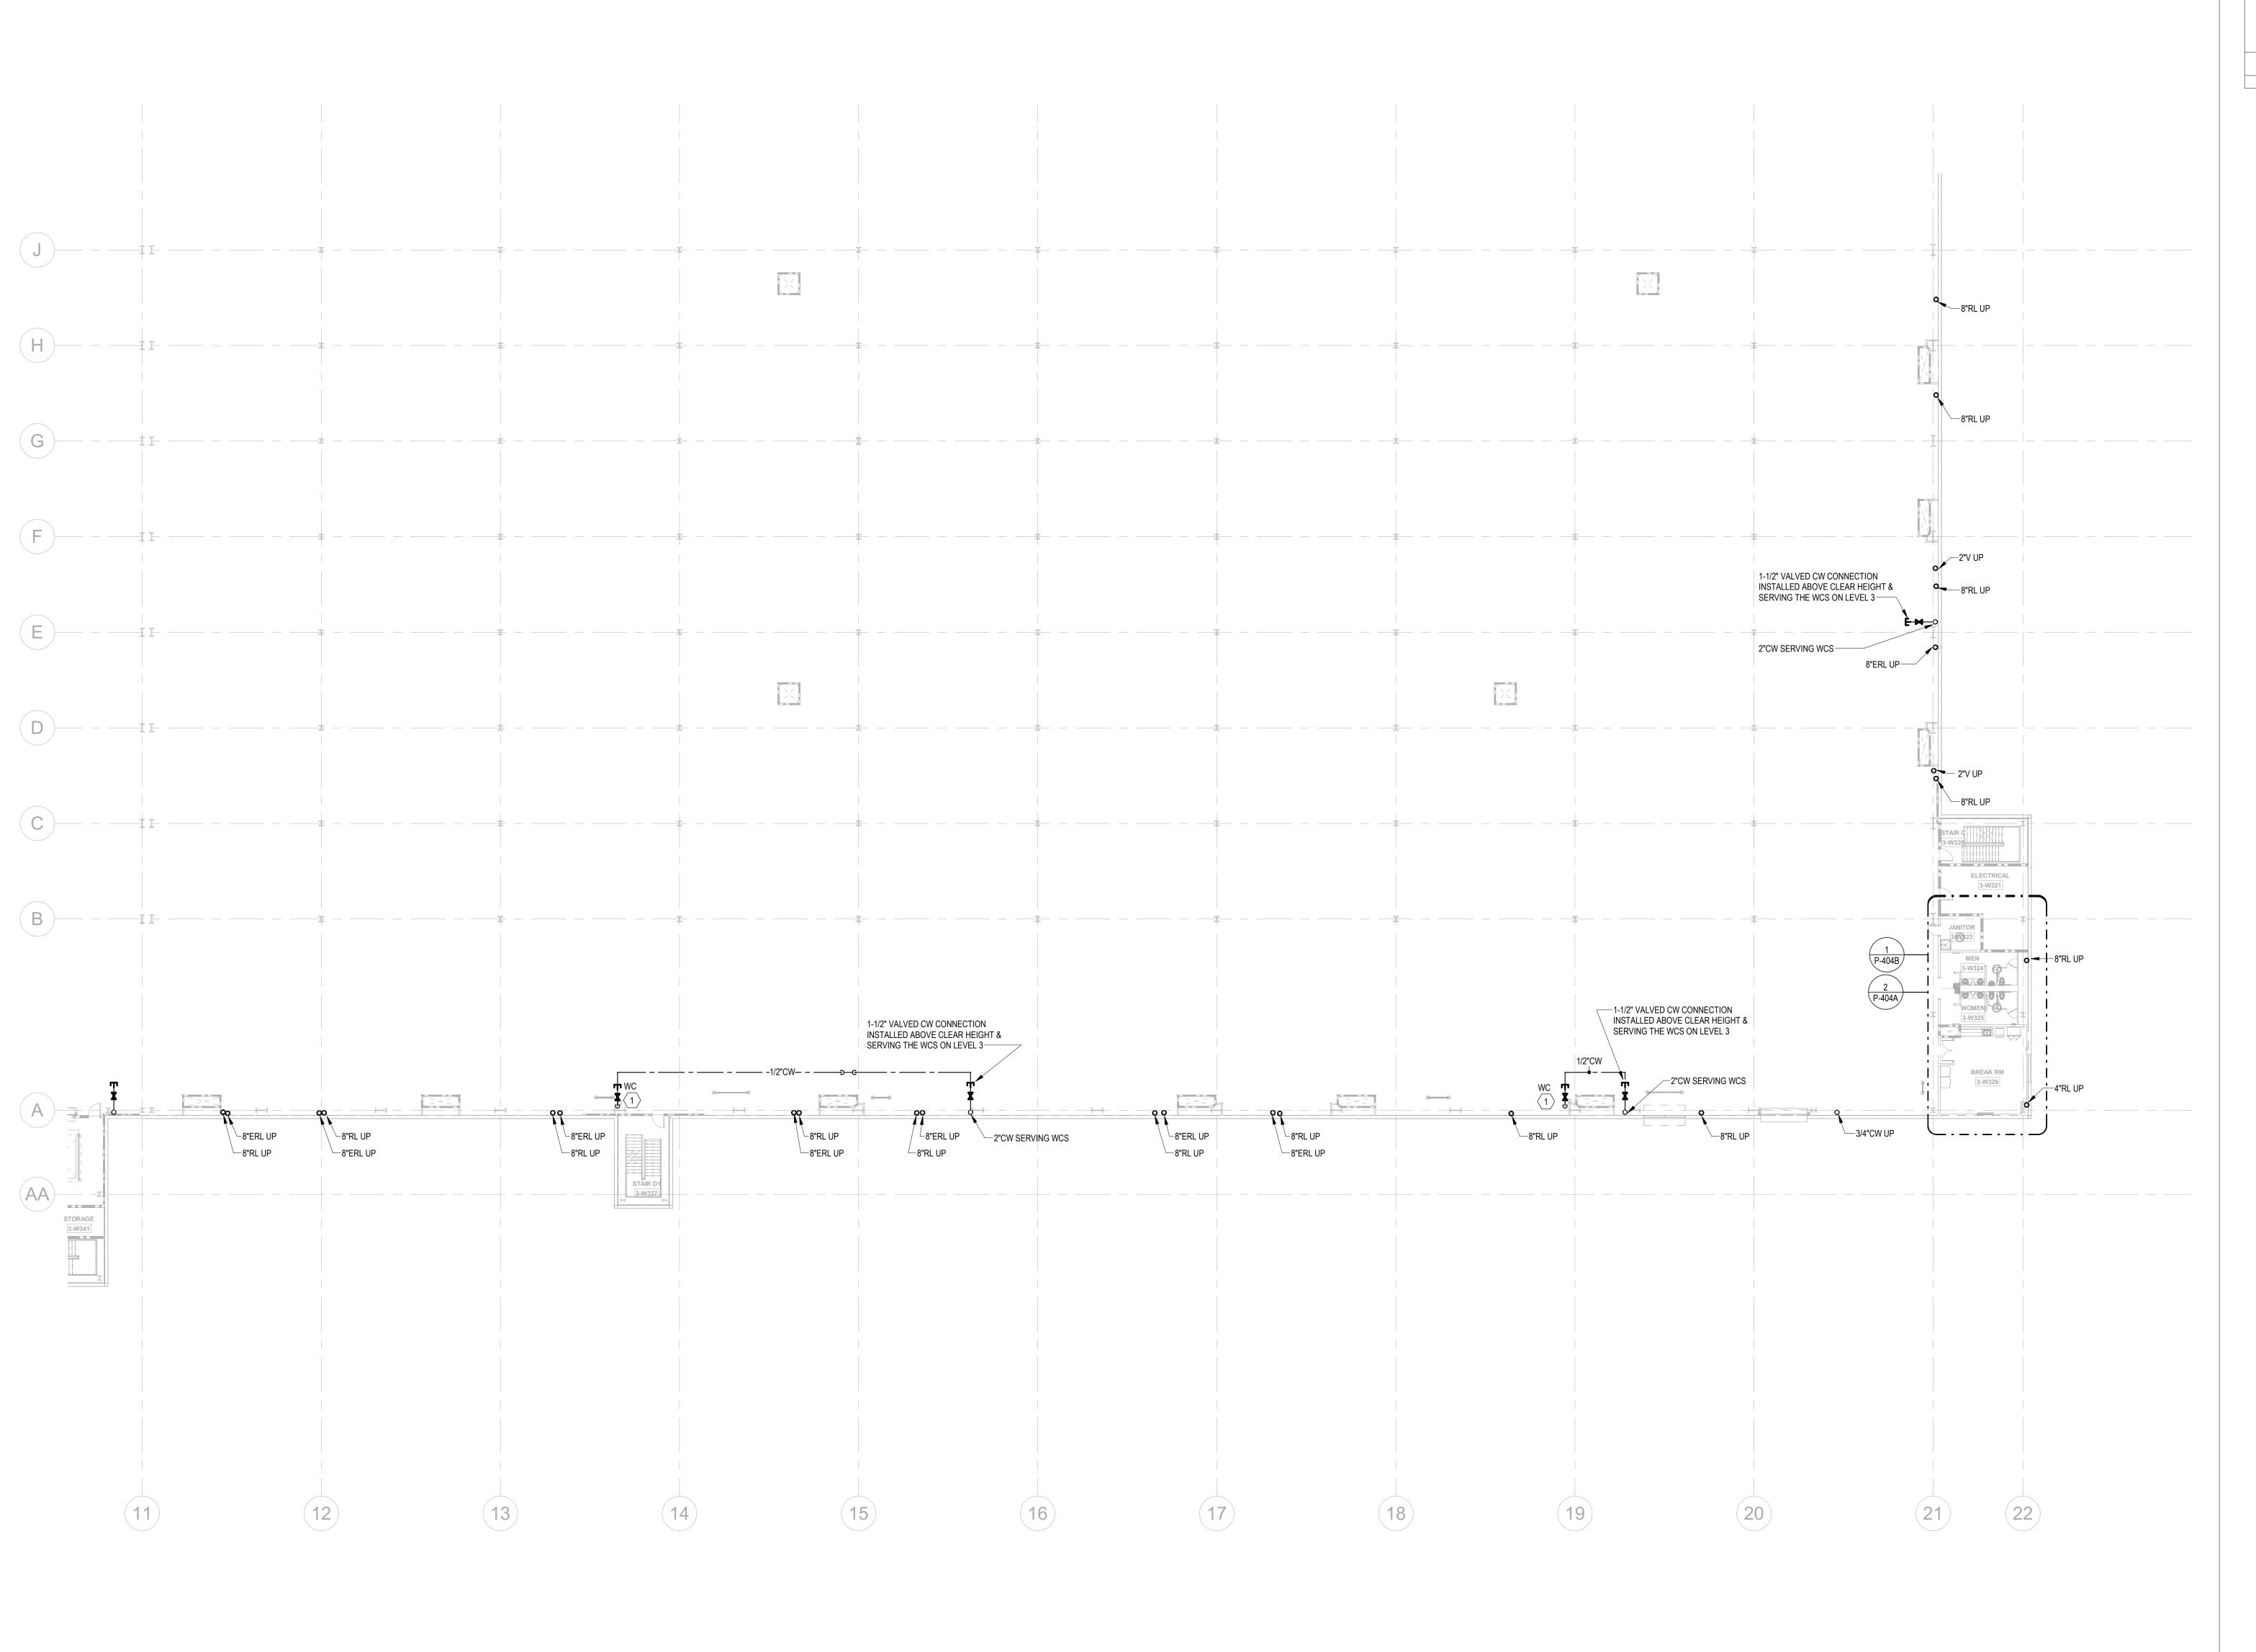

KEYNO'

- PROVIDE 1/2" WATER TAP WITH BALL VALVE AND COPPER MANIFOLD. LOCATE BALL VALVE 8'-0" AFF. ROUTE 1/2" COPPER PIPING FROM TAP TO EACH OWNER PROVIDED WATER COOLER.

 STUB COPPER PIPING 24" ABOVE FLOOR AT WATER COOLER LOCATION. PROVIDE 1/2" X 3/8" ANGLE STOP SUPPLY VALVE. ALL LOCATIONS TO BE REVIEWED BY TENANT PRIOR TO INSTALLATION.
- 3 10" STORM PIPE, REFER TO DETAIL 11 ON ARCHITECTURAL SHEET A-503.
 4 FOR THIS RL, SEE SHEET P-003 DETAIL 6 FOR PIPE MATERIAL.

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p. 770.447.5547 • f. 770.448.0262

Project Number: 24010155
Drawn By:CF Checked By:JMW

BER DATE DESCRIPTION

06/10/24 PRICING SET

PROJECT INFORMATION

PROJECT WHALE

WILMINGTON, NC

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DATE
PROJECT NO
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SHEETTITLE
PARTIAL
FLOOR PLAN -


LEVEL 3 A PLUMBING

FLOOR KEY PLAN N

SHEET NUMBER

D_919

P-212

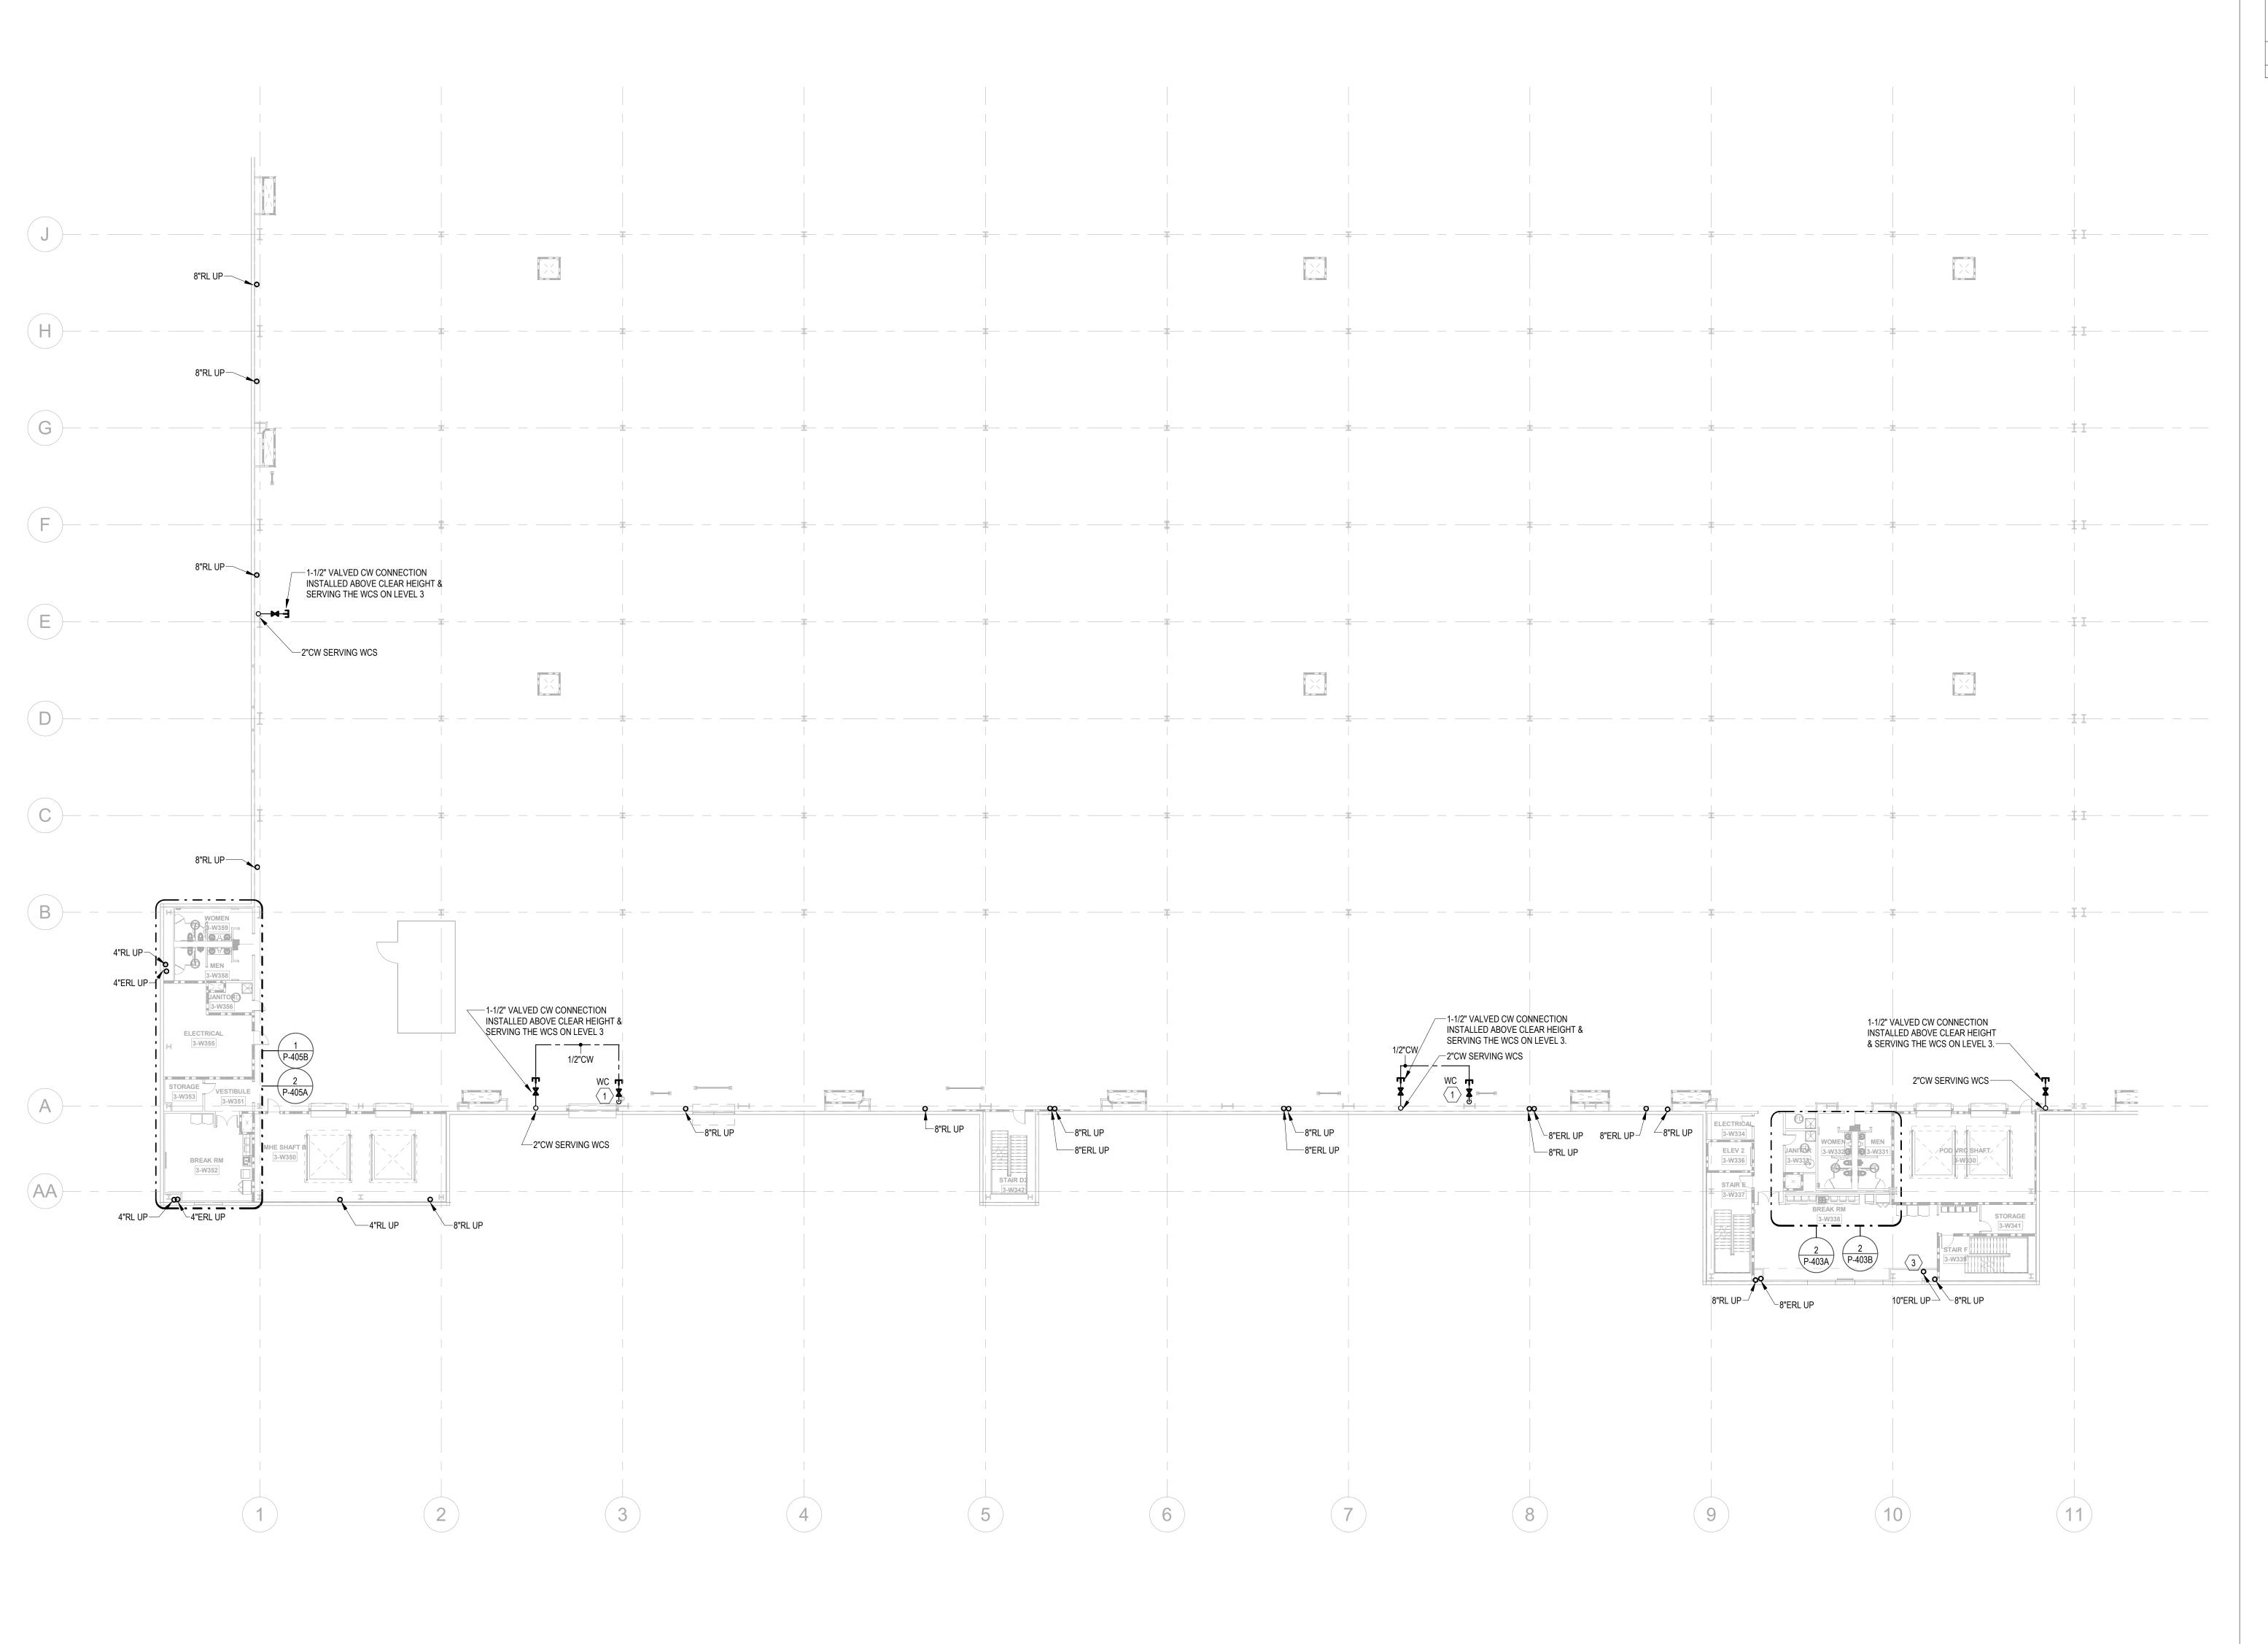

- PROVIDE 1/2" WATER TAP WITH BALL VALVE AND COPPER MANIFOLD. LOCATE BALL VALVE 8'-0" AFF. ROUTE 1/2" COPPER PIPING FROM TAP TO EACH OWNER PROVIDED WATER COOLER. STUB COPPER PIPING 24" ABOVE FLOOR AT WATER COOLER LOCATION. PROVIDE 1/2" X 3/8" ANGLE STOP SUPPLY VALVE. ALL LOCATIONS TO BE REVIEWED BY TENANT PRIOR TO
- INSTALLATION. 10" STORM PIPE, REFER TO DETAIL 11 ON ARCHITECTURAL SHEET A-503.
- 4 FOR THIS RL, SEE SHEET P-003 DETAIL 6 FOR PIPE MATERIAL.

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2024-013 SHEET TITLE PARTIAL FLOOR PLAN -LEVEL 3 B -


PLUMBING

NOT FOR CONSTRUCTION

SHEET NUMBER

FLOOR KEY PLAN N

P-213

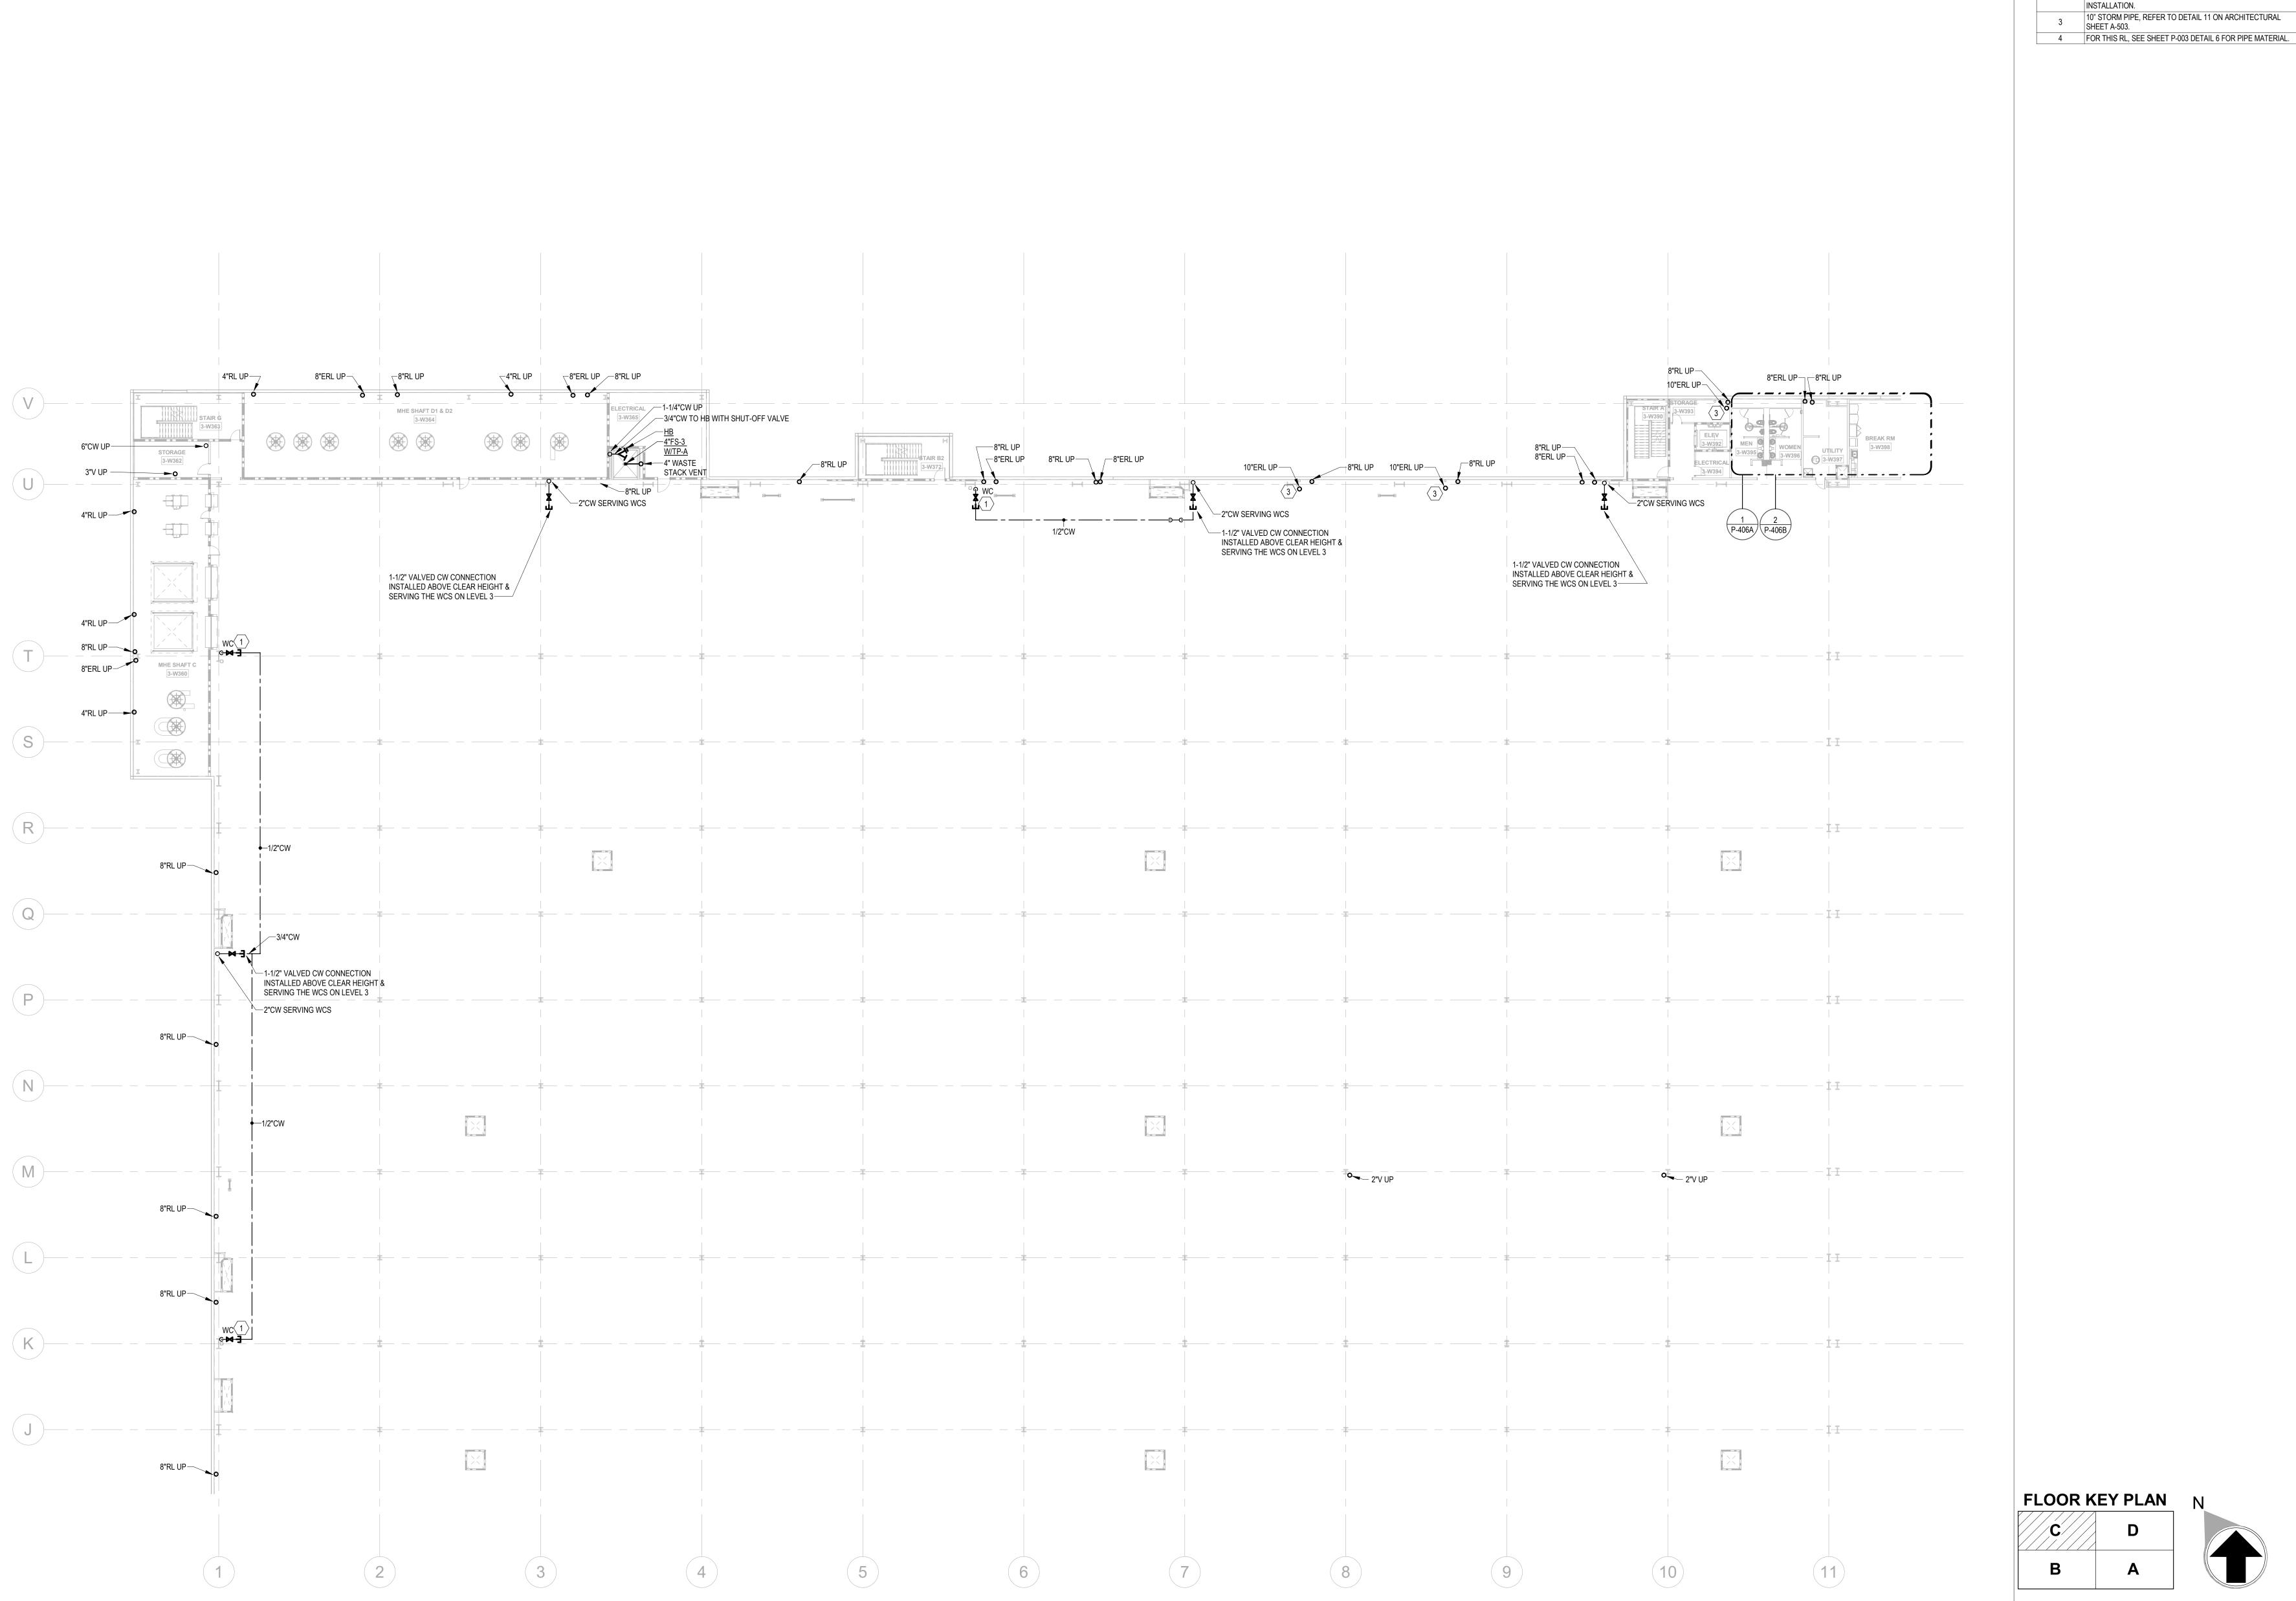

KEYNO

PROVIDE 1/2" WATER TAP WITH BALL VALVE AND COPPER MANIFOLD. LOCATE BALL VALVE 8'-0" AFF. ROUTE 1/2" COPPER PIPING FROM TAP TO EACH OWNER PROVIDED WATER COOLER.

STUB COPPER PIPING 24" ABOVE FLOOR AT WATER COOLER LOCATION. PROVIDE 1/2" X 3/8" ANGLE STOP SUPPLY VALVE. ALL LOCATIONS TO BE REVIEWED BY TENANT PRIOR TO INSTALLATION.

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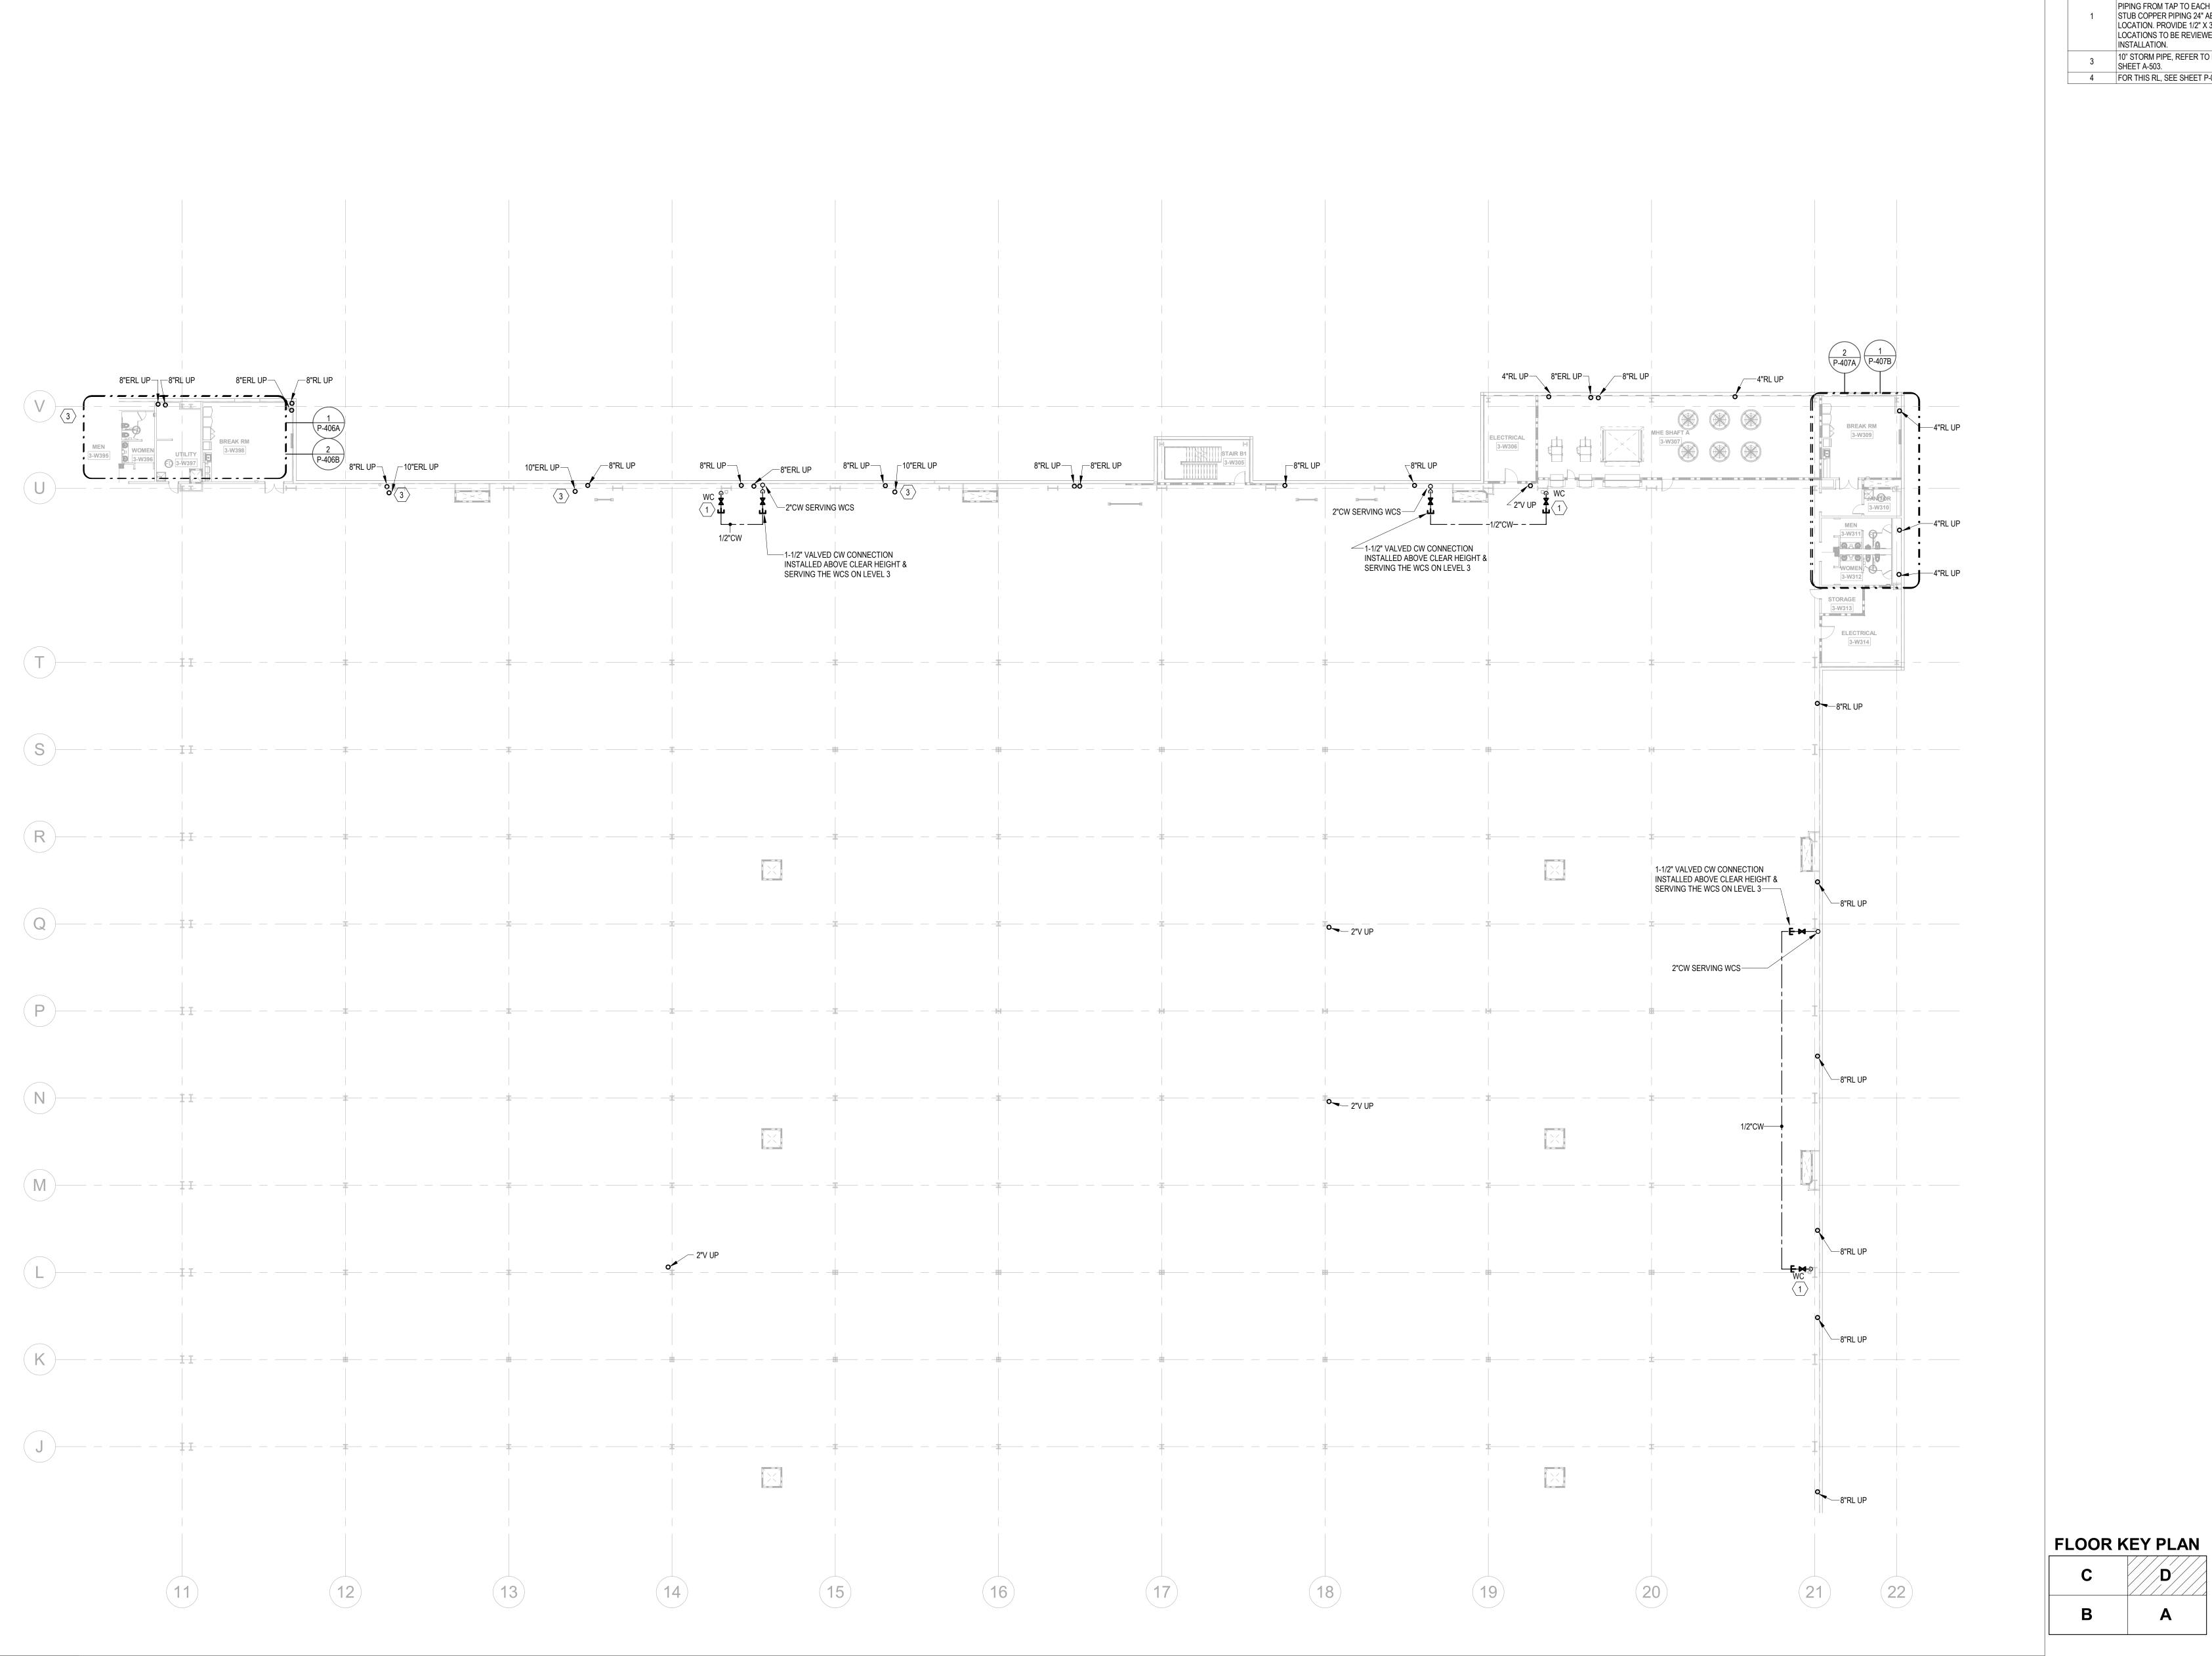
PARTIAL
FLOOR PLAN LEVEL 3 C PLUMBING

D_211

P-214

NOT FOR CONSTRUCTION

1" = 20'-0"



PROVIDE 1/2" WATER TAP WITH BALL VALVE AND COPPER MANIFOLD. LOCATE BALL VALVE 8'-0" AFF. ROUTE 1/2" COPPER PIPING FROM TAP TO EACH OWNER PROVIDED WATER COOLER. STUB COPPER PIPING 24" ABOVE FLOOR AT WATER COOLER LOCATION. PROVIDE 1/2" X 3/8" ANGLE STOP SUPPLY VALVE. ALL LOCATIONS TO BE REVIEWED BY TENANT PRIOR TO

10" STORM PIPE, REFER TO DETAIL 11 ON ARCHITECTURAL SHEET A-503.

MACGREGOR ASSOCIATES ARCHITECTS 4 FOR THIS RL, SEE SHEET P-003 DETAIL 6 FOR PIPE MATERIAL.

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PROJECT

WILMINGTON, NC

2024-013

SHEET TITLE PARTIAL FLOOR PLAN -LEVEL 3 D -


PLUMBING

P-215

NOT FOR CONSTRUCTION

PARTIAL FLOOR PLANS - LEVEL 3 - D - PLUMBING

1" = 20'-0"

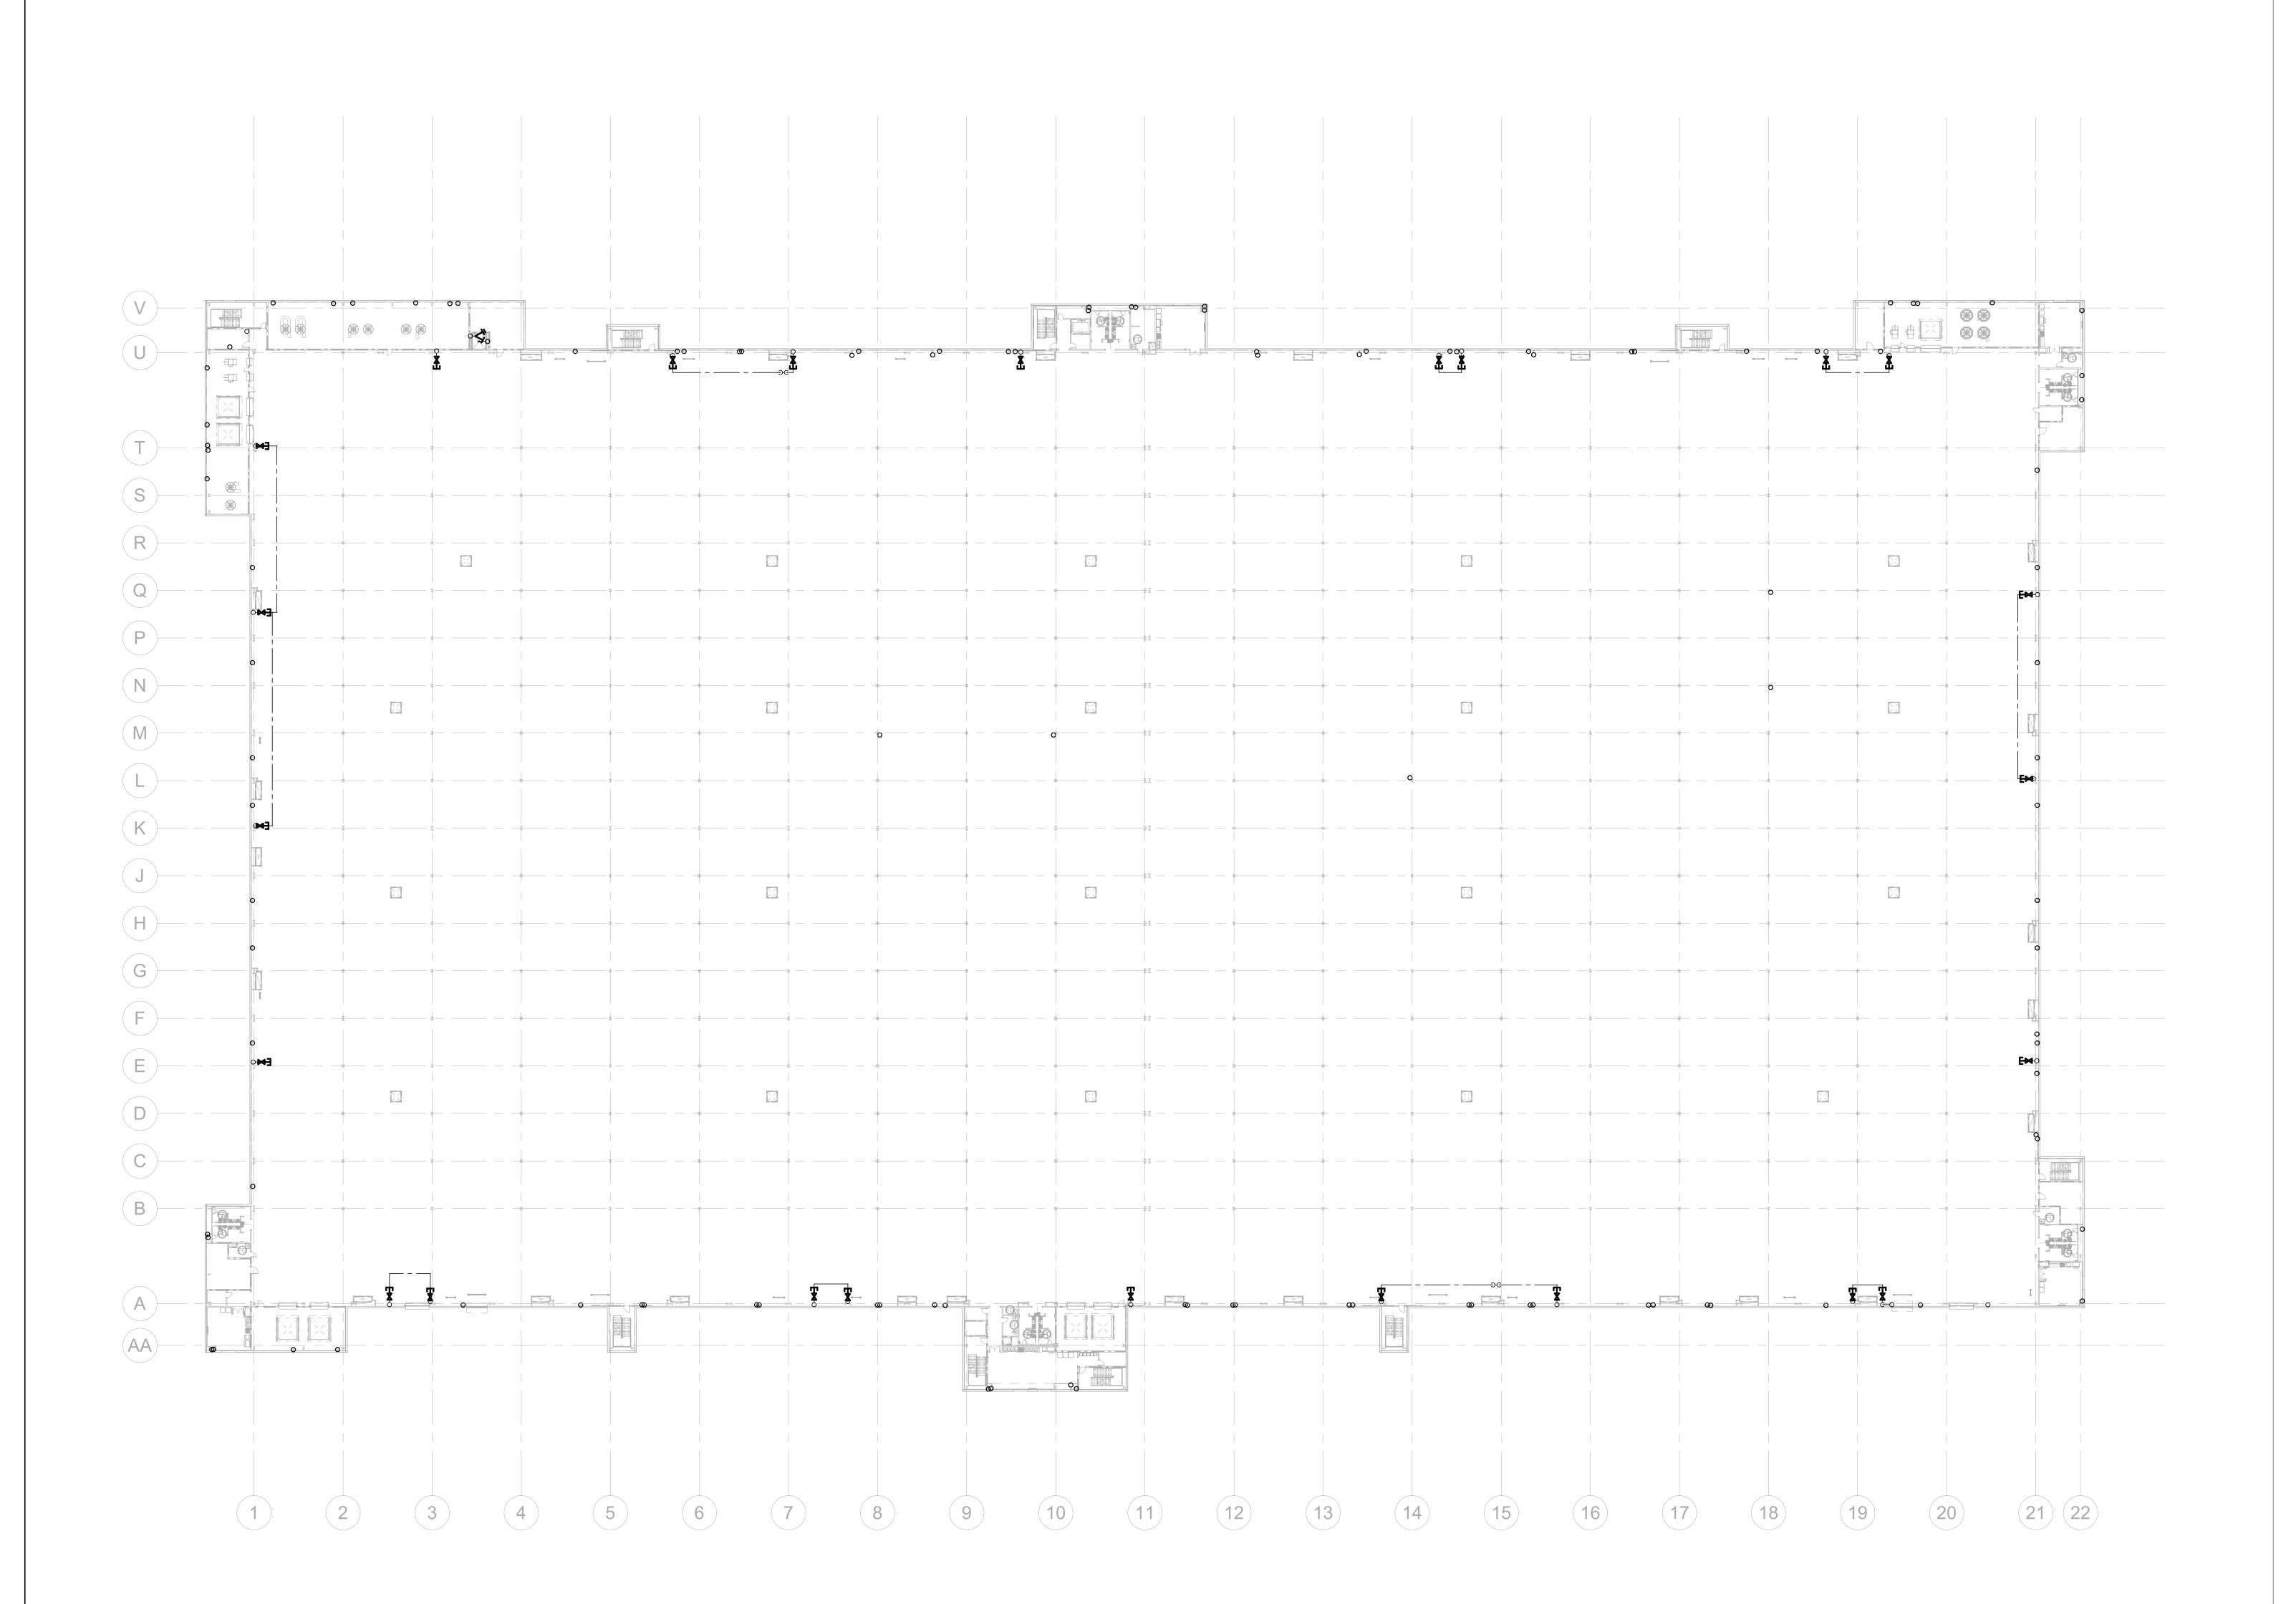

FLOOR KEY PLAN

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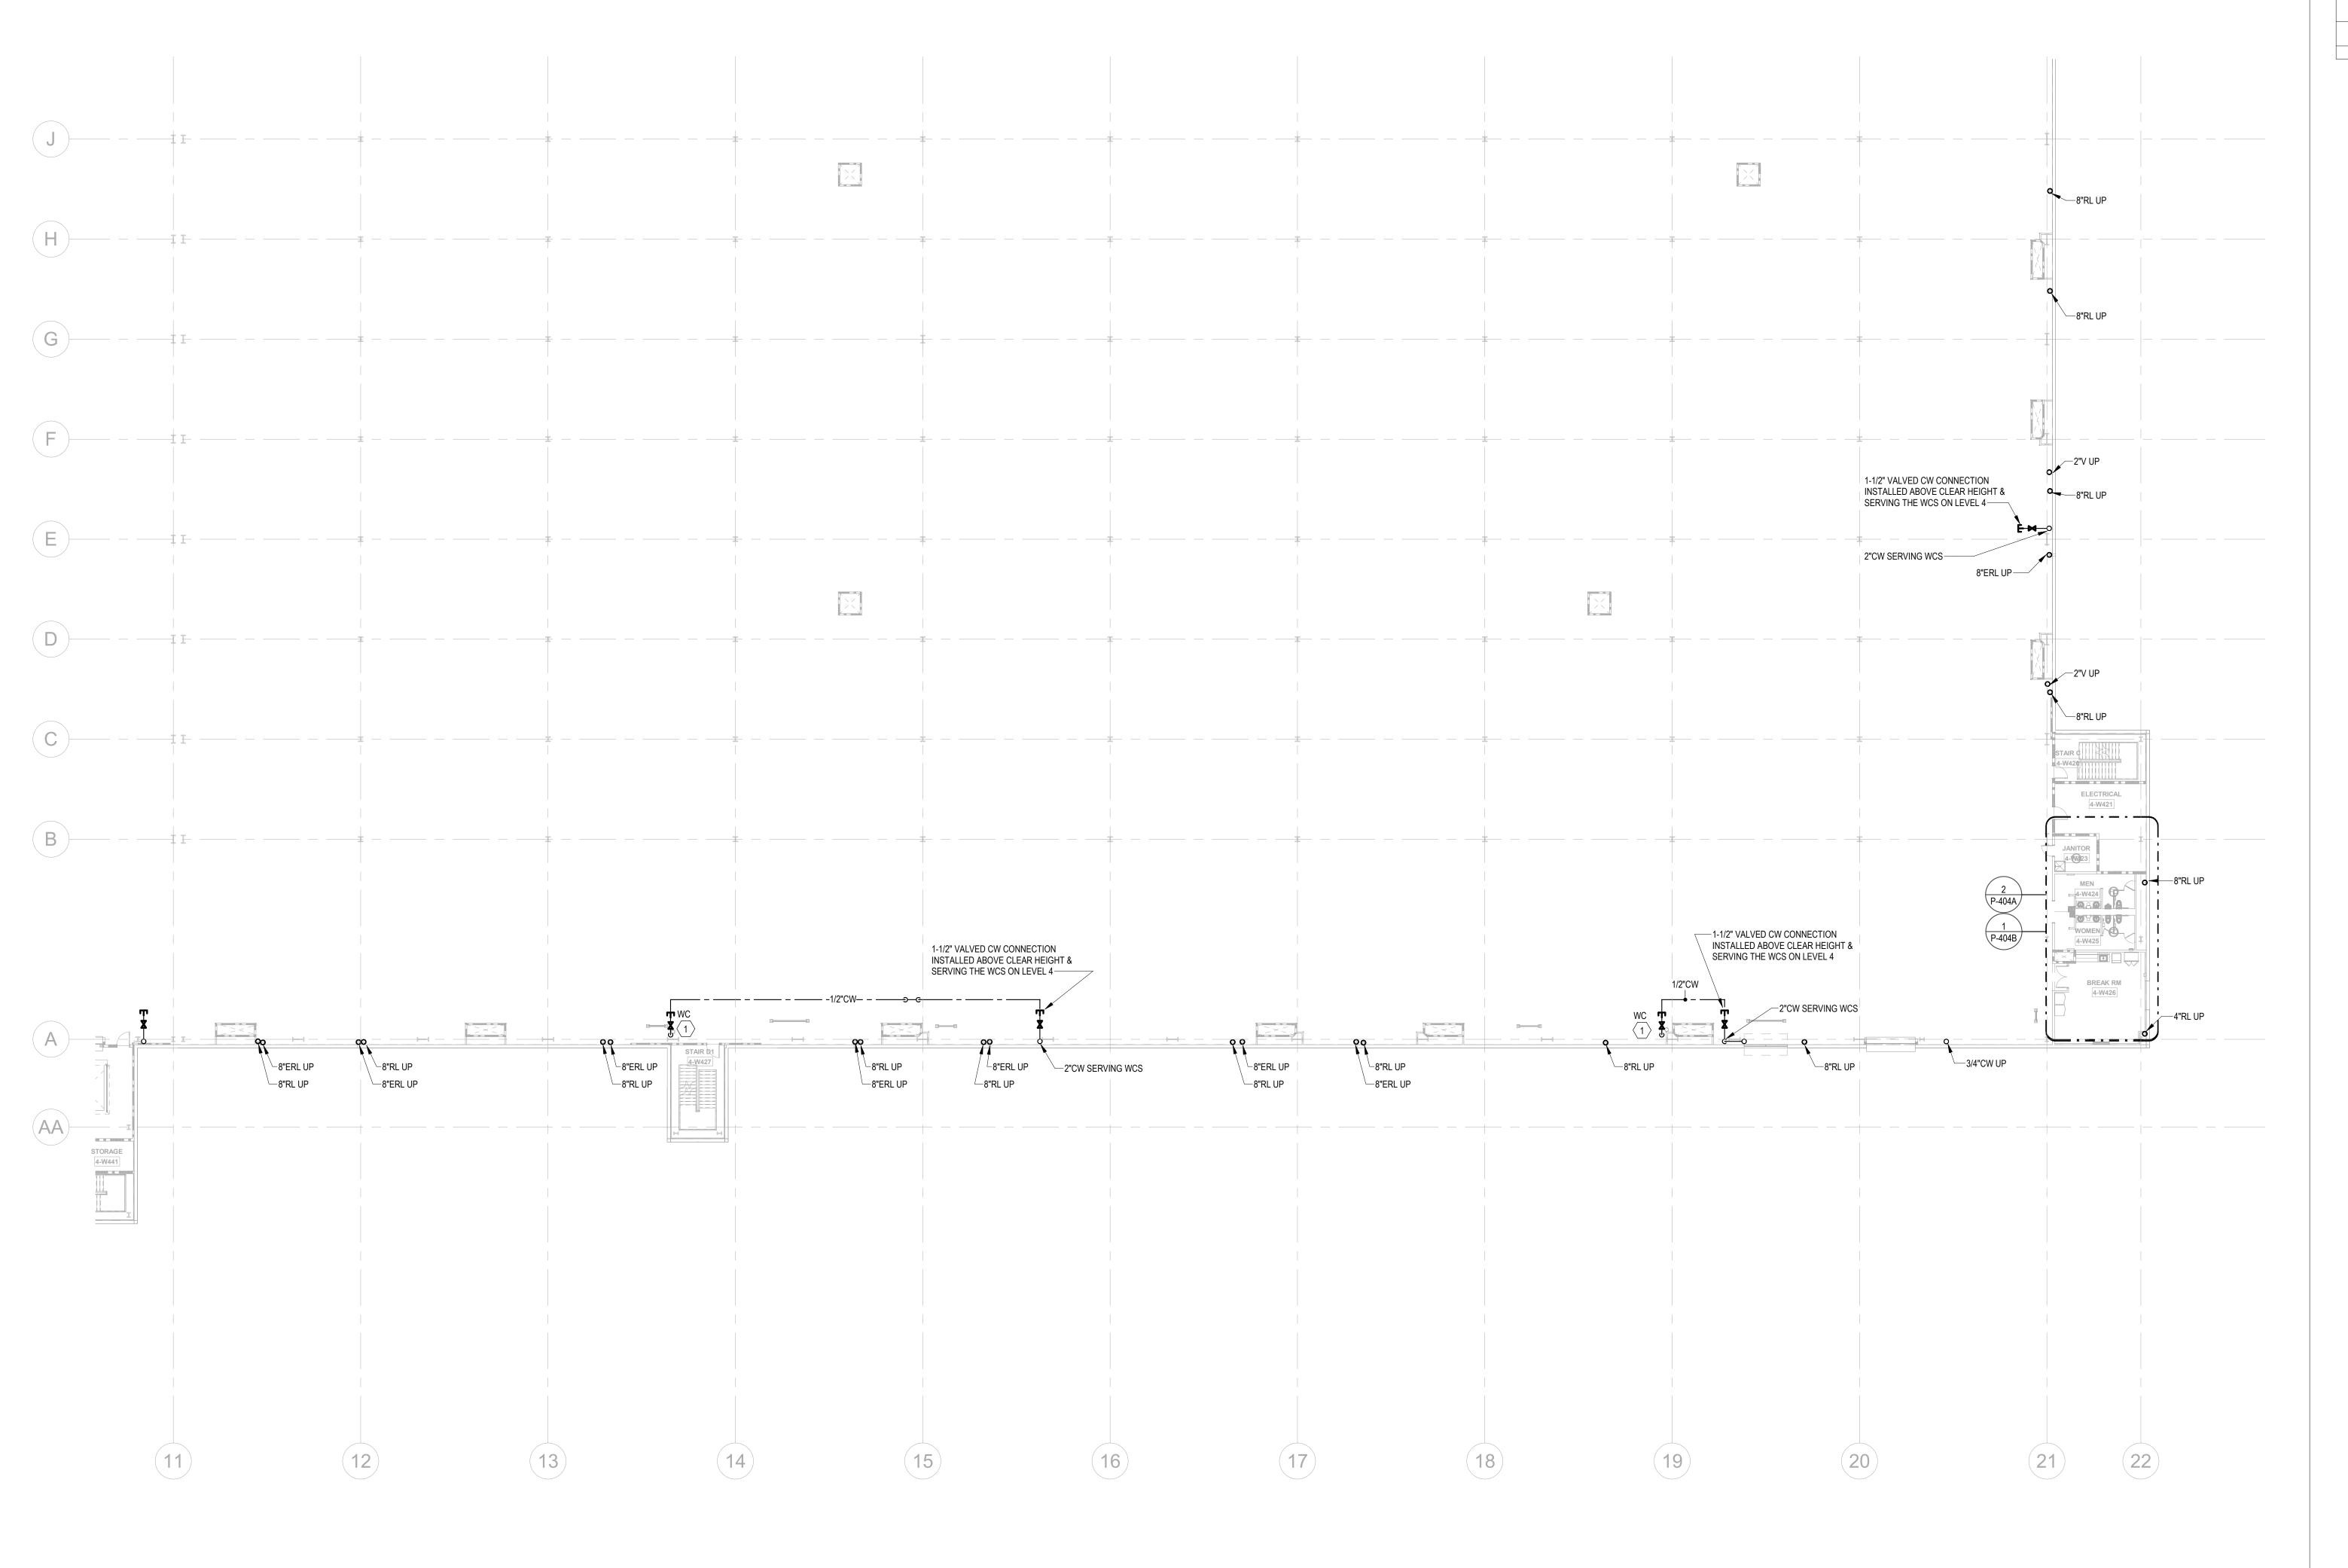
06/10/24 PRICING SET

PROJECT WHALE

WILMINGTON, NC

2024-013 SHEET TITLE OVERALL FLOOR PLAN -LEVEL 4 -PLUMBING

SHEET NUMBER P-216



KEYNOT

PROVIDE 1/2" WATER TAP WITH BALL VALVE AND COPPER MANIFOLD. LOCATE BALL VALVE 8'-0" AFF. ROUTE 1/2" COPPER PIPING FROM TAP TO EACH OWNER PROVIDED WATER COOLER.

STUB COPPER PIPING 24" ABOVE FLOOR AT WATER COOLER LOCATION. PROVIDE 1/2" X 3/8" ANGLE STOP SUPPLY VALVE. ALL LOCATIONS TO BE REVIEWED BY TENANT PRIOR TO

INSTALLATION.

10" STORM PIPE, REFER TO DETAIL 11 ON ARCHITECTURAL SHEET A-503.

SHEET A-503.

4 FOR THIS RL, SEE SHEET P-003 DETAIL 6 FOR PIPE MATERIAL.

LILL

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Drawn By:CF Checked By:JMW

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DATE
PROJECT NO
2024-013

SHEET TITLE
PARTIAL


PARTIAL FLOOR PLAN -LEVEL 4 A -PLUMBING

FLOOR KEY PLAN N

SHEET NUMBER

D 947

P-217

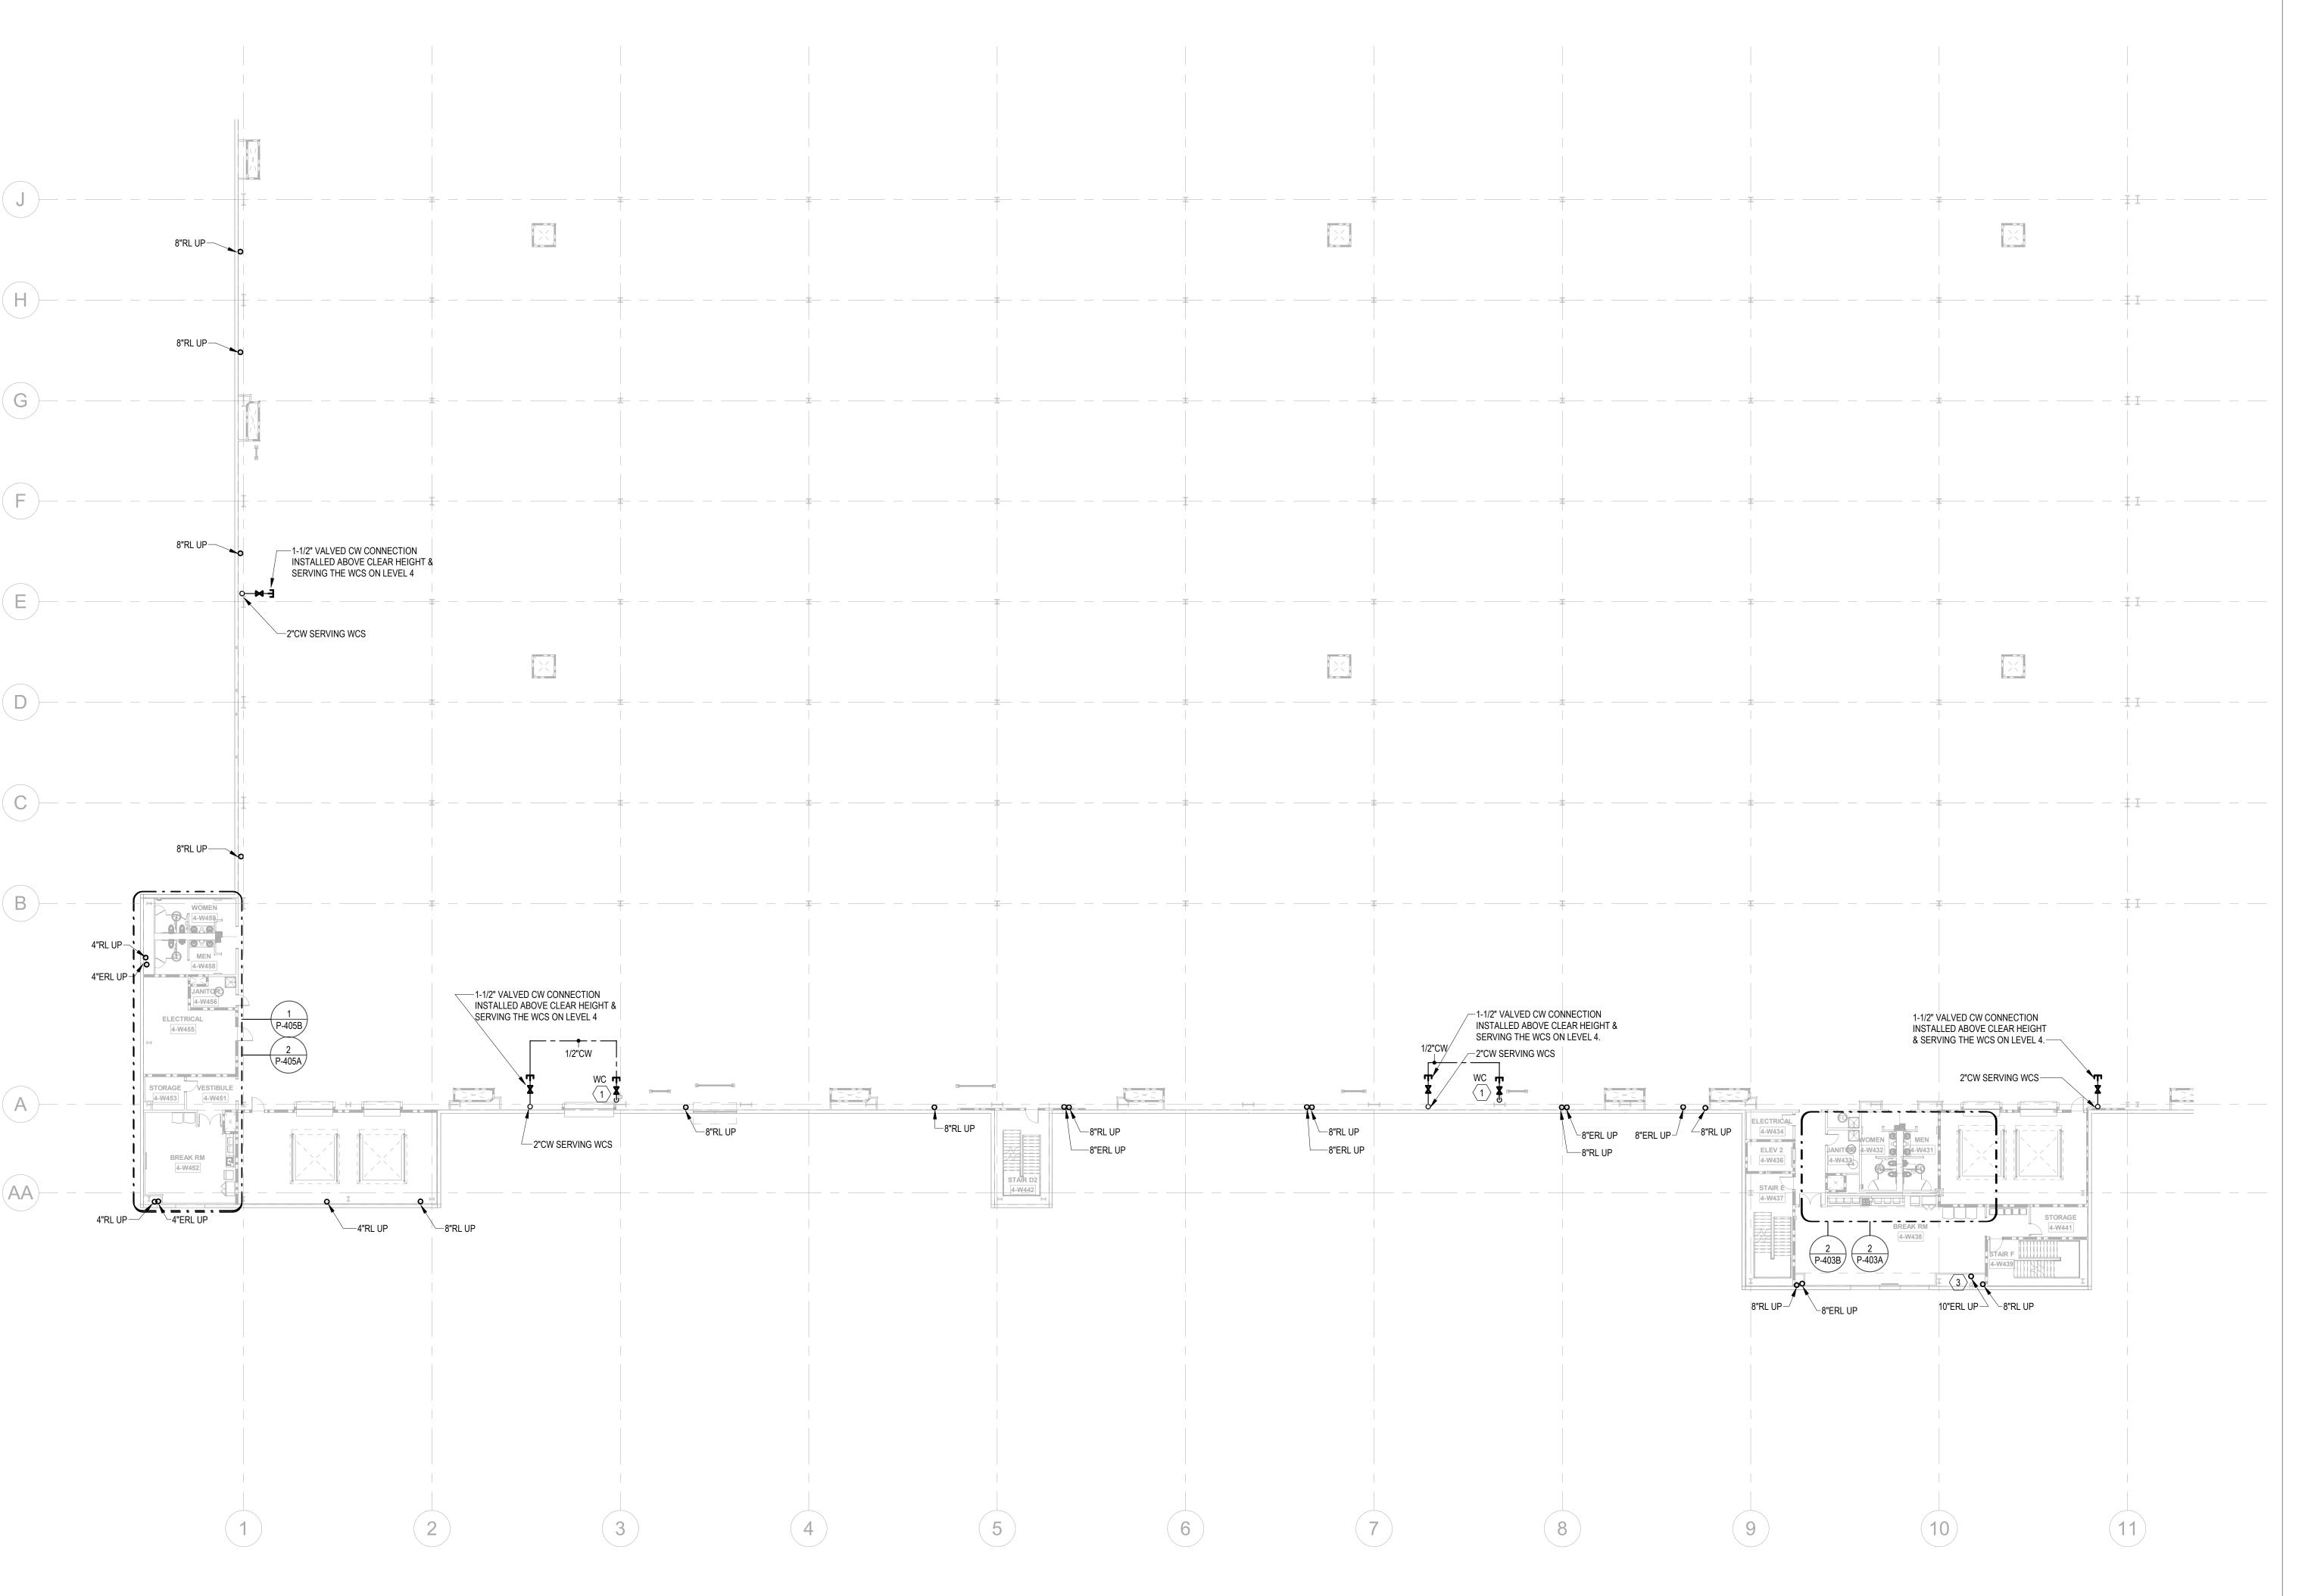

KEYNOTES

PROVIDE 1/2" WATER TAP WITH BALL VALVE AND COPPER MANIFOLD. LOCATE BALL VALVE 8'-0" AFF. ROUTE 1/2" COPPER PIPING FROM TAP TO EACH OWNER PROVIDED WATER COOLER. STUB COPPER PIPING 24" ABOVE FLOOR AT WATER COOLER LOCATION. PROVIDE 1/2" X 3/8" ANGLE STOP SUPPLY VALVE. ALL LOCATIONS TO BE REVIEWED BY TENANT PRIOR TO INSTALLATION.

10" STORM PIPE, REFER TO DETAIL 11 ON ARCHITECTURAL SHEET A-503.

4 FOR THIS RL, SEE SHEET P-003 DETAIL 6 FOR PIPE MATERIAL.

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2024-013 SHEET TITLE


PARTIAL FLOOR PLAN -LEVEL 4 B -PLUMBING

FLOOR KEY PLAN N

SHEET NUMBER

NOT FOR CONSTRUCTION

P-218

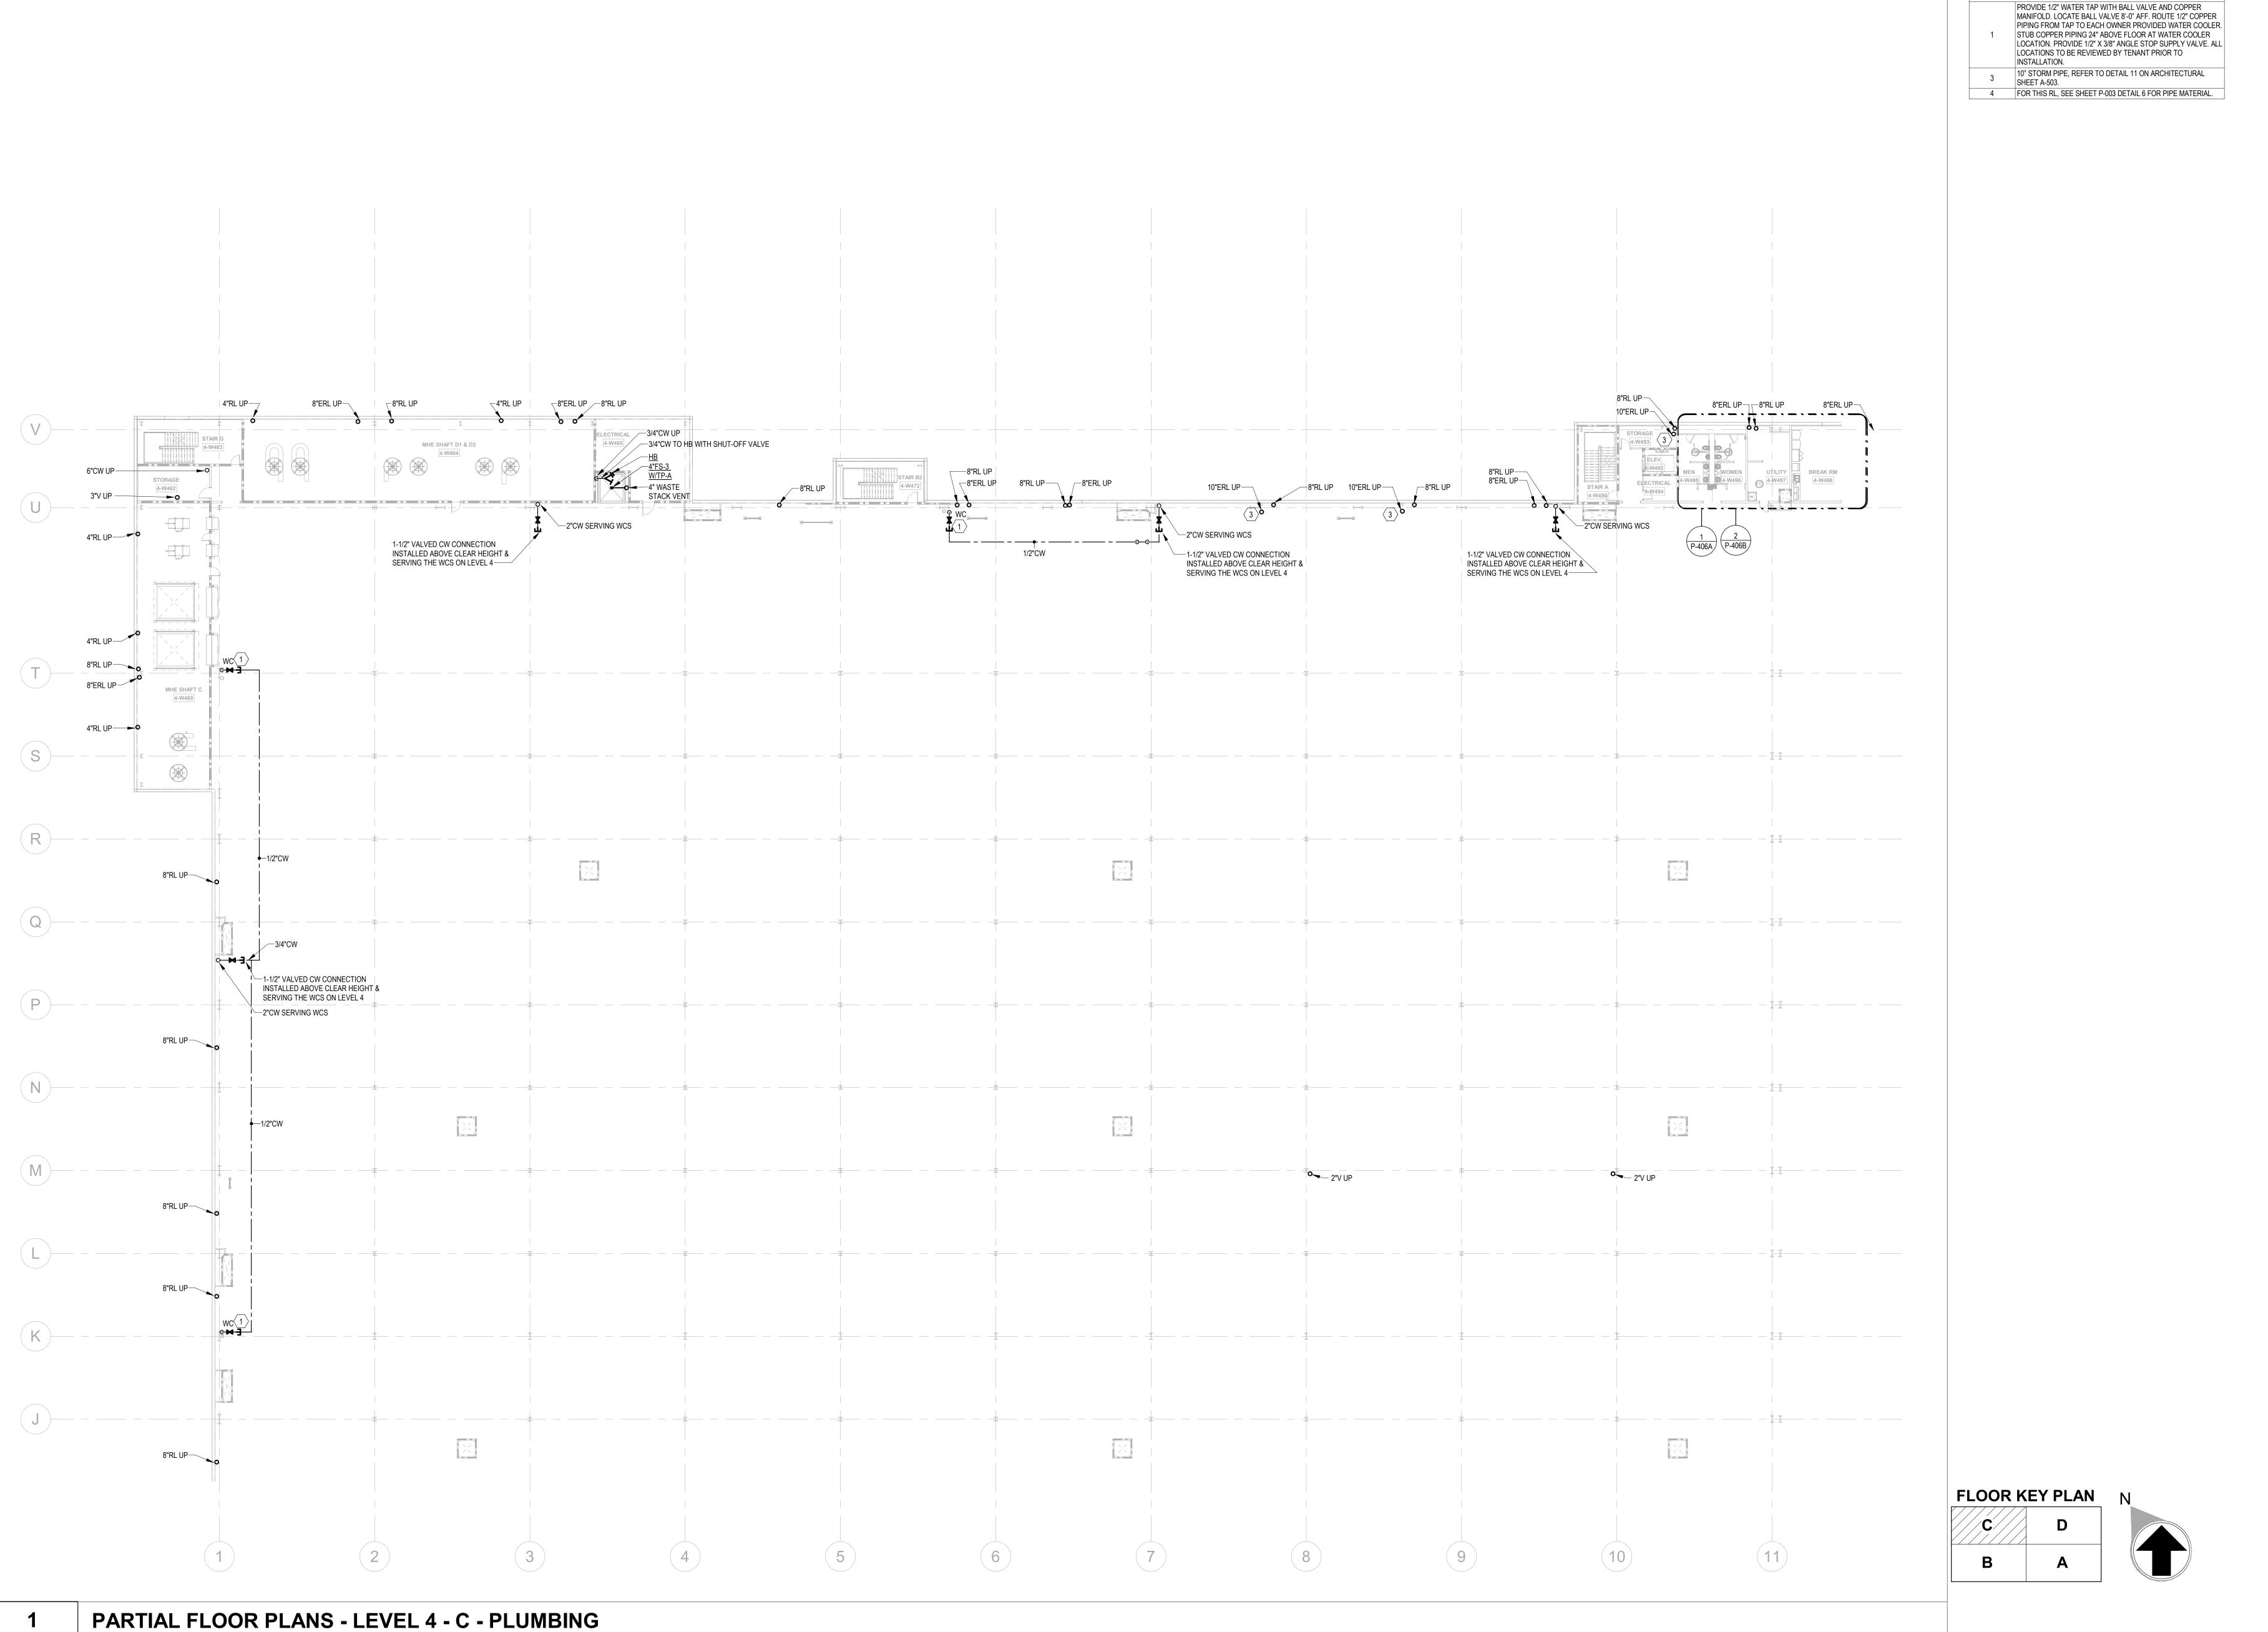

1" = 20'-0"

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MACGREGOR

KEYNOTES

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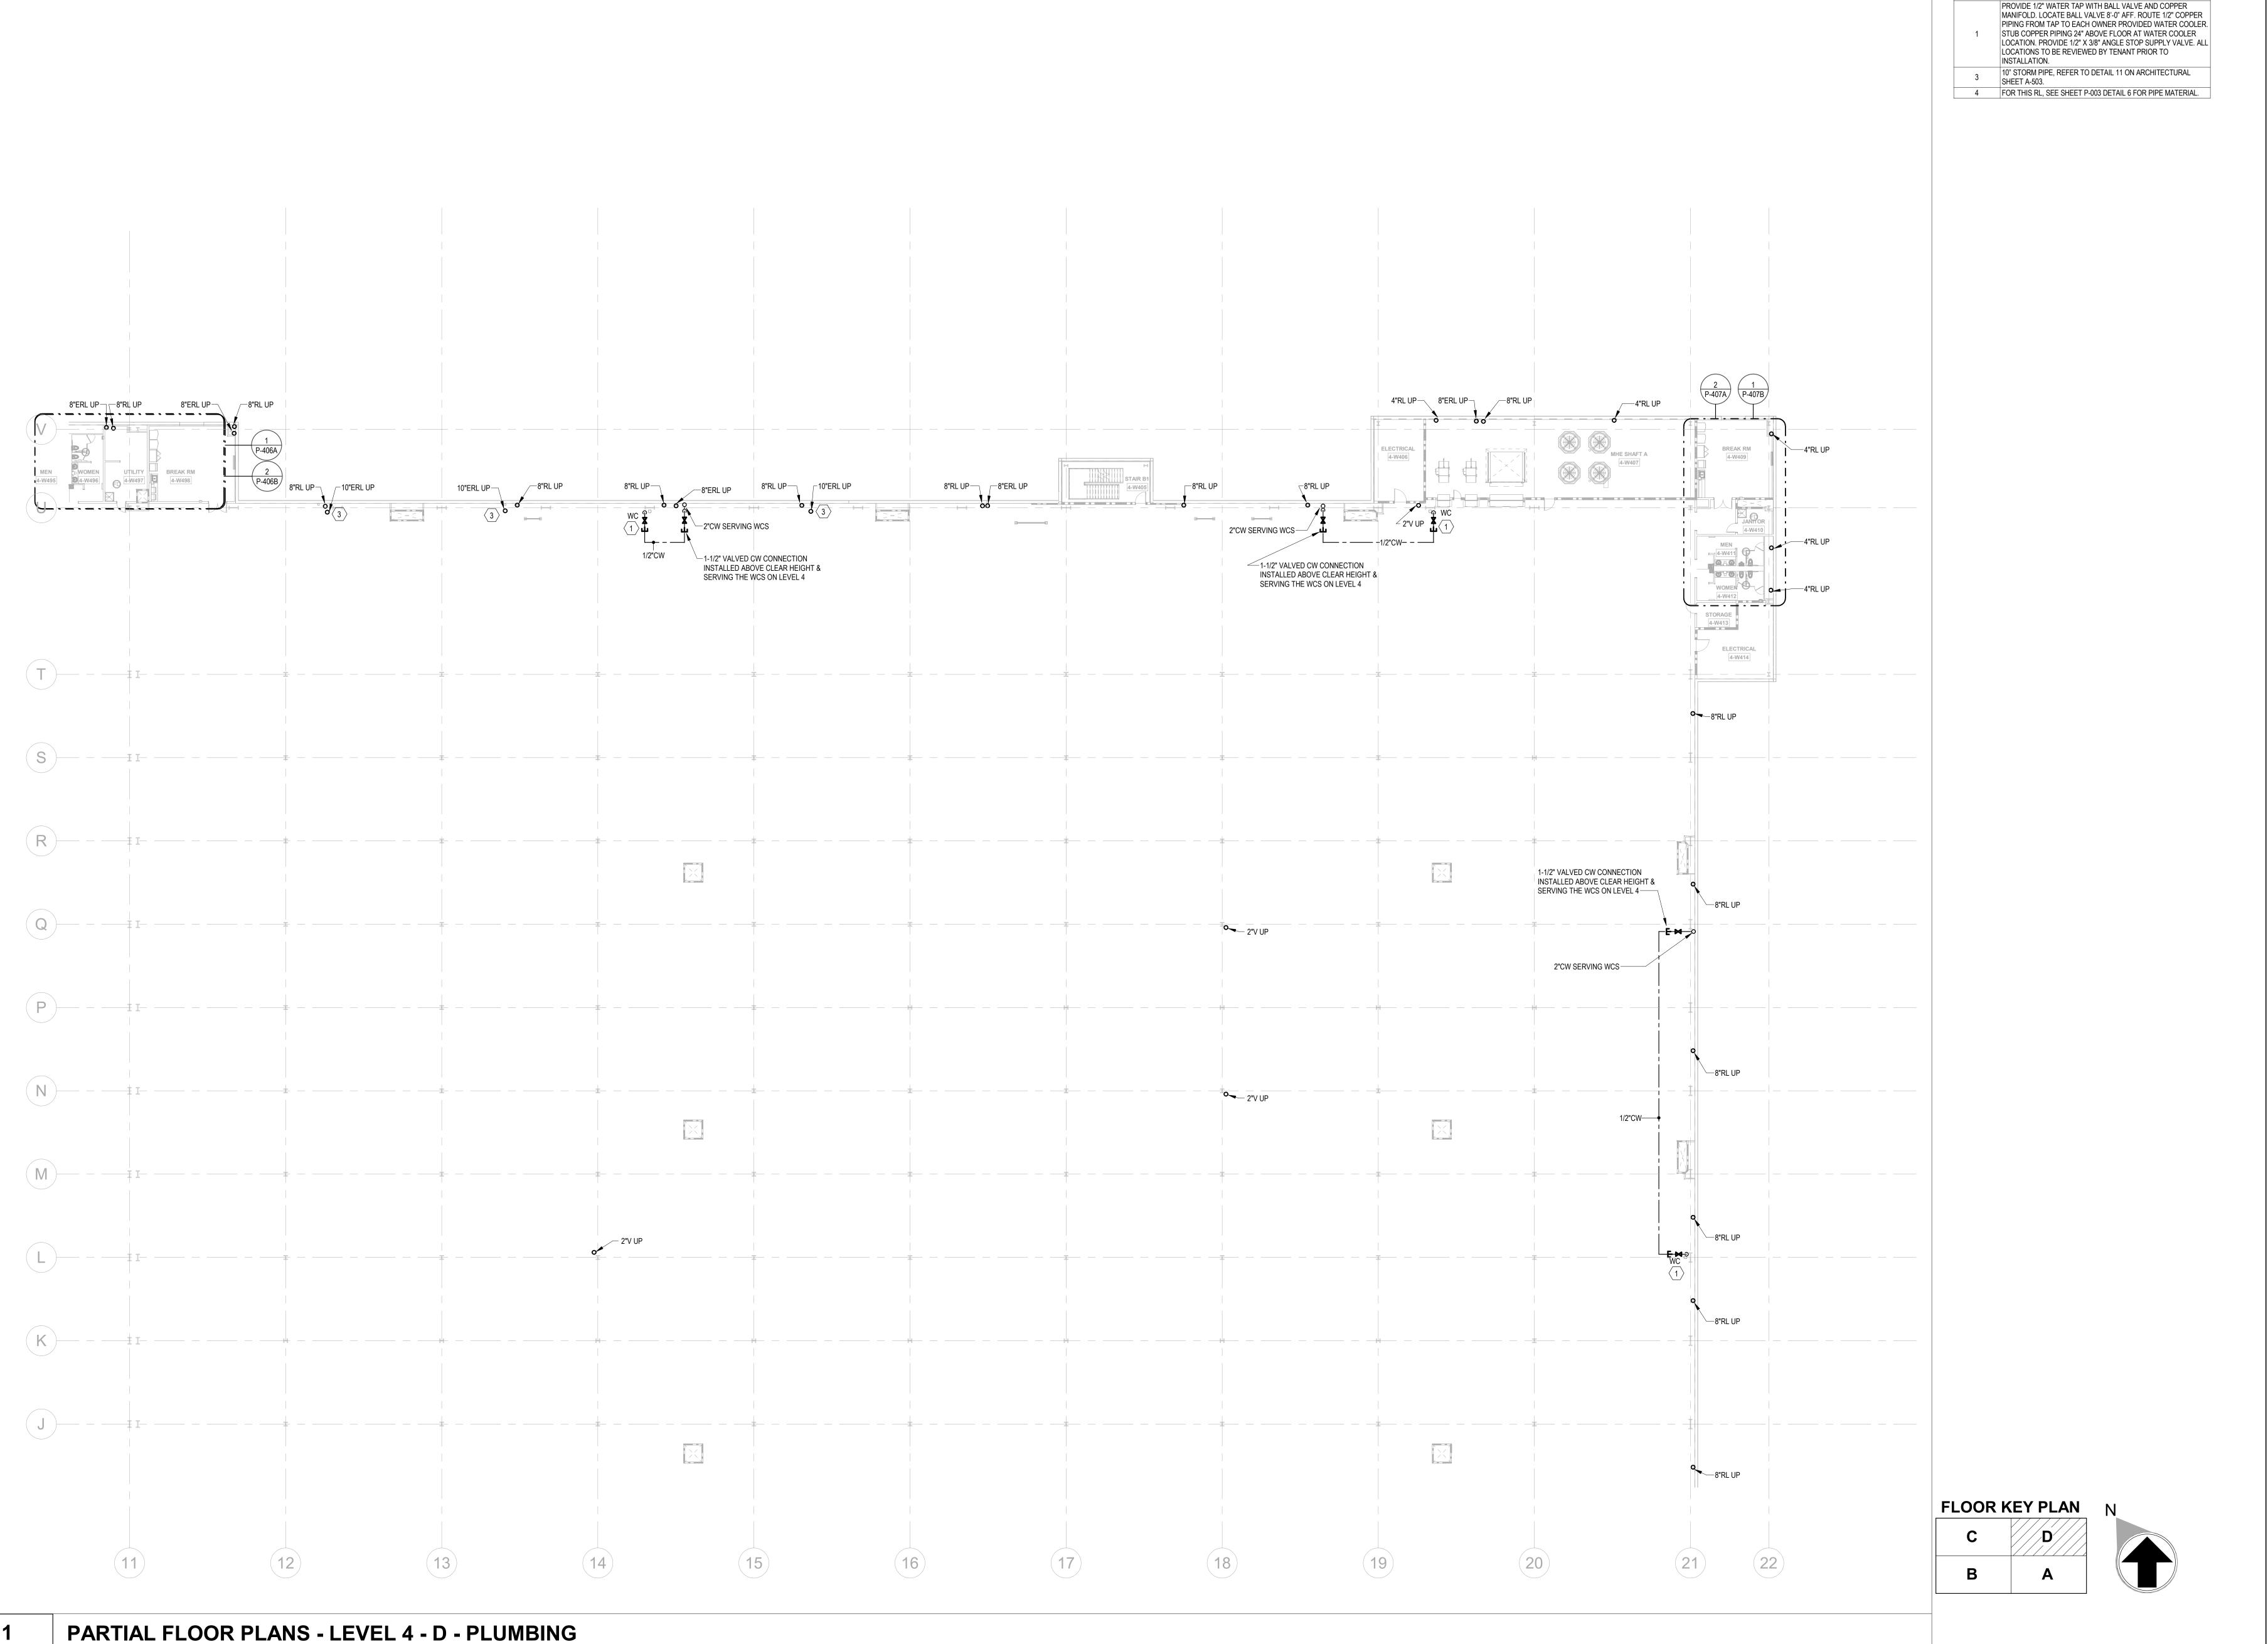
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PROJECT NO
2024-013

PARTIAL
FLOOR PLAN LEVEL 4 C PLUMBING

SHEET NUMBER

P-219



1" = 20'-0"

LILL
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WILMINGTON, NC

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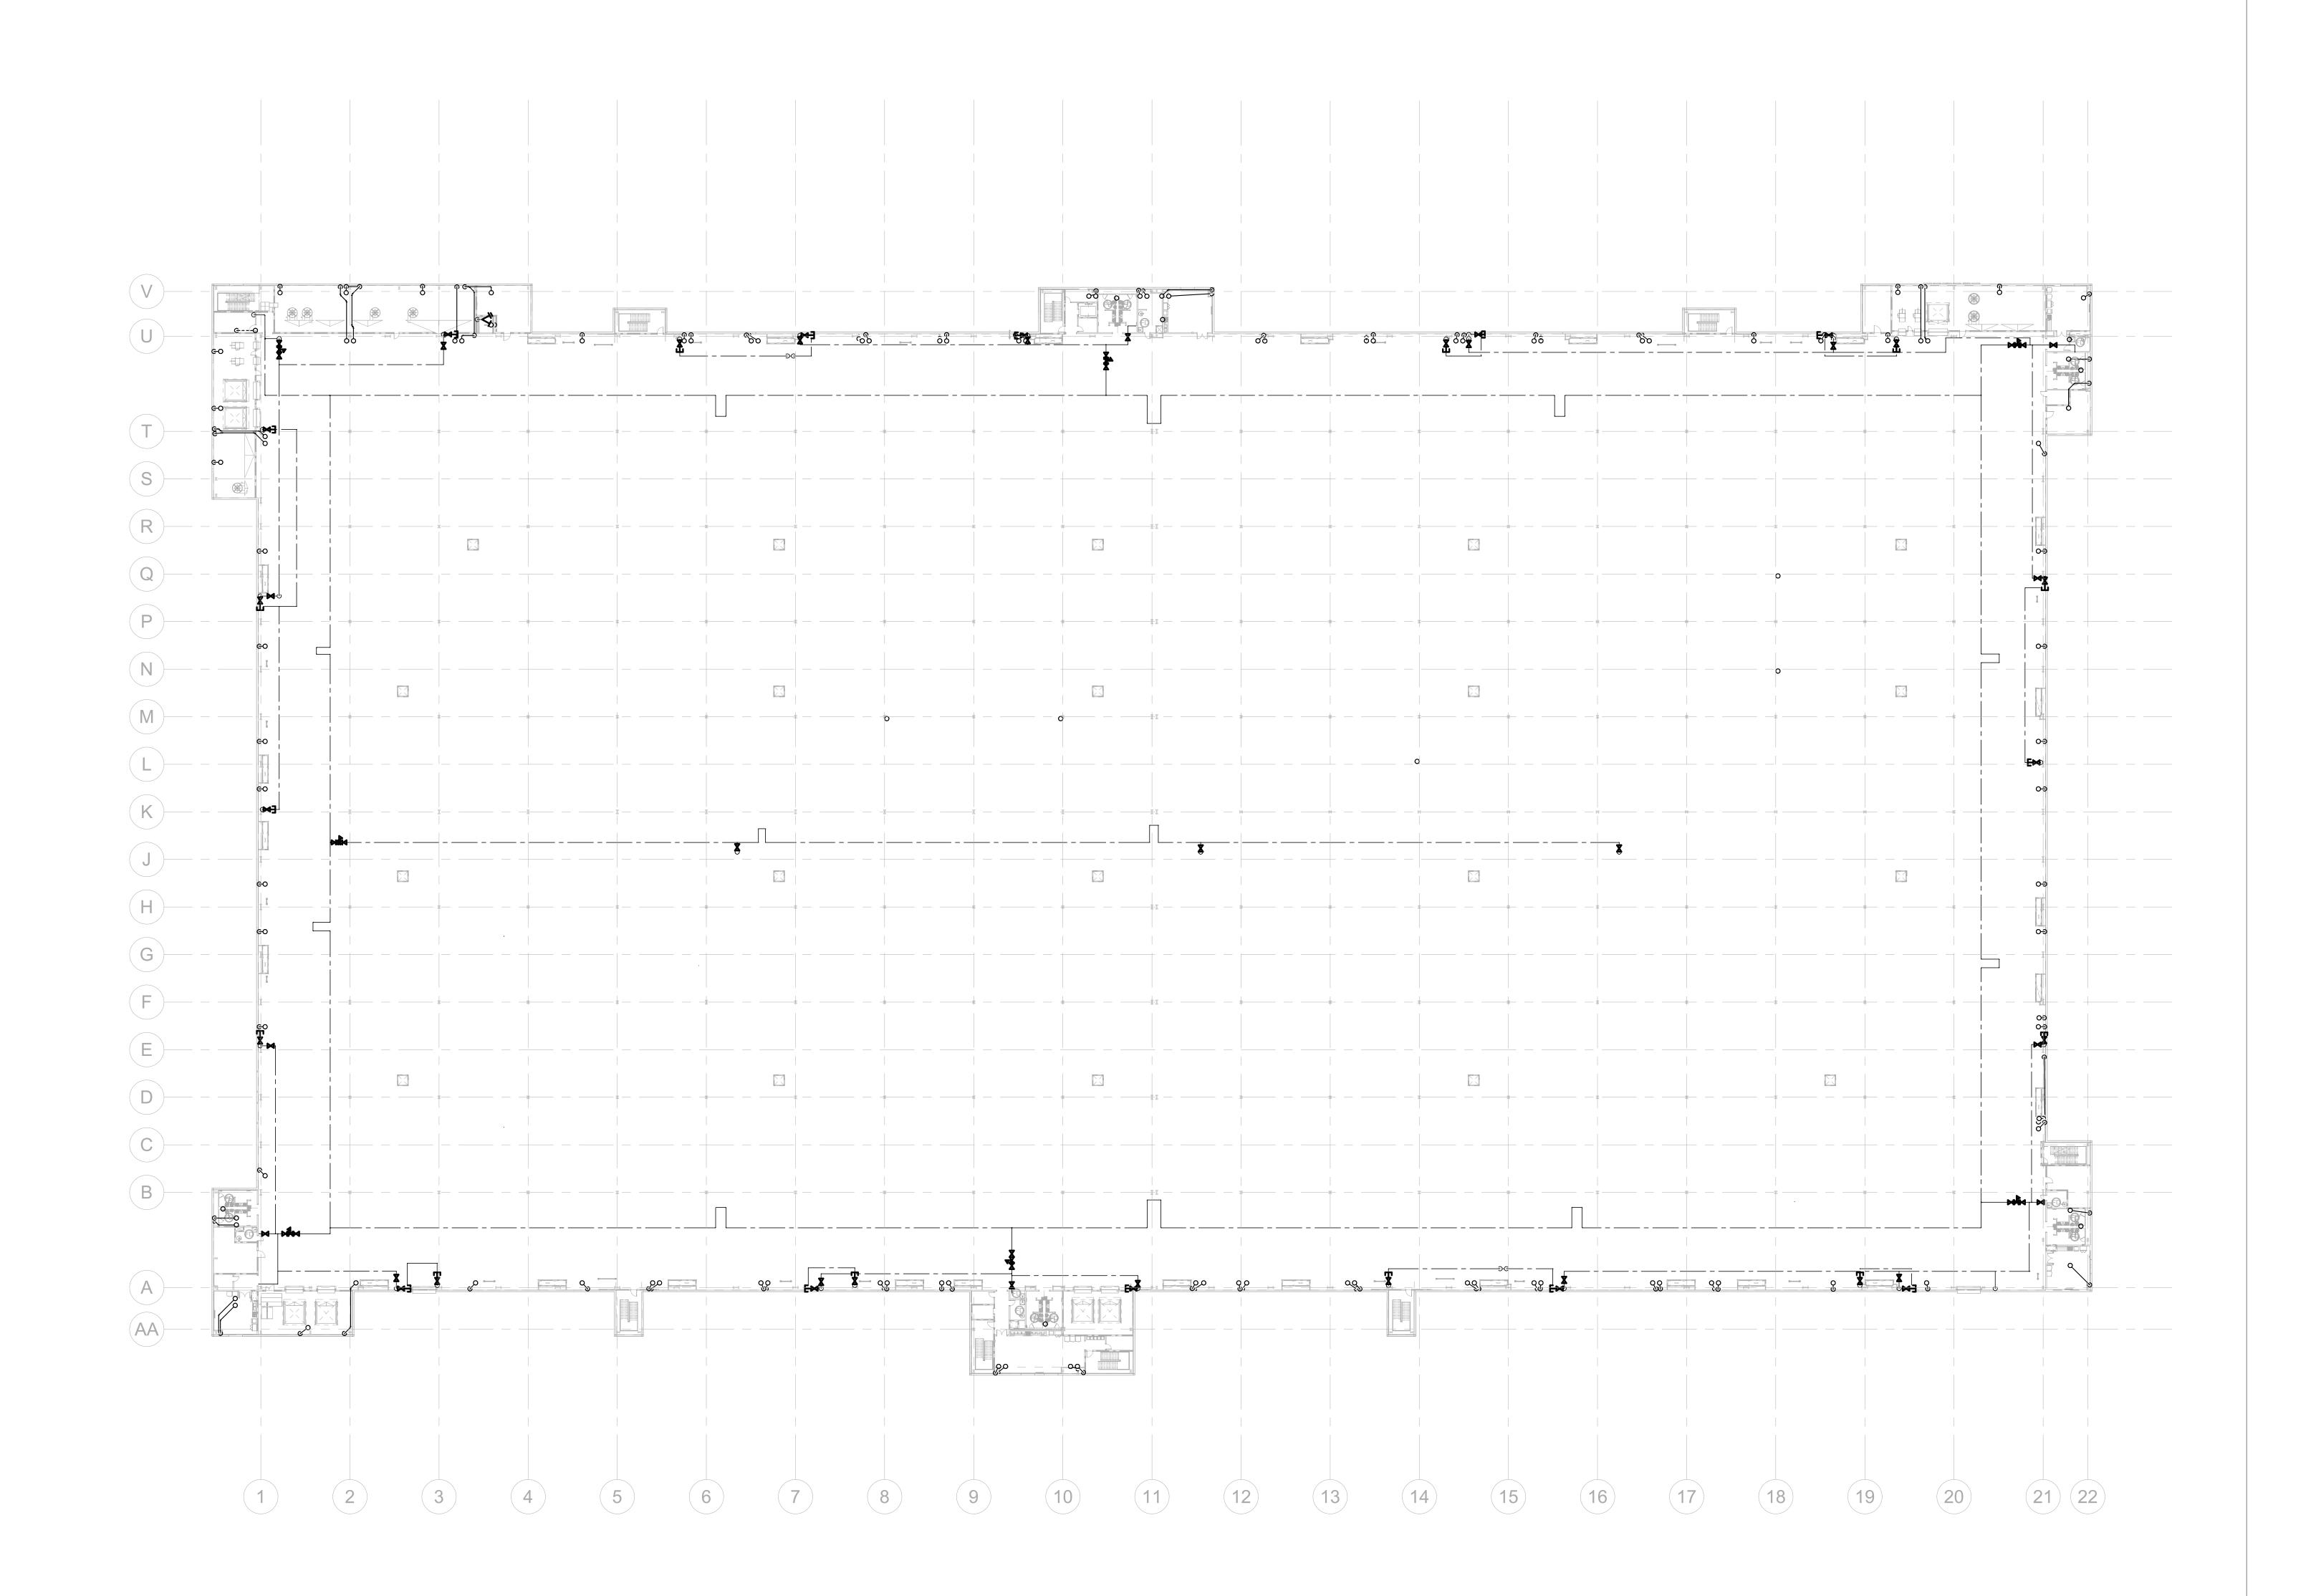
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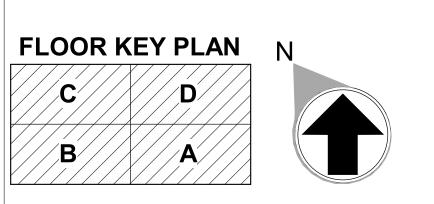
PROJECT NO
2024-013

PARTIAL
FLOOR PLAN LEVEL 4 D PLUMBING

SHEET NUMBER

P-220





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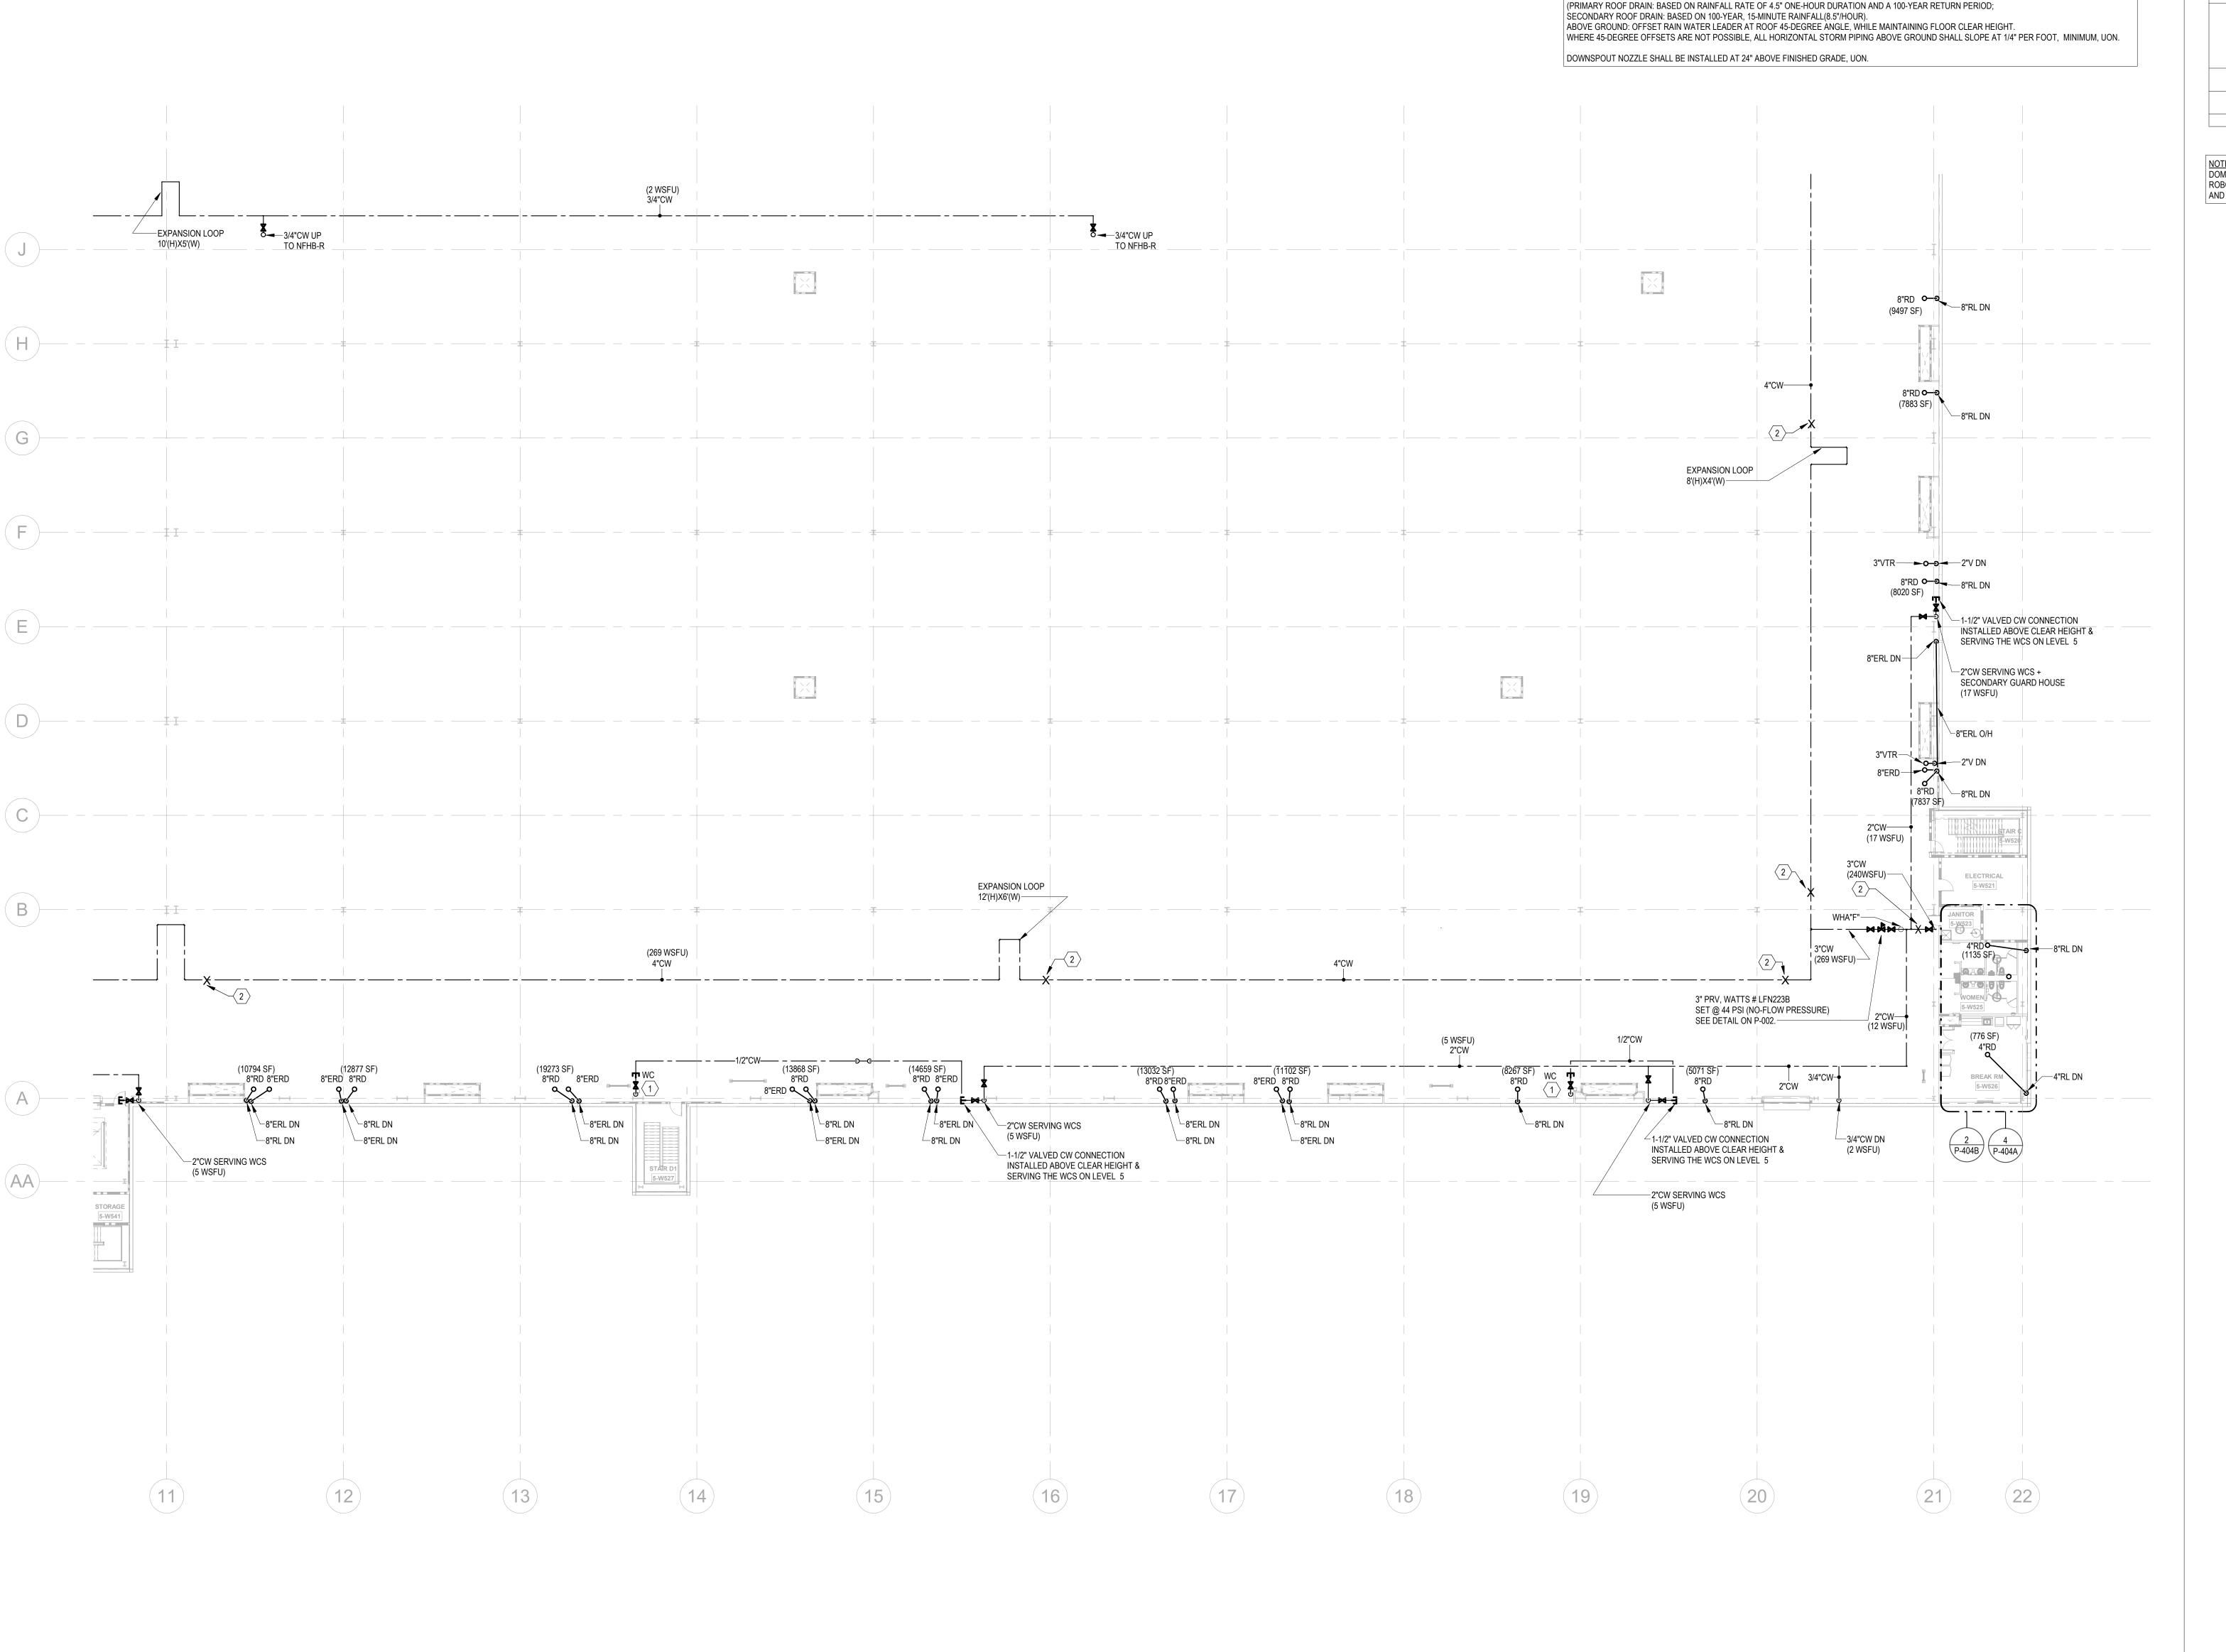
PROJECT WHALE

WILMINGTON, NC

2024-013 SHEET TITLE OVERALL FLOOR PLAN -LEVEL 5 -PLUMBING

SHEET NUMBER

P-221



STORM DRAINAGE NOTES:

STORM PIPING & ROOF DRAINS ARE SIZED BASED ON 2018 NORTH CAROLINA PLUMBING CODE.

KEYNOTES

- PROVIDE 1/2" WATER TAP WITH BALL VALVE AND COPPER MANIFOLD. LOCATE BALL VALVE 8'-0" AFF. ROUTE 1/2" COPPER PIPING FROM TAP TO EACH OWNER PROVIDED WATER COOLER. STUB COPPER PIPING 24" ABOVE FLOOR AT WATER COOLER LOCATION. PROVIDE 1/2" X 3/8" ANGLE STOP SUPPLY VALVE. ALL
- LOCATIONS TO BE REVIEWED BY TENANT PRIOR TO INSTALLATION. PROVIDE LONGITUDINAL AND TRANSVERSE BRACING. SEE DETAILS
- 10" STORM PIPE, REFER TO DETAIL 11 ON ARCHITECTURAL SHEET

4 FOR THIS RL, SEE SHEET P-003 DETAIL 6 FOR PIPE MATERIAL.

NOTE:
DOMESTIC WATER MAINS, VALVES & PRVS TO BE INSTALLED OUTSIDE OF THE ROBOTICS FIELD. COORDINATE ROUTING WITH CLEAR HEIGHT REQUIREMENTS AND ALL TRADES, INCLUDING MECHANICAL DUCT LOCATIONS.

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2024-013 SHEET TITLE

PARTIAL FLOOR PLAN -LEVEL 5 A -PLUMBING

FLOOR KEY PLAN N

SHEET NUMBER

P-222

STORM DRAINAGE NOTES: STORM PIPING & ROOF DRAINS ARE SIZED BASED ON 2018 NORTH CAROLINA PLUMBING CODE. (PRIMARY ROOF DRAIN: BASED ON RAINFALL RATE OF 4.5" ONE-HOUR DURATION AND A 100-YEAR RETURN PERIOD; SECONDARY ROOF DRAIN: BASED ON 100-YEAR, 15-MINUTE RAINFALL(8.5"/HOUR). ABOVE GROUND: OFFSET RAIN WATER LEADER AT ROOF 45-DEGREE ANGLE, WHILE MAINTAINING FLOOR CLEAR HEIGHT. WHERE 45-DEGREE OFFSETS ARE NOT POSSIBLE, ALL HORIZONTAL STORM PIPING ABOVE GROUND SHALL SLOPE AT 1/4" PER FOOT, MINIMUM, UON. DOWNSPOUT NOZZLE SHALL BE INSTALLED AT 24" ABOVE FINISHED GRADE, UON.

- PROVIDE 1/2" WATER TAP WITH BALL VALVE AND COPPER MANIFOLD. LOCATE BALL VALVE 8'-0" AFF. ROUTE 1/2" COPPER PIPING FROM TAP TO EACH OWNER PROVIDED WATER COOLER. STUB COPPER PIPING 24" ABOVE FLOOR AT WATER COOLER LOCATION. PROVIDE 1/2" X 3/8" ANGLE STOP SUPPLY VALVE. ALL
- LOCATIONS TO BE REVIEWED BY TENANT PRIOR TO INSTALLATION. PROVIDE LONGITUDINAL AND TRANSVERSE BRACING. SEE DETAILS 10" STORM PIPE, REFER TO DETAIL 11 ON ARCHITECTURAL SHEET
- 4 FOR THIS RL, SEE SHEET P-003 DETAIL 6 FOR PIPE MATERIAL.

NOTE:
DOMESTIC WATER MAINS, VALVES & PRVS TO BE INSTALLED OUTSIDE OF THE ROBOTICS FIELD. COORDINATE ROUTING WITH CLEAR HEIGHT REQUIREMENTS AND ALL TRADES, INCLUDING MECHANICAL DUCT LOCATIONS.

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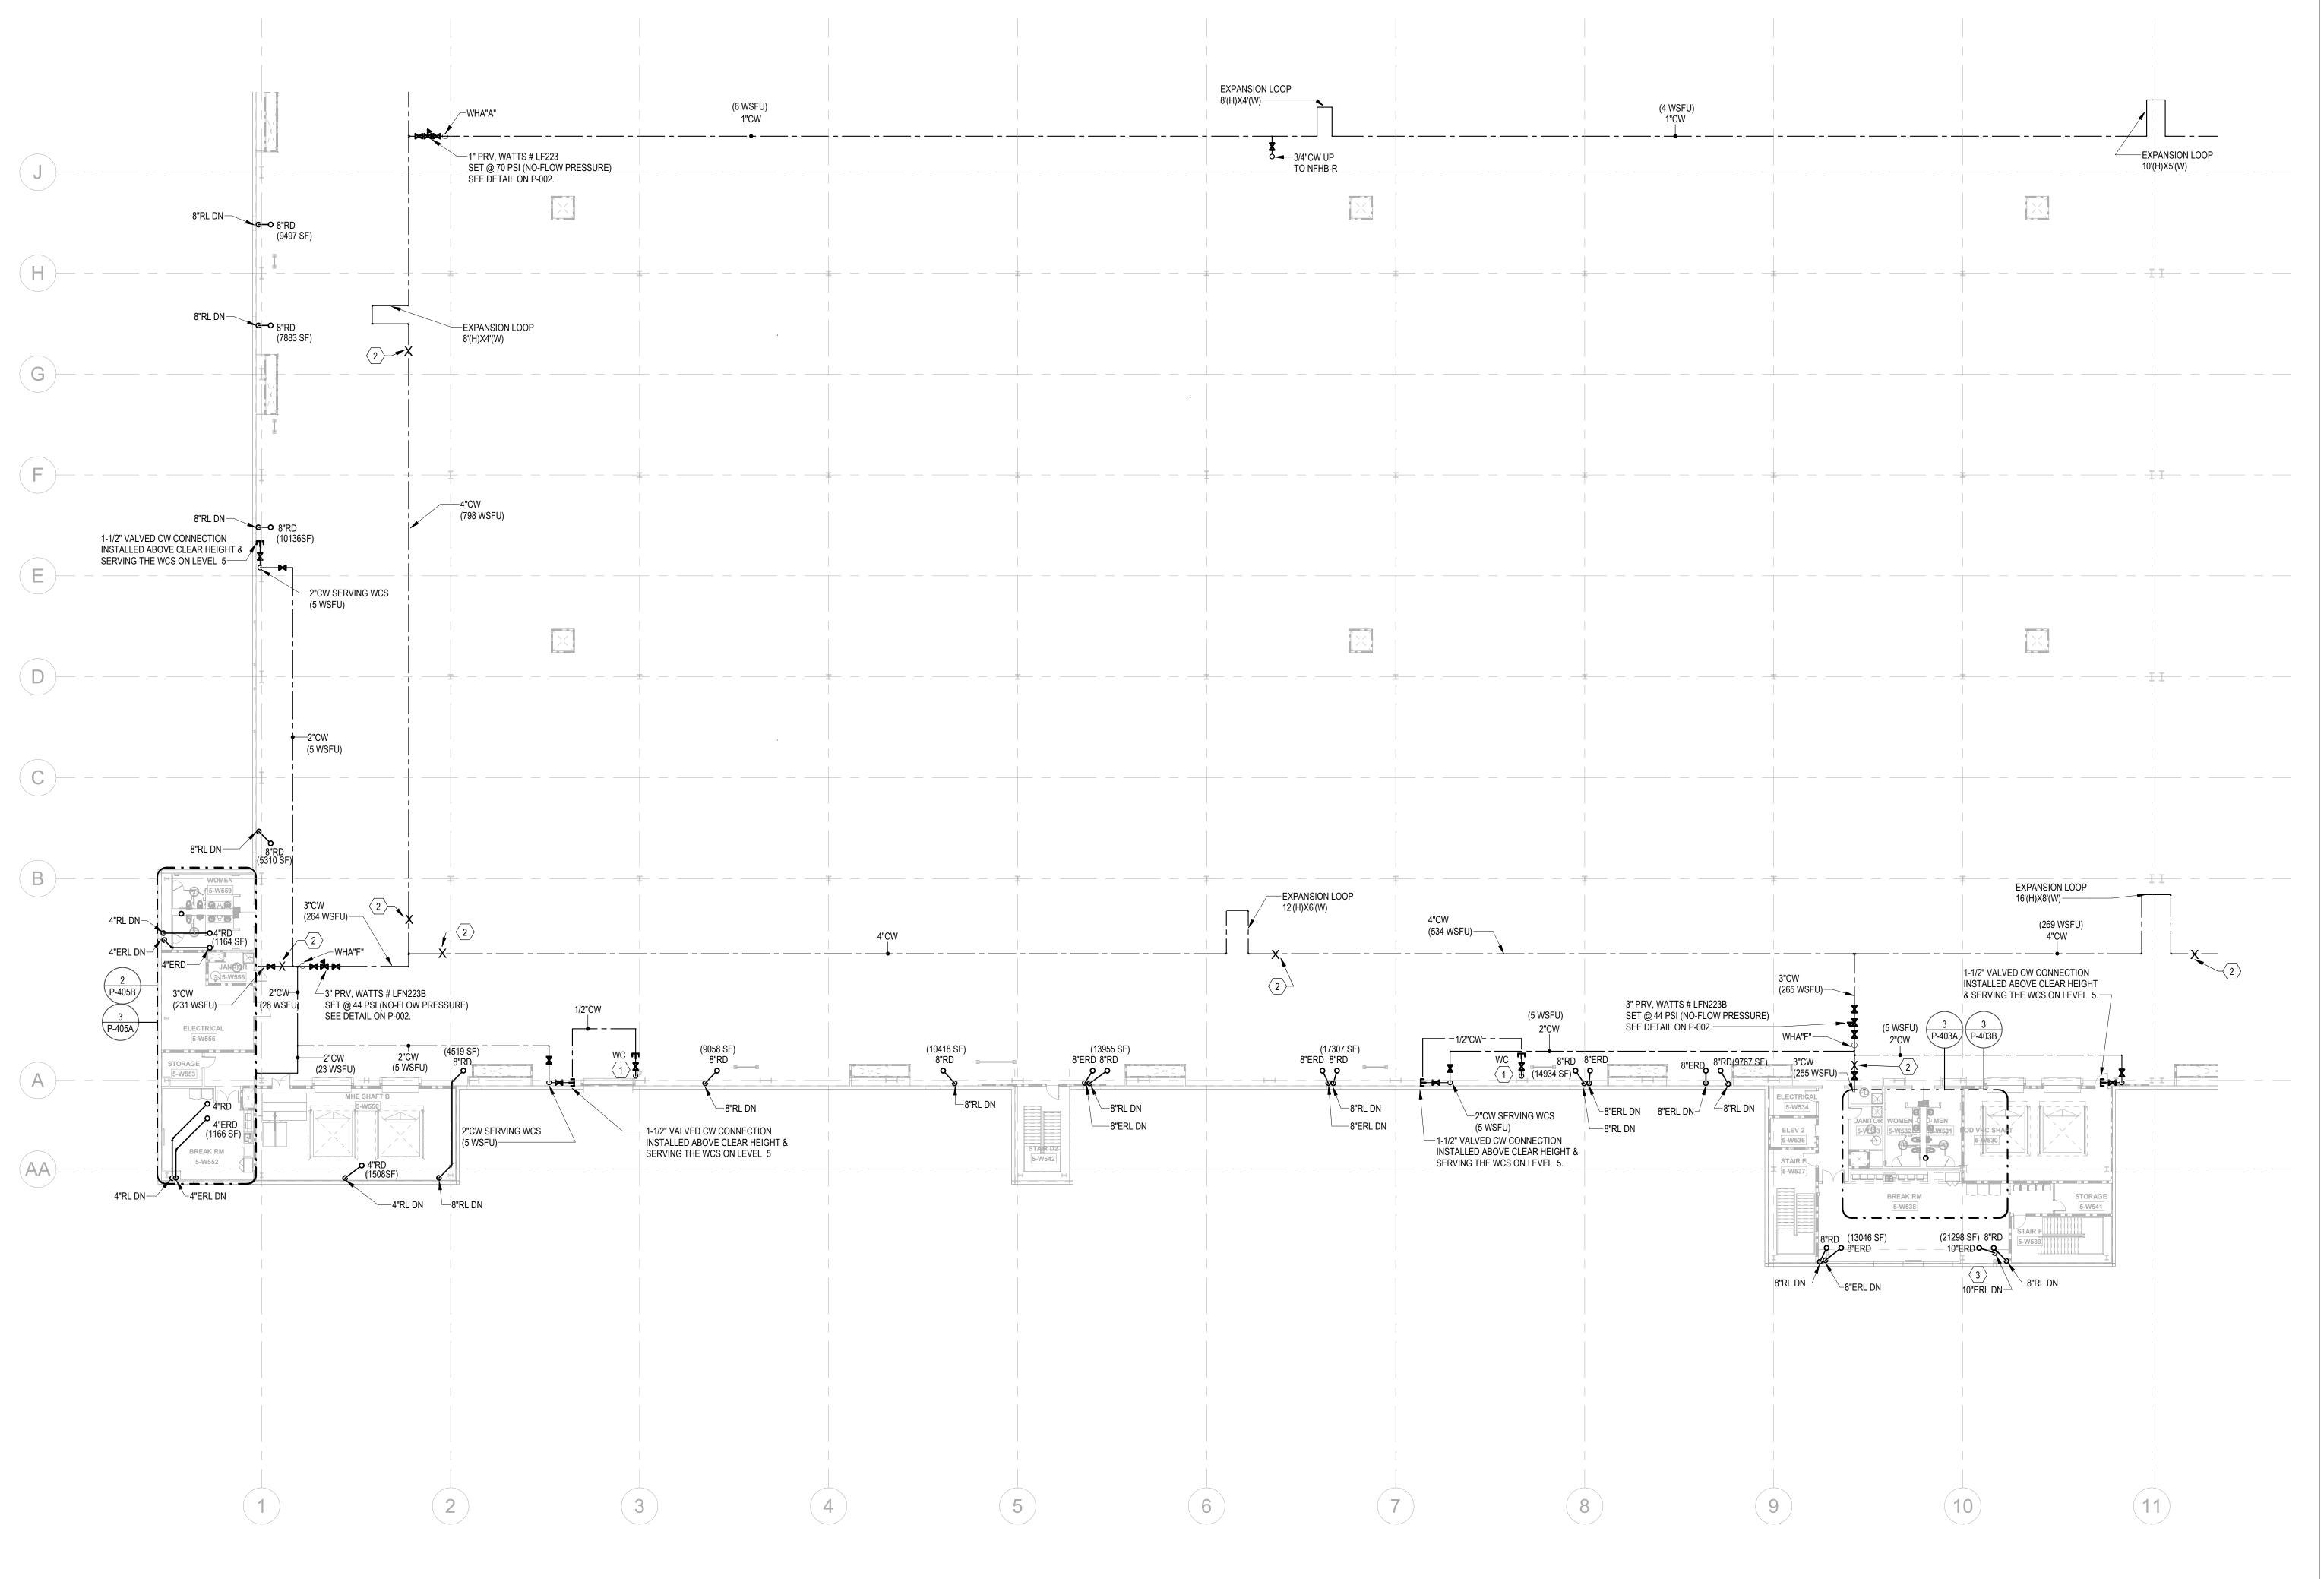
2024-013

SHEET TITLE PARTIAL FLOOR PLAN -LEVEL 5 B -PLUMBING

SHEET NUMBER

P-223

NOT FOR CONSTRUCTION



1" = 20'-0"

STORM DRAINAGE NOTES: STORM PIPING & ROOF DRAINS ARE SIZED BASED ON 2018 NORTH CAROLINA PLUMBING CODE. (PRIMARY ROOF DRAIN: BASED ON RAINFALL RATE OF 4.5" ONE-HOUR DURATION AND A 100-YEAR RETURN PERIOD; SECONDARY ROOF DRAIN: BASED ON 100-YEAR, 15-MINUTE RAINFALL(8.5"/HOUR). ABOVE GROUND: OFFSET RAIN WATER LEADER AT ROOF 45-DEGREE ANGLE, WHILE MAINTAINING FLOOR CLEAR HEIGHT. WHERE 45-DEGREE OFFSETS ARE NOT POSSIBLE, ALL HORIZONTAL STORM PIPING ABOVE GROUND SHALL SLOPE AT 1/4" PER FOOT, MINIMUM, UON. DOWNSPOUT NOZZLE SHALL BE INSTALLED AT 24" ABOVE FINISHED GRADE, UON.

2"CW SERVING WCS

(5 WSFU)-

8"RL DN-

8"ERL DN-

(3)10"ERD **8 6** 8"RD (13820 SF)

KEYNOTES

- PROVIDE 1/2" WATER TAP WITH BALL VALVE AND COPPER MANIFOLD. LOCATE BALL VALVE 8'-0" AFF. ROUTE 1/2" COPPER PIPING FROM TAP TO EACH OWNER PROVIDED WATER COOLER. STUB COPPER PIPING 24" ABOVE FLOOR AT WATER COOLER LOCATION. PROVIDE 1/2" X 3/8" ANGLE STOP SUPPLY VALVE. ALL LOCATIONS TO BE REVIEWED BY TENANT PRIOR TO INSTALLATION.
- PROVIDE LONGITUDINAL AND TRANSVERSE BRACING. SEE DETAILS 10" STORM PIPE, REFER TO DETAIL 11 ON ARCHITECTURAL SHEET

4 FOR THIS RL, SEE SHEET P-003 DETAIL 6 FOR PIPE MATERIAL.

NOTE:
DOMESTIC WATER MAINS, VALVES & PRVS TO BE INSTALLED OUTSIDE OF THE ROBOTICS FIELD. COORDINATE ROUTING WITH CLEAR HEIGHT REQUIREMENTS AND ALL TRADES, INCLUDING MECHANICAL DUCT LOCATIONS.

FIIF MACGREGOR ASSOCIATES **ARCHITECTS**

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PRINT RECORD NUMBER DATE DESCRIPTION 06/10/24 PRICING SET

PROJECT WHALE

WILMINGTON, NC

2024-013

SHEET TITLE PARTIAL FLOOR PLAN -LEVEL 5 C -PLUMBING

SHEET NUMBER P-224

NOT FOR CONSTRUCTION

PARTIAL FLOOR PLANS - LEVEL 5 - C - PLUMBING

1" = 20'-0"

1-1/2" VALVED CW CONNECTION INSTALLED ABOVE CLEAR HEIGHT & SERVING THE WCS ON LEVEL 5

∕-3/4"CW DN

<u>4"FS-3</u> <u>W/TP-A</u>

W/TP-A 4" WASTE

√3/4"CW TO HB WITH SHUT-OFF VALVE

4"RD (1138 SF)


√4"RL (5505 SF)

8"ERD 8"RD(4410 SF)

8"ERL DN —

4"RL DN---

(1271 WSFU)

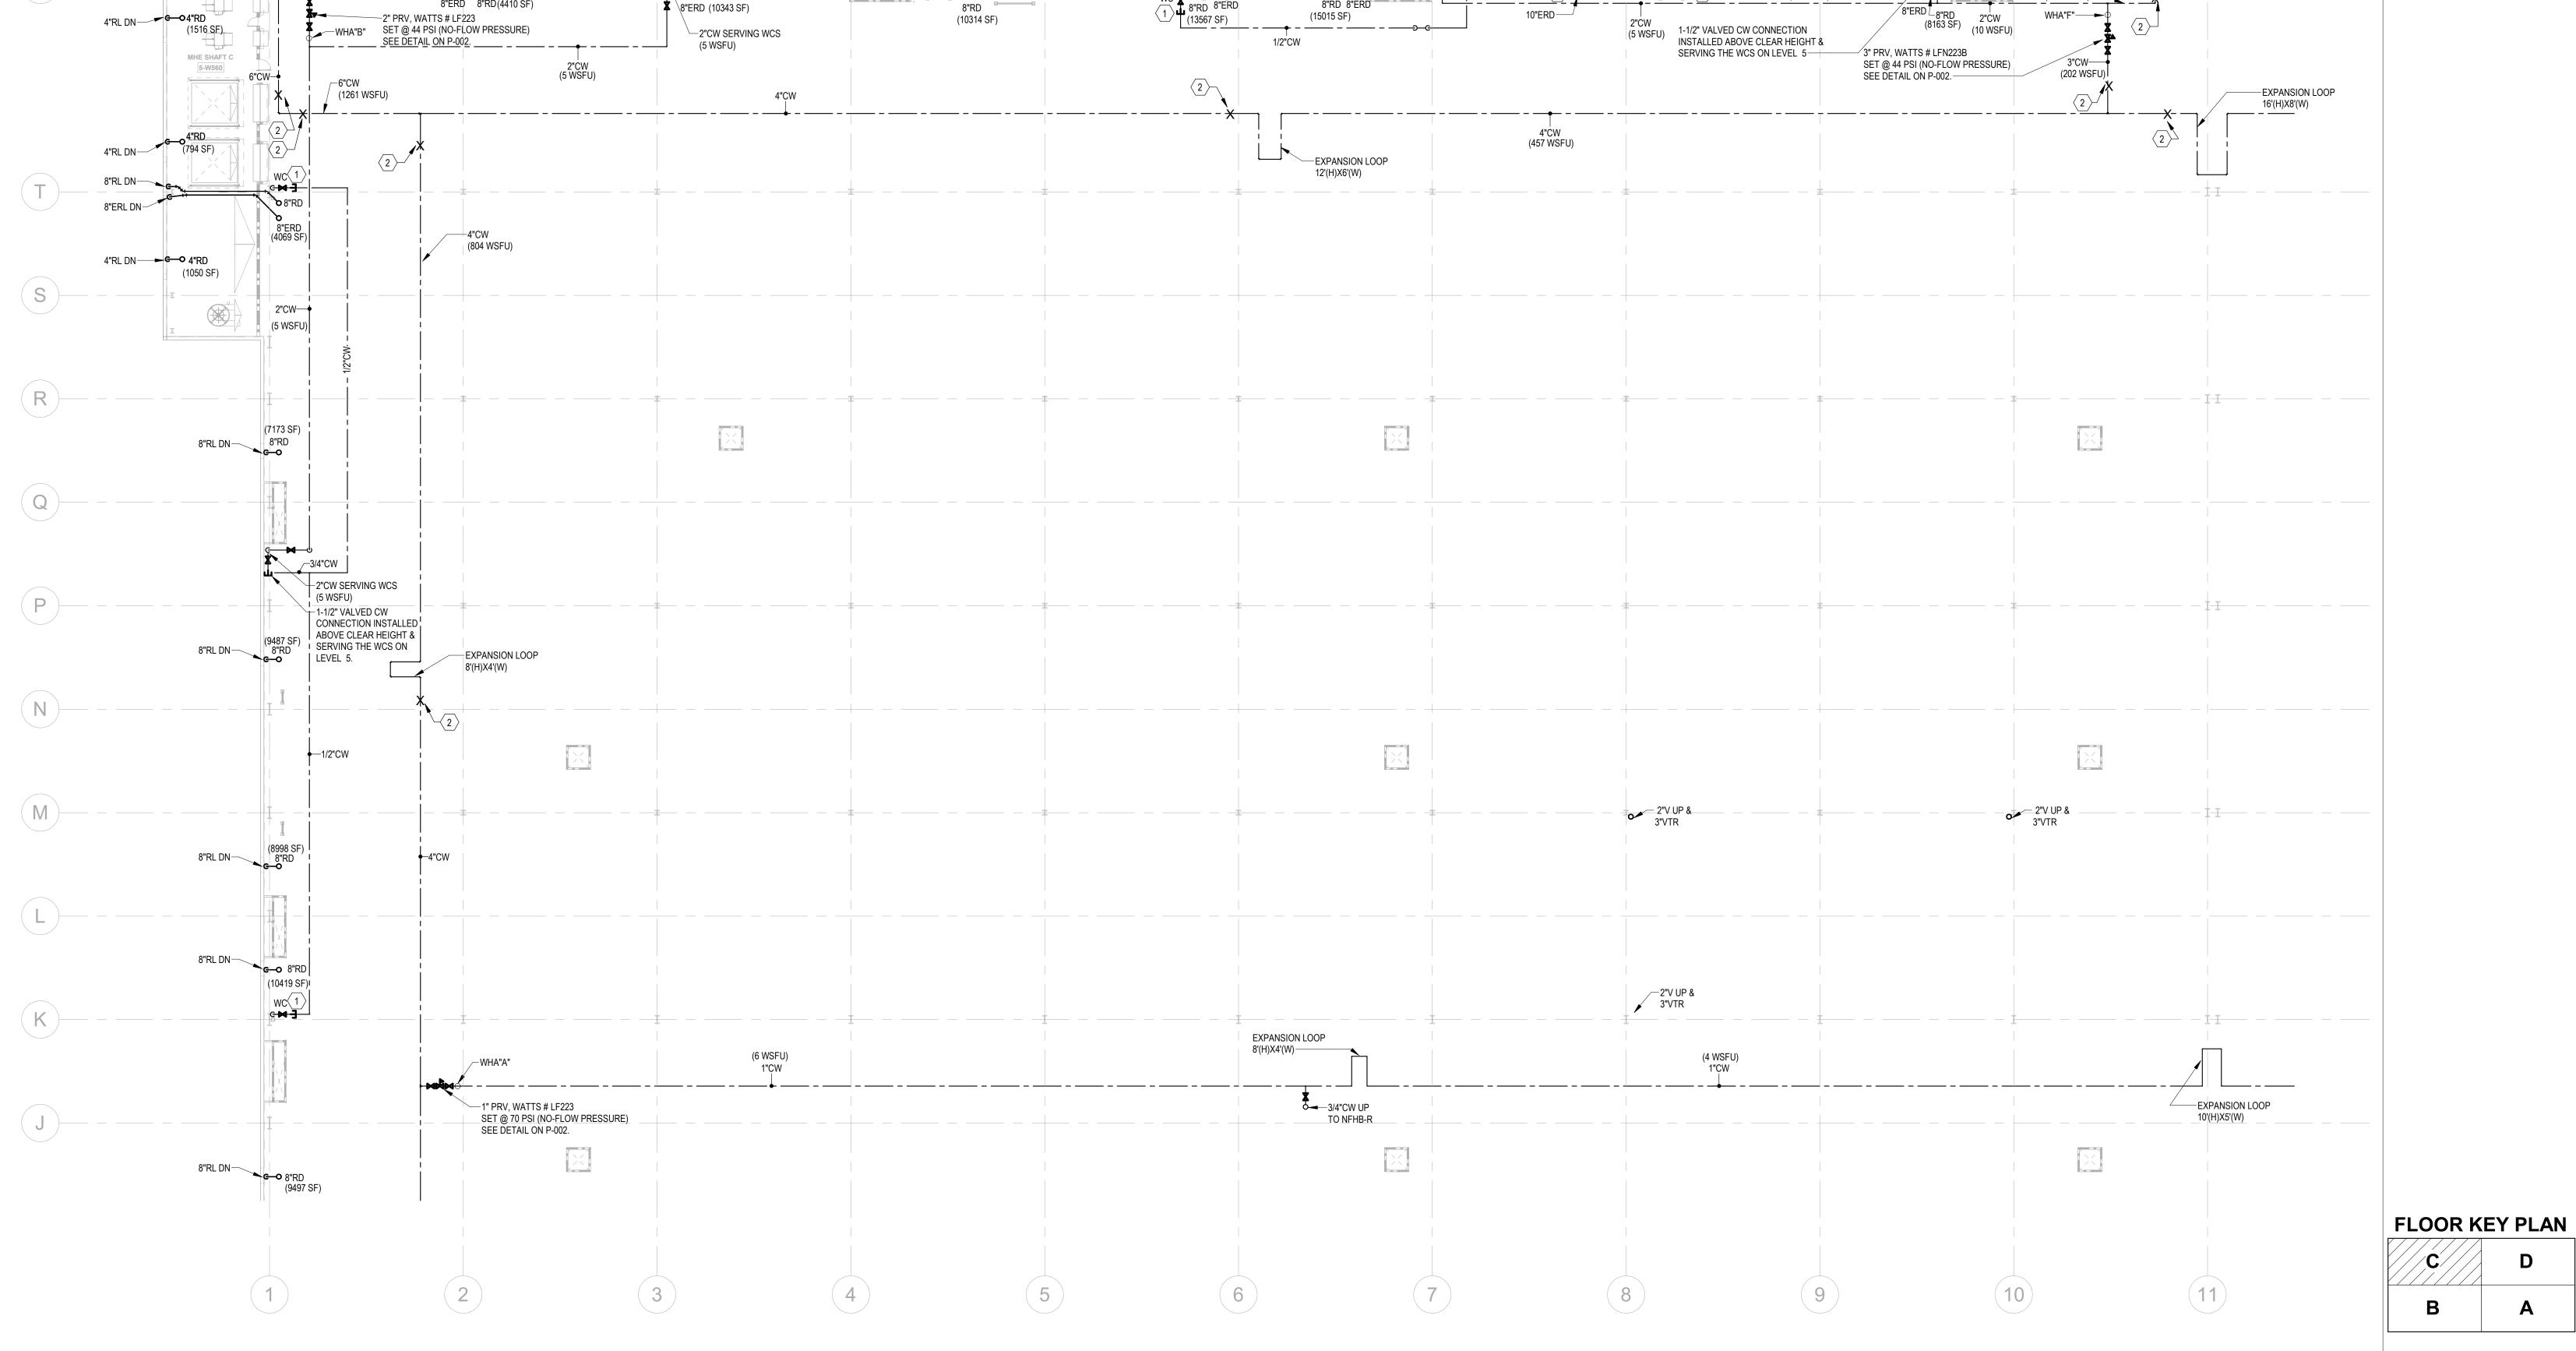

─8"ERL DN

__2"CW SERVING WCS

— 1-1/2" VALVED CW CONNECTION INSTALLED ABOVE CLEAR HEIGHT &

SERVING THE WCS ON LEVEL 5

(5 WSFU)

STORM PIPING & ROOF DRAINS ARE SIZED BASED ON 2018 NORTH CAROLINA PLUMBING CODE.

(PRIMARY ROOF DRAIN: BASED ON RAINFALL RATE OF 4.5" ONE-HOUR DURATION AND A 100-YEAR RETURN PERIOD;
SECONDARY ROOF DRAIN: BASED ON 100-YEAR, 15-MINUTE RAINFALL(8.5"/HOUR).
ABOVE GROUND: OFFSET RAIN WATER LEADER AT ROOF 45-DEGREE ANGLE, WHILE MAINTAINING FLOOR CLEAR HEIGHT.
WHERE 45-DEGREE OFFSETS ARE NOT POSSIBLE, ALL HORIZONTAL STORM PIPING ABOVE GROUND SHALL SLOPE AT 1/4" PER FOOT, MINIMUM, UON.

DOWNSPOUT NOZZLE SHALL BE INSTALLED AT 24" ABOVE FINISHED GRADE, UON.

(786 SF)

4"RD (847 SF) ELECTRICAL

5-W514

4"RL DN

9-1 4"RL DN

4"RL DN ─ 8"ERL DN ─

3" PRV, WATTS # LFN223B SET @ 44 PSI (NO-FLOW PRESSURE)

SEE DETAIL ON P-002.

5-W506

1/2"CW

2"CW SERVING WCS

(5 WSFU)---

1-1/2" VALVED CW CONNECTION

─8"RL DN

STAIR B1

2"CW (5 WSFU)

4"ĊW

(255 WSFU)

6 68"ERD

INSTALLED ABOVE CLEAR HEIGHT &

SERVING THE WCS ON LEVEL 5

KEYNOTES

- PROVIDE 1/2" WATER TAP WITH BALL VALVE AND COPPER MANIFOLD. LOCATE BALL VALVE 8'-0" AFF. ROUTE 1/2" COPPER PIPING FROM TAP TO EACH OWNER PROVIDED WATER COOLER. STUB COPPER PIPING 24" ABOVE FLOOR AT WATER COOLER LOCATION. PROVIDE 1/2" X 3/8" ANGLE STOP SUPPLY VALVE. ALL LOCATIONS TO BE REVIEWED BY TENANT PRIOR TO INSTALLATION.
- PROVIDE LONGITUDINAL AND TRANSVERSE BRACING. SEE DETAILS ON P-003.

 10" STORM PIPE, REFER TO DETAIL 11 ON ARCHITECTURAL SHEET

4 FOR THIS RL, SEE SHEET P-003 DETAIL 6 FOR PIPE MATERIAL.

NOTE:
DOMESTIC WATER MAINS, VALVES & PRVS TO BE INSTALLED OUTSIDE OF THE ROBOTICS FIELD. COORDINATE ROUTING WITH CLEAR HEIGHT REQUIREMENTS AND ALL TRADES, INCLUDING MECHANICAL DUCT LOCATIONS.

LILL

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Project Number:24010155 Drawn By:CF Checked By:JMW

PRINT RECORD

NUMBER DATE DESCRIPTION

06/10/24 PRICING SET

PROJECT INFORMATION

PROJECT WHALE

WILMINGTON, NC

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THE CONTRACTOR SHALL VERIFY ALL DIMENSIONS

ATE

PROJECT NO

2024-013

PARTIAL
FLOOR PLAN LEVEL 5 D PLUMBING

SHEET NUMBER

NOT FOR CONSTRUCTION

P-225




8"RD**o 8**(3)

10"ERD 8"RD

(15182 SF)

(17451 SF) 10"ERD

-EXPANSION LOOP

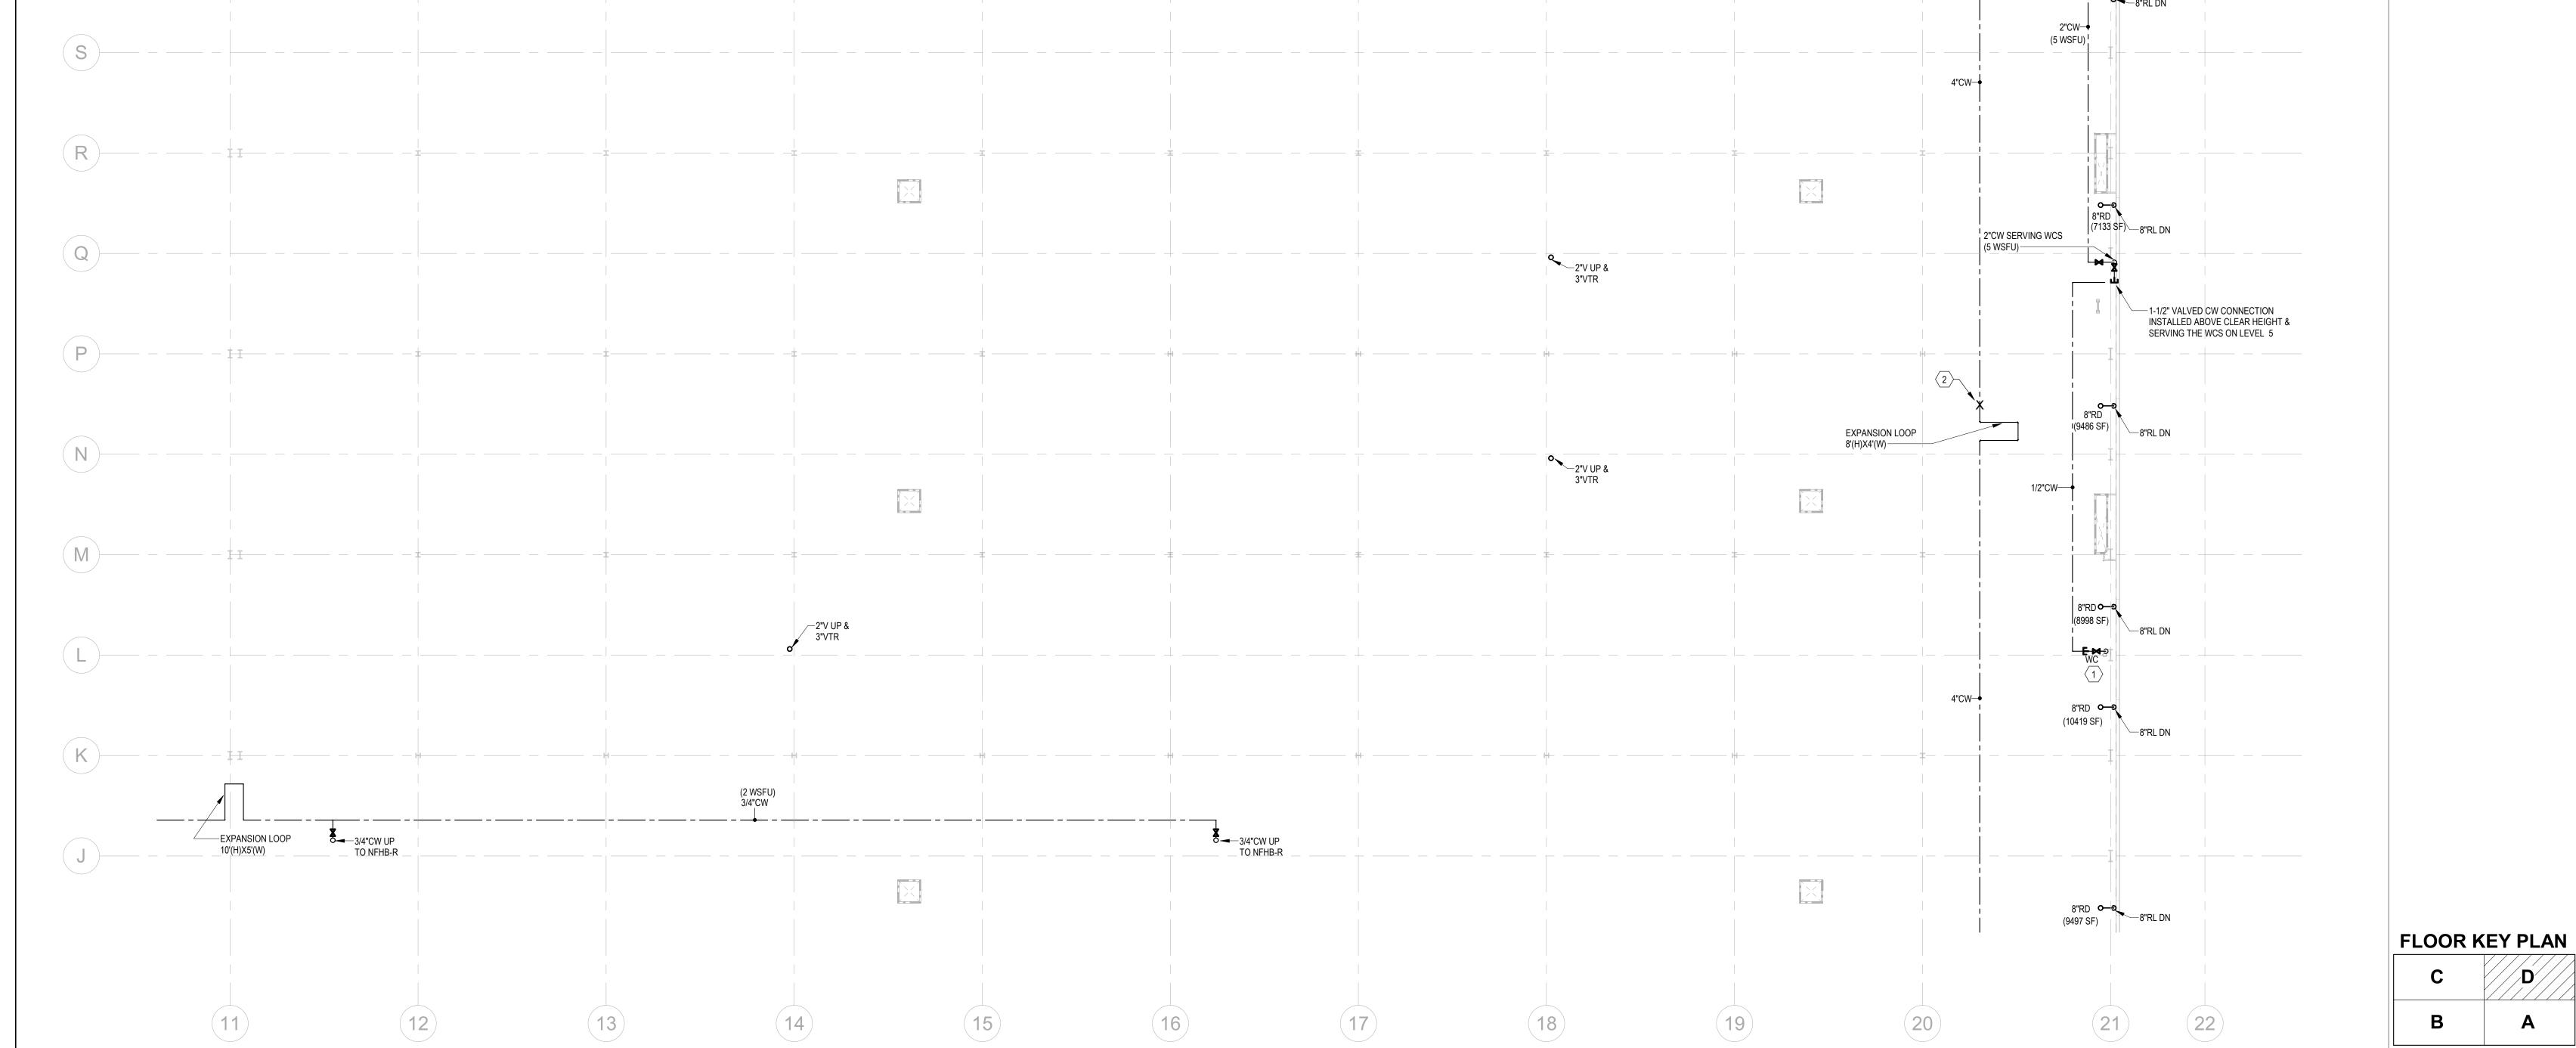

—2"CW SERVING WCS (5 WSFU)


┌─8"ERL DN

1-1/2" VALVED CW CONNECTION

EXPANSION LOOP

INSTALLED ABOVE CLEAR HEIGHT &

SERVING THE WCS ON LEVEL 5

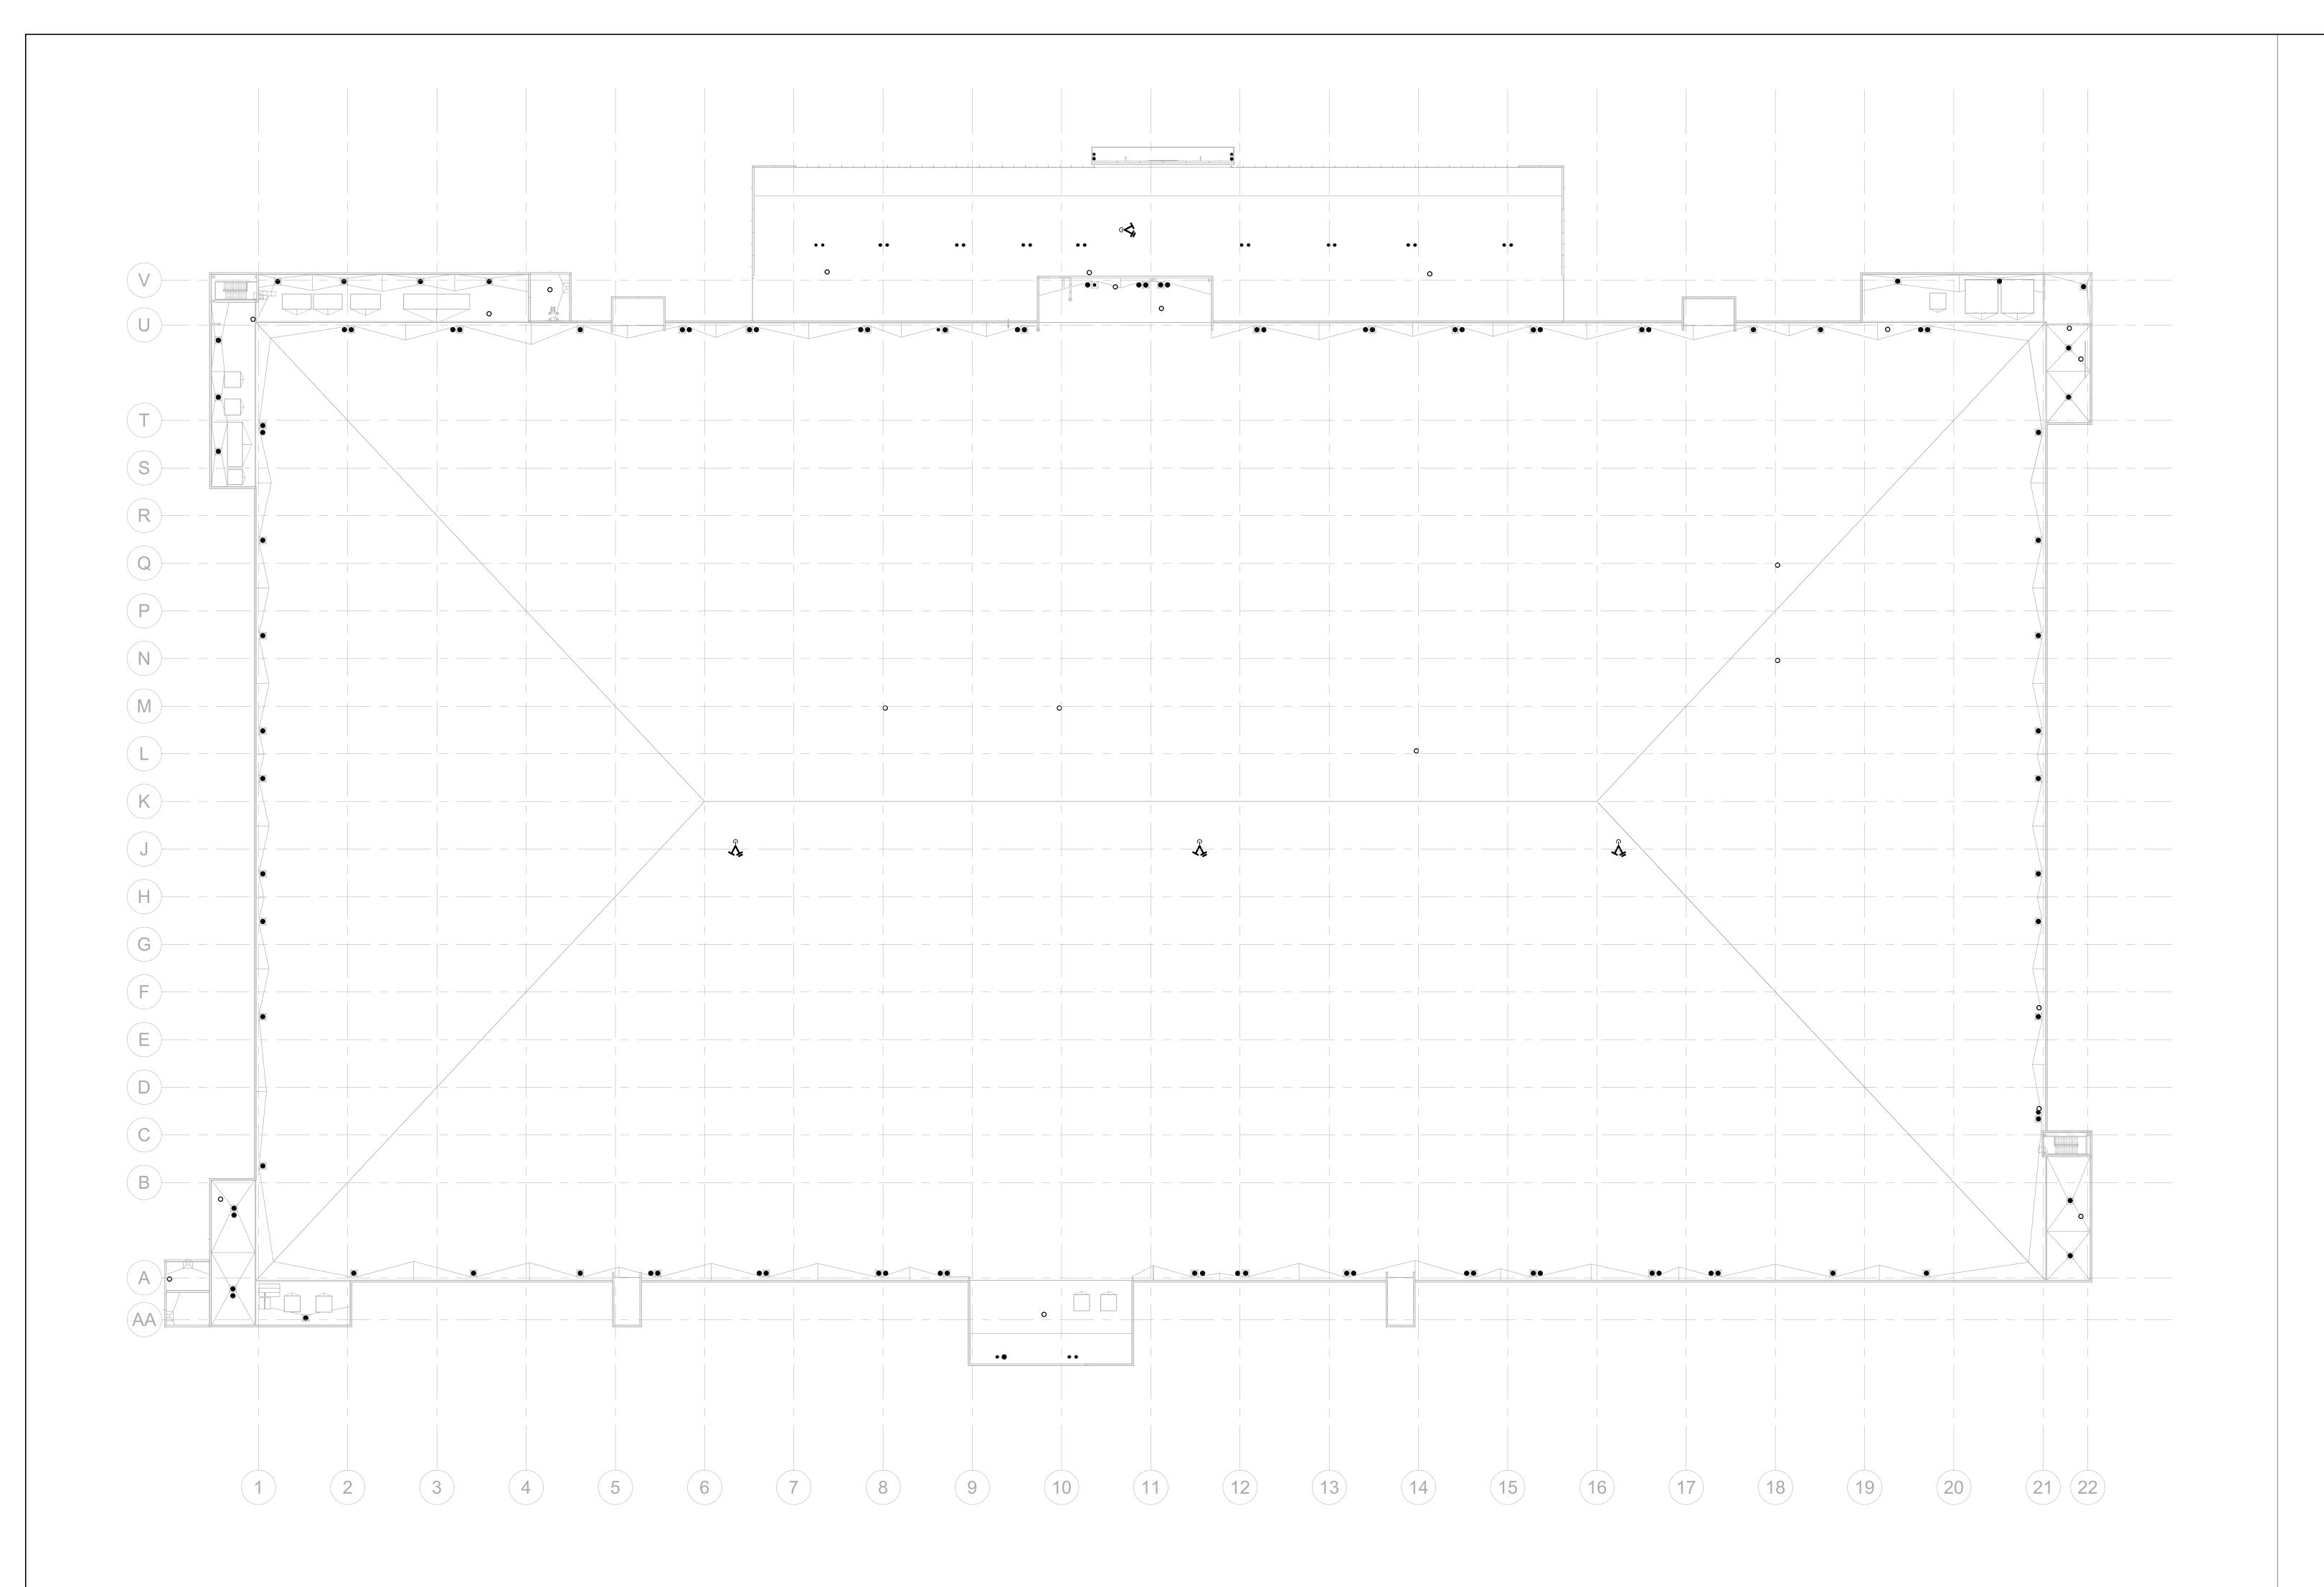



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DATE PROJECT NO
2024-013

SHEET TITLE

OVERALL ROOF
PLAN PLUMBING

P-226

NOT FOR CONSTRUCTION

FLOOR KEY PLAN

STORM DRAINAGE NOTES:
STORM PIPING & ROOF DRAINS ARE SIZED BASED ON 2018 NORTH CAROLINA PLUMBING CODE. (PRIMARY ROOF DRAIN: BASED ON RAINFALL RATE OF 4.5" ONE-HOUR DURATION AND A 100-YEAR RETURN PERIOD; SECONDARY ROOF DRAIN: BASED ON 100-YEAR, 15-MINUTE RAINFALL(8.5"/HOUR). ABOVE GROUND: OFFSET RAIN WATER LEADER AT ROOF 45-DEGREE ANGLE, WHILE MAINTAINING FLOOR CLEAR HEIGHT. WHERE 45-DEGREE OFFSETS ARE NOT POSSIBLE, ALL HORIZONTAL STORM PIPING ABOVE GROUND SHALL SLOPE AT 1/4" PER FOOT, MINIMUM, UON. DOWNSPOUT NOZZLE SHALL BE INSTALLED AT 24" ABOVE FINISHED GRADE, UON.

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Jordan & Skala

PROJECT INFORMATION


PROJECT WHALE

WILMINGTON, NC

2024-013 SHEET TITLE PARTIAL ROOF


PLAN - A -PLUMBING

SHEET NUMBER P-227

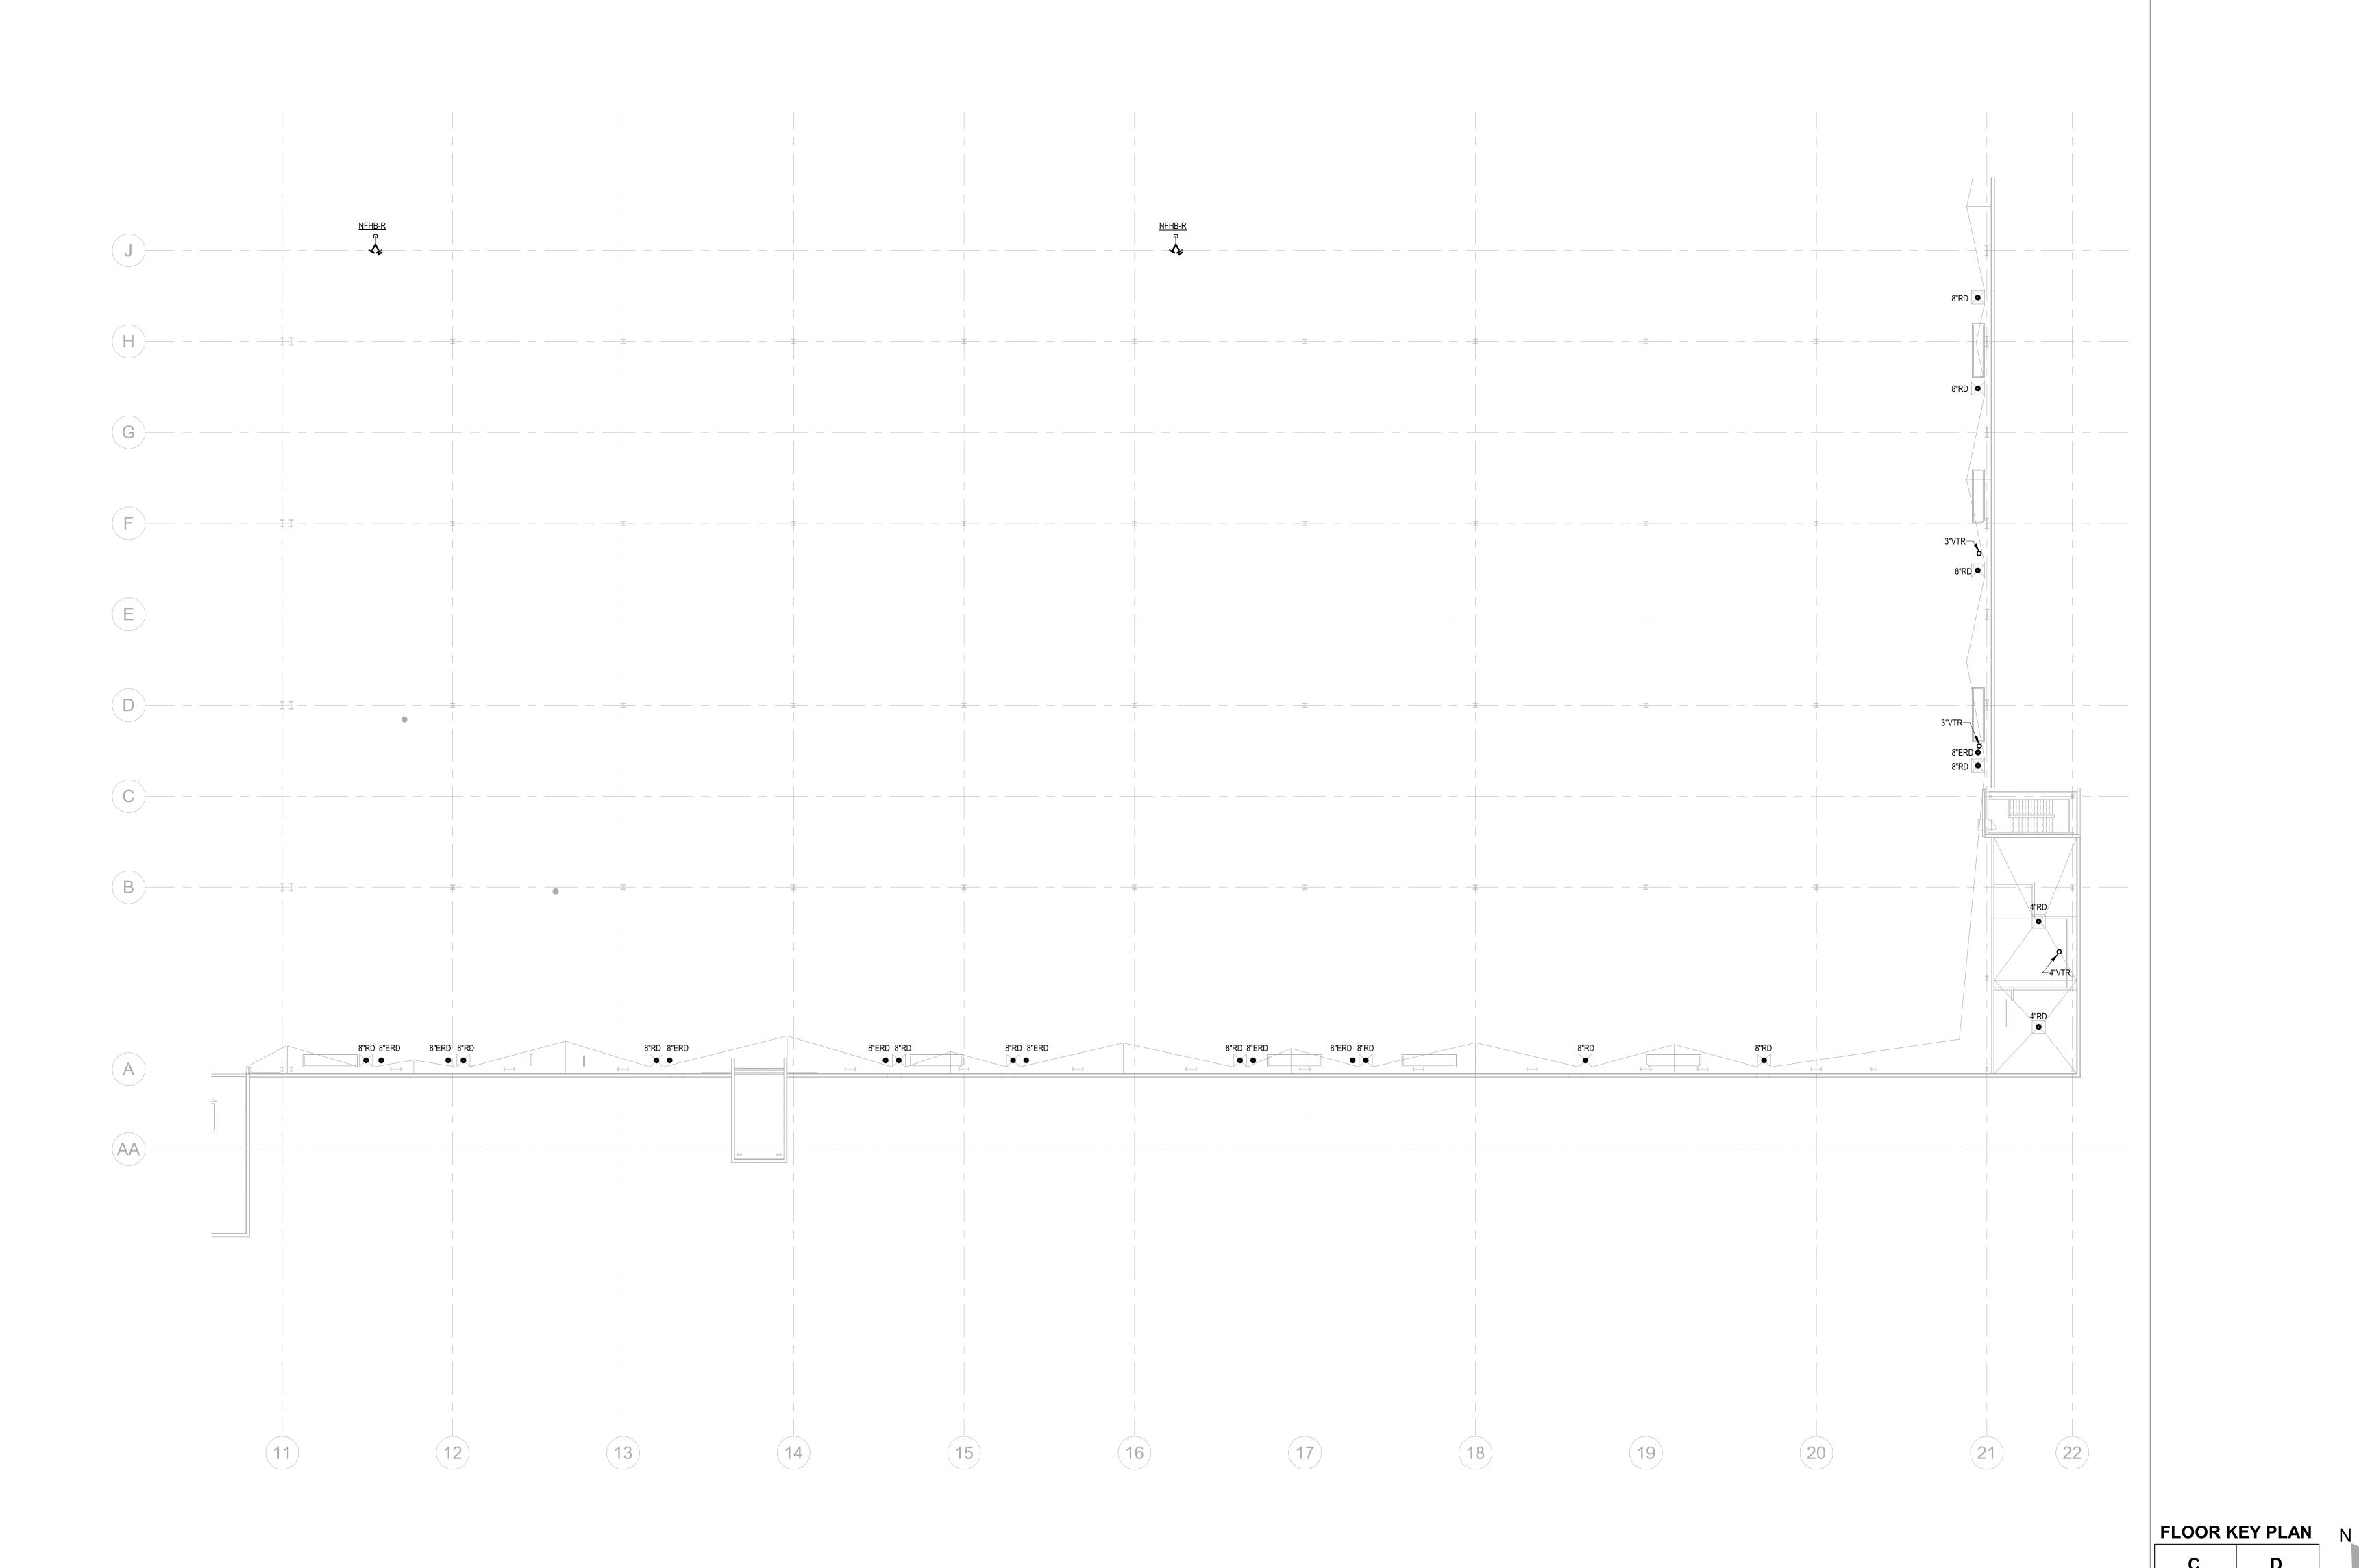

STORM DRAINAGE NOTES:
STORM PIPING & ROOF DRAINS ARE SIZED BASED ON 2018 NORTH CAROLINA PLUMBING CODE.
(PRIMARY ROOF DRAIN: BASED ON RAINFALL RATE OF 4.5" ONE-HOUR DURATION AND A 100-YEAR RETURN PERIOD;
SECONDARY ROOF DRAIN: BASED ON 100-YEAR, 15-MINUTE RAINFALL(8.5"/HOUR).
ABOVE GROUND: OFFSET RAIN WATER LEADER AT ROOF 45-DEGREE ANGLE, WHILE MAINTAINING FLOOR CLEAR HEIGHT.
WHERE 45-DEGREE OFFSETS ARE NOT POSSIBLE, ALL HORIZONTAL STORM PIPING ABOVE GROUND SHALL SLOPE AT 1/4" PER FOOT, MINIMUM, UON.

DOWNSPOUT NOZZLE SHALL BE INSTALLED AT 24" ABOVE FINISHED GRADE, UON.

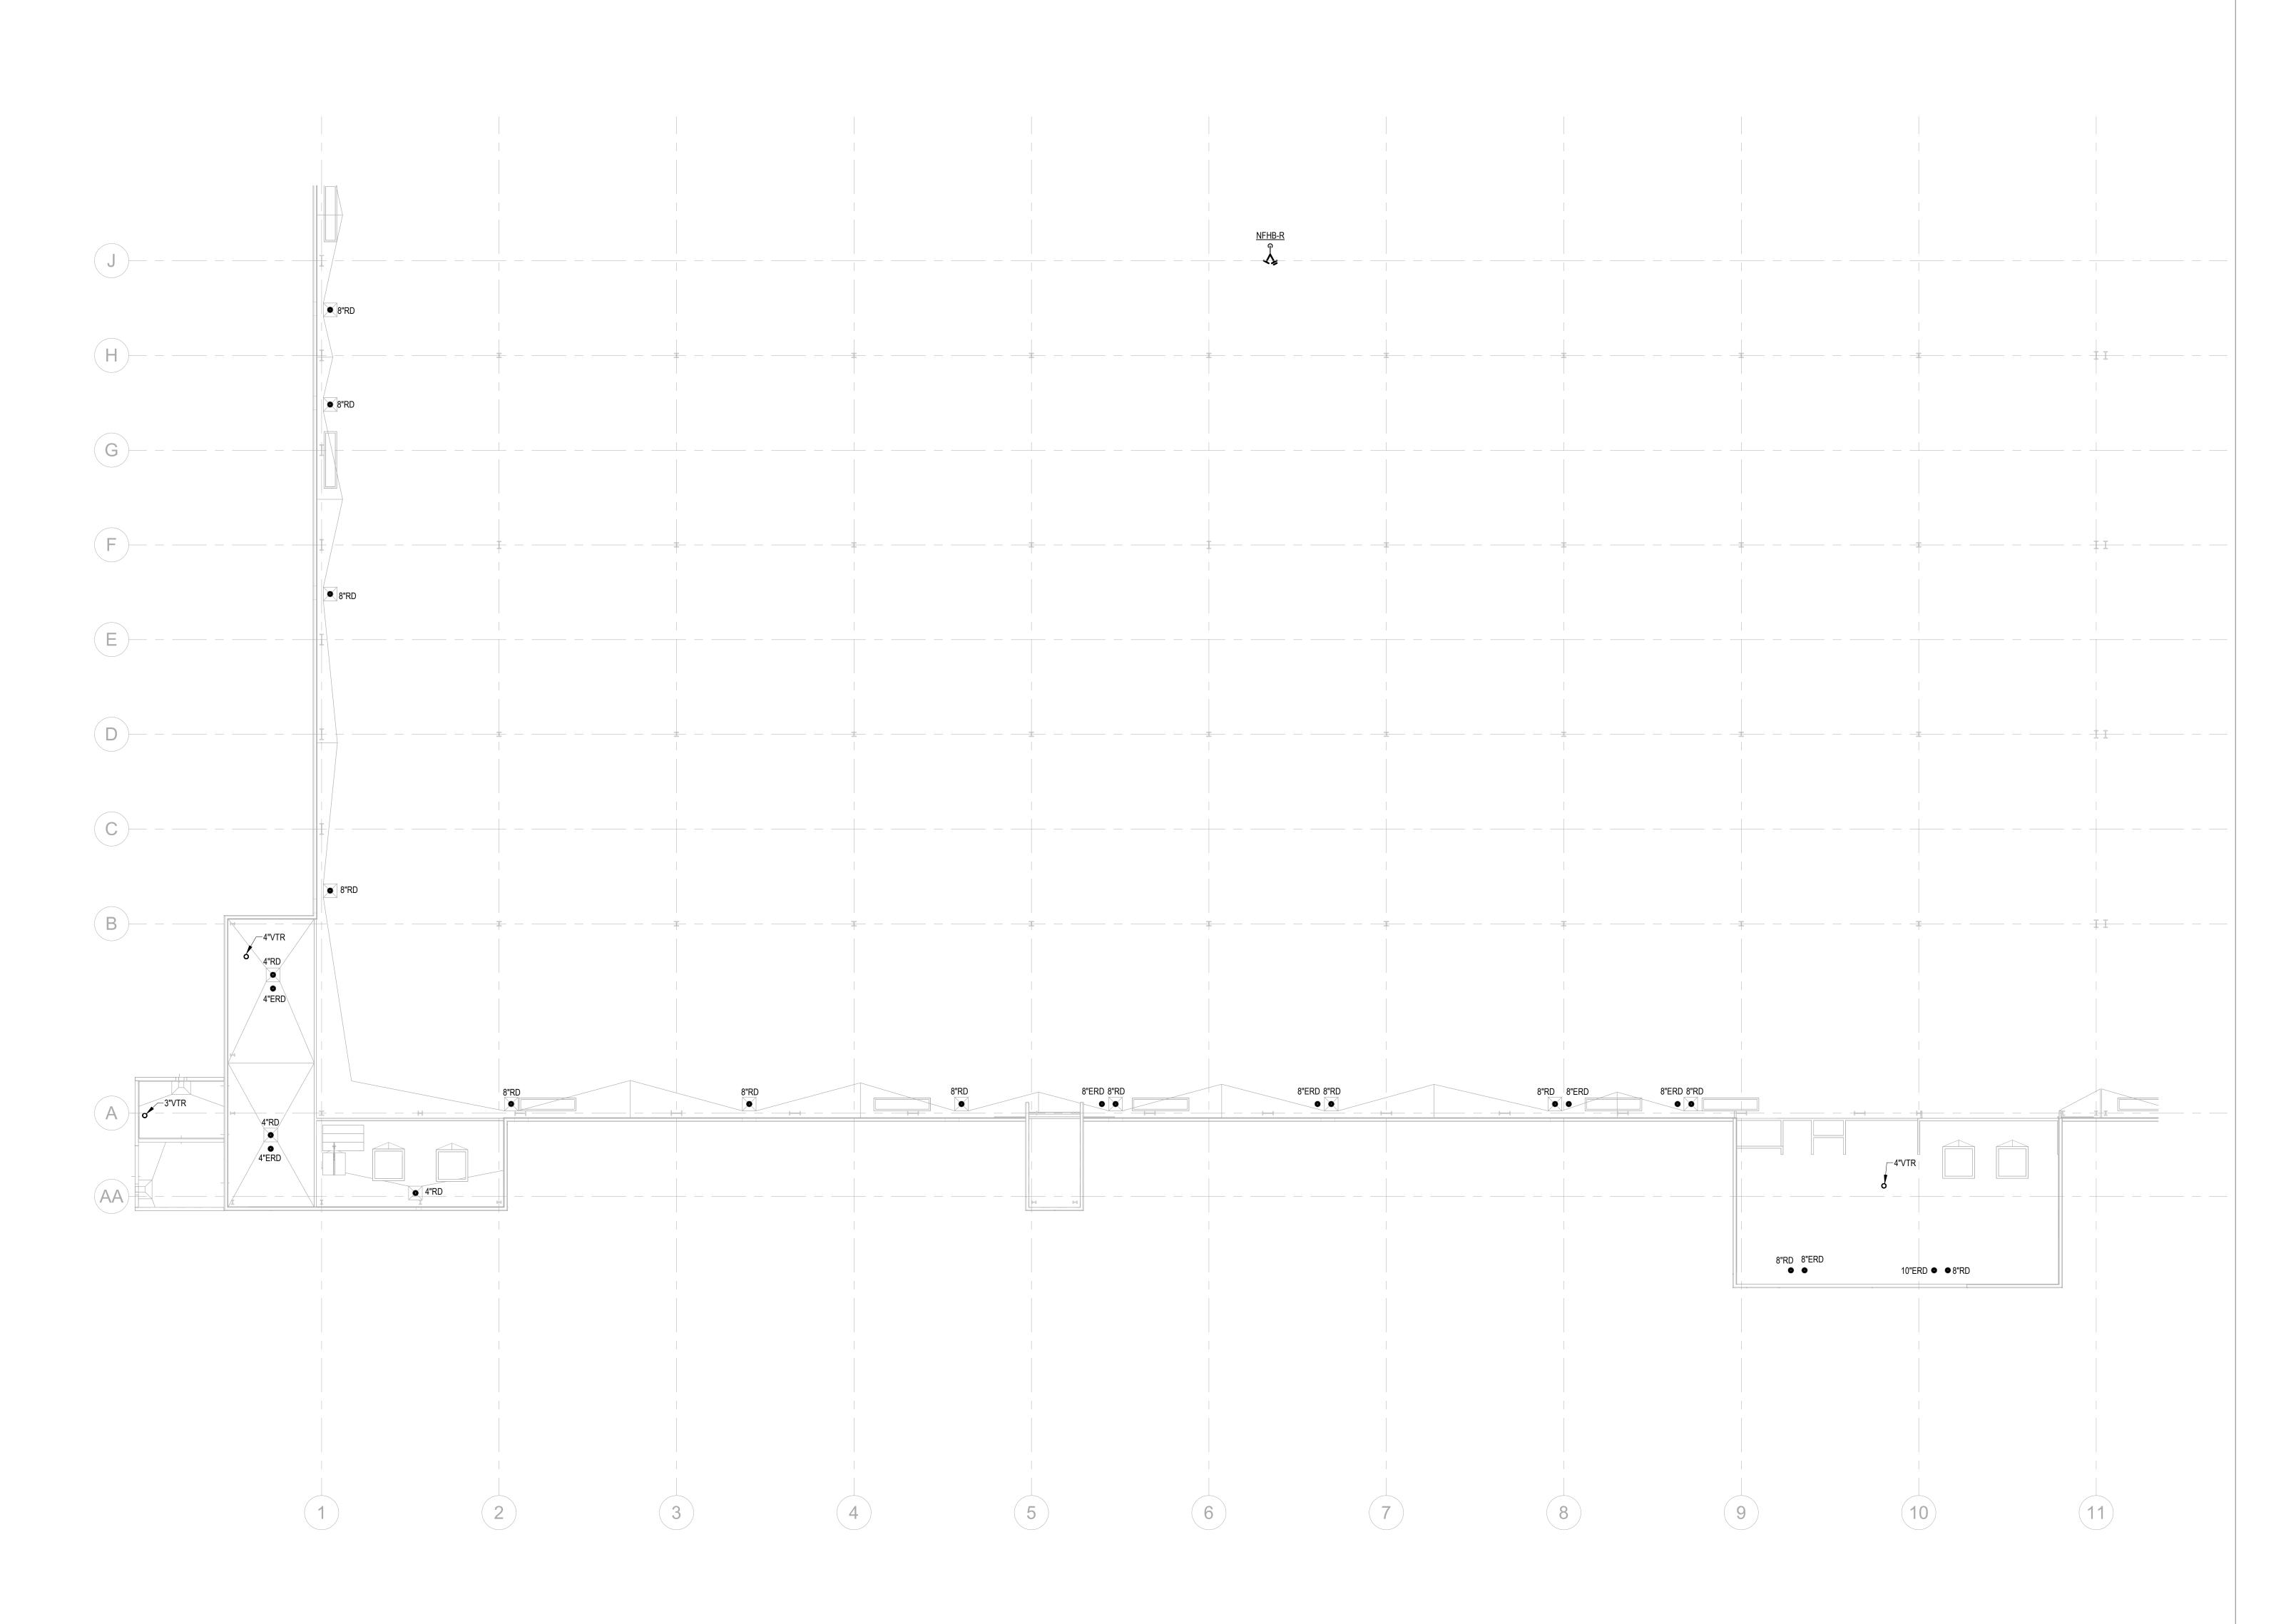

FLOOR KEY PLAN N

C D

D A



1 PARTIAL ROOF PLAN - B - PLUMBING

1" = 20'-0"

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PROJECT INFORMATION

PROJECT

WHALE

WILMINGTON, NC

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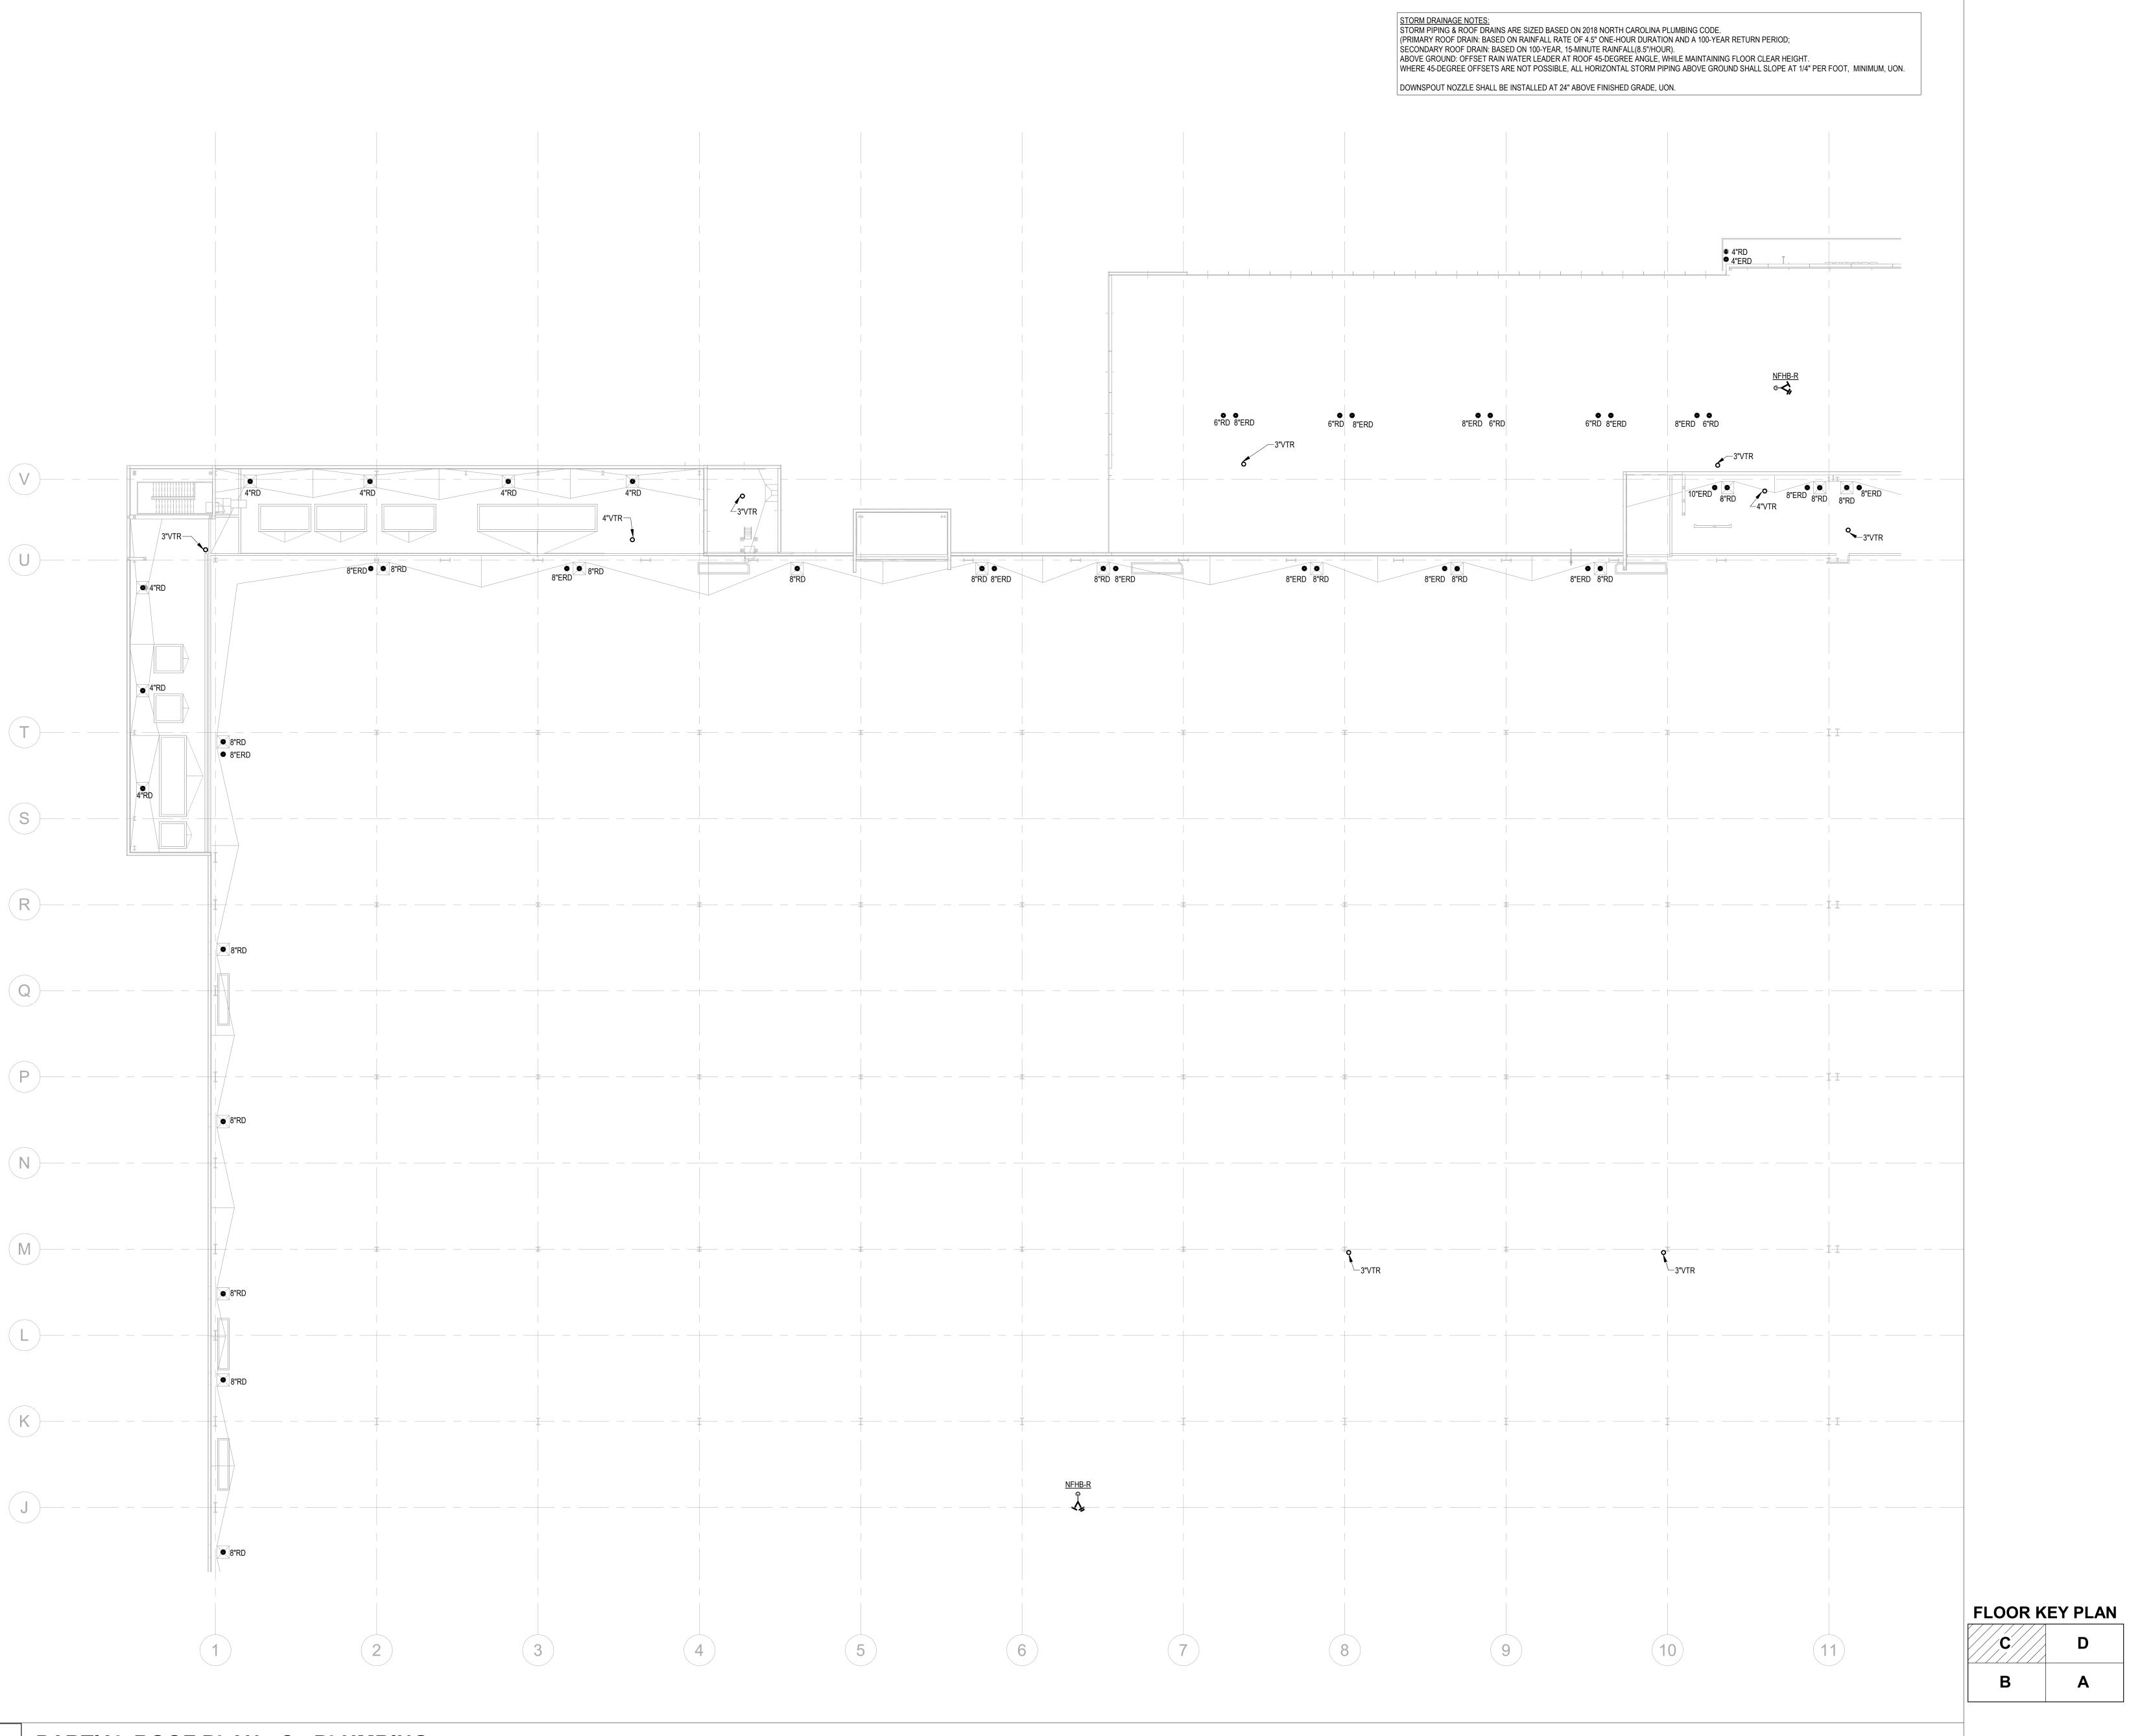
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PROJECT NO
2024-013

SHEET TITLE
PARTIAL ROOF
PLAN - B PLUMBING

P-228



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CONTRACTOR SHALL VERIFY ALL DIMENSIONS EXISTING CONDITIONS AT THE SITE BEFORE OCCEDING WITH EACH PHASE OF HIS WORK.

DATE
PROJECT NO
2024-013

SHEET TITLE
PARTIAL ROOF
PLAN - C PLUMBING

SHEET NUMBER

P-229

STORM DRAINAGE NOTES:
STORM PIPING & ROOF DRAINS ARE SIZED BASED ON 2018 NORTH CAROLINA PLUMBING CODE.
(PRIMARY ROOF DRAIN: BASED ON RAINFALL RATE OF 4.5" ONE-HOUR DURATION AND A 100-YEAR RETURN PERIOD; SECONDARY ROOF DRAIN: BASED ON 100-YEAR, 15-MINUTE RAINFALL(8.5"/HOUR). ABOVE GROUND: OFFSET RAIN WATER LEADER AT ROOF 45-DEGREE ANGLE, WHILE MAINTAINING FLOOR CLEAR HEIGHT.
WHERE 45-DEGREE OFFSETS ARE NOT POSSIBLE, ALL HORIZONTAL STORM PIPING ABOVE GROUND SHALL SLOPE AT 1/4" PER FOOT, MINIMUM, UON. DOWNSPOUT NOZZLE SHALL BE INSTALLED AT 24" ABOVE FINISHED GRADE, UON. 6"RD 8"ERD ● ● 6"RD 8"ERD ● ● 8"ERD 6"RD ● 8"ERD 6"RD 8"ERD 8"RD ● 8"RD 8"ERD 8"RD 8"ERD **● ●** 8"RD 8"ERD _______VTR__ 4"RD • 8"RD FLOOR KEY PLAN N 21 20 18

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PROJECT WHALE

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2024-013 SHEET TITLE

PARTIAL ROOF PLAN - D -PLUMBING


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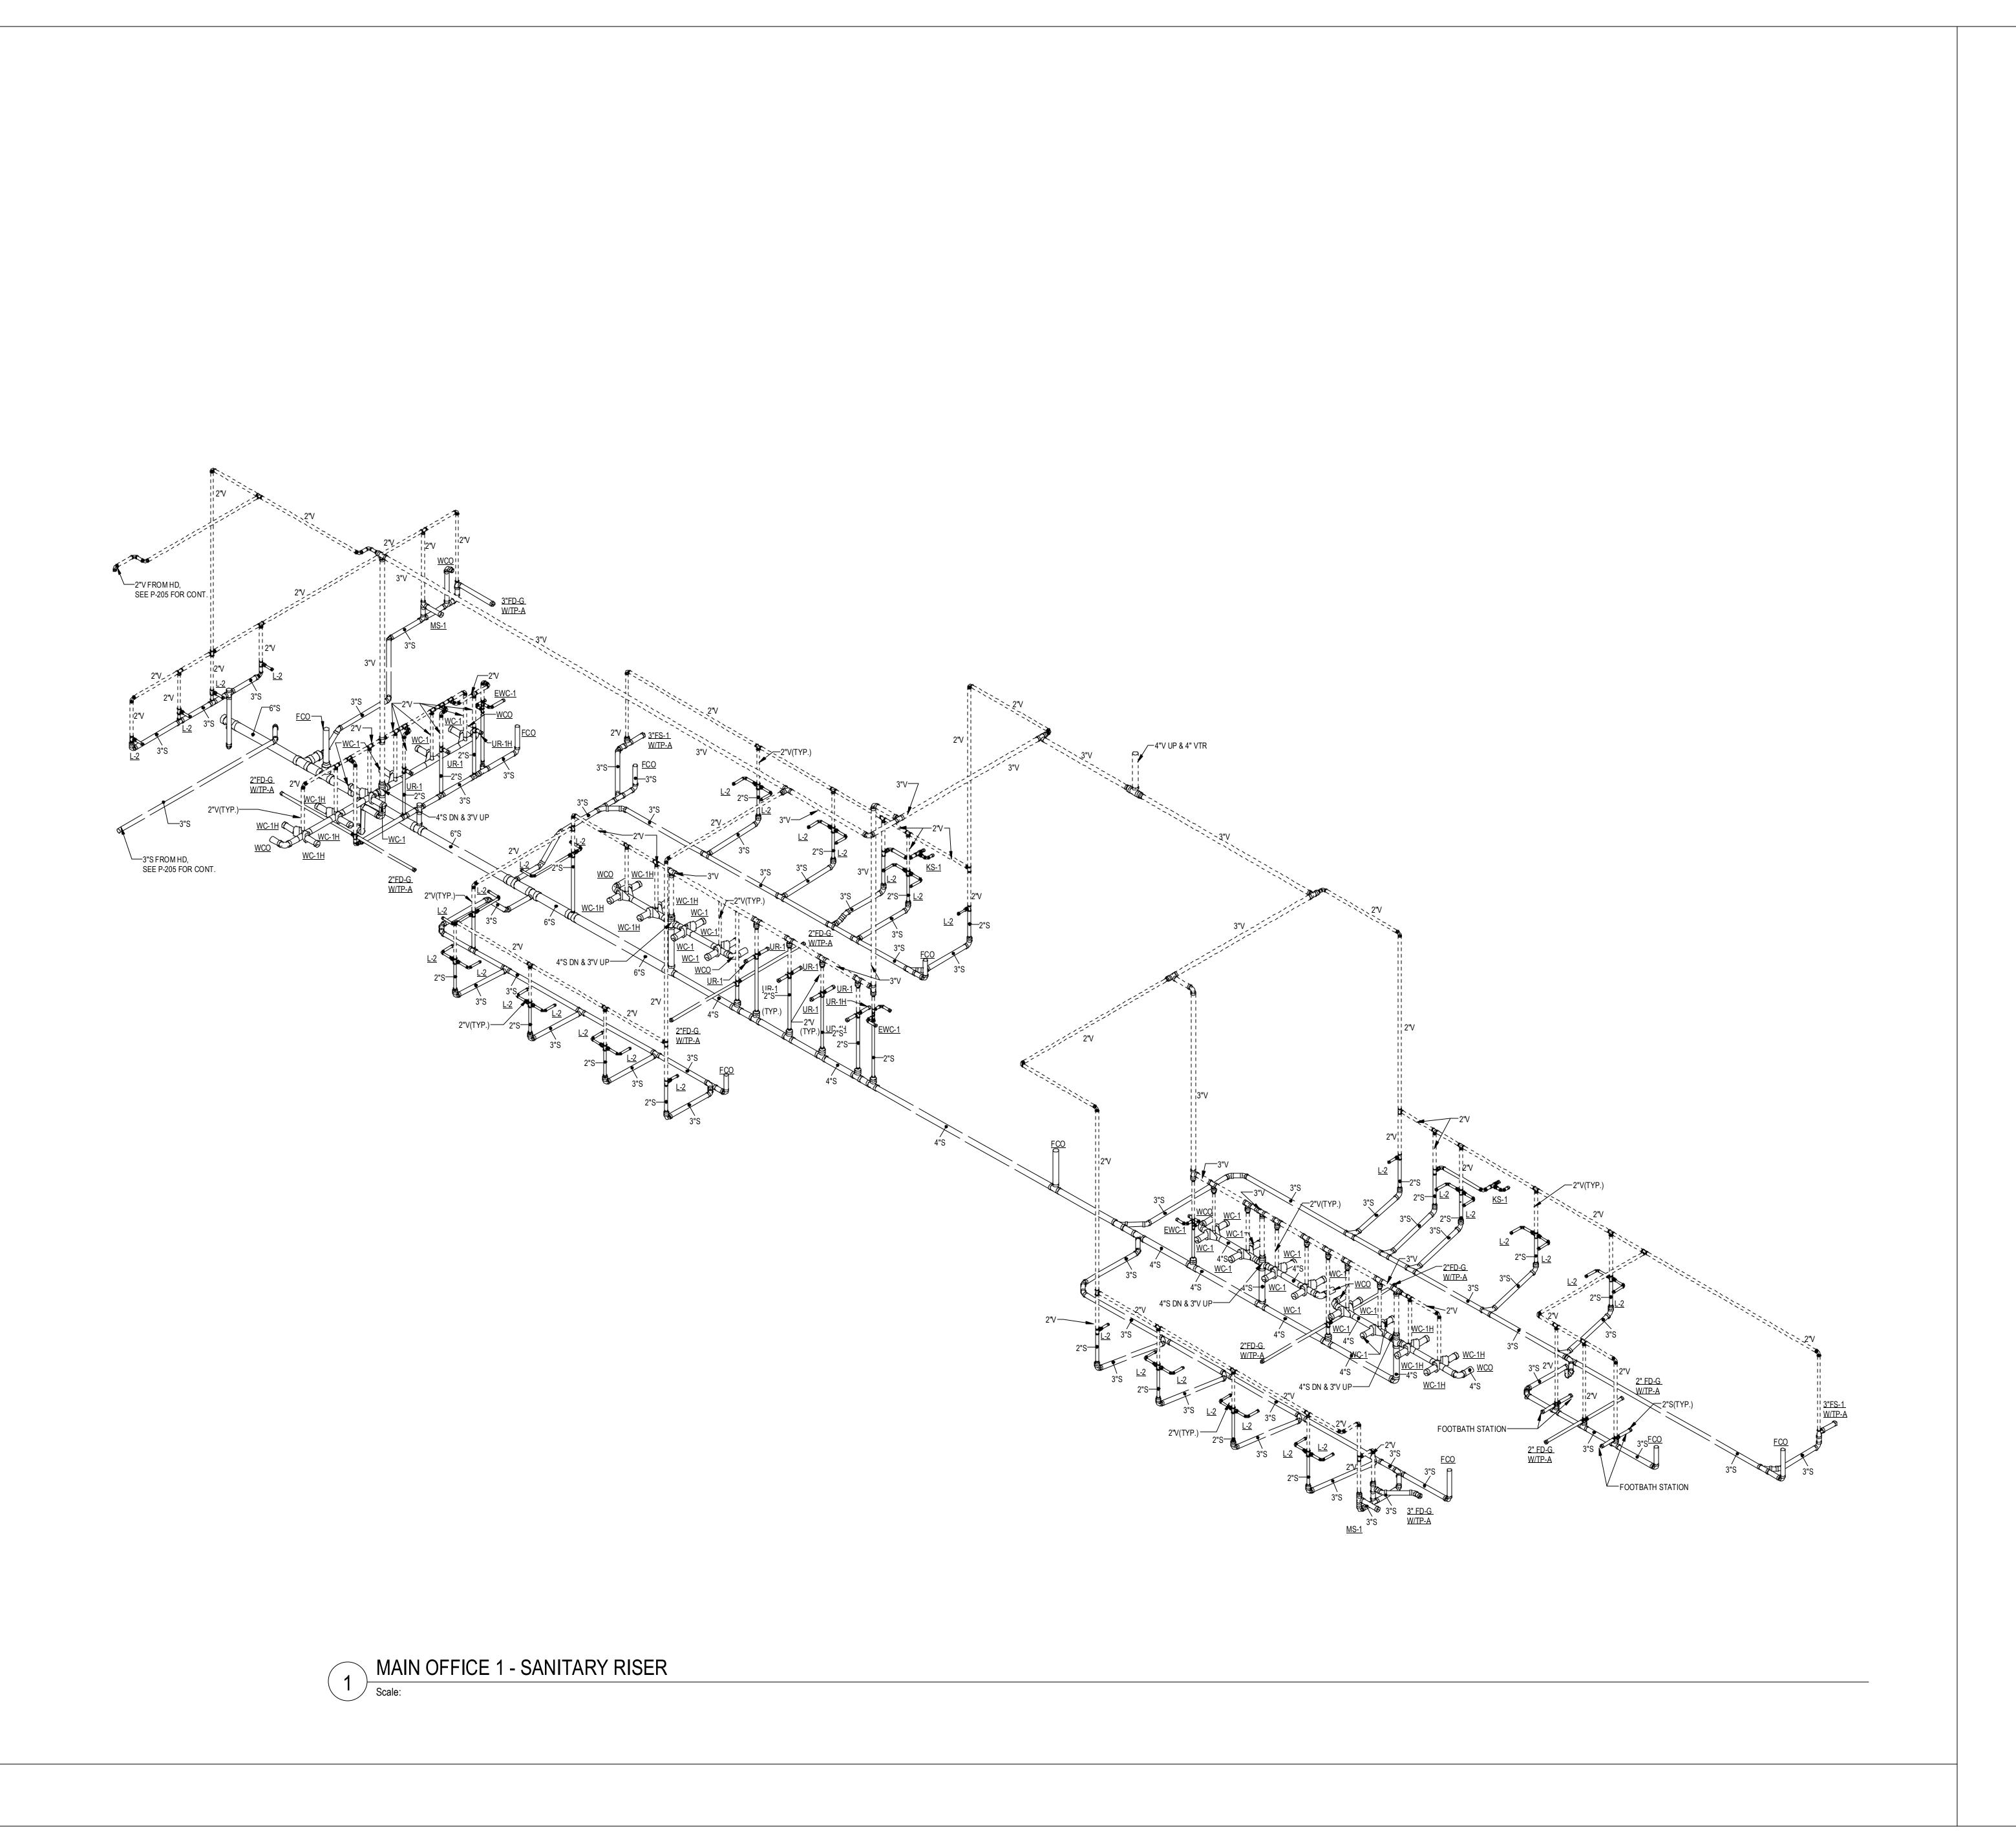
P-230

NOT FOR CONSTRUCTION

PARTIAL ROOF PLAN - D - PLUMBING

1" = 20'-0"



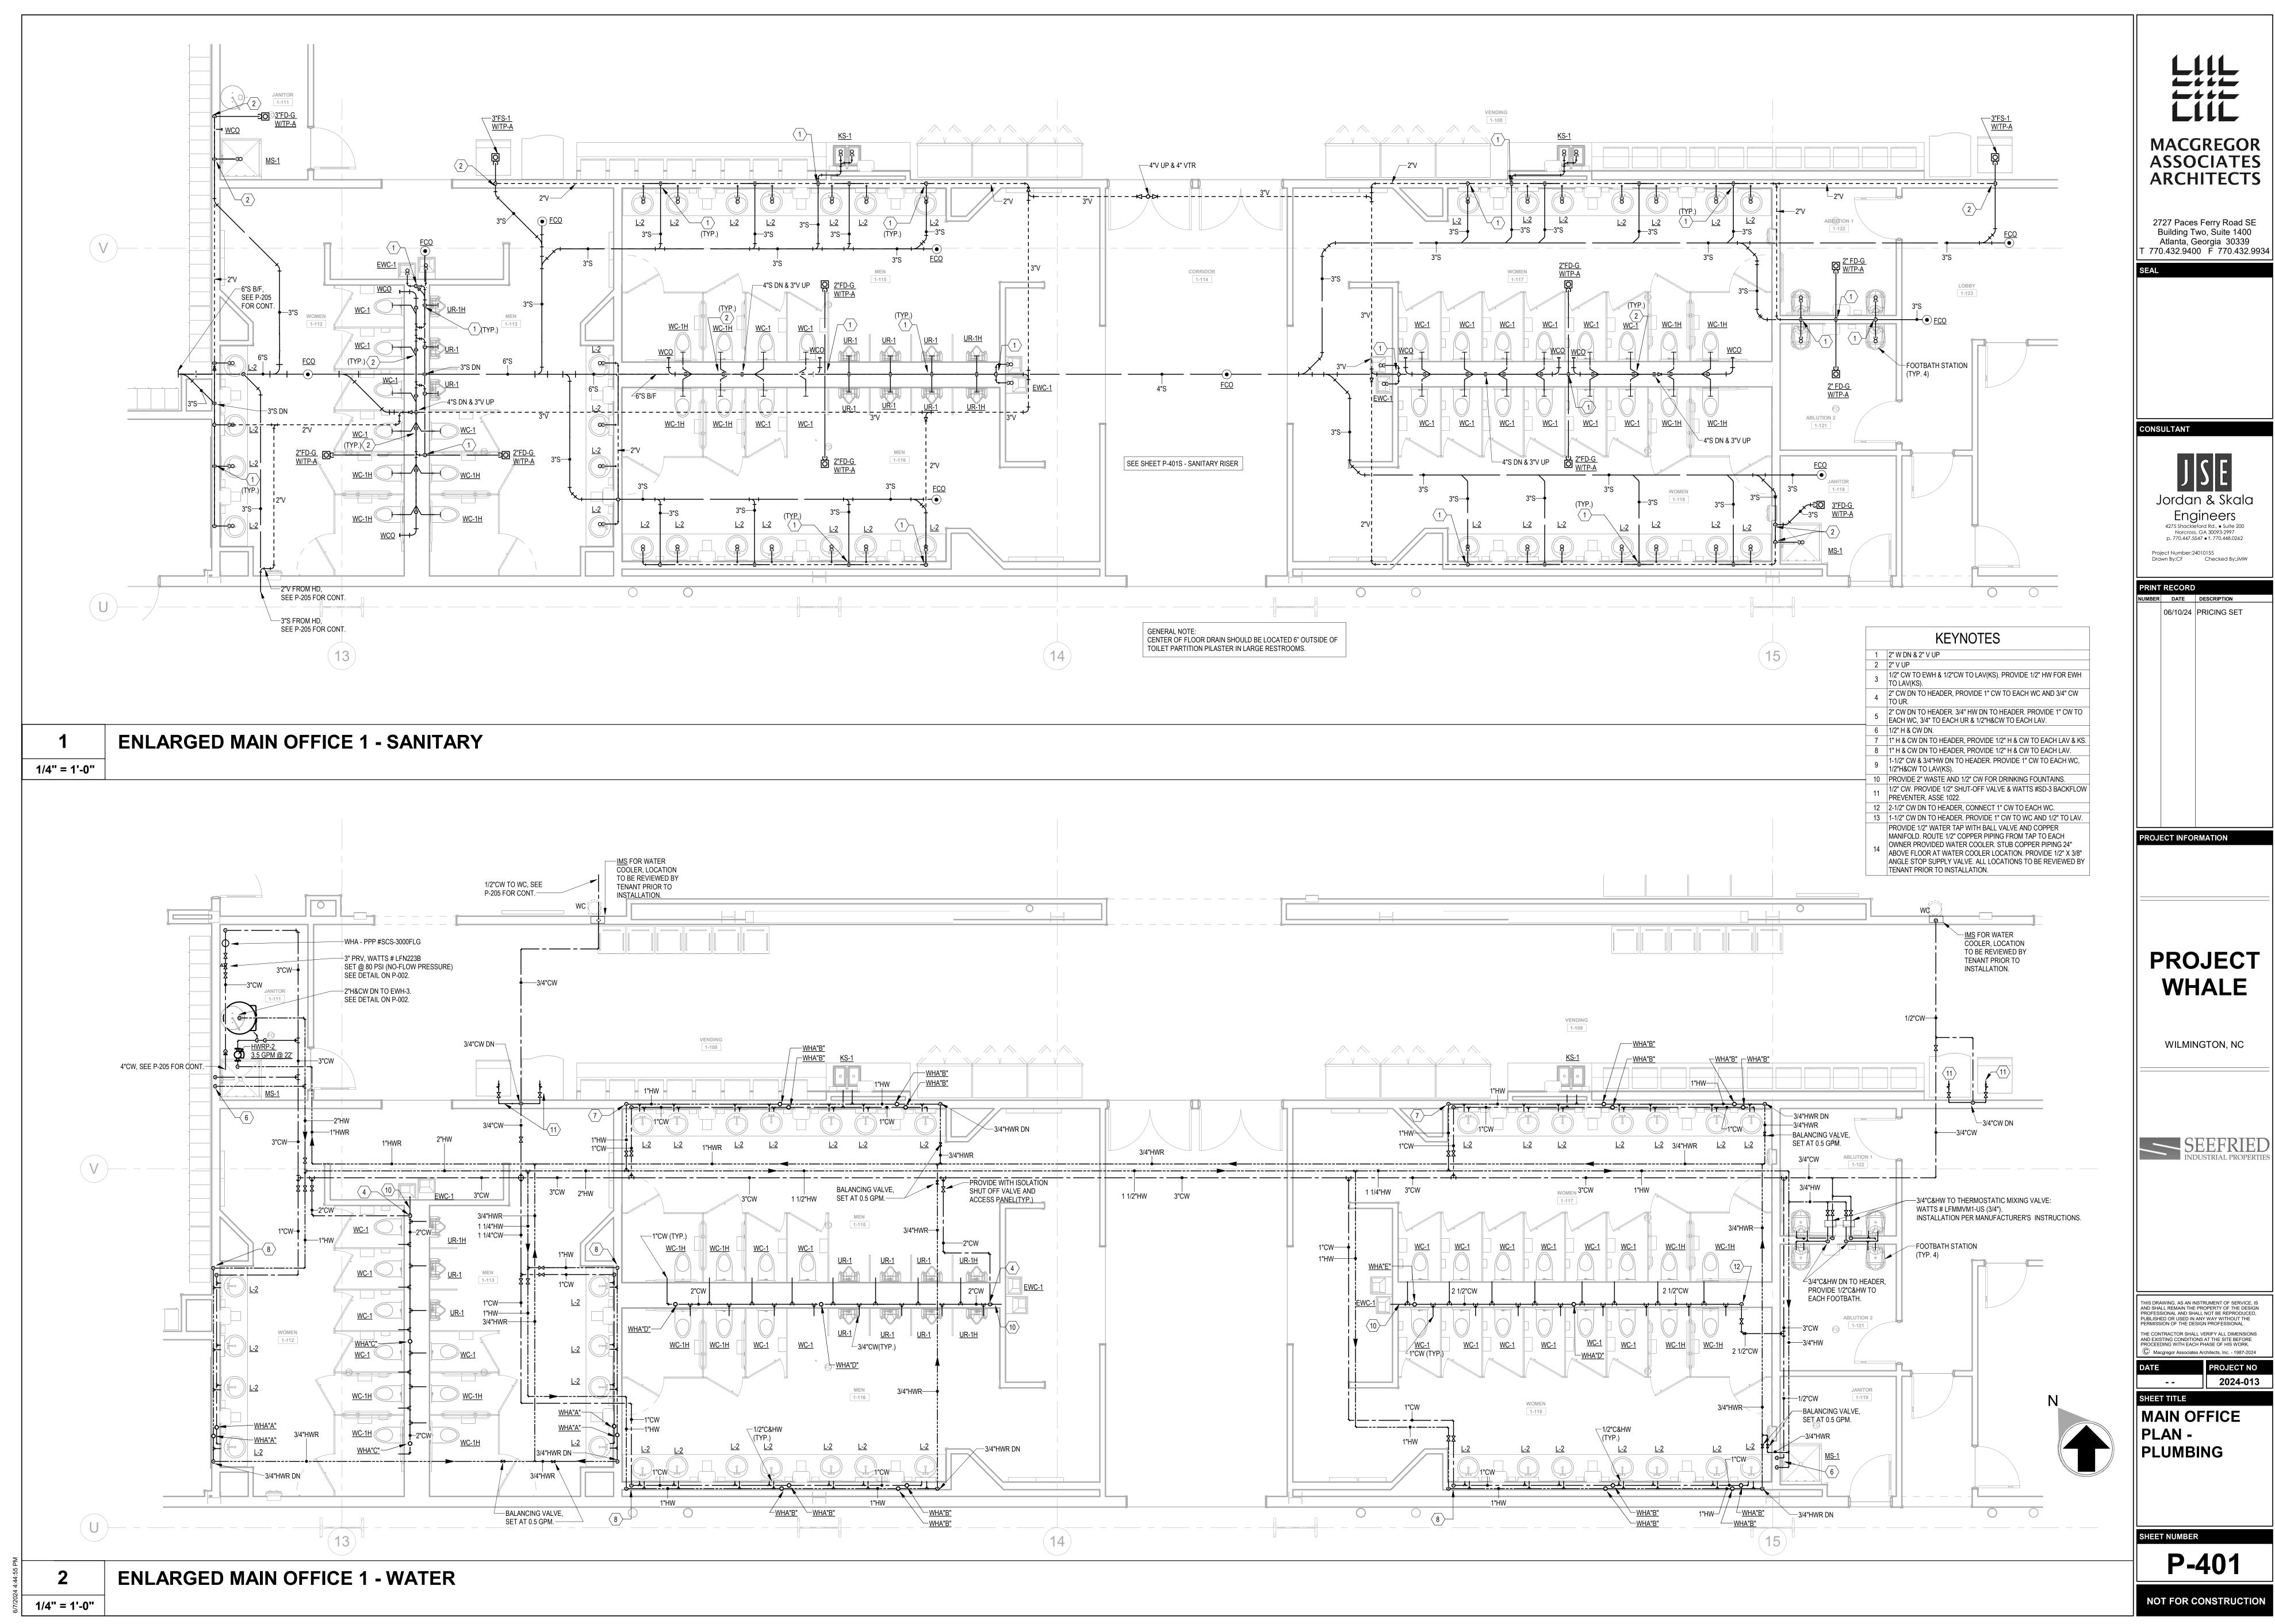

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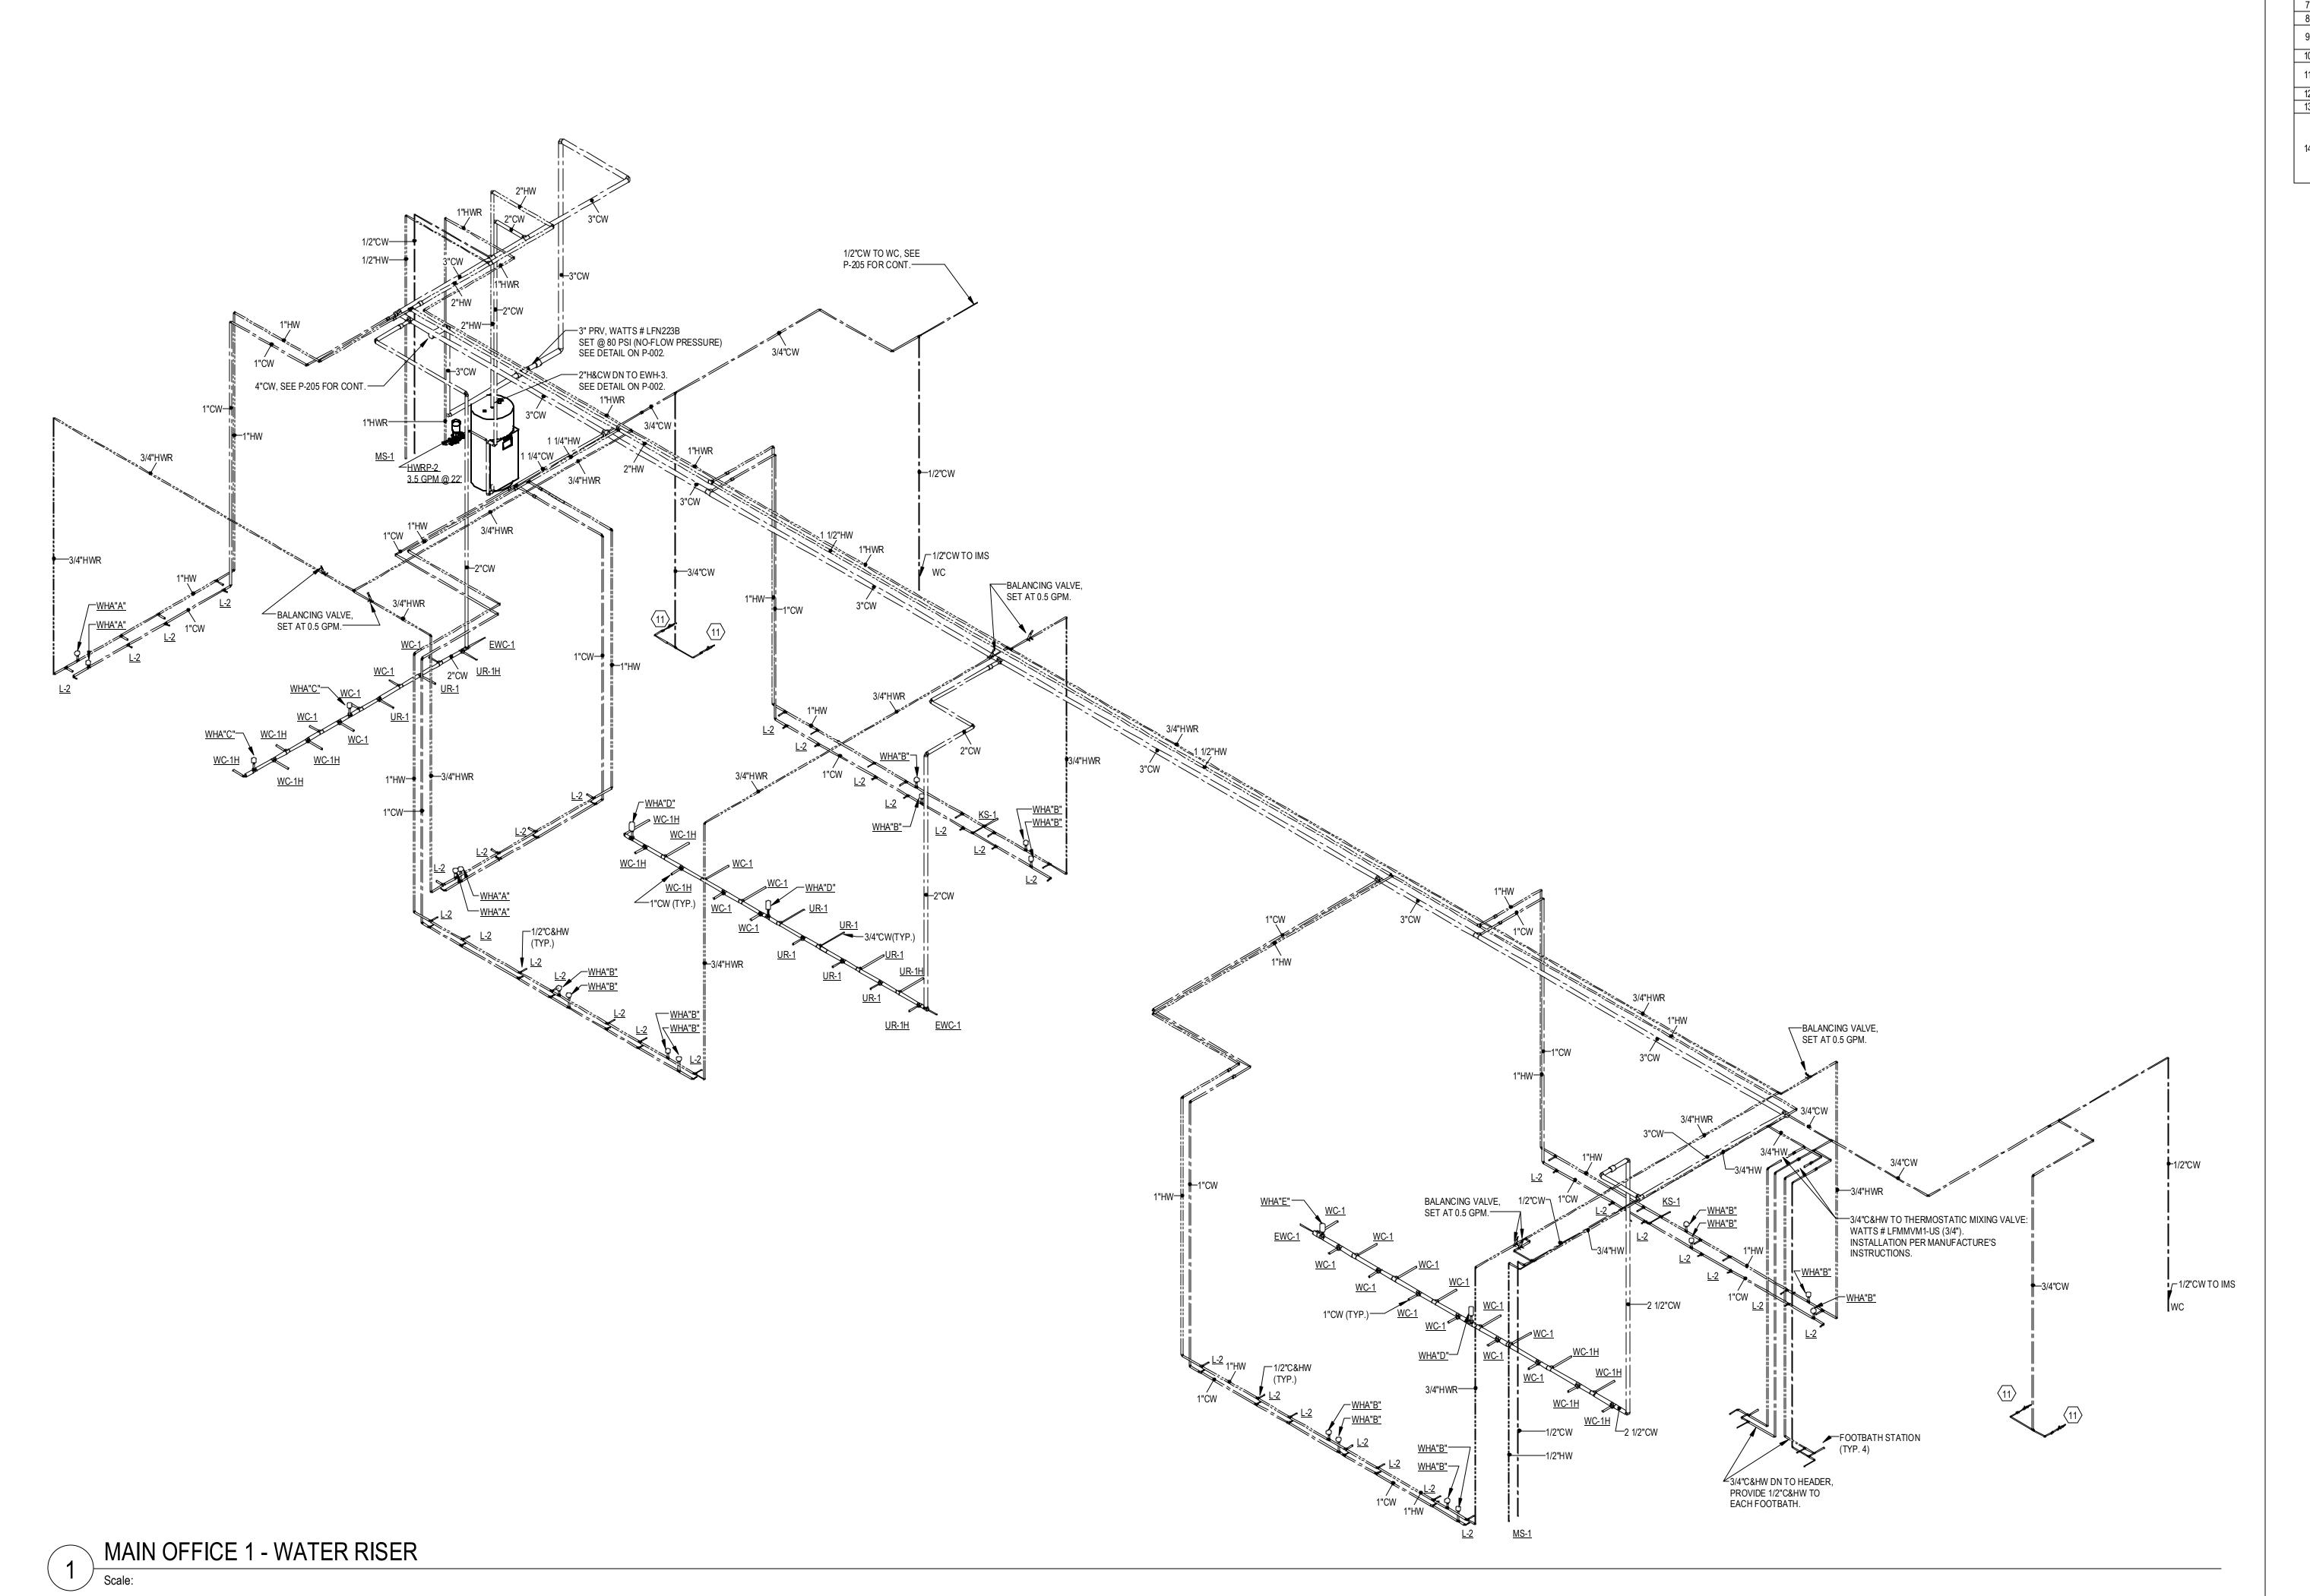
PROJECT NO 2024-013

SHEET TITLE

MAIN OFFICE -SANITARY RISER

SHEET NUMBER

P-401S



KEYNOTES

1 2" W DN & 2" V UP

3 1/2" CW TO EWH & 1/2"CW TO LAV(KS). PROVIDE 1/2" HW FOR EWH TO LAV(KS). 2" CW DN TO HEADER, PROVIDE 1" CW TO EACH WC AND 3/4" CW

5 2" CW DN TO HEADER. 3/4" HW DN TO HEADER. PROVIDE 1" CW TO EACH WC, 3/4" TO EACH UR & 1/2"H&CW TO EACH LAV. 6 1/2" H & CW DN.
7 1" H & CW DN TO HEADER, PROVIDE 1/2" H & CW TO EACH LAV & KS.

8 1" H & CW DN TO HEADER, PROVIDE 1/2" H & CW TO EACH LAV. 9 1-1/2" CW & 3/4"HW DN TO HEADER. PROVIDE 1" CW TO EACH WC, 1/2"H&CW TO LAV(KS).

10 PROVIDE 2" WASTE AND 1/2" CW FOR DRINKING FOUNTAINS.

11 1/2" CW. PROVIDE 1/2" SHUT-OFF VALVE & WATTS #SD-3 BACKFLOW PREVENTER, ASSE 1022. 12 2-1/2" CW DN TO HEADER, CONNECT 1" CW TO EACH WC.

12 | 2-1/2" CW DN TO HEADER, CONNECT 1" CW TO EACH WC.

13 | 1-1/2" CW DN TO HEADER. PROVIDE 1" CW TO WC AND 1/2" TO LAV.

PROVIDE 1/2" WATER TAP WITH BALL VALVE AND COPPER MANIFOLD. ROUTE 1/2" COPPER PIPING FROM TAP TO EACH

OWNER PROVIDED WATER COOLER. STUB COPPER PIPING 24"

ABOVE FLOOR AT WATER COOLER LOCATION. PROVIDE 1/2" X 3/8"

ANGLE STOP SUPPLY VALVE. ALL LOCATIONS TO BE REVIEWED BY TENANT PRIOR TO INSTALLATION.

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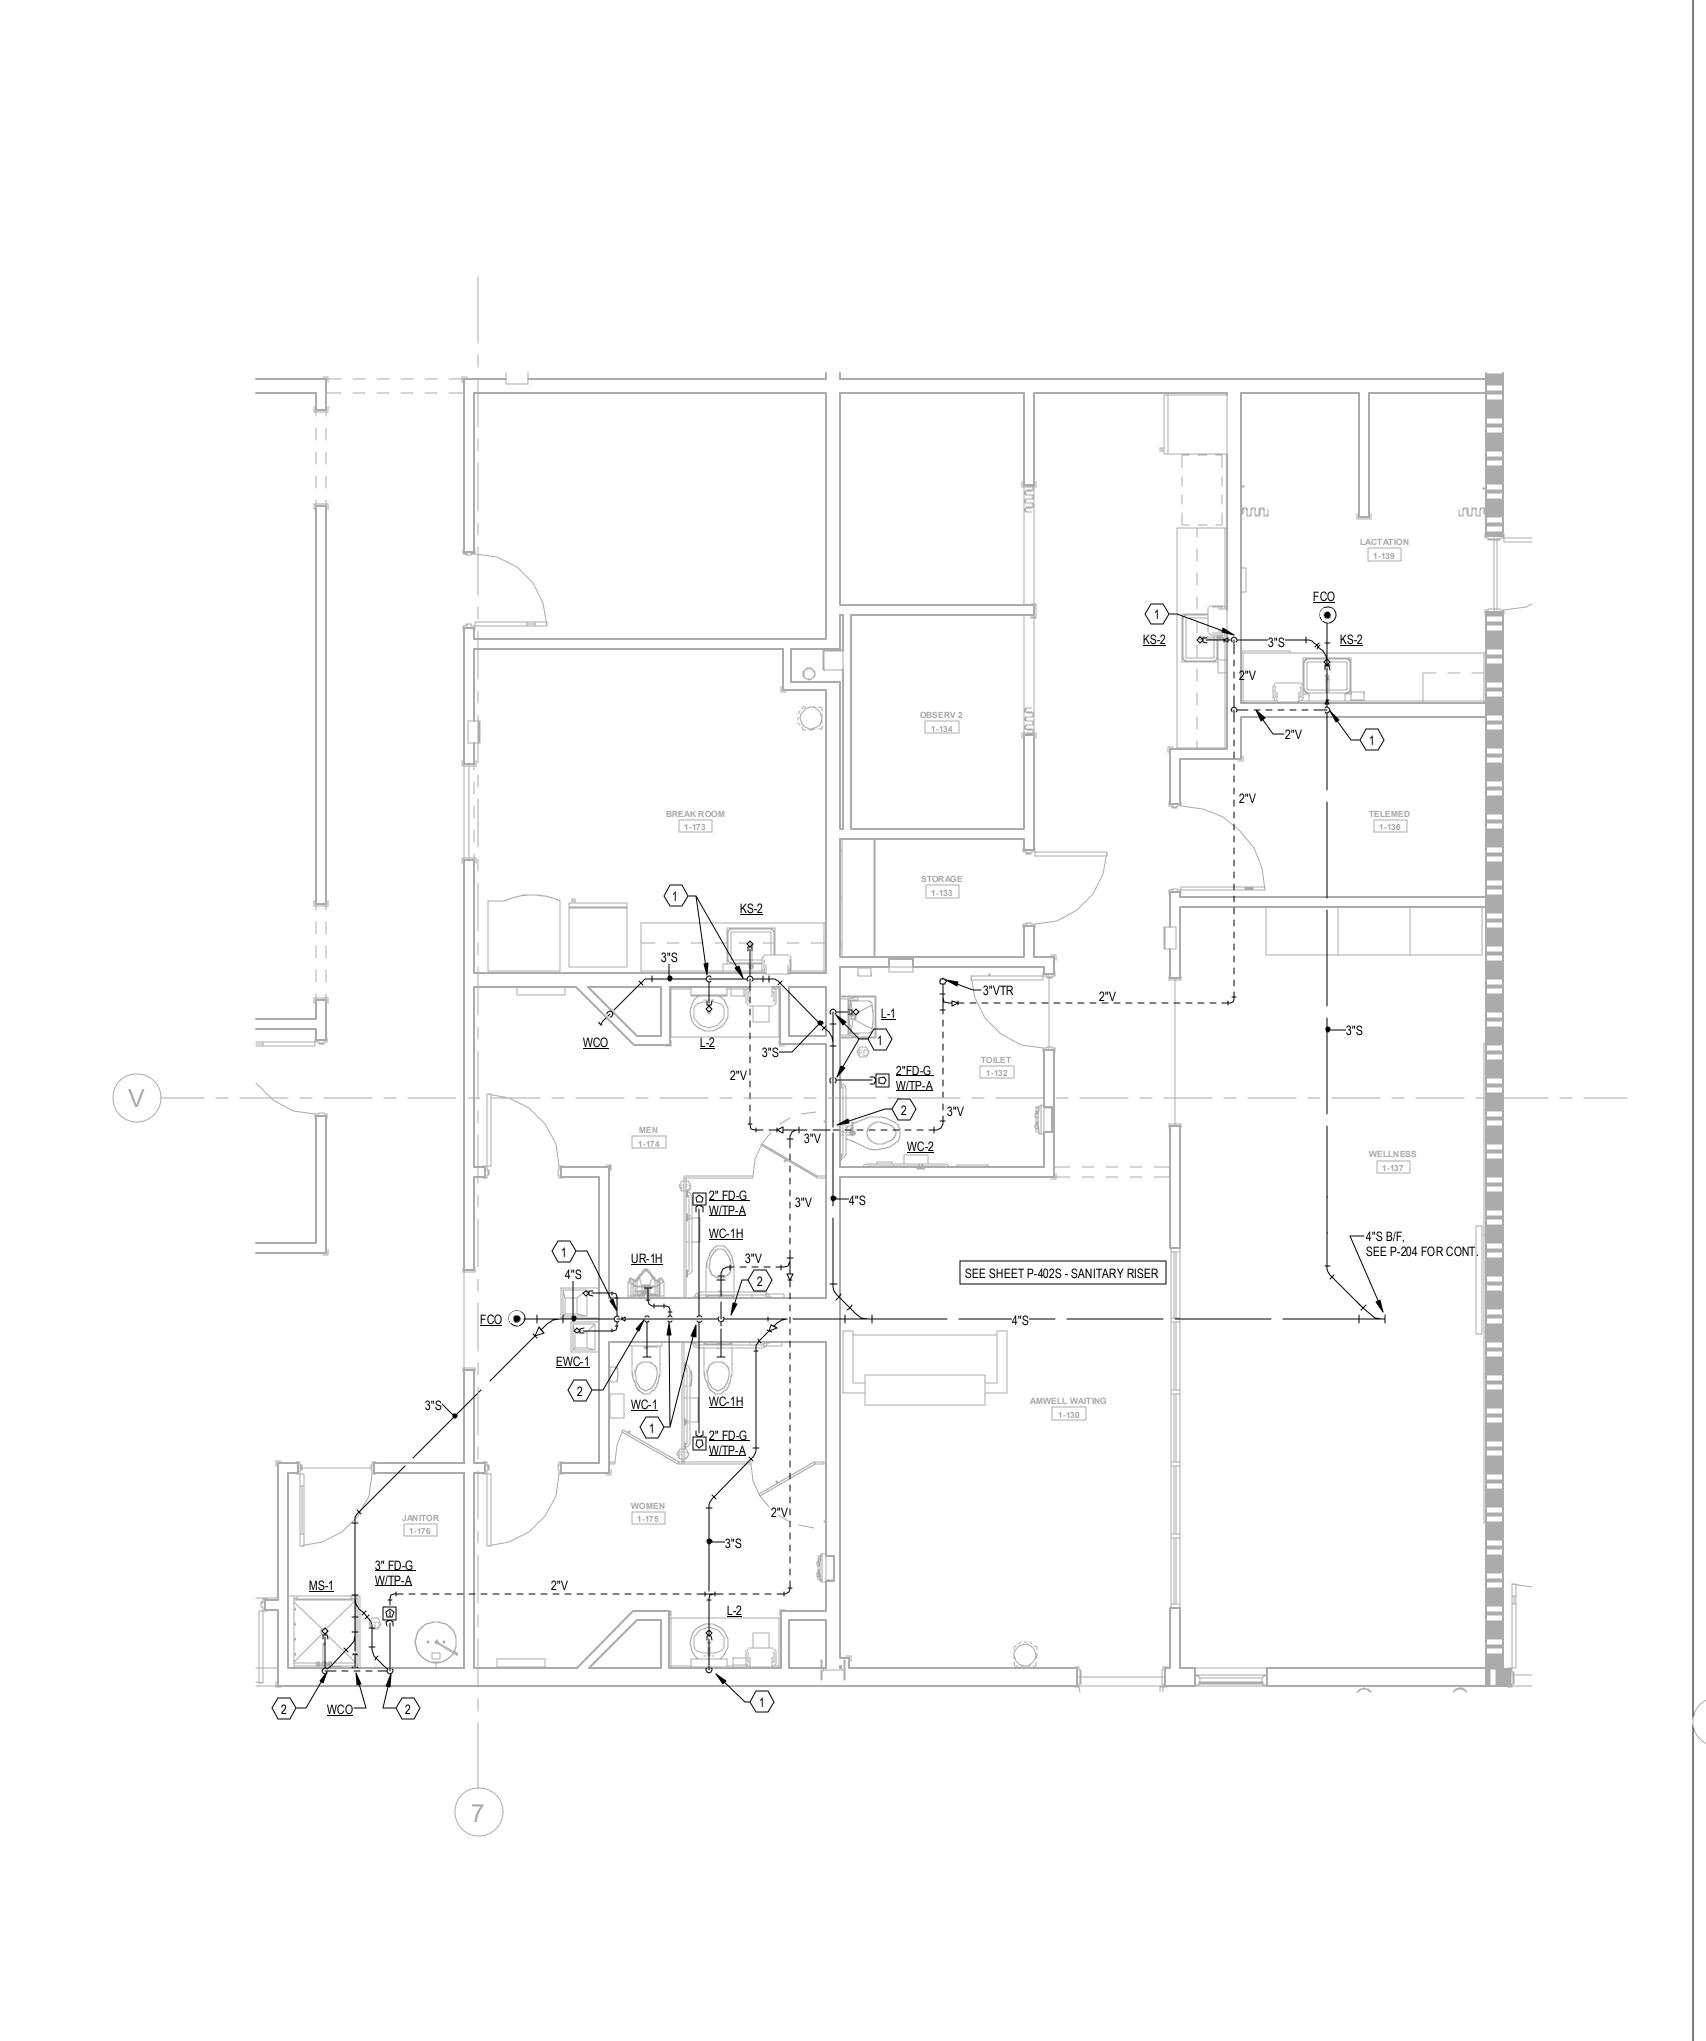
PROJECT WHALE

WILMINGTON, NC

PROJECT NO 2024-013

SHEET TITLE MAIN OFFICE -WATER RISER

P-401W



KEYNOTES

1 2" W DN & 2" V UP 3 1/2" CW TO EWH & 1/2"CW TO LAV(KS). PROVIDE 1/2" HW FOR EWH TO LAV(KS). 4 2" CW DN TO HEADER, PROVIDE 1" CW TO EACH WC AND 3/4" CW TO UR.

2" CW DN TO HEADER. 3/4" HW DN TO HEADER. PROVIDE 1" CW TO EACH WC, 3/4" TO EACH UR & 1/2"H&CW TO EACH LAV.

6 1/2" H & CW DN.
7 1" H & CW DN TO HEADER, PROVIDE 1/2" H & CW TO EACH LAV & KS. 8 1" H & CW DN TO HEADER, PROVIDE 1/2" H & CW TO EACH LAV. 9 1-1/2" CW & 3/4"HW DN TO HEADER. PROVIDE 1" CW TO EACH WC, 1/2"H&CW TO LAV(KS).

10 PROVIDE 2" WASTE AND 1/2" CW FOR DRINKING FOUNTAINS.

11 1/2" CW. PROVIDE 1/2" SHUT-OFF VALVE & WATTS #SD-3 BACKFLOW PREVENTER, ASSE 1022. 12 2-1/2" CW DN TO HEADER, CONNECT 1" CW TO EACH WC.

13 1-1/2" CW DN TO HEADER. PROVIDE 1" CW TO WC AND 1/2" TO LAV.
PROVIDE 1/2" WATER TAP WITH BALL VALVE AND COPPER MANIFOLD. ROUTE 1/2" COPPER PIPING FROM TAP TO EACH OWNER PROVIDED WATER COOLER. STUB COPPER PIPING 24" ABOVE FLOOR AT WATER COOLER LOCATION. PROVIDE 1/2" X 3/8" ANGLE STOP SUPPLY VALVE. ALL LOCATIONS TO BE REVIEWED BY TENANT PRIOR TO INSTALLATION.

TOILET PARTITION PILASTER IN SMALL RESTROOMS.

CENTER OF FLOOR DRAIN SHOULD BE LOCATED 6" INSIDE

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PROJECT NO 2024-013 SHEET TITLE

MAIN OFFICE PLAN -SANITARY

P-402A

NOT FOR CONSTRUCTION

ENLARGED CAREER CHOICE CLASSROOM - SANITARY

1/4" = 1'-0"

CAREER CHOICE CLASSROOM
1-104

f ---- 3"V

2" HUB DRAIN W/TP-A UNDER KS-2

DISCHARGE UP

DISCHARGE A/C


/--4"HD W/TP-A

4"S B/F, SEE P-204 FOR CONT.

SINK FOR CONDENSATE

FROM ACS, COORDINATE WITH MECHANICAL.

SPILL OVER H.D.

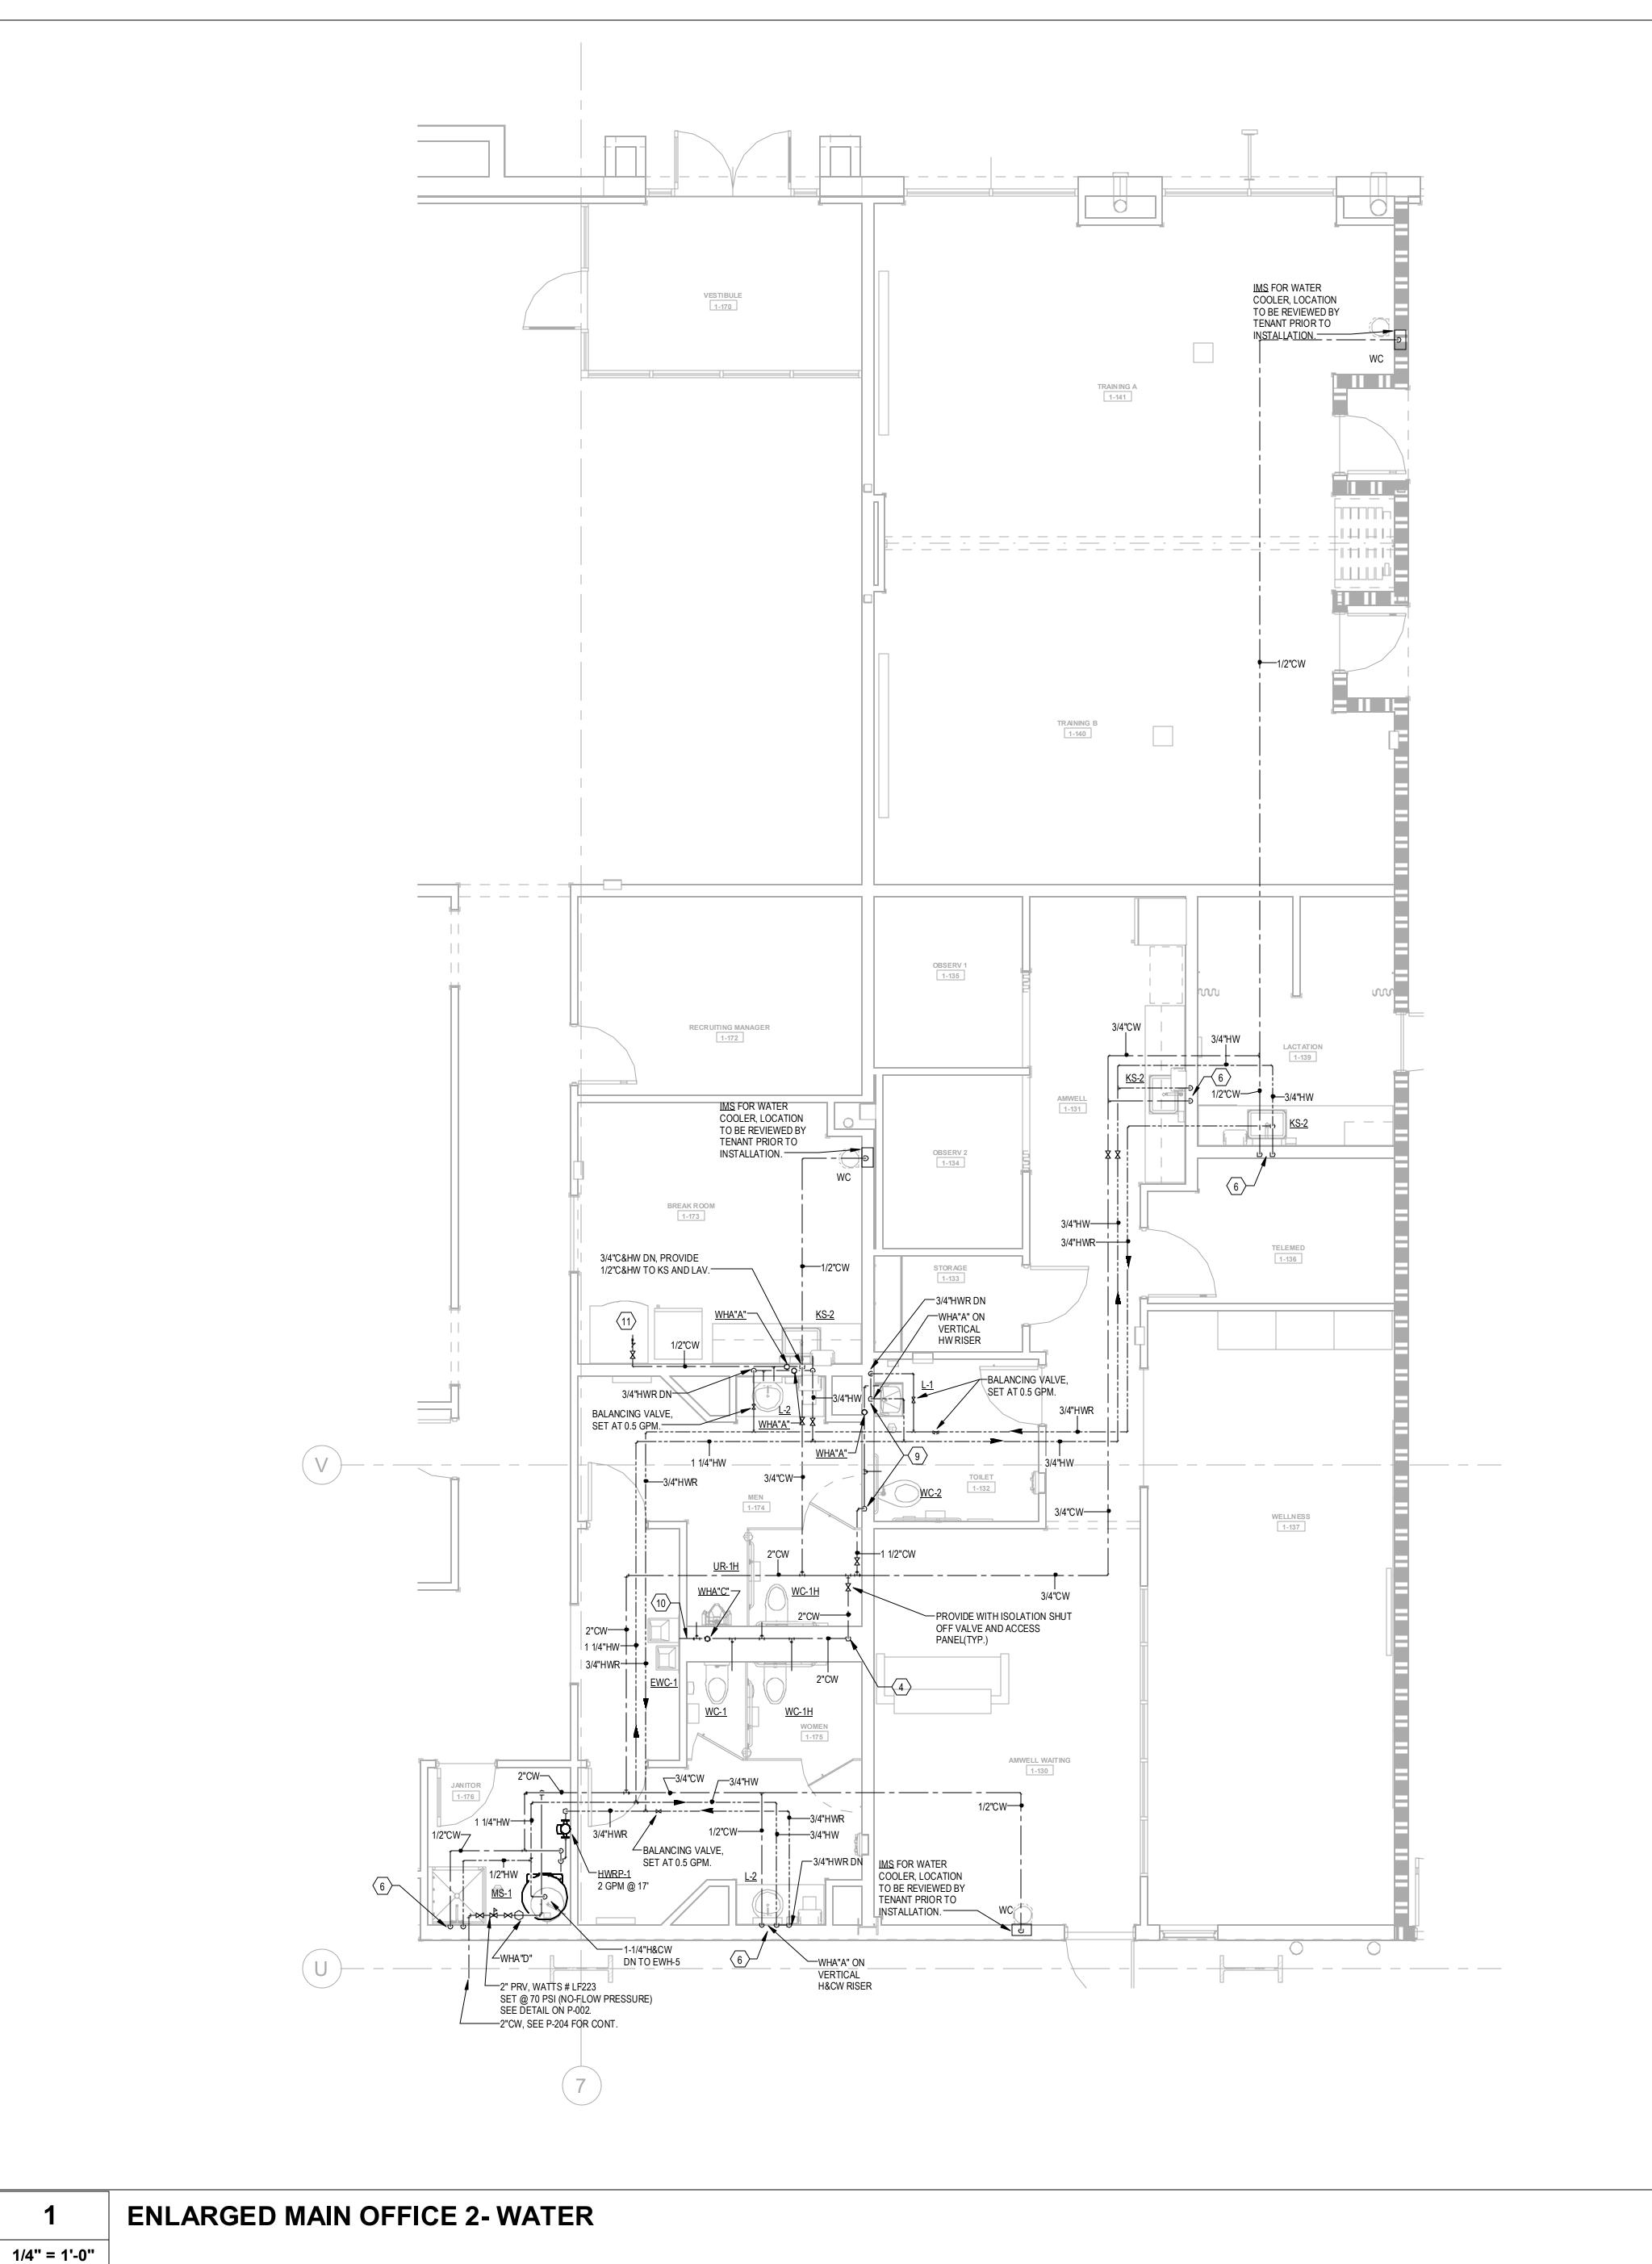

KEYNOTES

- 1 2" W DN & 2" V UP
- 1/2" CW TO EWH & 1/2"CW TO LAV(KS). PROVIDE 1/2" HW FOR EWH
- 4 2" CW DN TO HEADER, PROVIDE 1" CW TO EACH WC AND 3/4" CW
- 5 2" CW DN TO HEADER. 3/4" HW DN TO HEADER. PROVIDE 1" CW TO EACH WC, 3/4" TO EACH UR & 1/2"H&CW TO EACH LAV.
- 6 1/2" H & CW DN. 7 1" H & CW DN TO HEADER, PROVIDE 1/2" H & CW TO EACH LAV & KS.
- 8 1" H & CW DN TO HEADER, PROVIDE 1/2" H & CW TO EACH LAV.
- 9 1-1/2" CW & 3/4"HW DN TO HEADER. PROVIDE 1" CW TO EACH WC, 1/2"H&CW TO LAV(KS). 10 PROVIDE 2" WASTE AND 1/2" CW FOR DRINKING FOUNTAINS.
- 1/2" CW. PROVIDE 1/2" SHUT-OFF VALVE & WATTS #SD-3 BACKFLOW PREVENTER, ASSE 1022.
- 12 2-1/2" CW DN TO HEADER, CONNECT 1" CW TO EACH WC. 13 1-1/2" CW DN TO HEADER. PROVIDE 1" CW TO WC AND 1/2" TO LAV.
- PROVIDE 1/2" WATER TAP WITH BALL VALVE AND COPPER MANIFOLD. ROUTE 1/2" COPPER PIPING FROM TAP TO EACH
- OWNER PROVIDED WATER COOLER. STUB COPPER PIPING 24" ABOVE FLOOR AT WATER COOLER LOCATION. PROVIDE 1/2" X 3/8" ANGLE STOP SUPPLY VALVE. ALL LOCATIONS TO BE REVIEWED BY TENANT PRIOR TO INSTALLATION.

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PROJECT INFORMATION

PROJECT WHALE

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2024-013 SHEET TITLE

MAIN OFFICE PLAN - WATER

P-402B

NOT FOR CONSTRUCTION

ENLARGED CAREER CHOICE CLASSROOM - WATER

----3/4"CW TO NFHB-R, SEE P-204 FOR CONT.

—3/4" PRV, WATTS # LF223


SEE P-204 FOR CONT.

SET @ 60 PSI (NO-FLOW PRESSURE) SEE DETAIL ON P-002.

-IMS FOR WATER COOLER, LOCATION

TO BE REVIEWED BY TENANT PRIOR TO INSTALLATION.

1/4" = 1'-0"

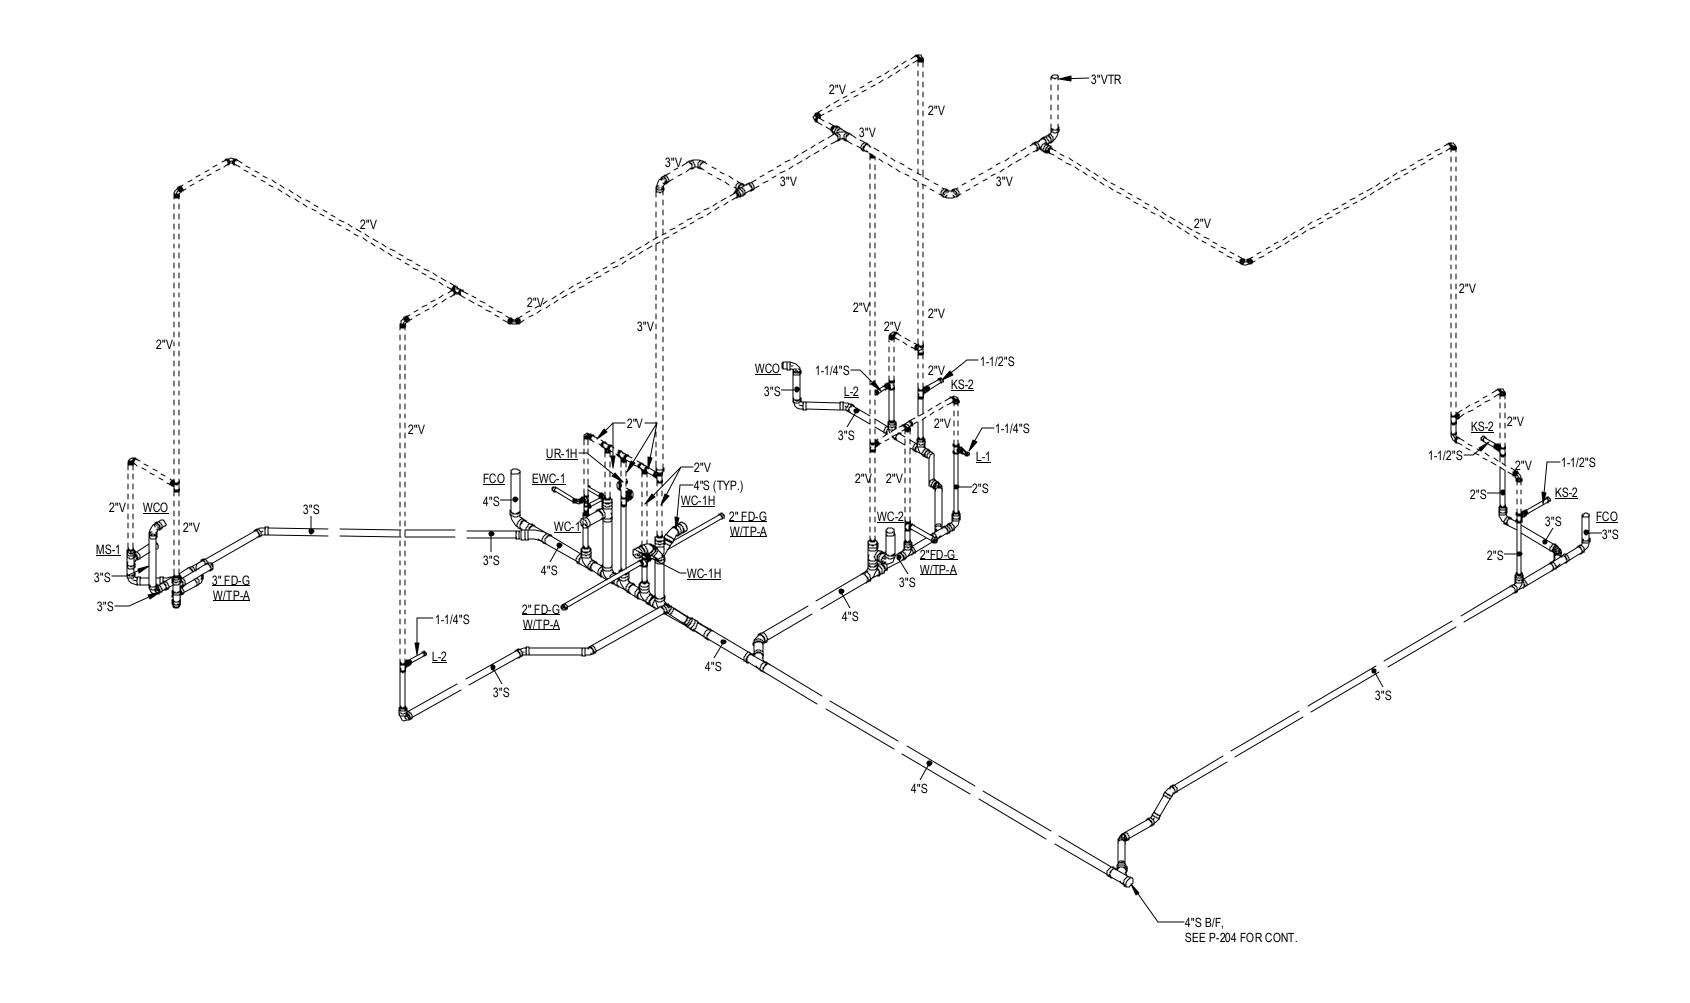

MAIN OFFICE 2 - SANITARY RISER

Scale:

LILL

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DATE
PROJECT NO
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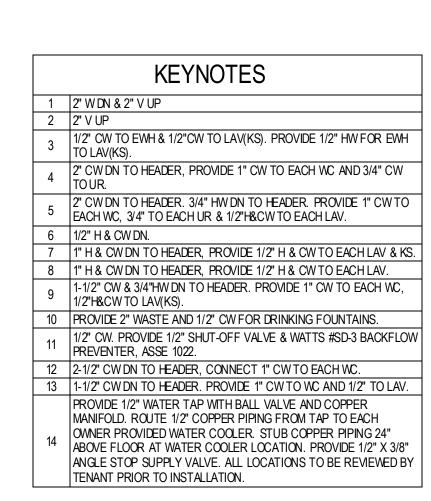
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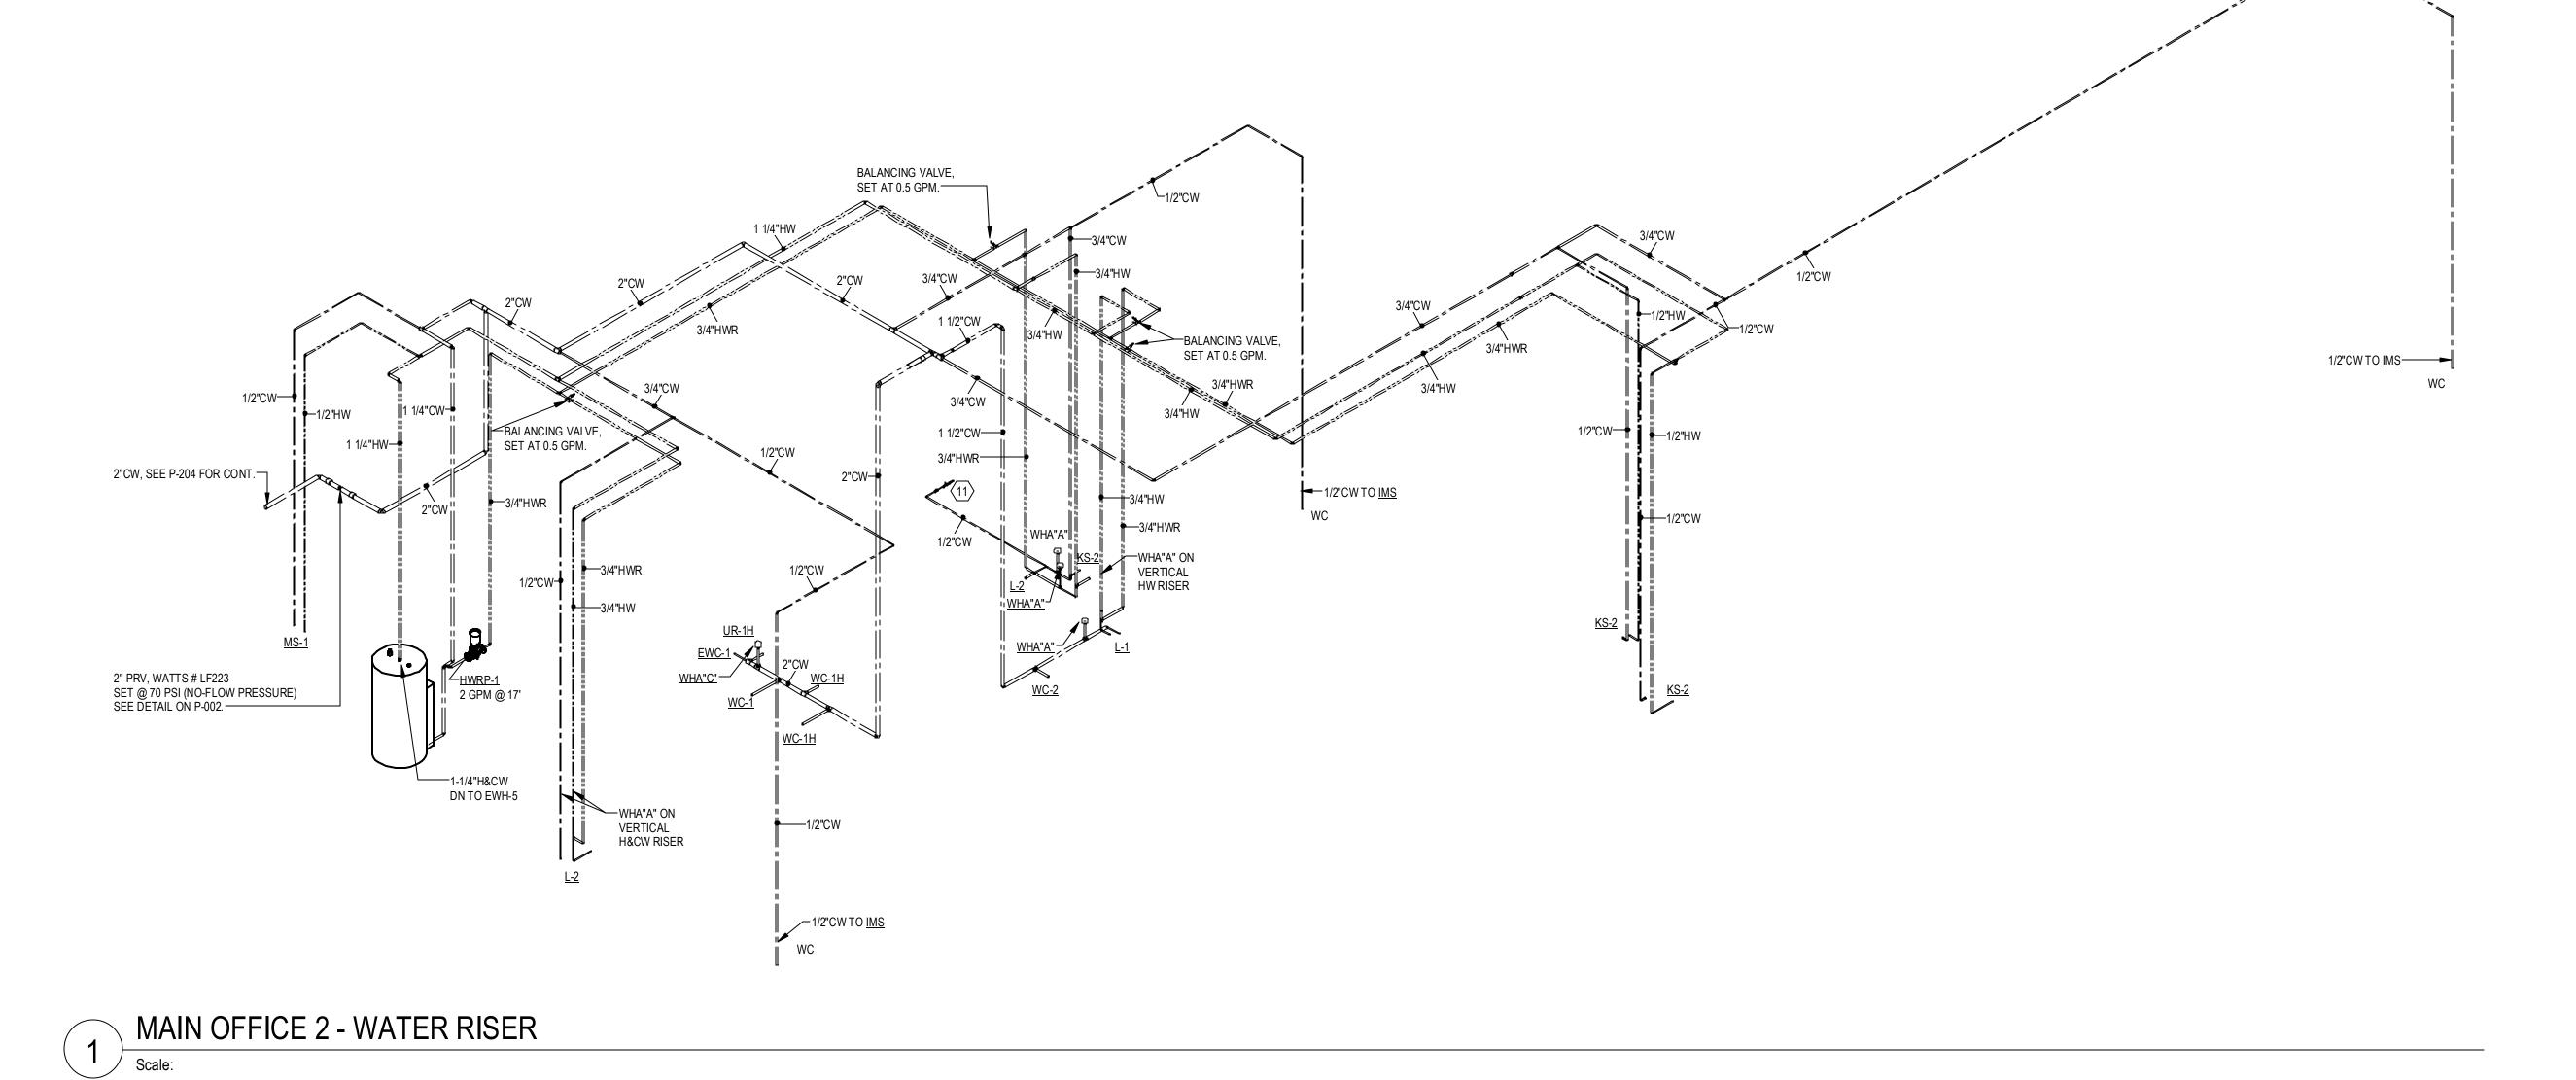
MAIN OFFICE


MAIN OFFICE -SANITARY RISER

SHEET NUMBER

P-402S





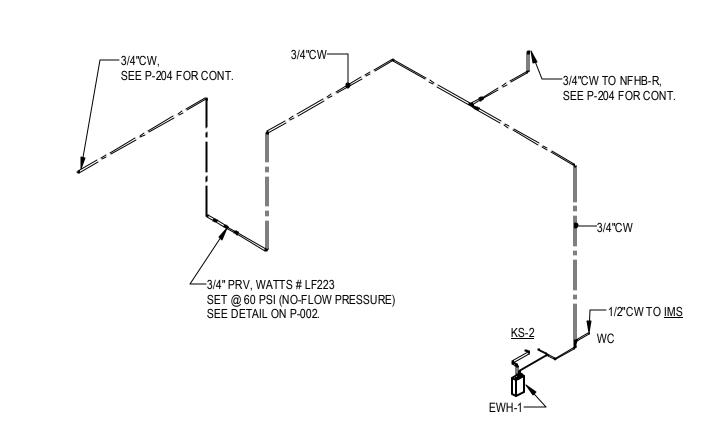

CAREER CHOICE CLASSROOM - WATER RISER

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THE CONTRACTOR SHALL VERIFY ALL DIMENSIONS AND EXISTING CONDITIONS AT THE SITE BEFORE PROCEEDING WITH EACH PHASE OF HIS WORK.


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DATE
PROJECT NO
2024-013

SHEET TITLE

MAIN OFFICE WATER RISER

P-402W

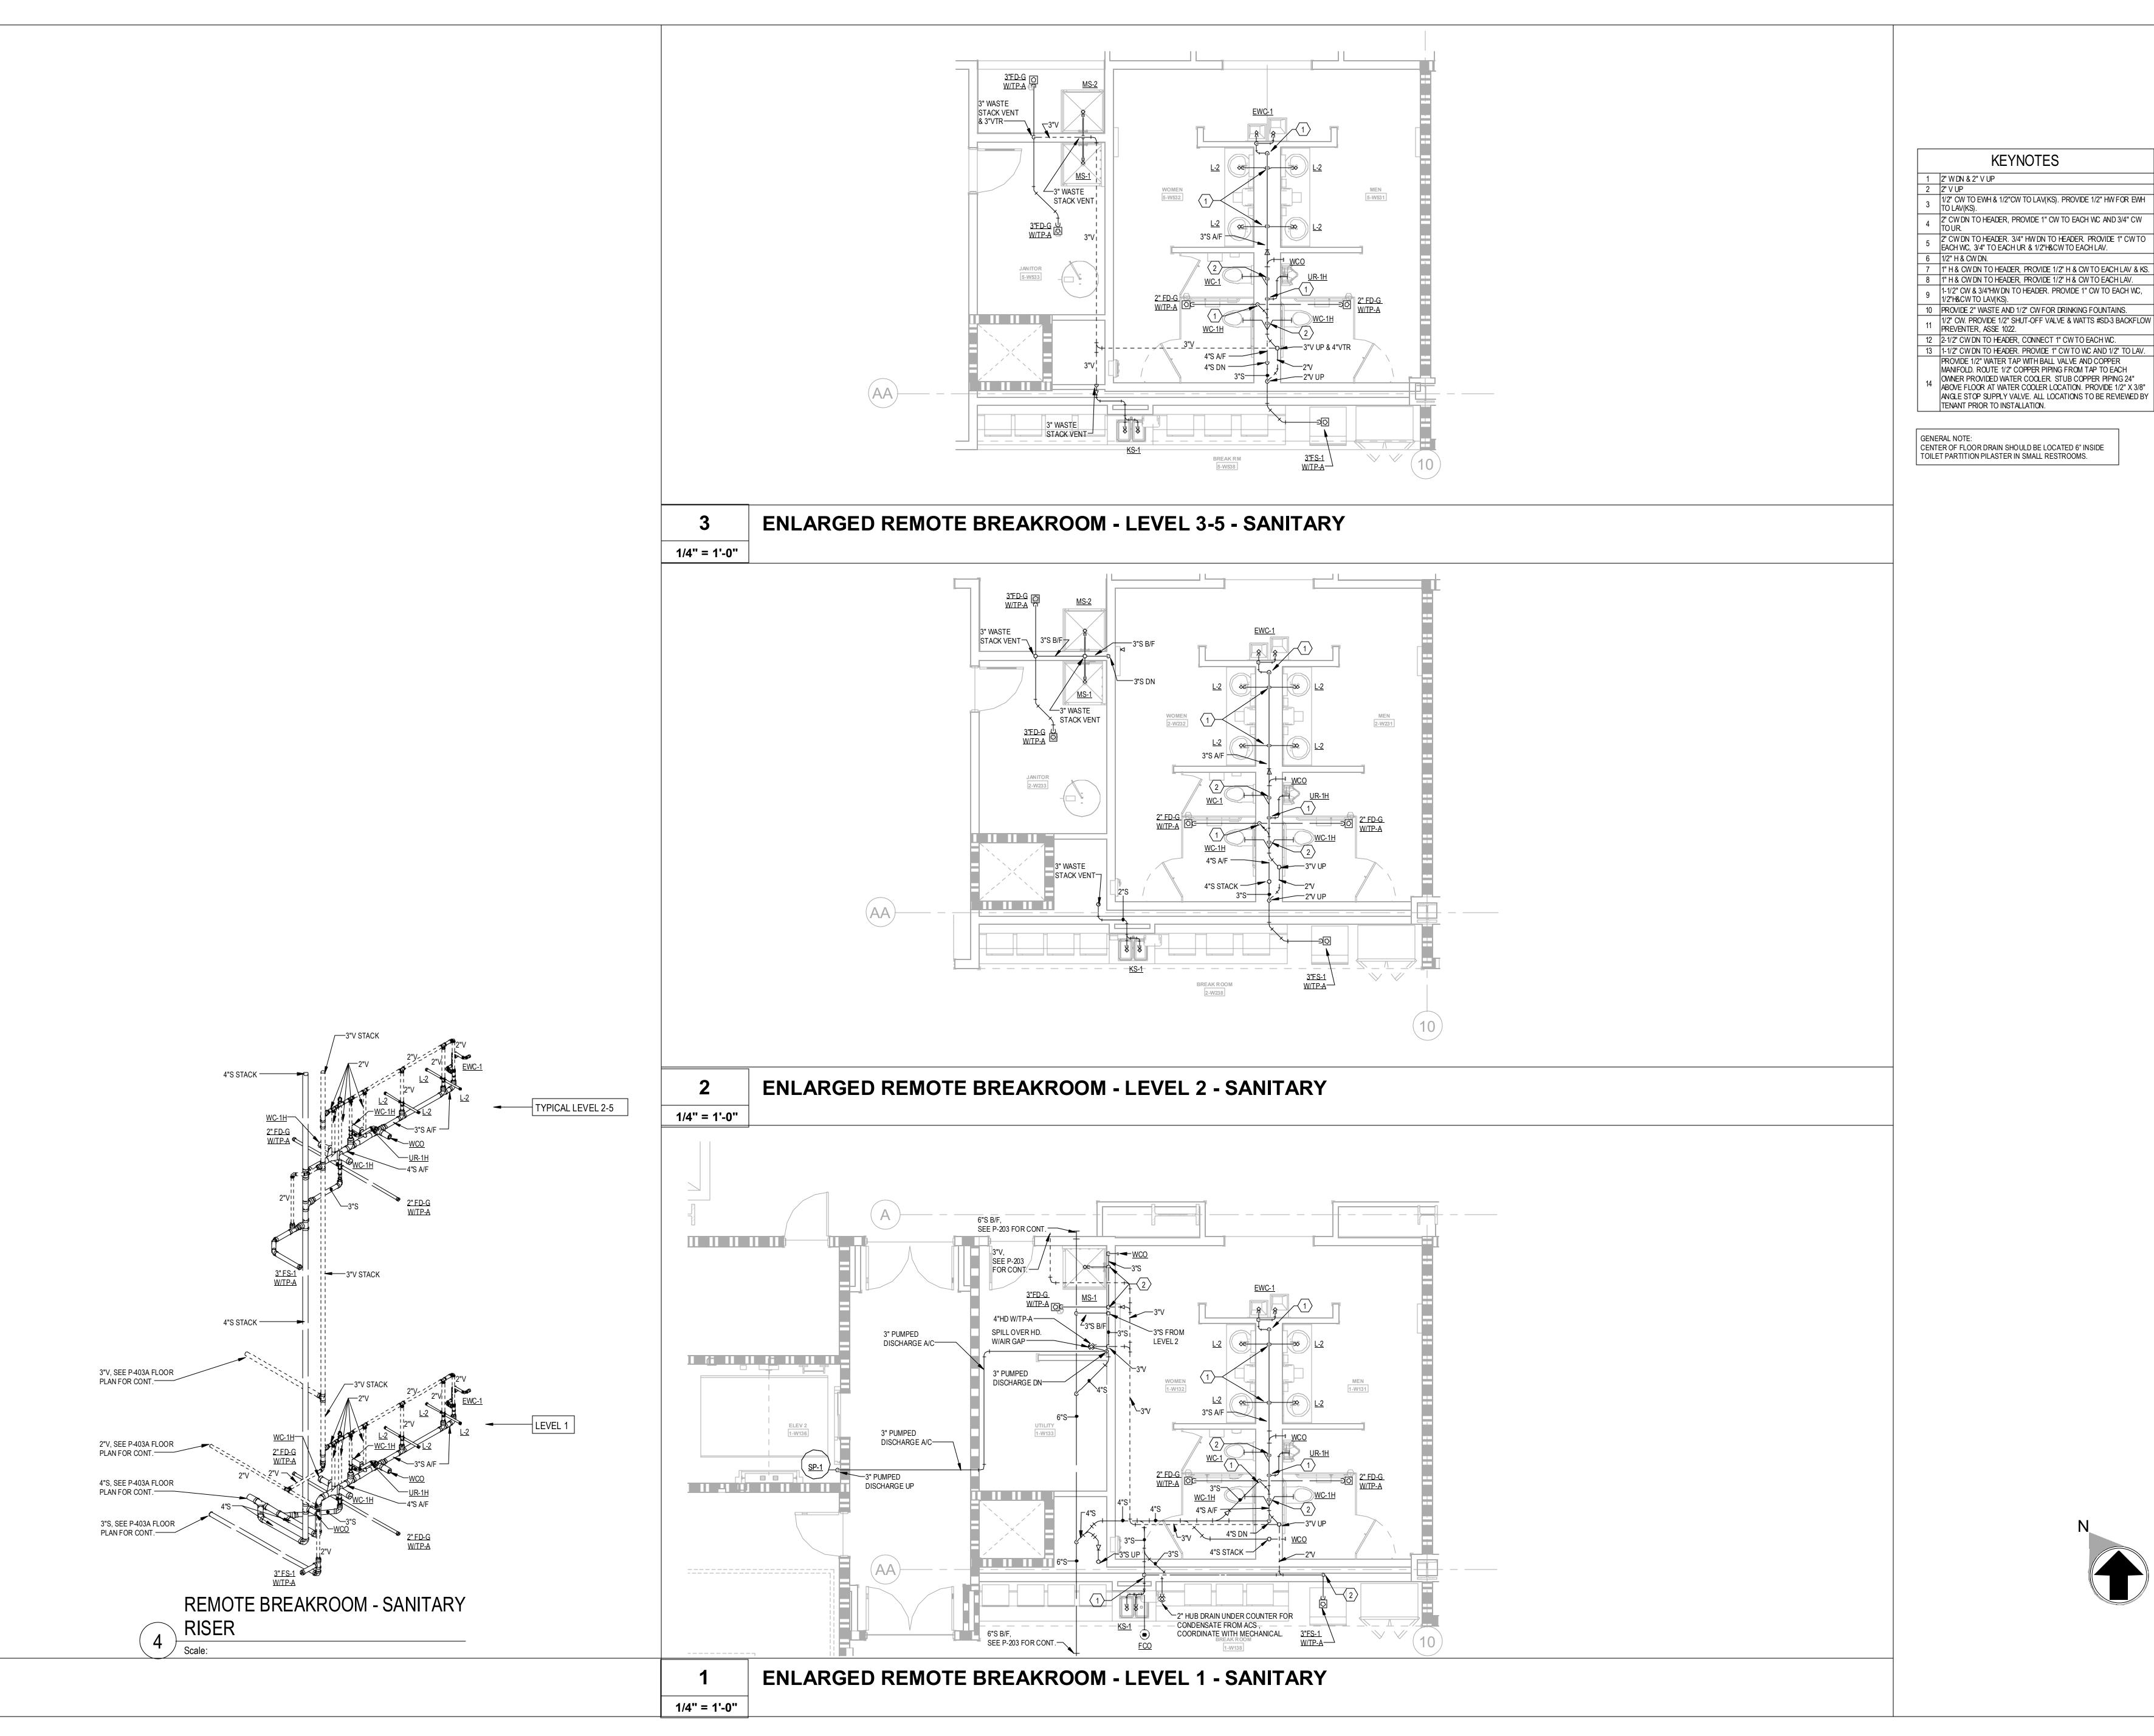

- 1/2" CW TO EWH & 1/2"CW TO LAV(KS). PROVIDE 1/2" HW FOR EWH
- 4 2" CW DN TO HEADER, PROVIDE 1" CW TO EACH WC AND 3/4" CW TO UR.
- 5 2" CW DN TO HEADER. 3/4" HW DN TO HEADER. PROVIDE 1" CW TO EACH WC, 3/4" TO EACH UR & 1/2"H&CW TO EACH LAV.
- 7 1" H & CW DN TO HEADER, PROVIDE 1/2" H & CW TO EACH LAV & KS. 8 1" H & CW DN TO HEADER, PROVIDE 1/2" H & CW TO EACH LAV.
- 9 1-1/2" CW & 3/4"HW DN TO HEADER. PROVIDE 1" CW TO EACH WC, 1/2"H&CW TO LAV(KS).
- 10 PROVIDE 2" WASTE AND 1/2" CW FOR DRINKING FOUNTAINS.
- 13 1-1/2" CW DN TO HEADER. PROVIDE 1" CW TO WC AND 1/2" TO LAV.
- PROVIDE 1/2" WATER TAP WITH BALL VALVE AND COPPER MANIFOLD. ROUTE 1/2" COPPER PIPING FROM TAP TO EACH OWNER PROVIDED WATER COOLER. STUB COPPER PIPING 24" ABOVE FLOOR AT WATER COOLER LOCATION. PROVIDE 1/2" X 3/8"

CENTER OF FLOOR DRAIN SHOULD BE LOCATED 6" INSIDE

MACGREGOR ASSOCIATES **ARCHITECTS**

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PROJECT INFORMATION

PROJECT WHALE


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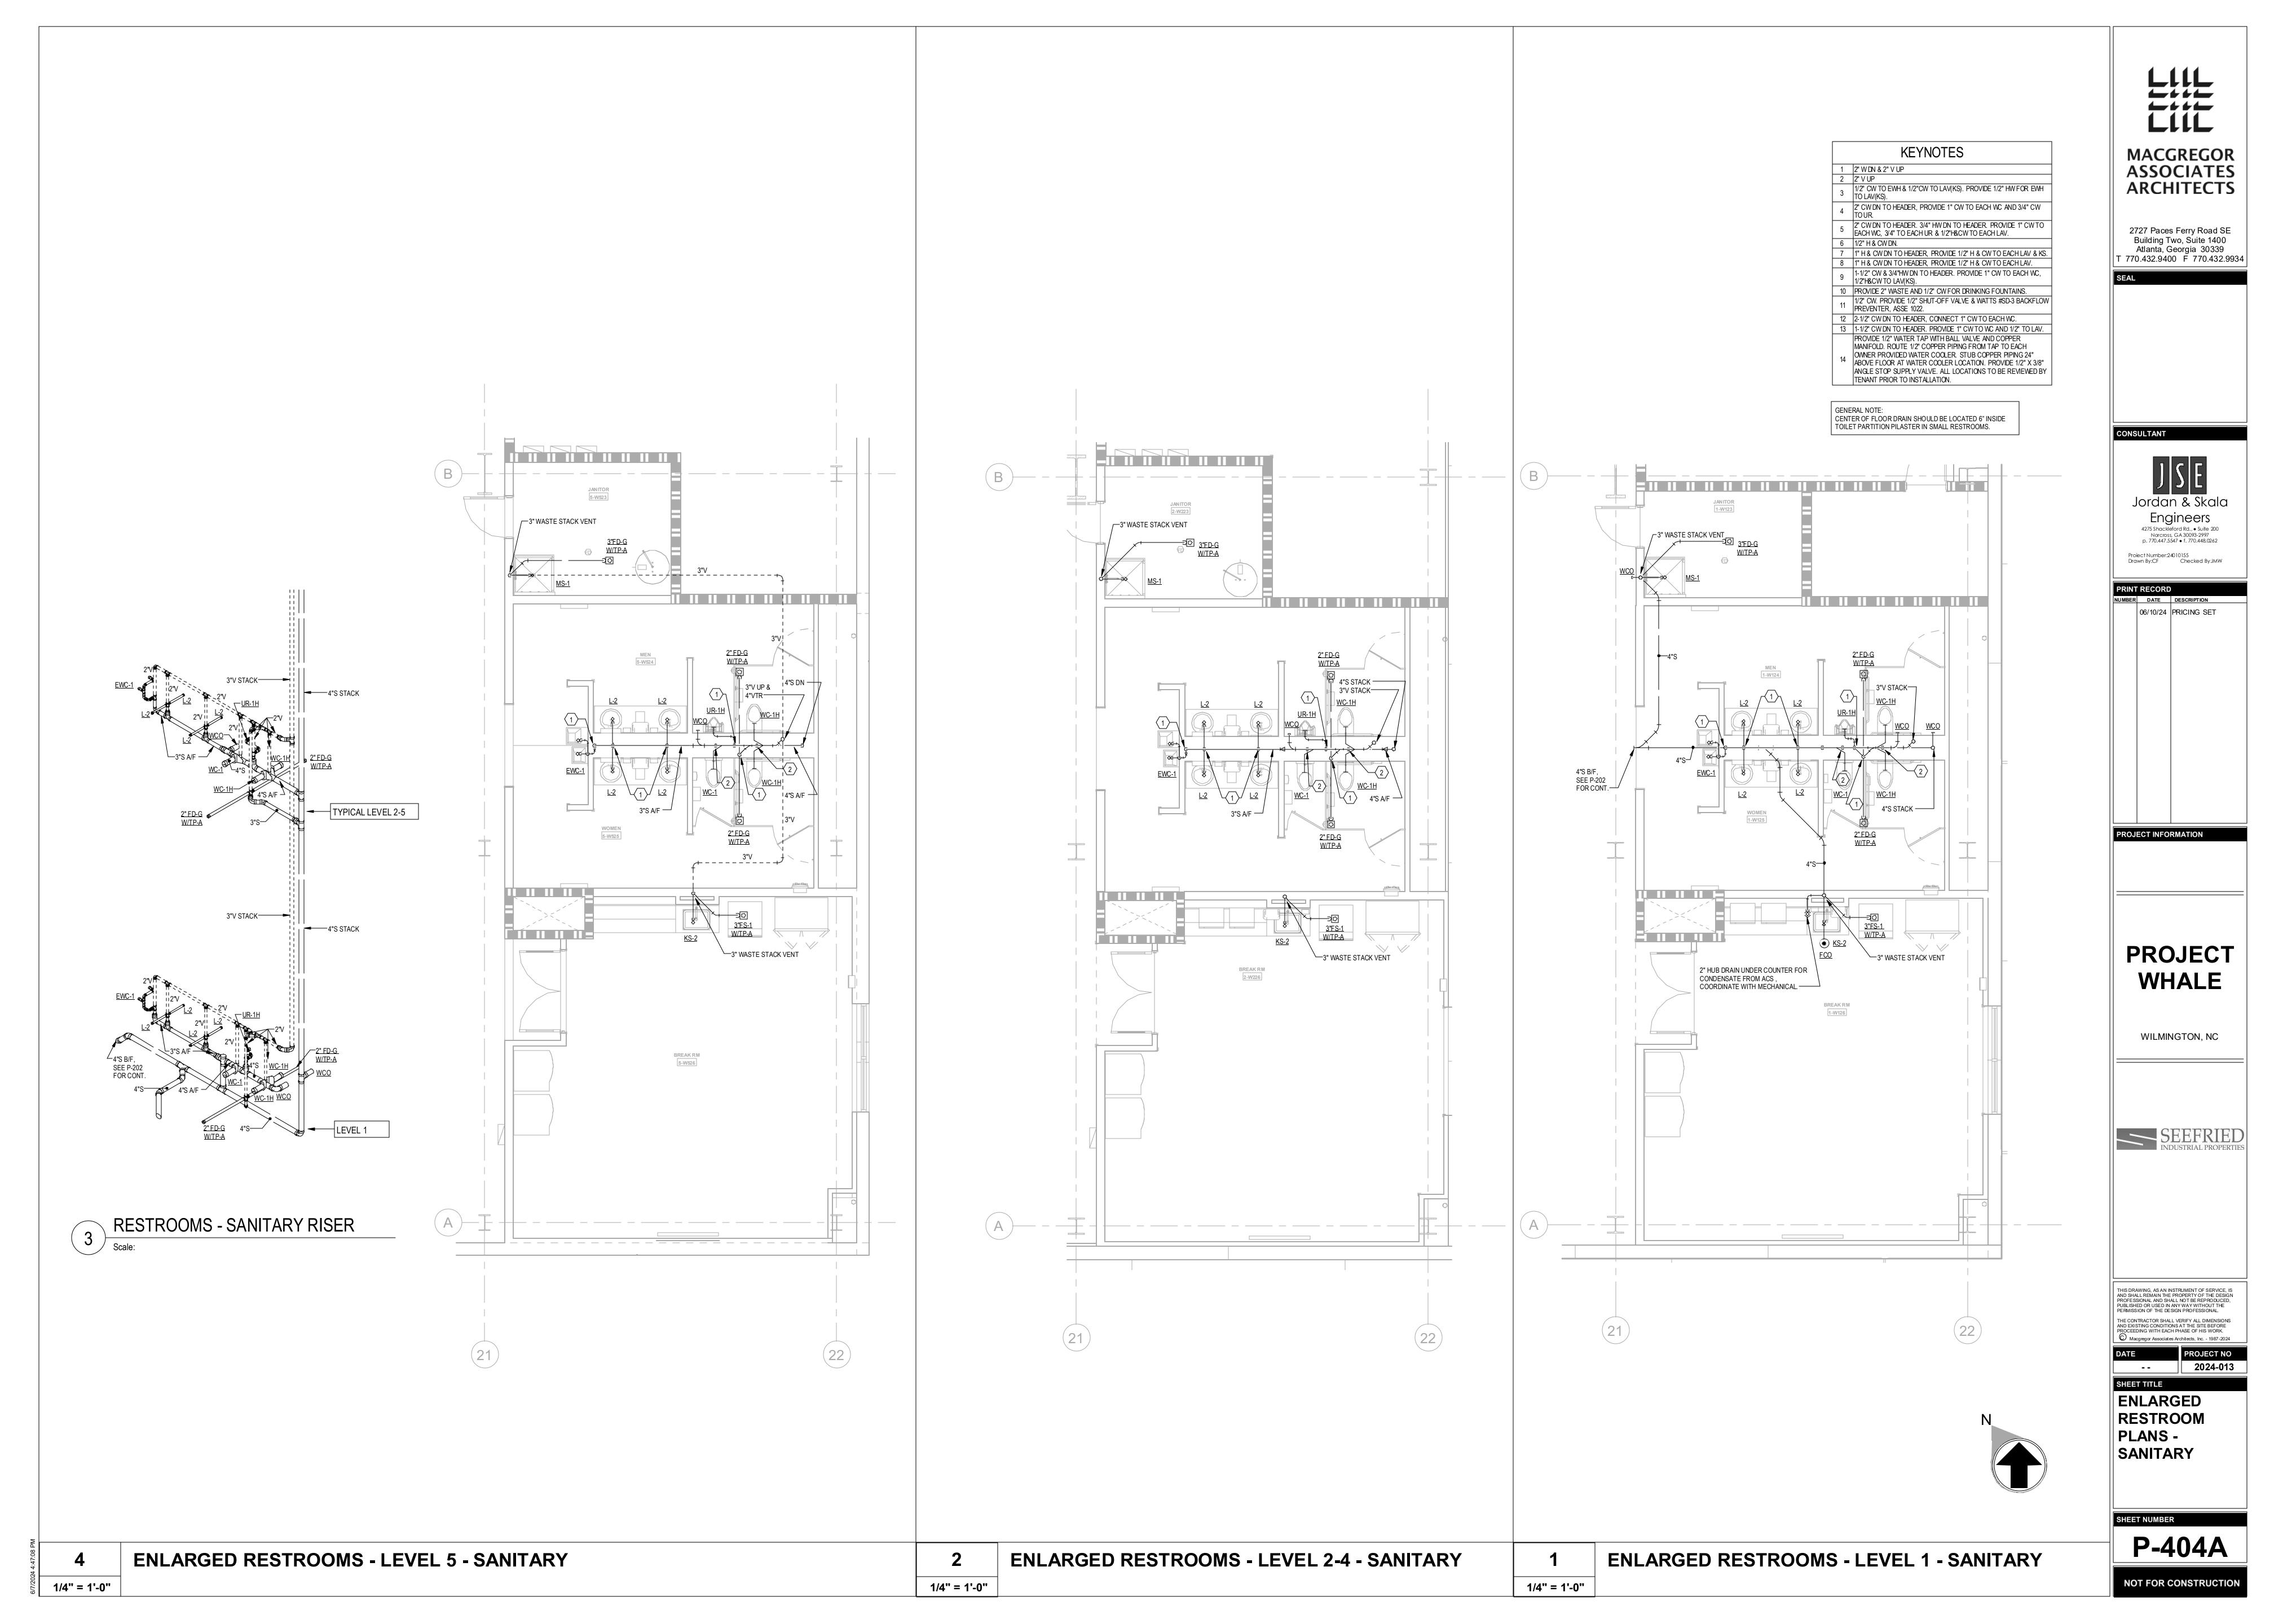
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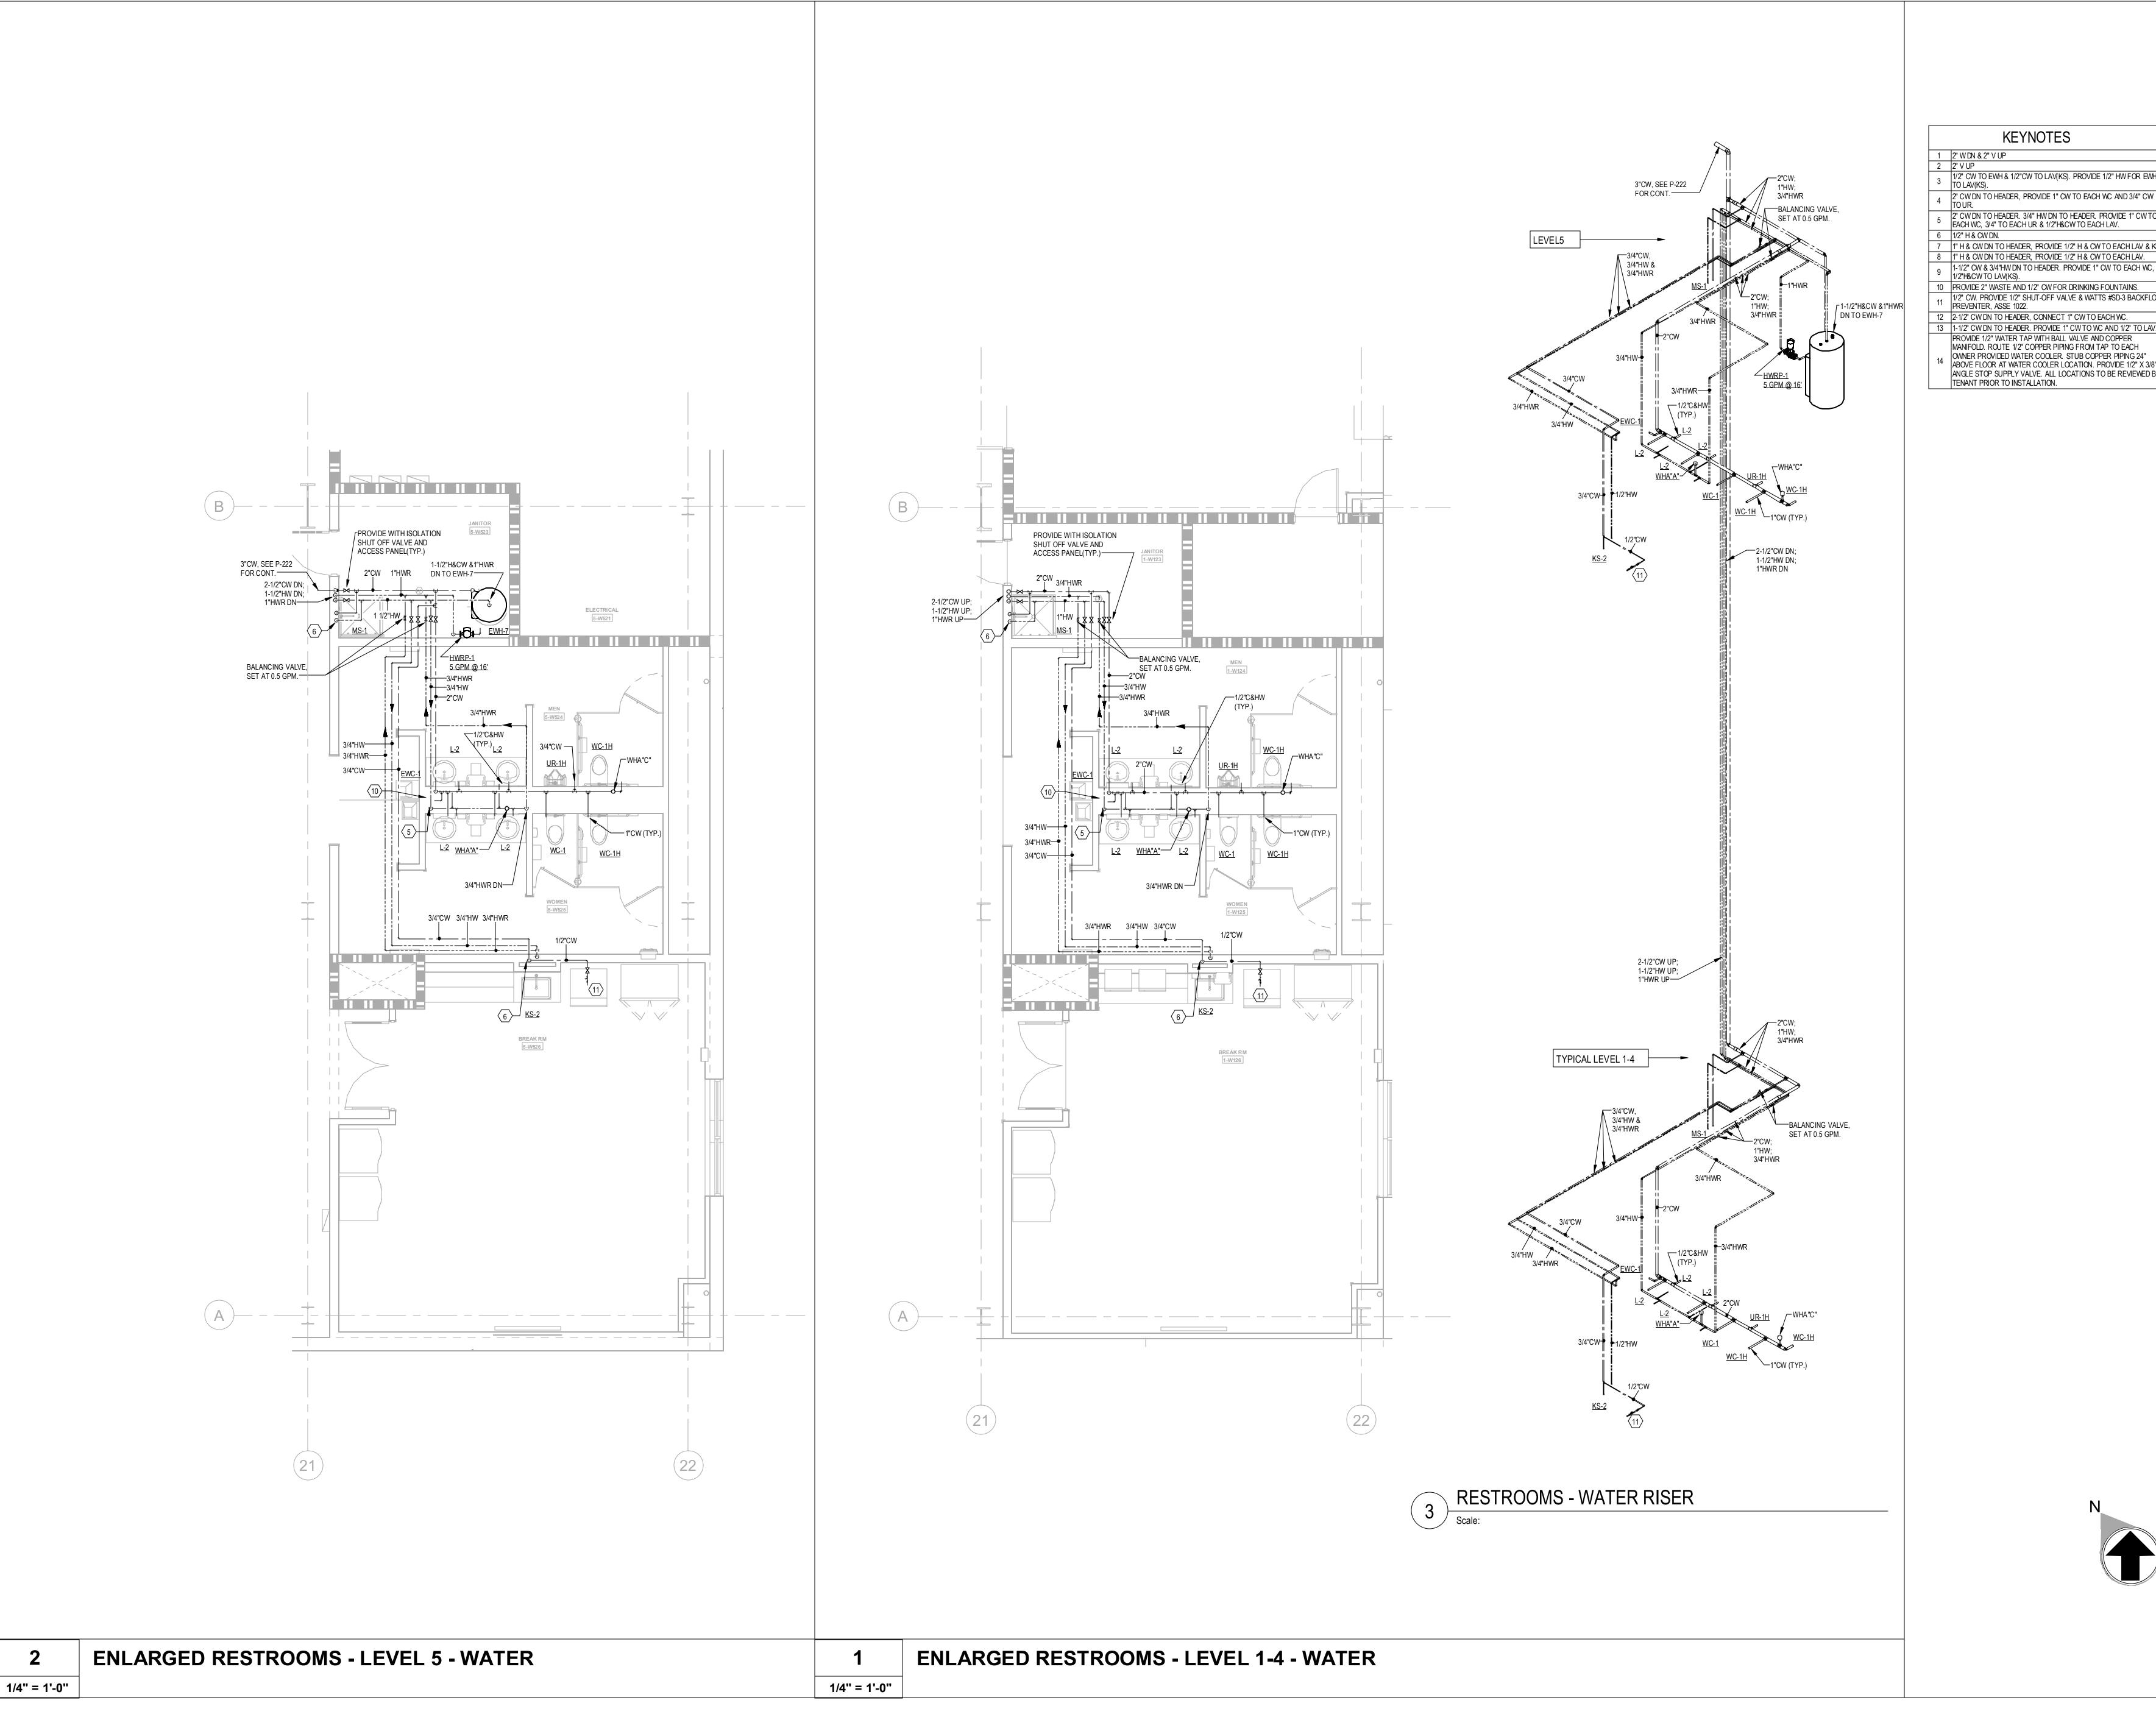
2024-013 SHEET TITLE **ENLARGED**

REMOTE BREAKROOM PLANS -SANITARY

P-403A





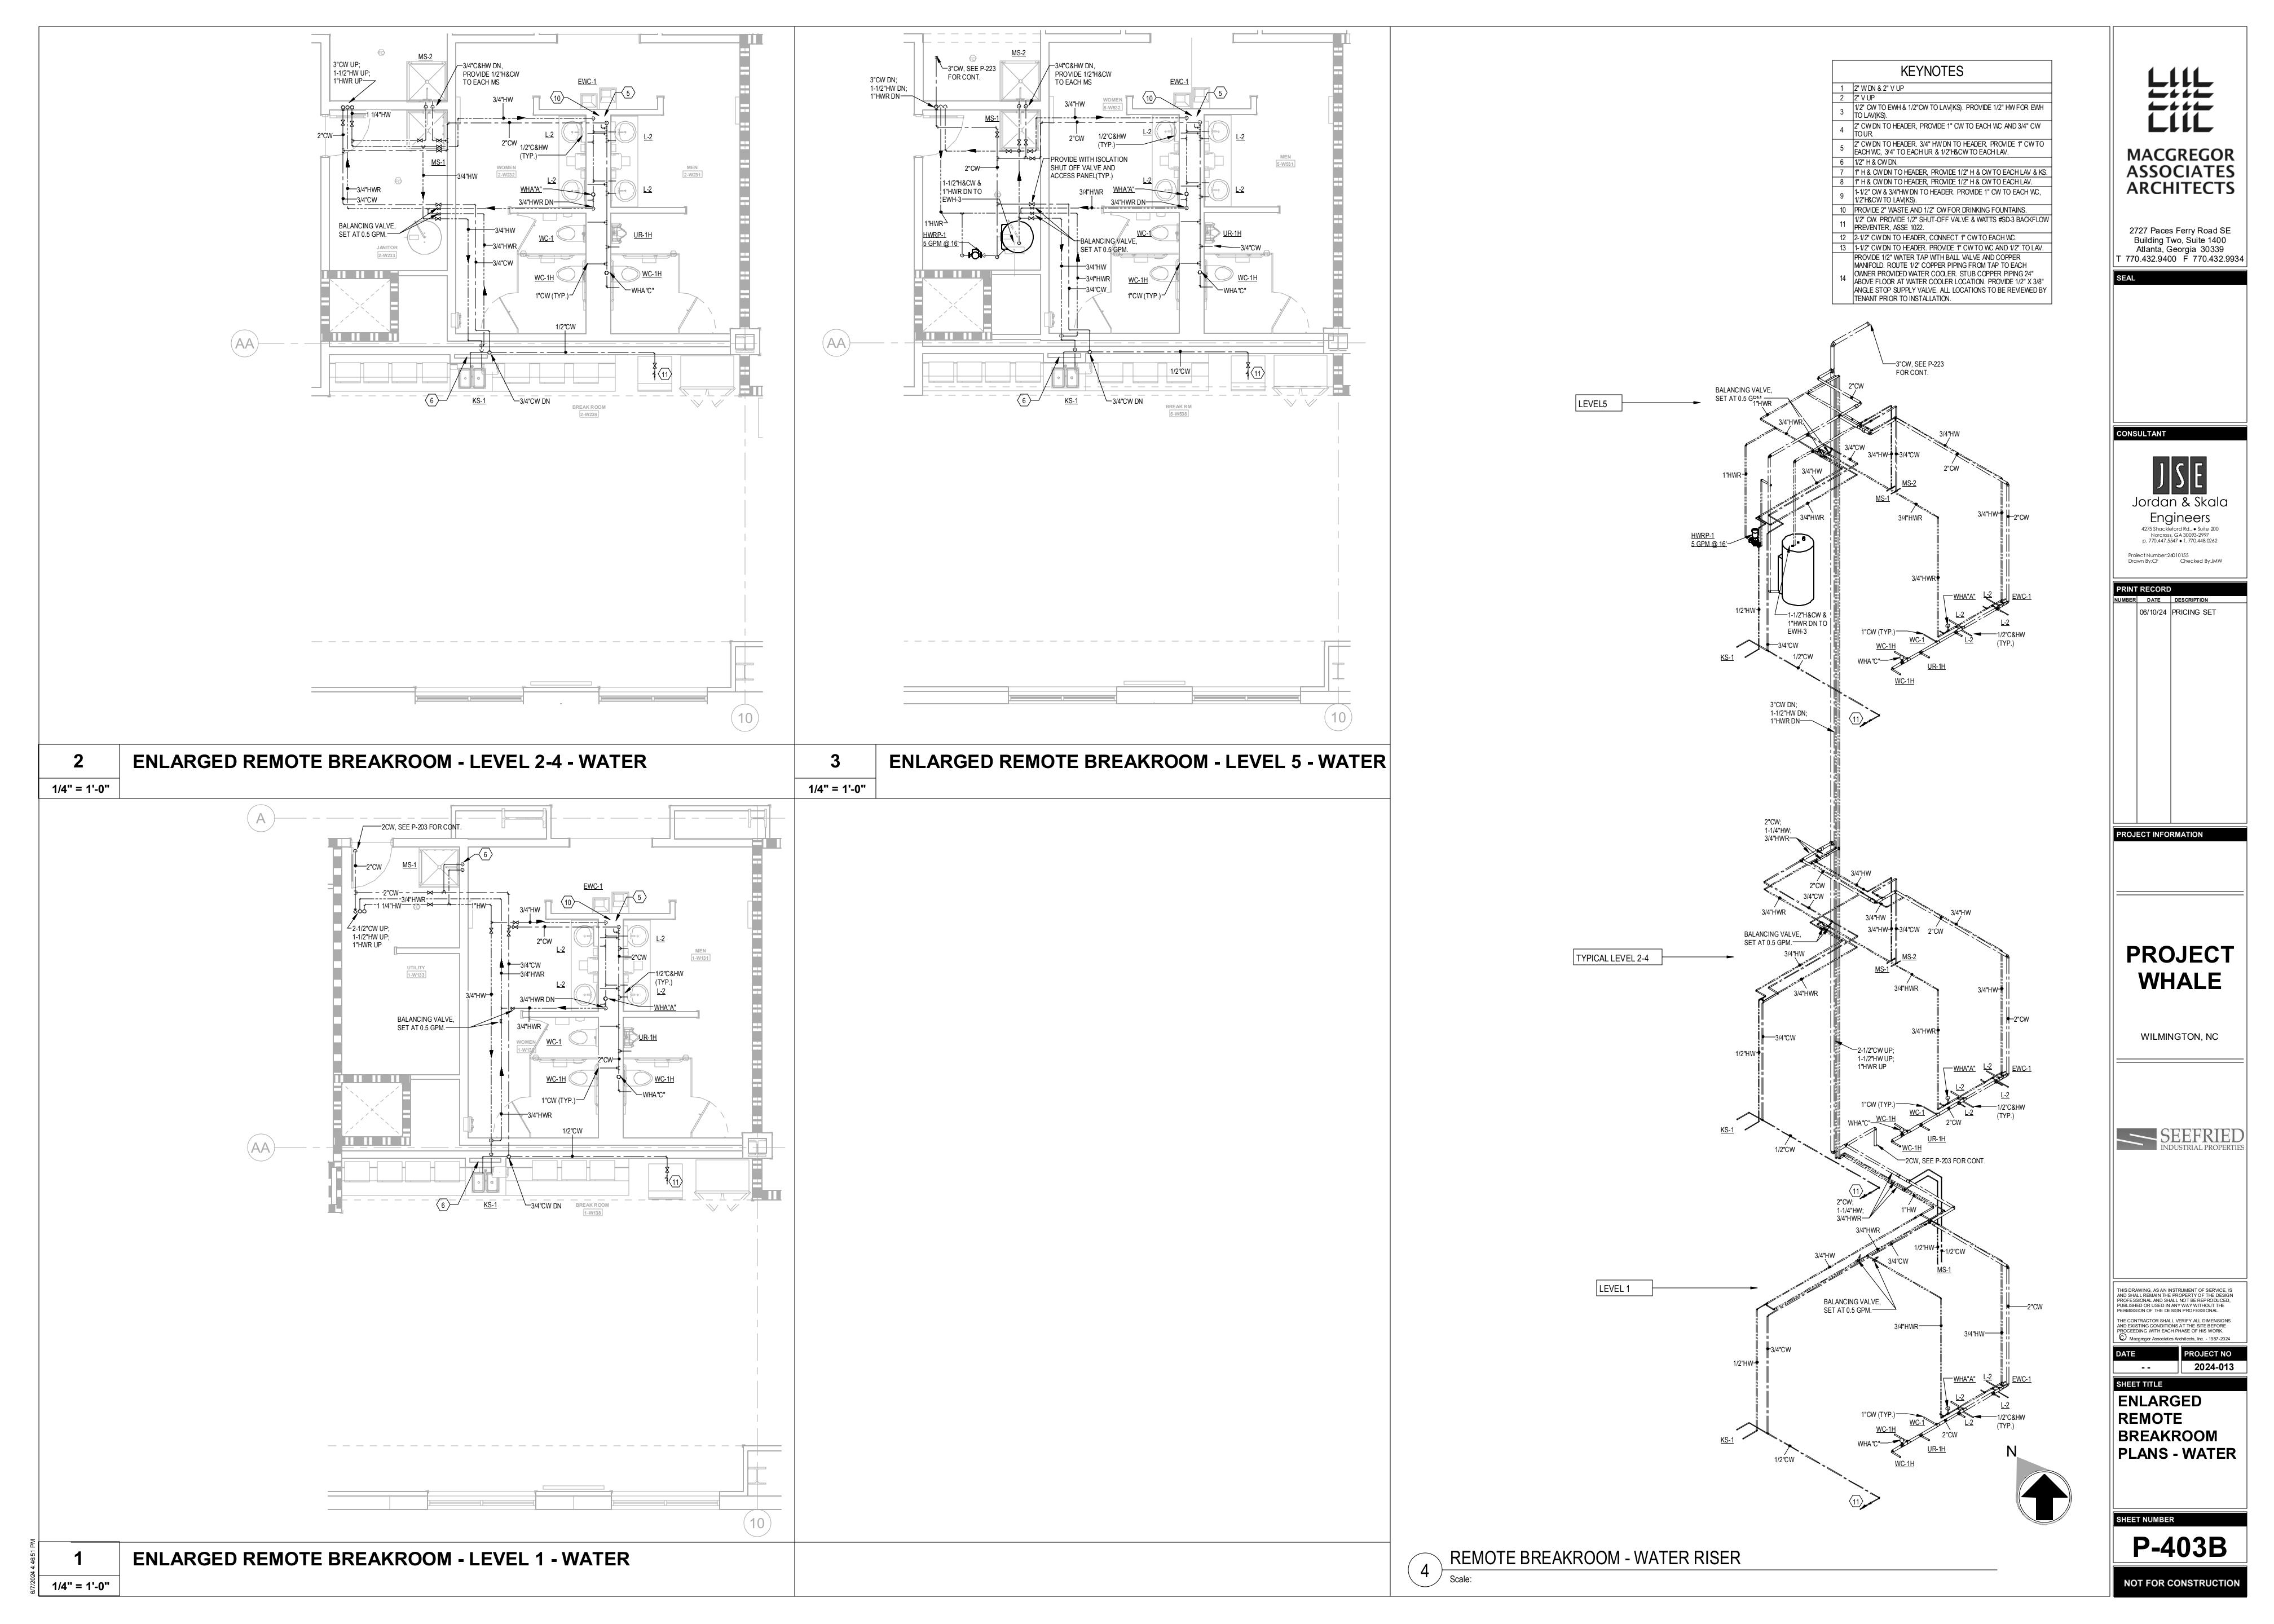



1/2" CW TO EWH & 1/2"CW TO LAV(KS). PROVIDE 1/2" HW FOR EWH 2" CW DN TO HEADER, PROVIDE 1" CW TO EACH WC AND 3/4" CW

2" CW DN TO HEADER. 3/4" HW DN TO HEADER. PROVIDE 1" CW TO EACH WC, 3/4" TO EACH UR & 1/2"H&CW TO EACH LAV.

1" H & CW DN TO HEADER, PROVIDE 1/2" H & CW TO EACH LAV & KS.

9 1-1/2" CW & 3/4"HW DN TO HEADER. PROVIDE 1" CW TO EACH WC, 1/2"H&CW TO LAV(KS).

10 PROVIDE 2" WASTE AND 1/2" CW FOR DRINKING FOUNTAINS.

11 1/2" CW. PROVIDE 1/2" SHUT-OFF VALVE & WATTS #SD-3 BACKFLOW PREVENTER, ASSE 1022.

12 2-1/2" CW DN TO HEADER, CONNECT 1" CW TO EACH WC. 13 1-1/2" CW DN TO HEADER. PROVIDE 1" CW TO WC AND 1/2" TO LAV.

PROVIDE 1/2" WATER TAP WITH BALL VALVE AND COPPER
MANIFOLD. ROUTE 1/2" COPPER PIPING FROM TAP TO EACH
OWNER PROVIDED WATER COOLER. STUB COPPER PIPING 24"
ABOVE FLOOR AT WATER COOLER LOCATION. PROVIDE 1/2" X 3/8" ANGLE STOP SUPPLY VALVE. ALL LOCATIONS TO BE REVIEWED BY

MACGREGOR ASSOCIATES ARCHITECTS

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PROJECT INFORMATION

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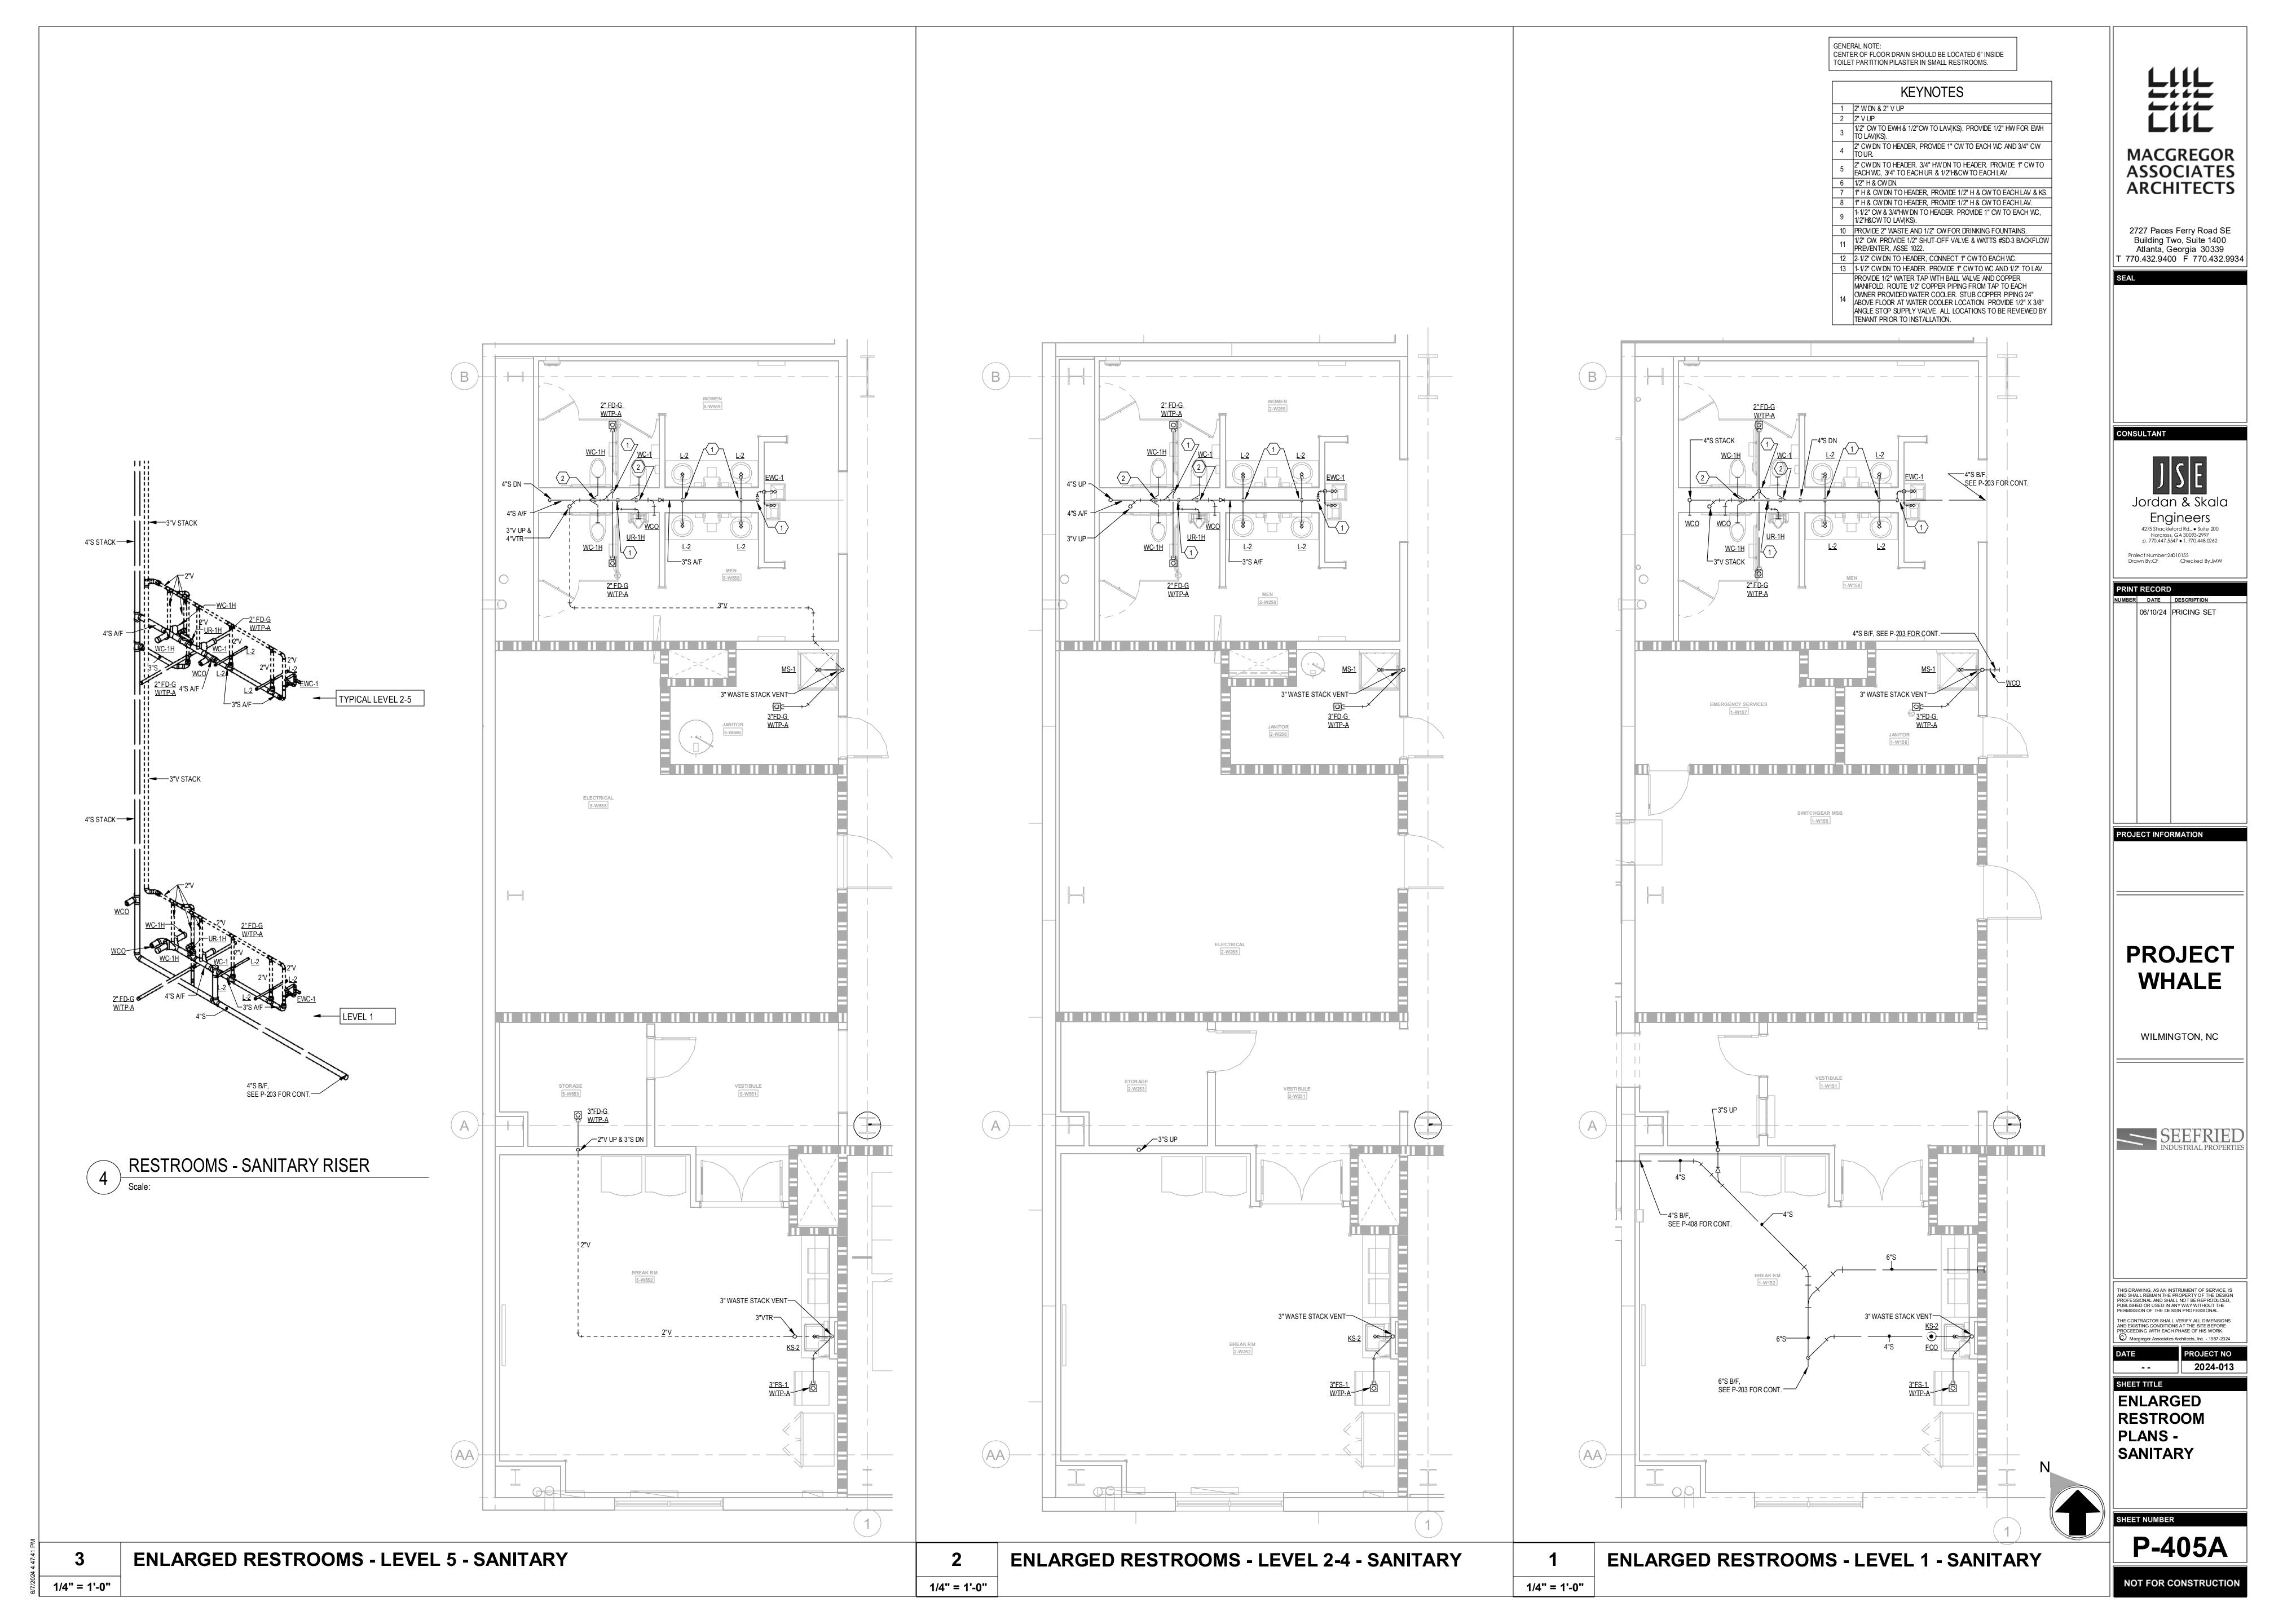
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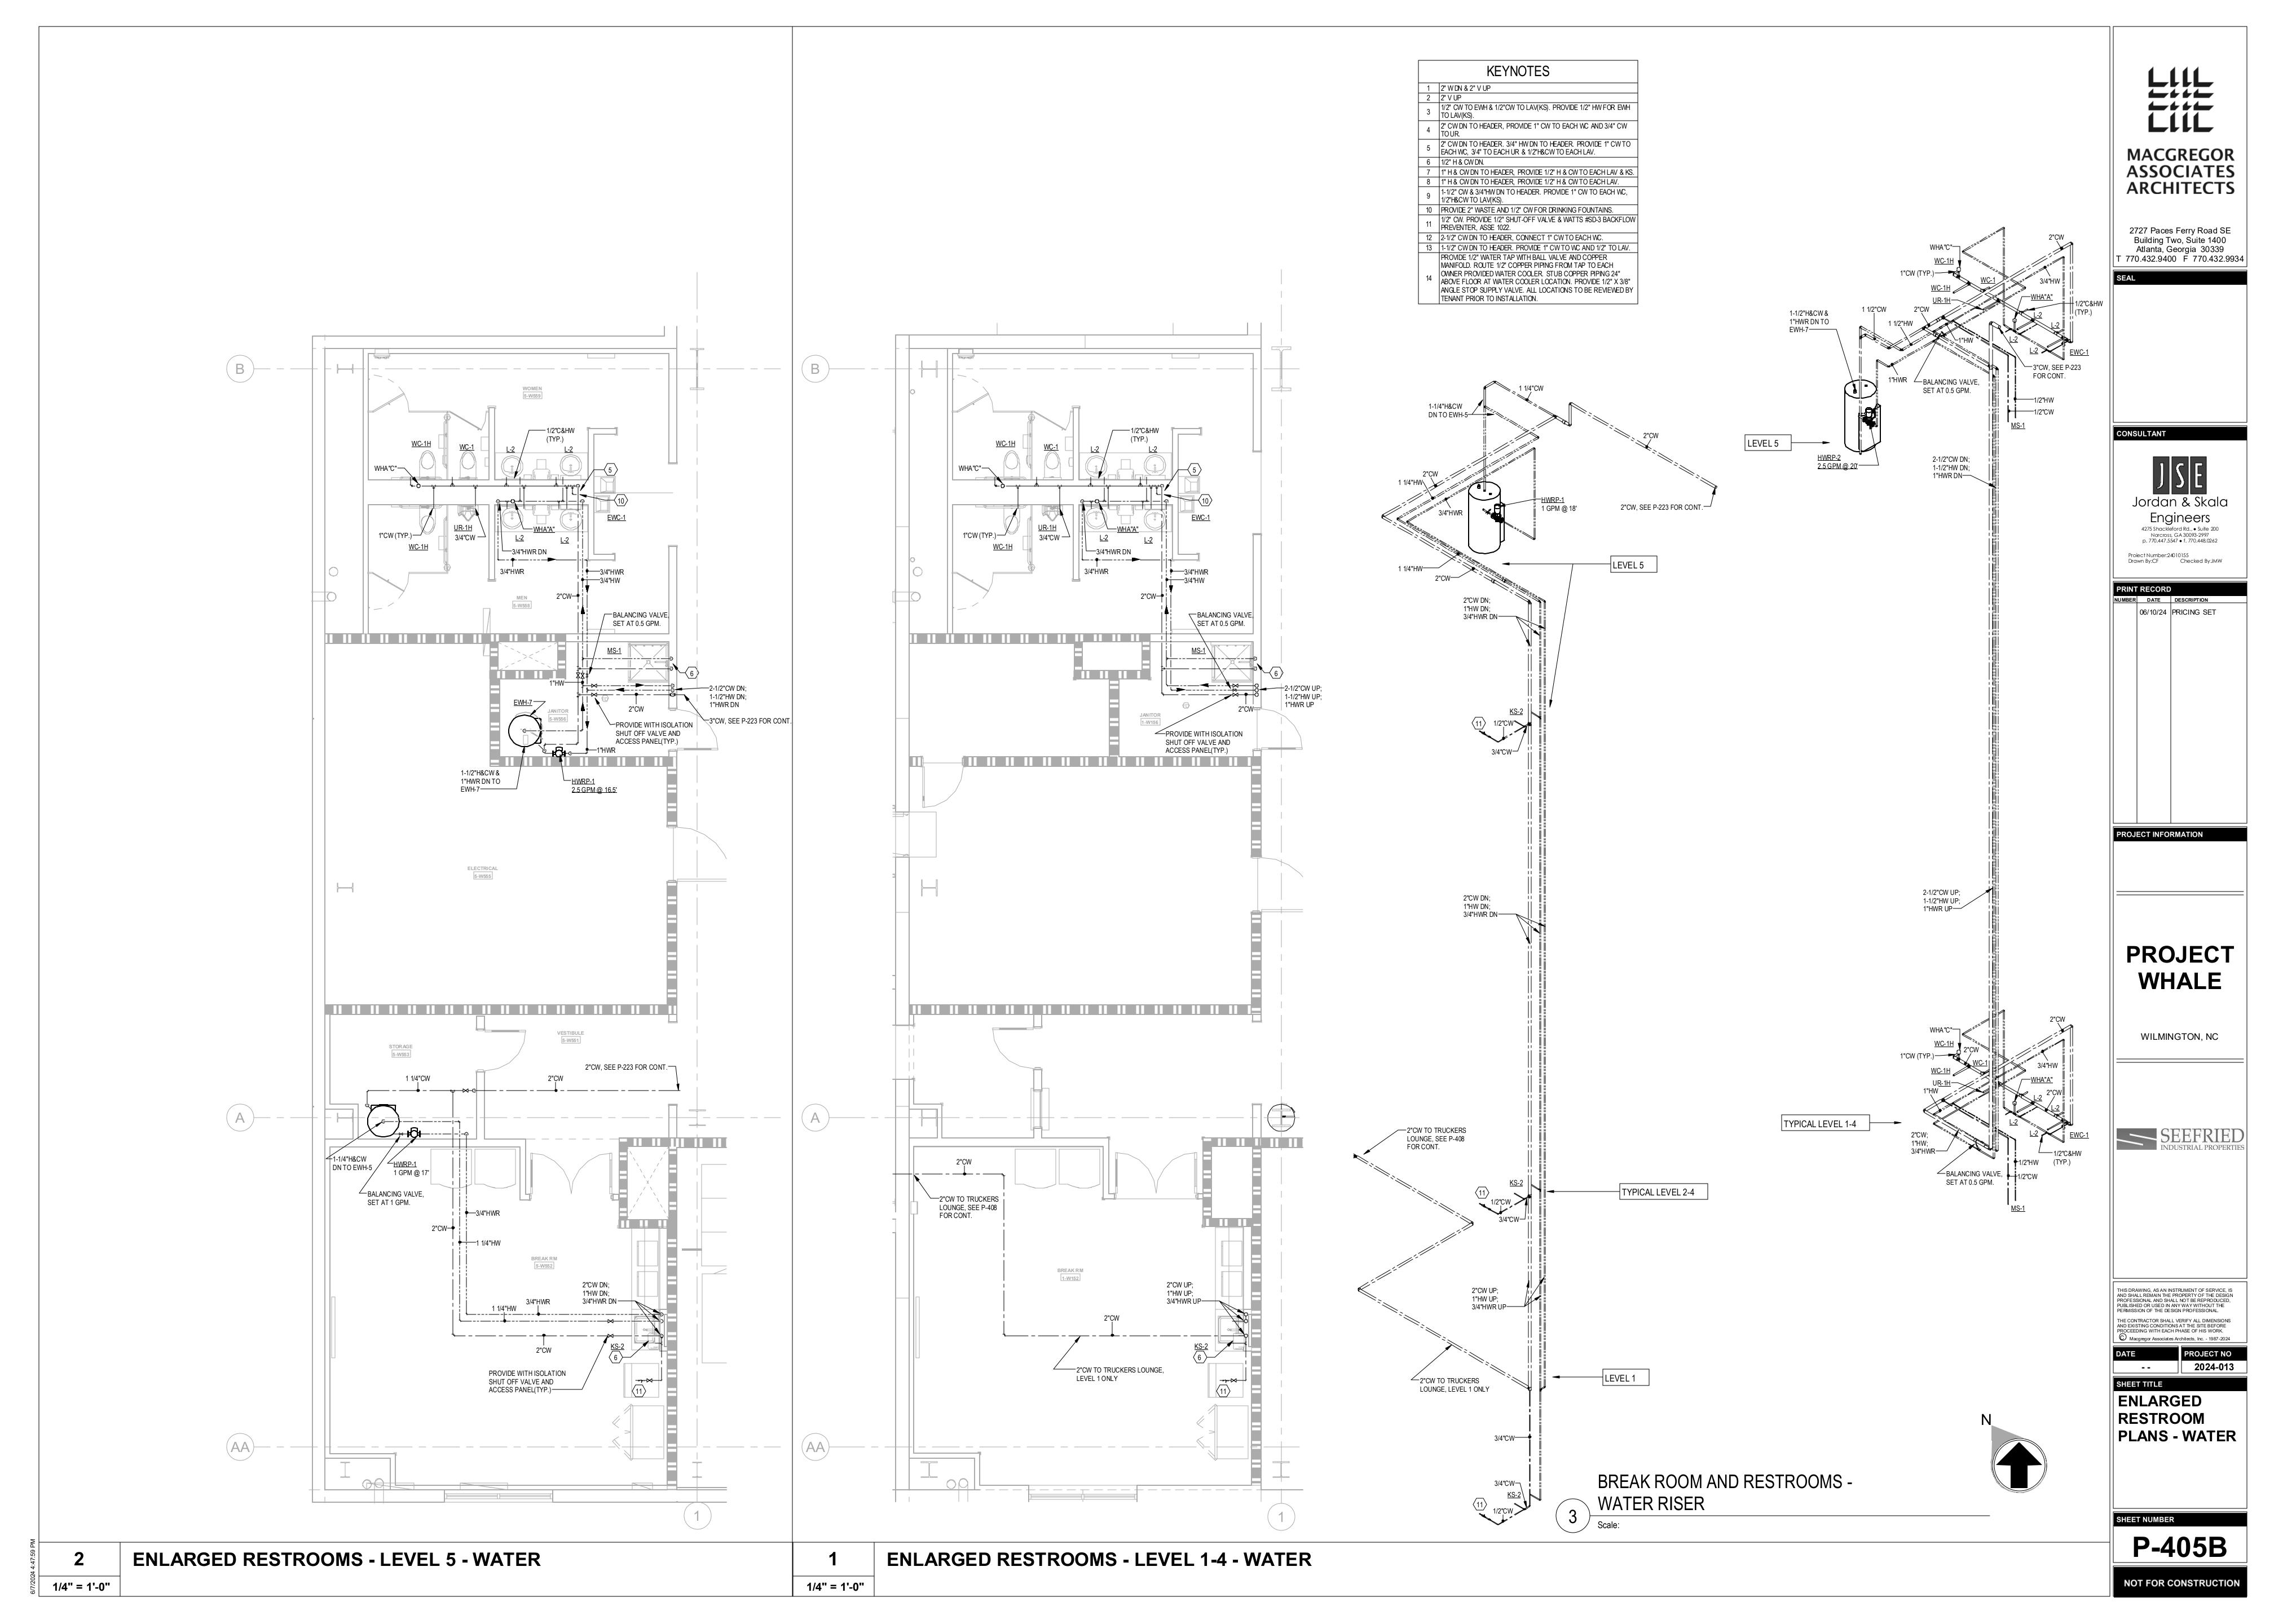
PROJECT NO 2024-013


SHEET TITLE ENLARGED RESTROOM **PLANS - WATER**

SHEET NUMBER

P-404B





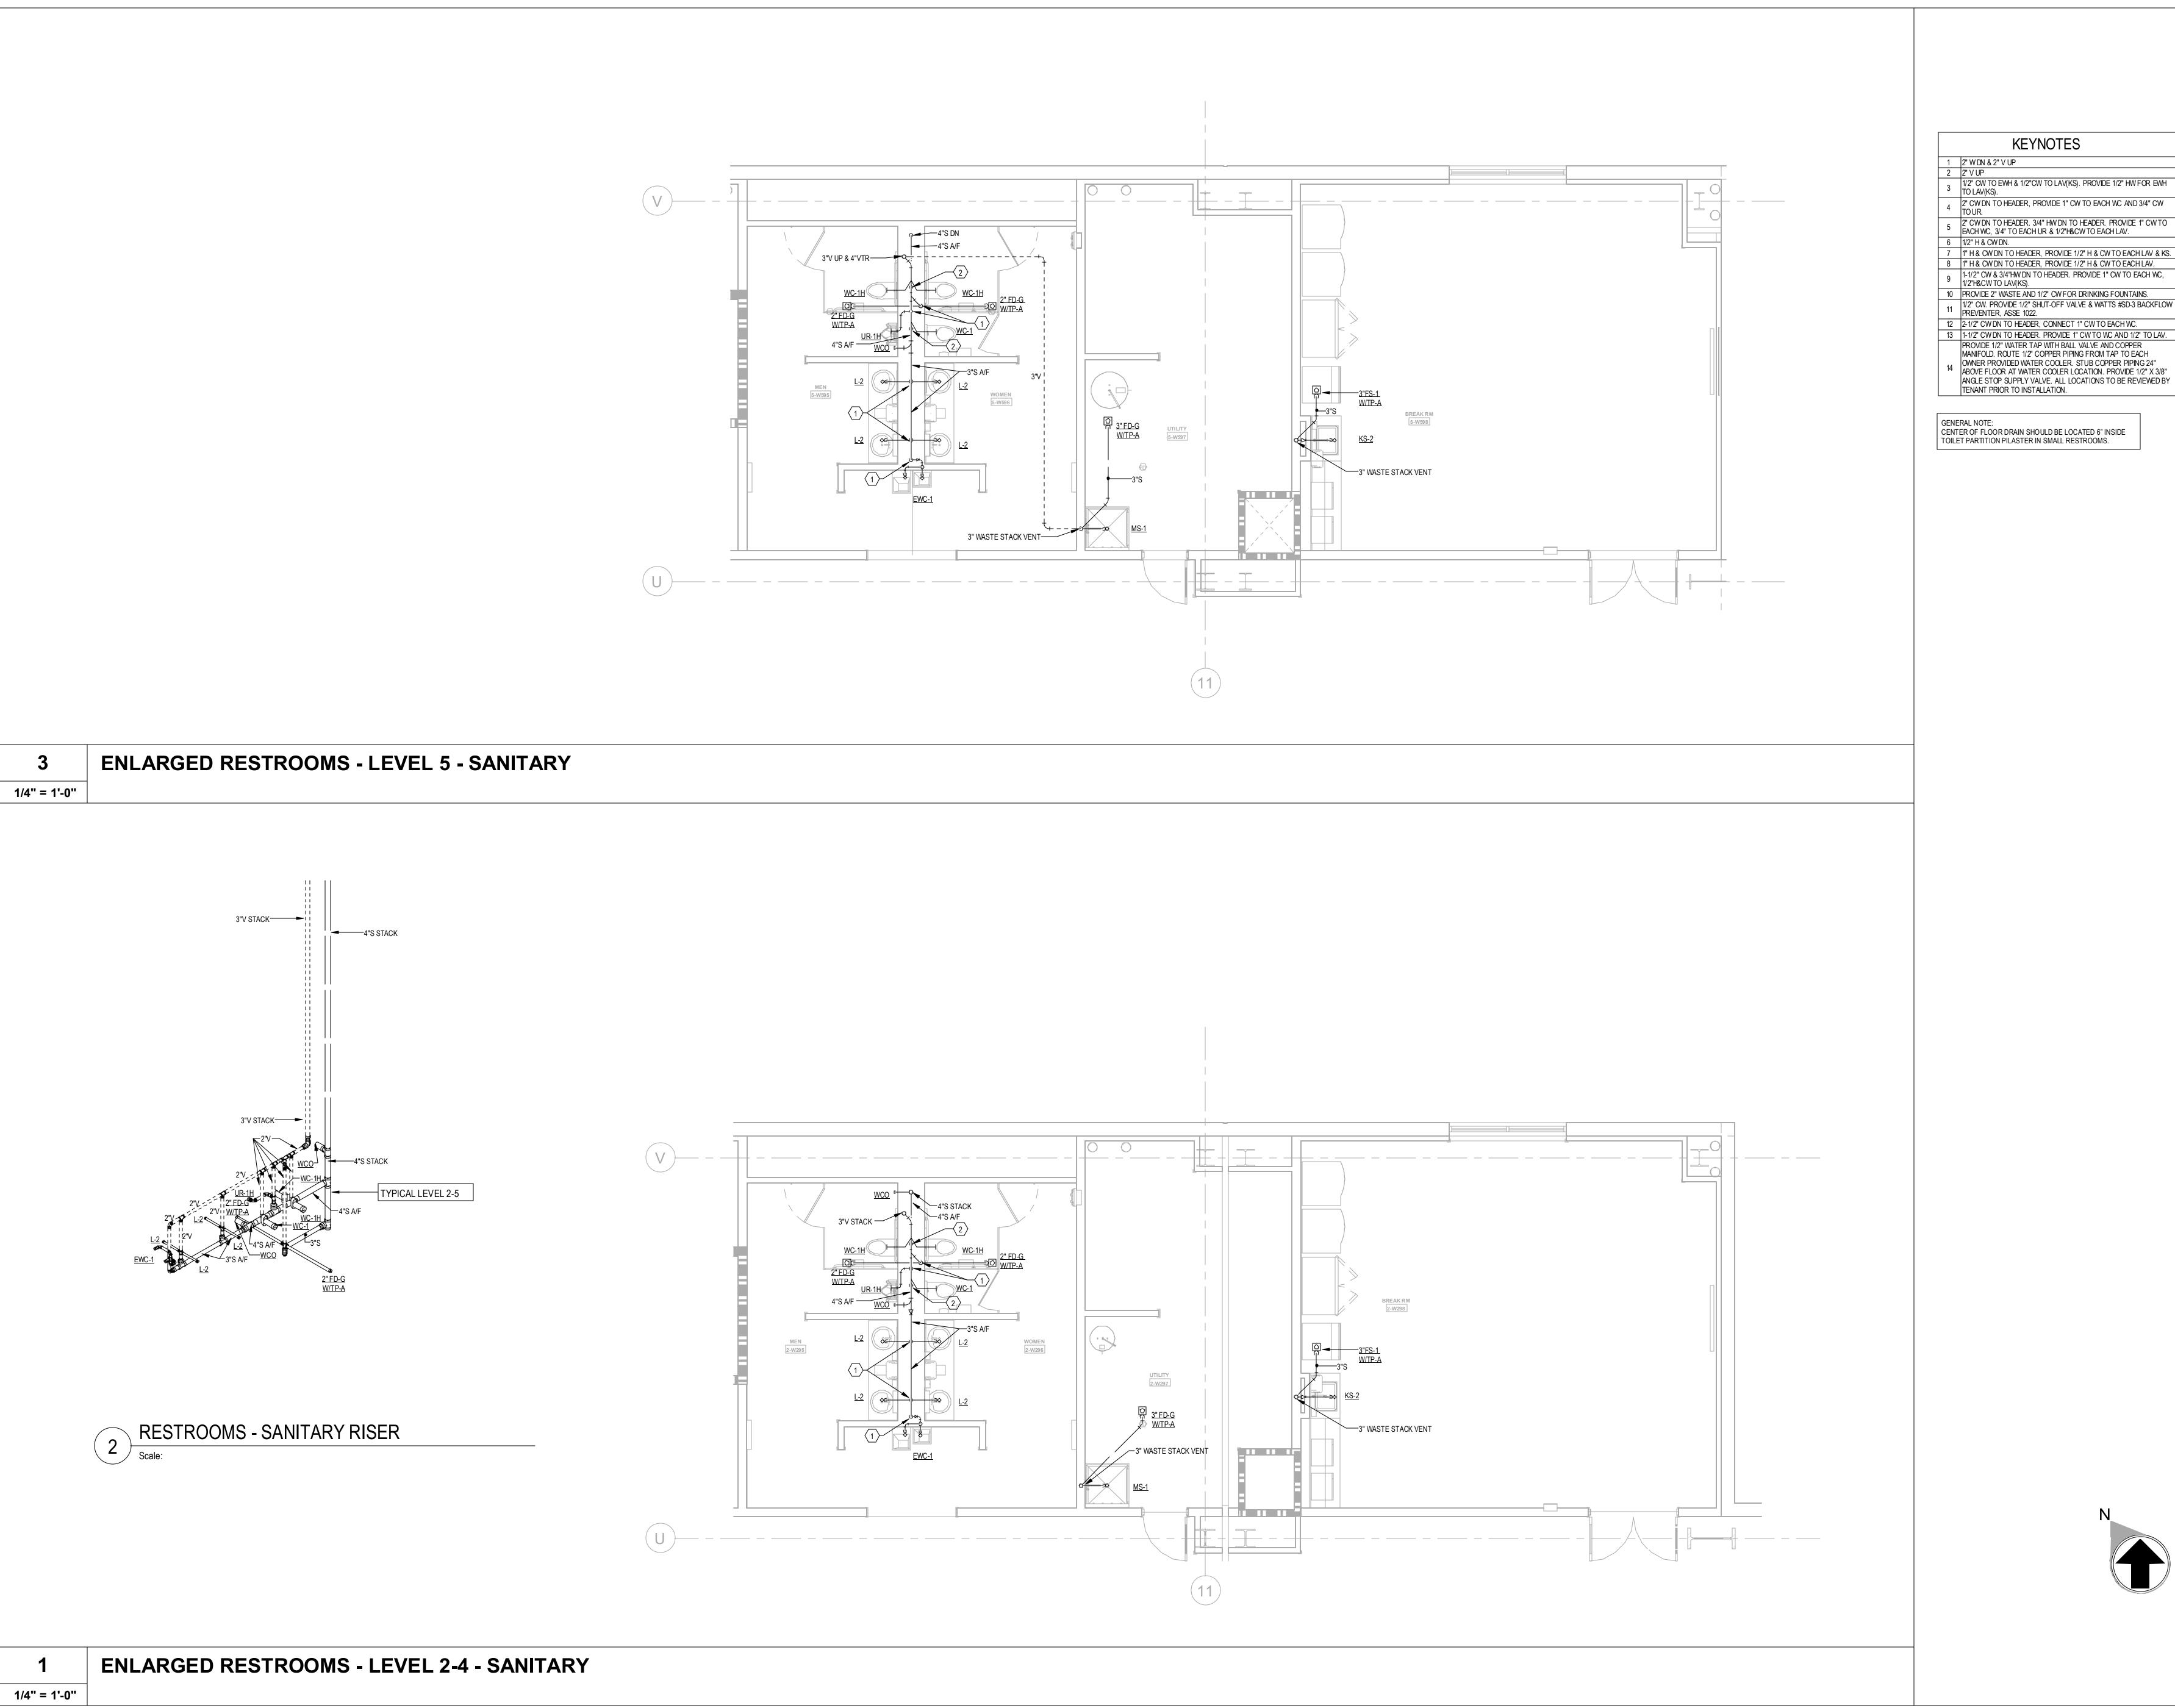

1/2" CW TO EWH & 1/2"CW TO LAV(KS). PROVIDE 1/2" HW FOR EWH

2" CW DN TO HEADER, PROVIDE 1" CW TO EACH WC AND 3/4" CW TO UR.

5 2" CW DN TO HEADER. 3/4" HW DN TO HEADER. PROVIDE 1" CW TO EACH WC, 3/4" TO EACH UR & 1/2"H&CW TO EACH LAV.

8 1" H & CW DN TO HEADER, PROVIDE 1/2" H & CW TO EACH LAV.

9 1-1/2" CW & 3/4"HW DN TO HEADER. PROVIDE 1" CW TO EACH WC, 1/2"H&CW TO LAV(KS).

11 1/2" CW. PROVIDE 1/2" SHUT-OFF VALVE & WATTS #SD-3 BACKFLOW PREVENTER, ASSE 1022.

13 1-1/2" CW DN TO HEADER. PROVIDE 1" CW TO WC AND 1/2" TO LAV. PROVIDE 1/2" WATER TAP WITH BALL VALVE AND COPPER

MANIFOLD. ROUTE 1/2" COPPER PIPING FROM TAP TO EACH OWNER PROVIDED WATER COOLER. STUB COPPER PIPING 24"
ABOVE FLOOR AT WATER COOLER LOCATION. PROVIDE 1/2" X 3/8" ANGLE STOP SUPPLY VALVE. ALL LOCATIONS TO BE REVIEWED BY

CENTER OF FLOOR DRAIN SHOULD BE LOCATED 6" INSIDE

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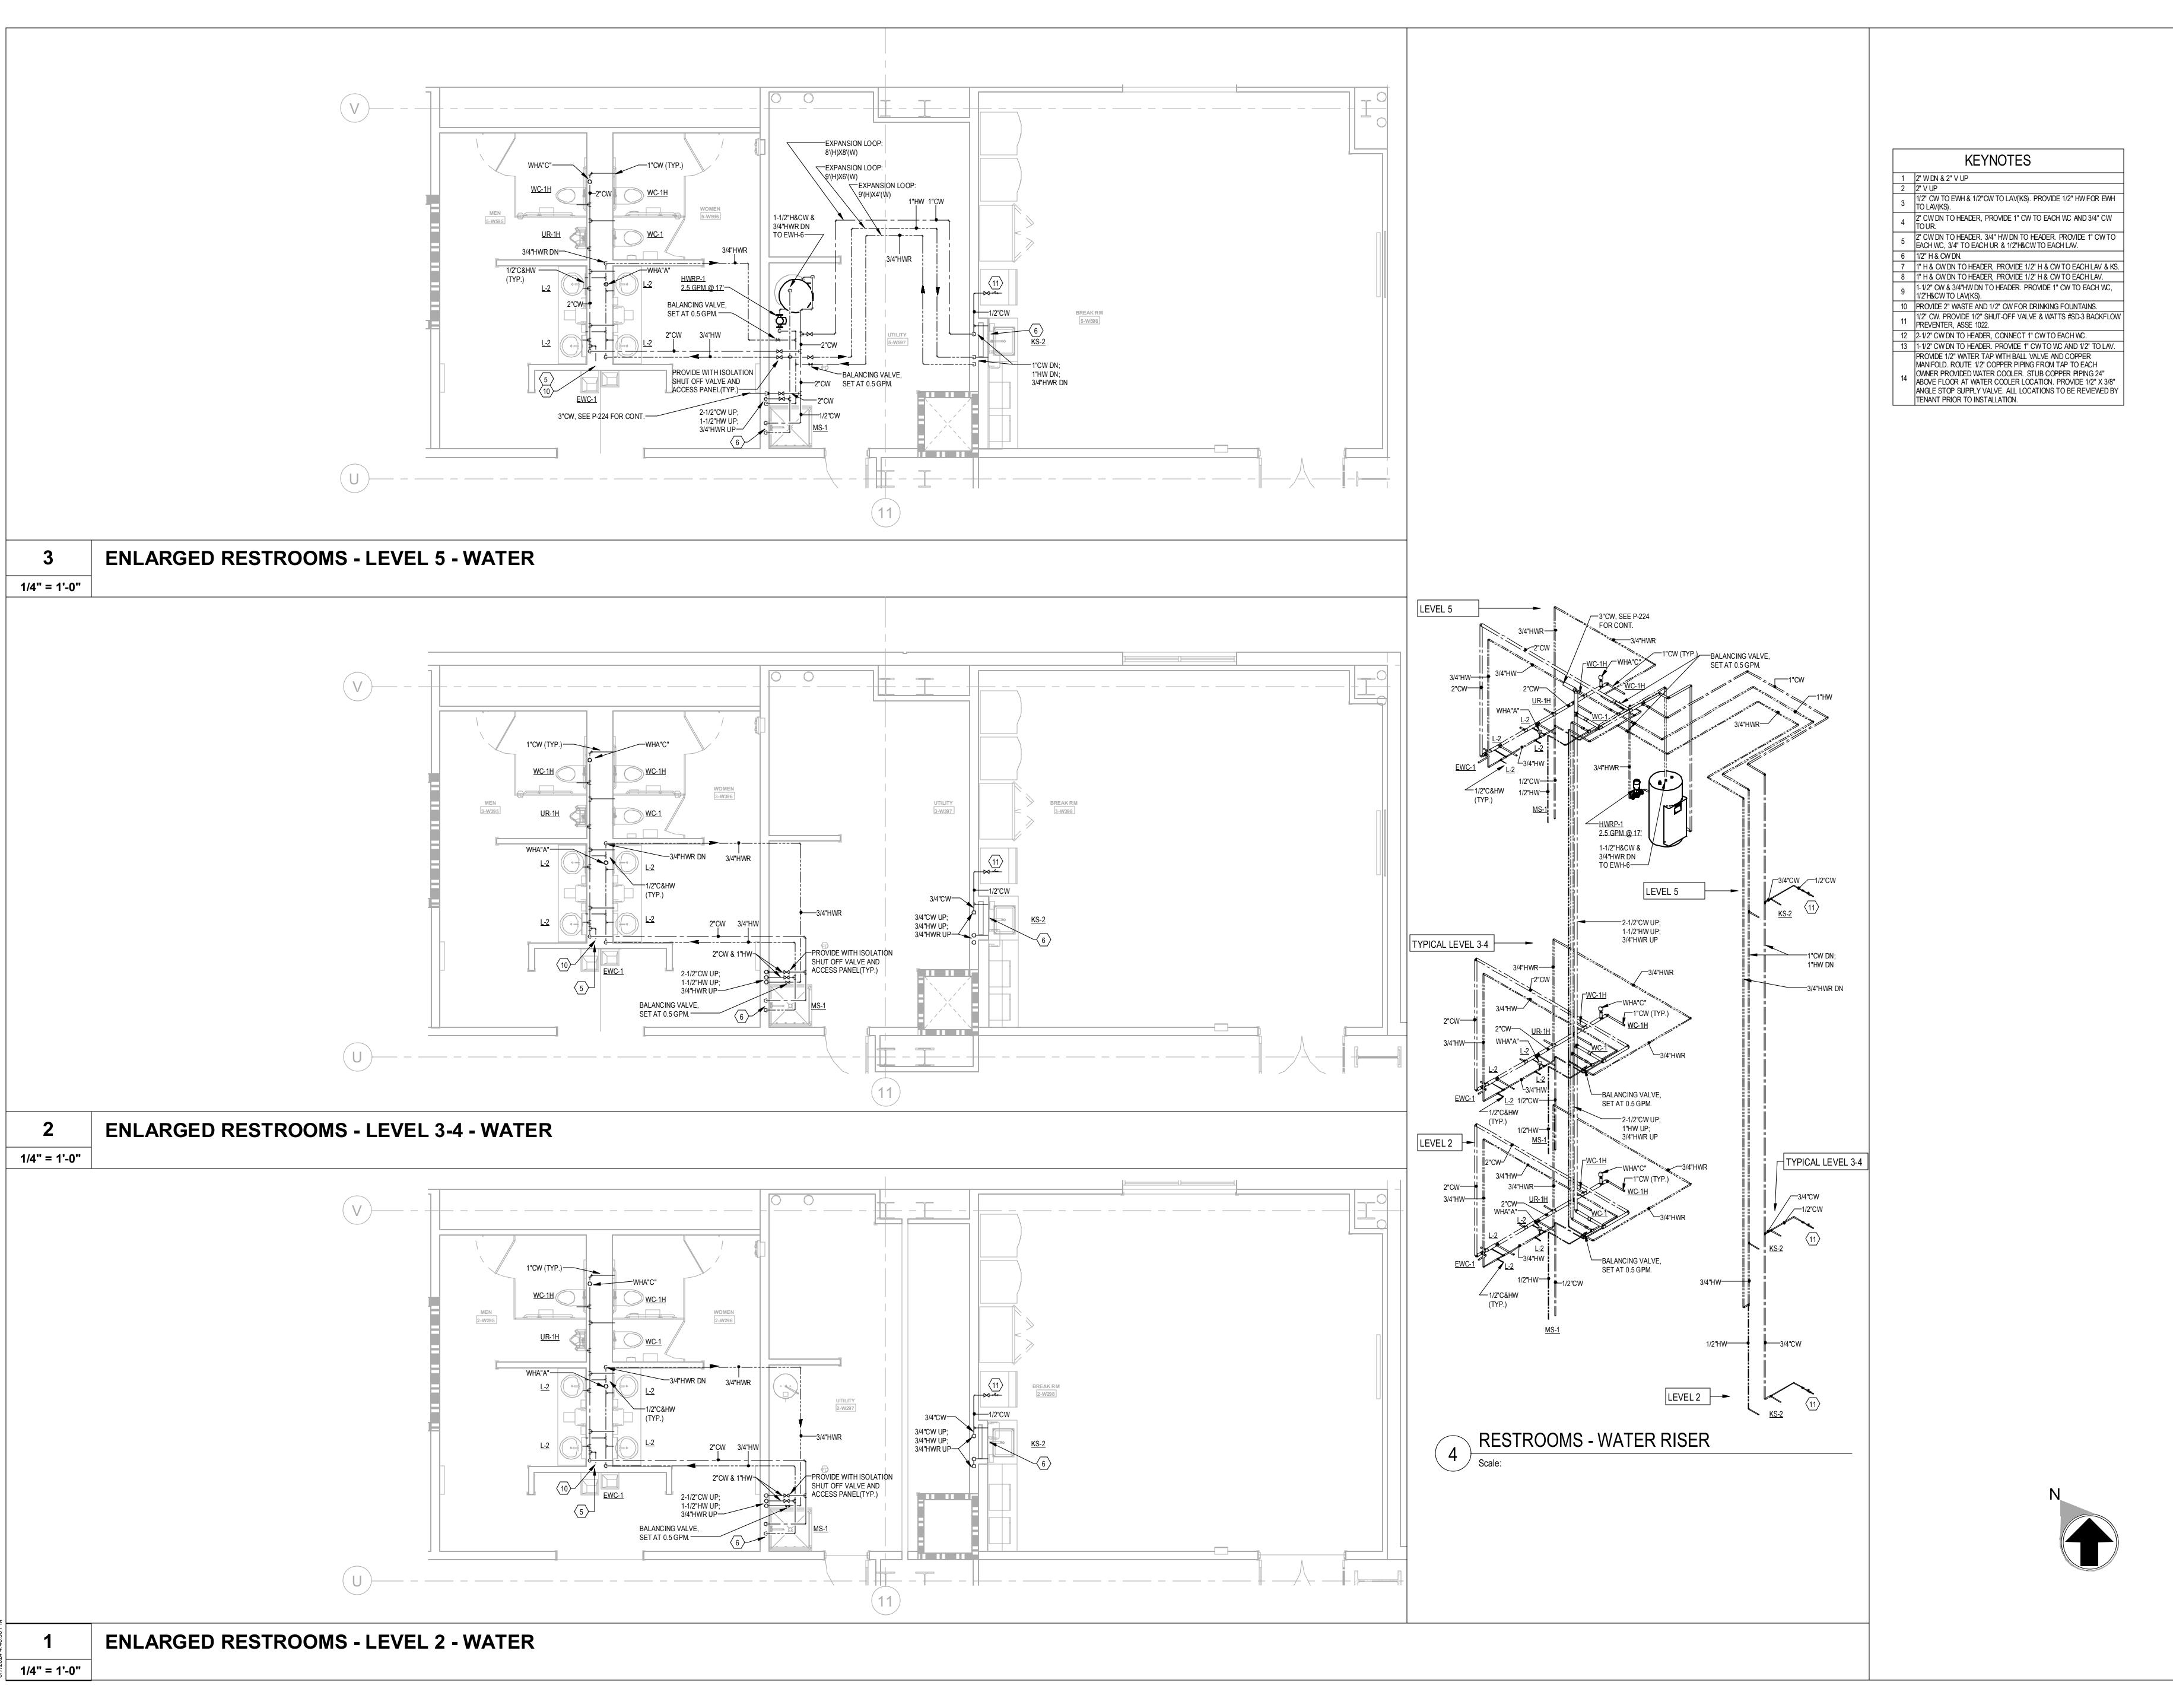
PROJECT WHALE

WILMINGTON, NC

2024-013

SHEET TITLE ENLARGED RESTROOM PLANS -SANITARY

P-406A



MACGREGOR ASSOCIATES ARCHITECTS

ARCHITECTS

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PROJECT WHALE

WILMINGTON, NC

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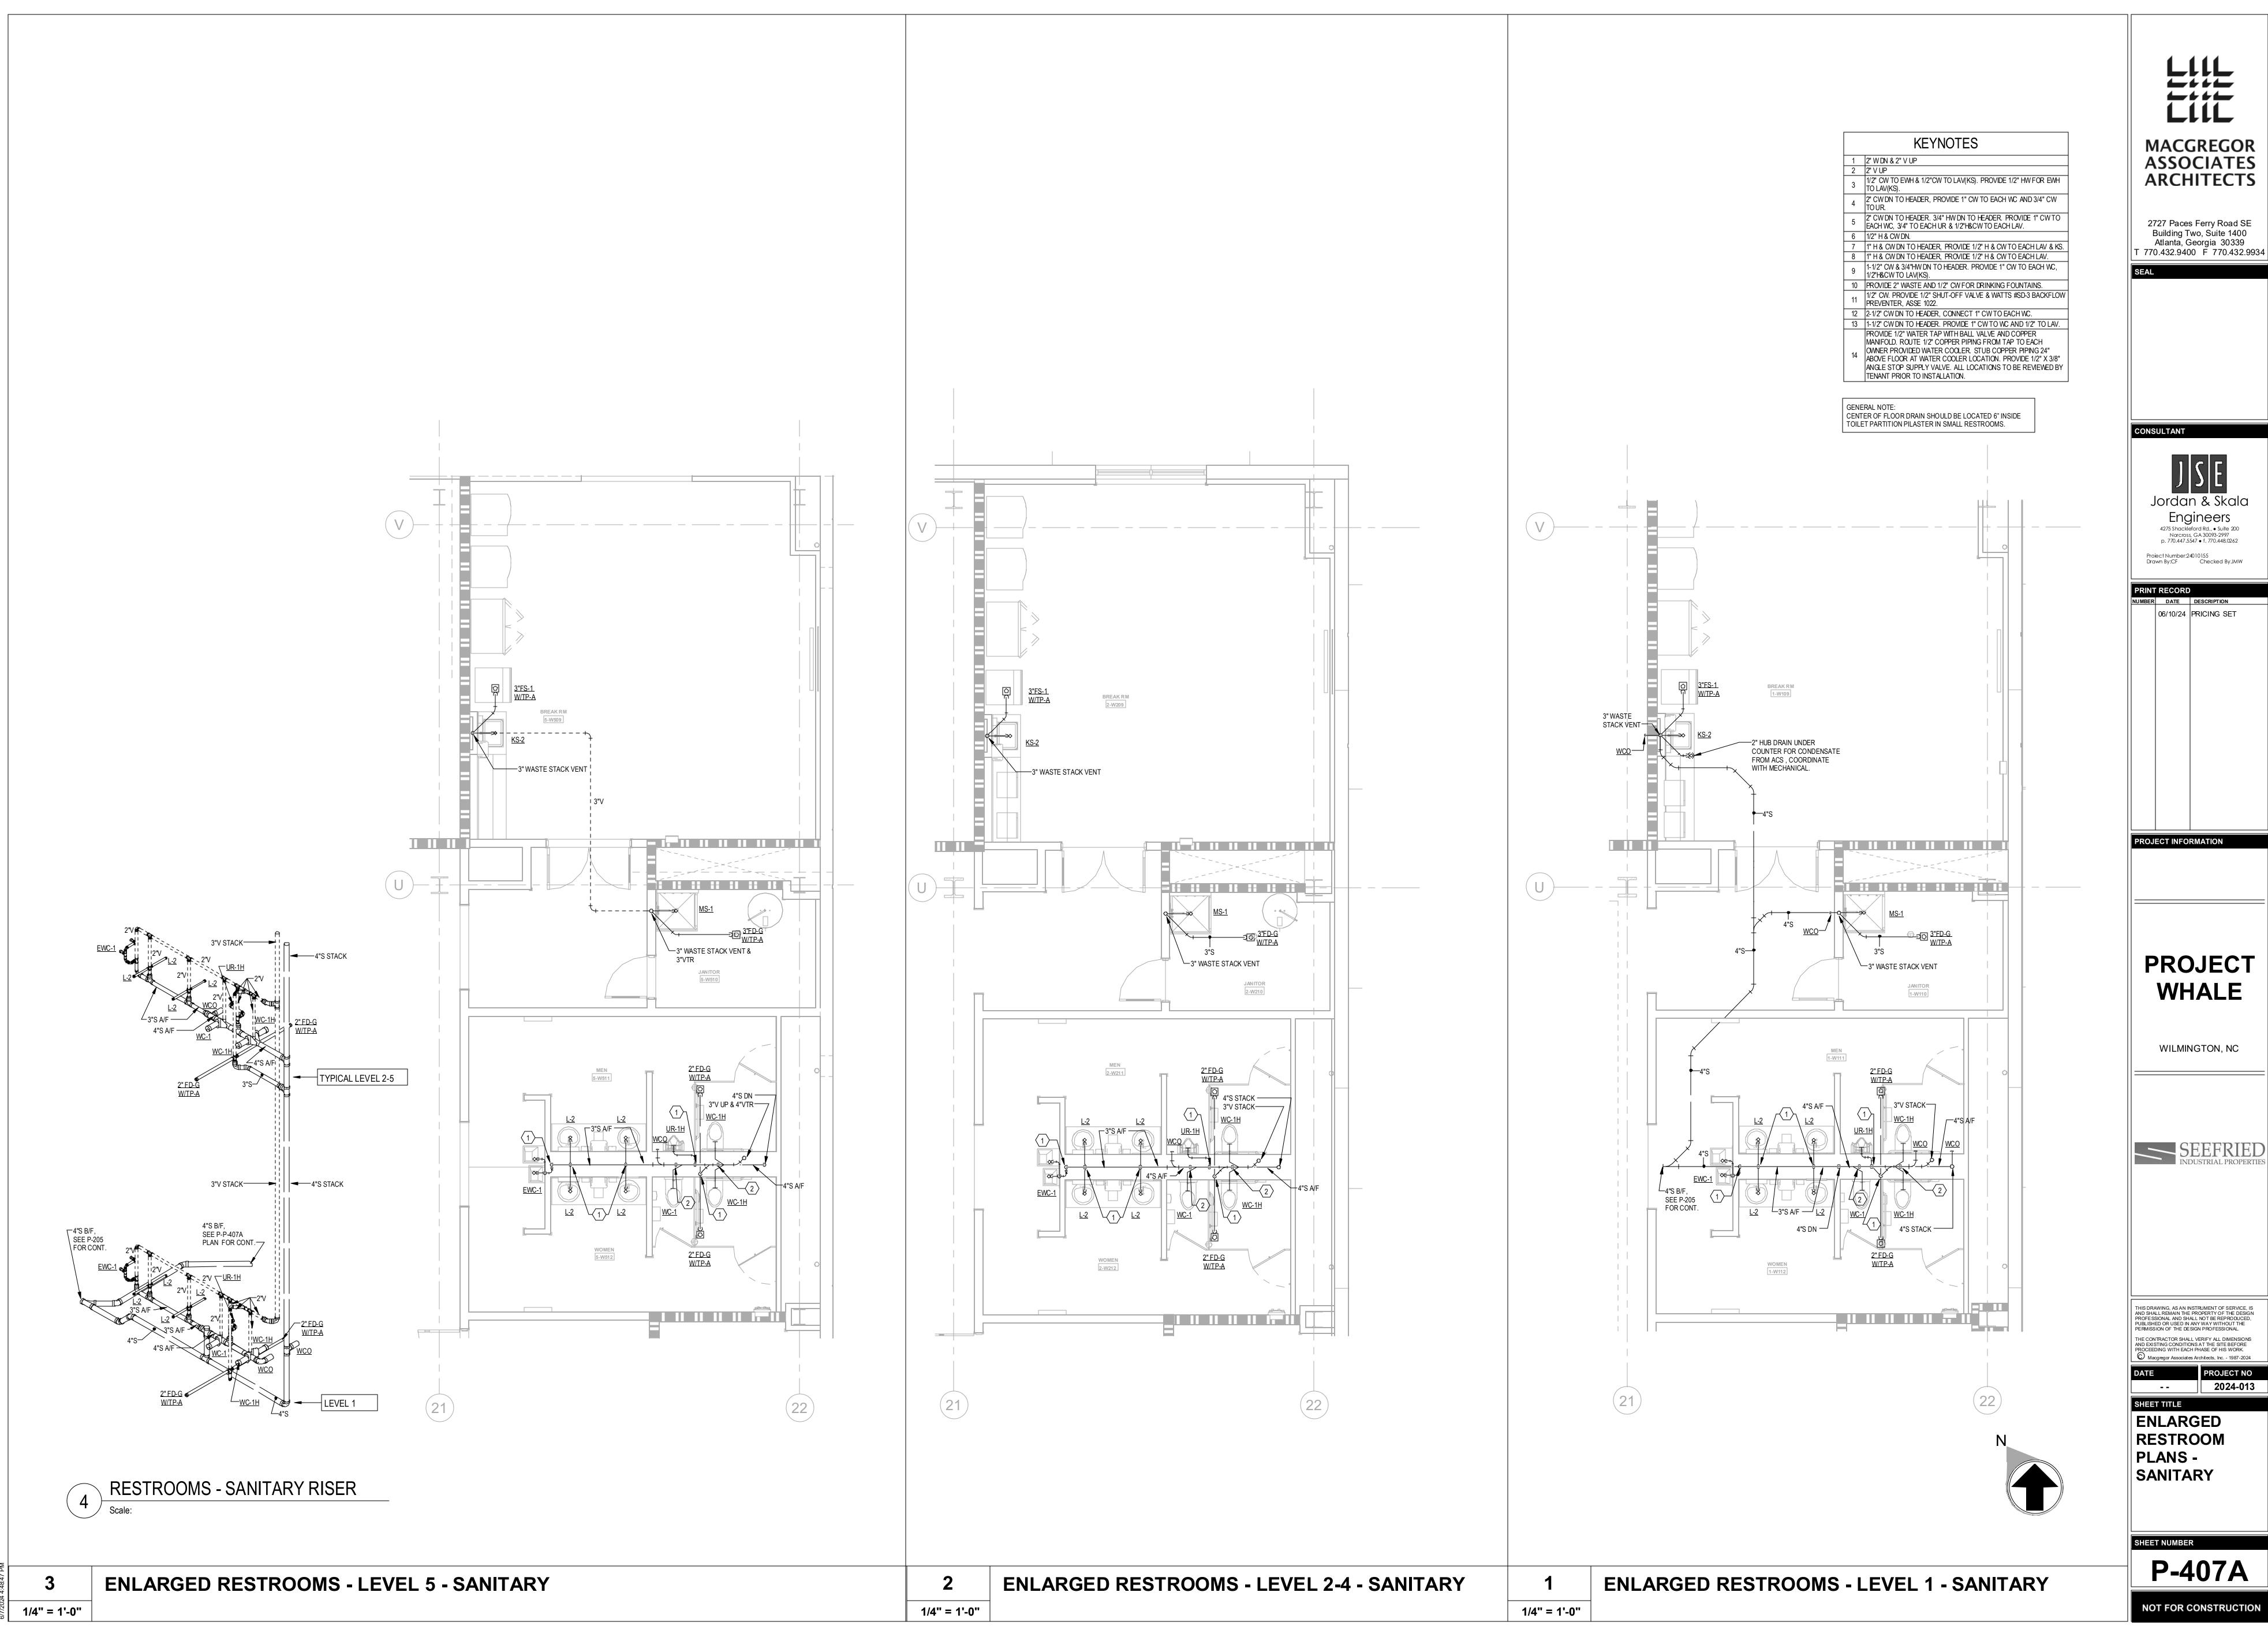
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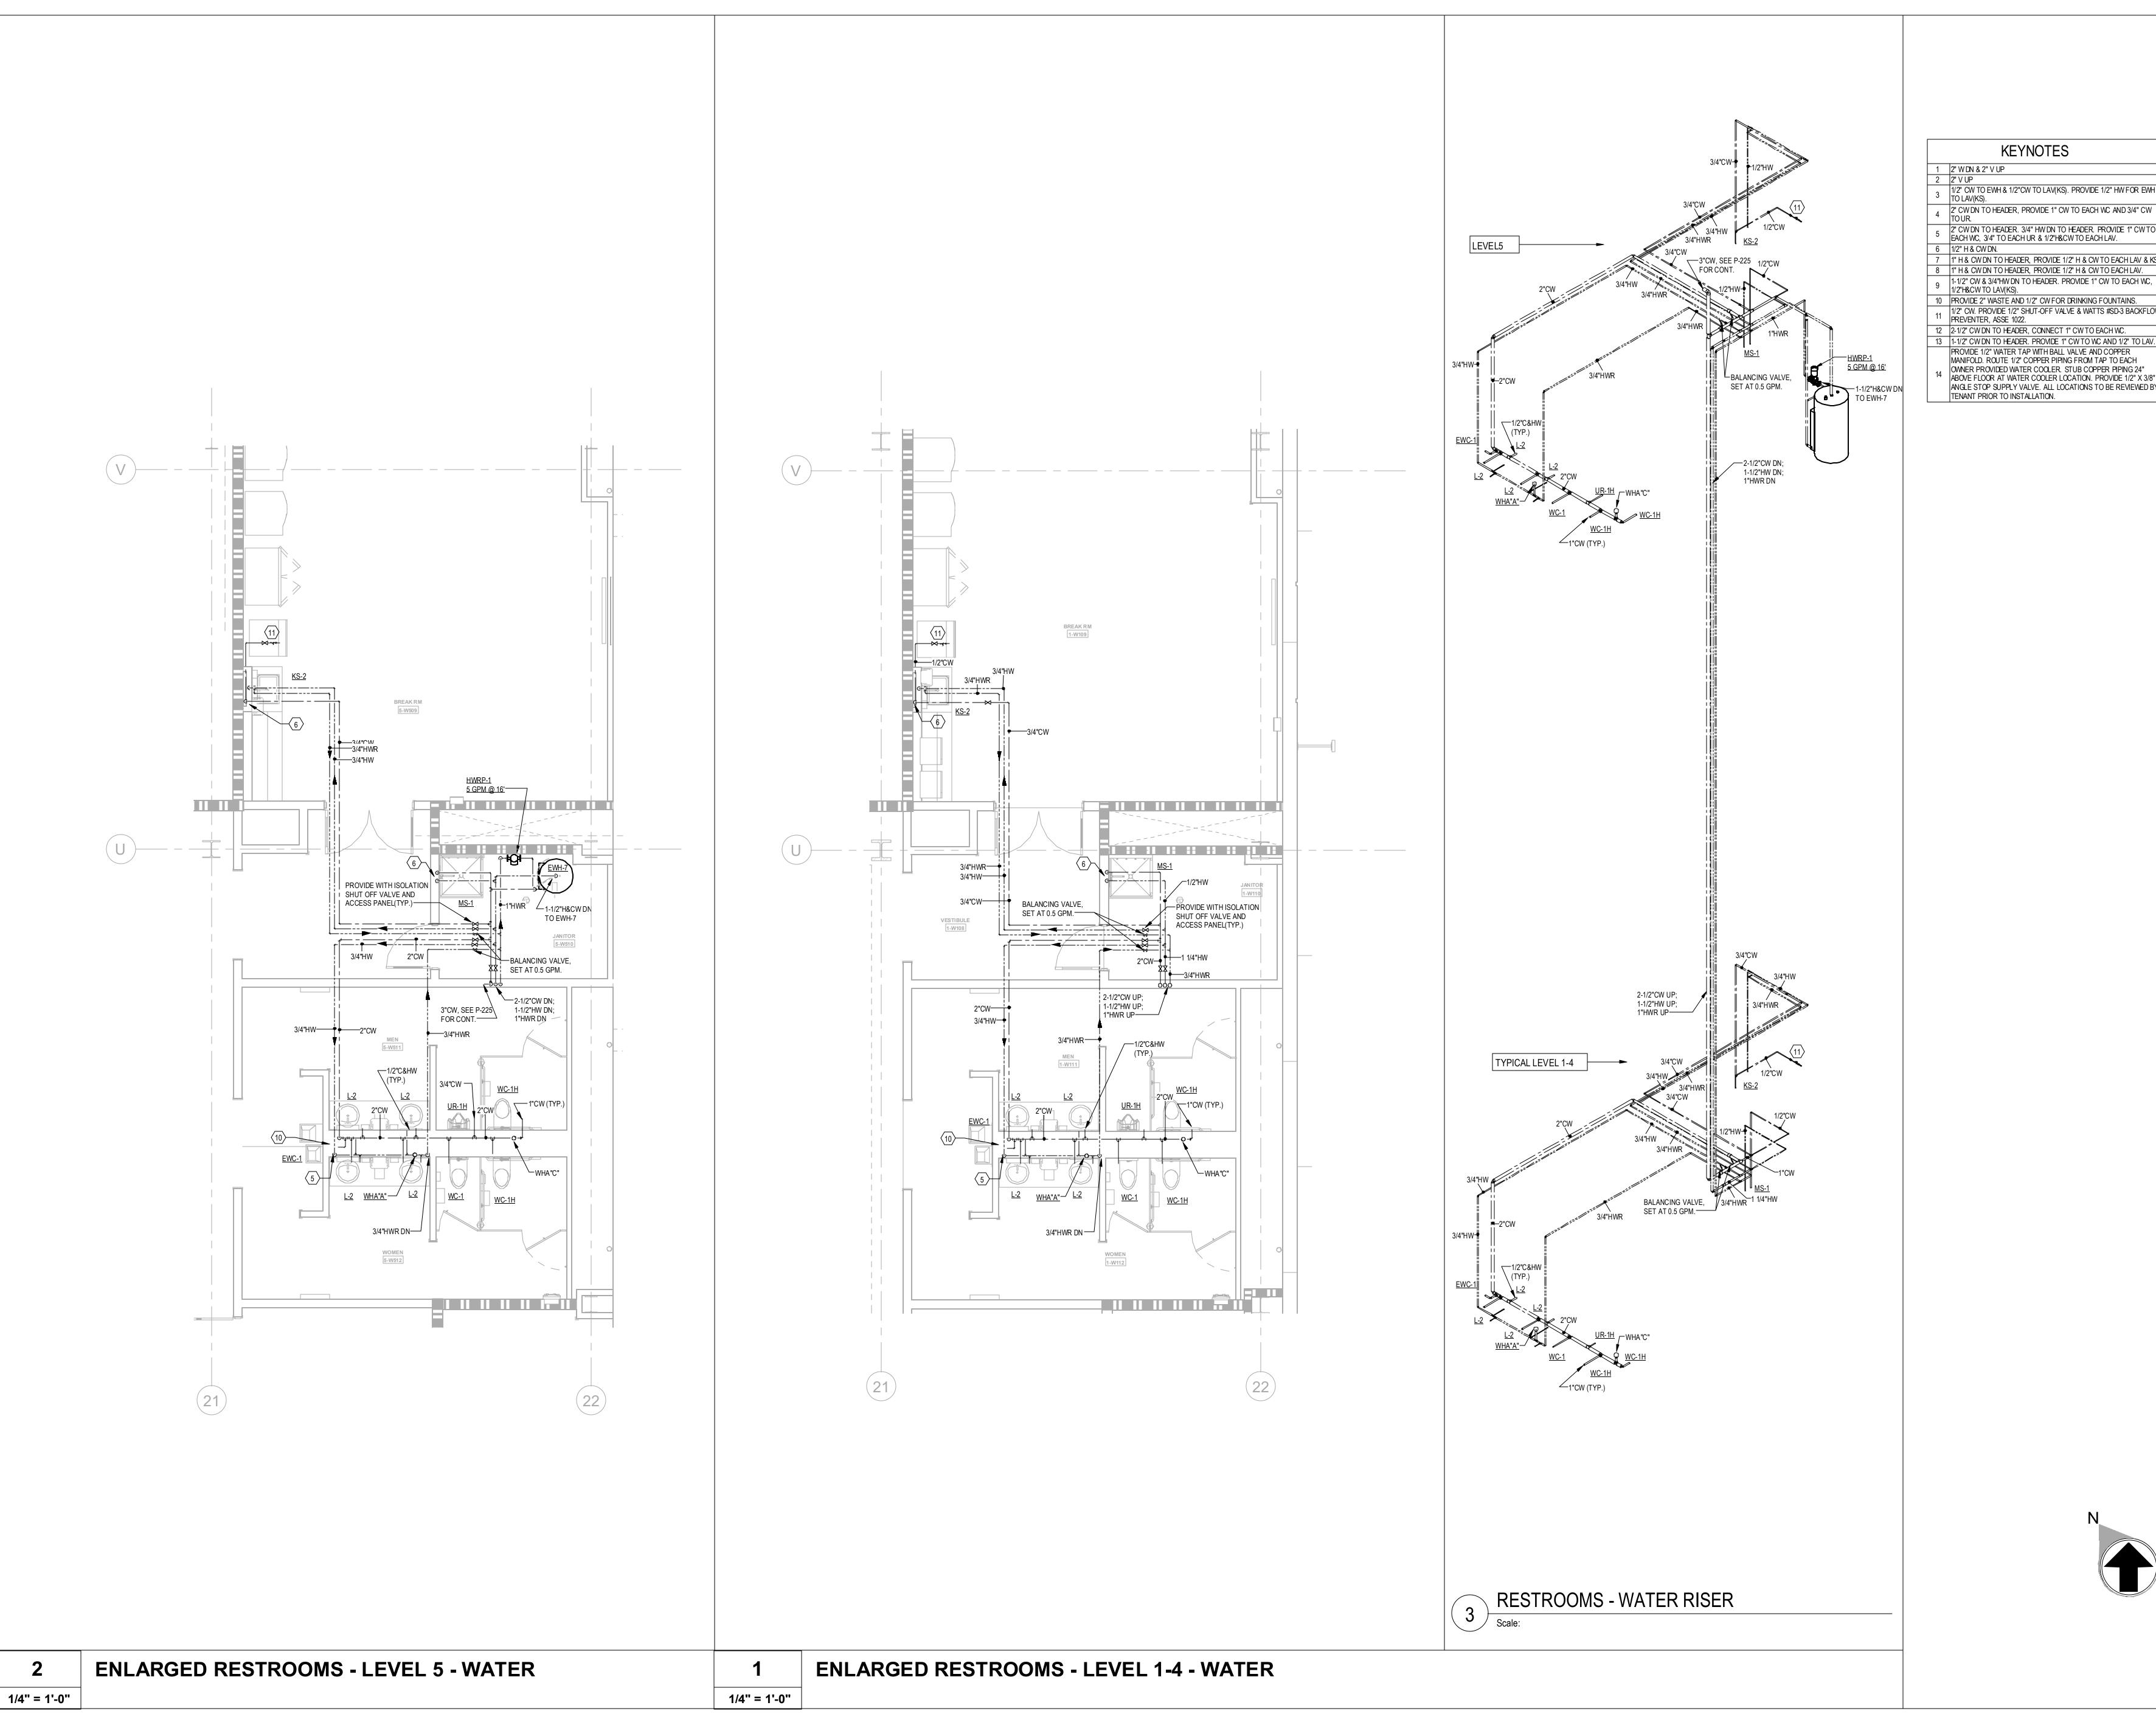
PROJECT NO 2024-013

ENLARGED
RESTROOM
PLANS - WATER

SHEET NUMBER

P-406B





- 1/2" CW TO EWH & 1/2"CW TO LAV(KS). PROVIDE 1/2" HW FOR EWH
- 5 2" CW DN TO HEADER. 3/4" HW DN TO HEADER. PROVIDE 1" CW TO EACH WC, 3/4" TO EACH UR & 1/2"H&CW TO EACH LAV.
- 1" H & CW DN TO HEADER, PROVIDE 1/2" H & CW TO EACH LAV & KS. 8 1" H & CW DN TO HEADER, PROVIDE 1/2" H & CW TO EACH LAV.
- 9 1-1/2" CW & 3/4"HW DN TO HEADER. PROVIDE 1" CW TO EACH WC, 1/2"H&CW TO LAV(KS).
- 10 PROVIDE 2" WASTE AND 1/2" CW FOR DRINKING FOUNTAINS. 1/2" CW. PROVIDE 1/2" SHUT-OFF VALVE & WATTS #SD-3 BACKFLOW PREVENTER, ASSE 1022.
- 12 2-1/2" CW DN TO HEADER, CONNECT 1" CW TO EACH WC.
- 13 1-1/2" CW DN TO HEADER. PROVIDE 1" CW TO WC AND 1/2" TO LAV. PROVIDE 1/2" WATER TAP WITH BALL VALVE AND COPPER MANIFOLD. ROUTE 1/2" COPPER PIPING FROM TAP TO EACH
- OWNER PROVIDED WATER COOLER. STUB COPPER PIPING 24" ABOVE FLOOR AT WATER COOLER LOCATION. PROVIDE 1/2" X 3/8" ANGLE STOP SUPPLY VALVE. ALL LOCATIONS TO BE REVIEWED BY TENANT PRIOR TO INSTALLATION.

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PROJECT INFORMATION

PROJECT WHALE

WILMINGTON, NC

PROJECT NO 2024-013

SHEET TITLE ENLARGED RESTROOM

PLANS - WATER

SHEET NUMBER P-407B

