


KEY MAP

SITE PLAN






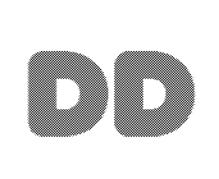

WILMINGTON INTERNATIONAL AIRPORT

1740 AIRPORT BLVD, WILMINGTON, NC 28405 BOARDING LEVEL, ZONE 1 SPACE: A,B,C

> 60% SUBMITTAL 06/23/2023

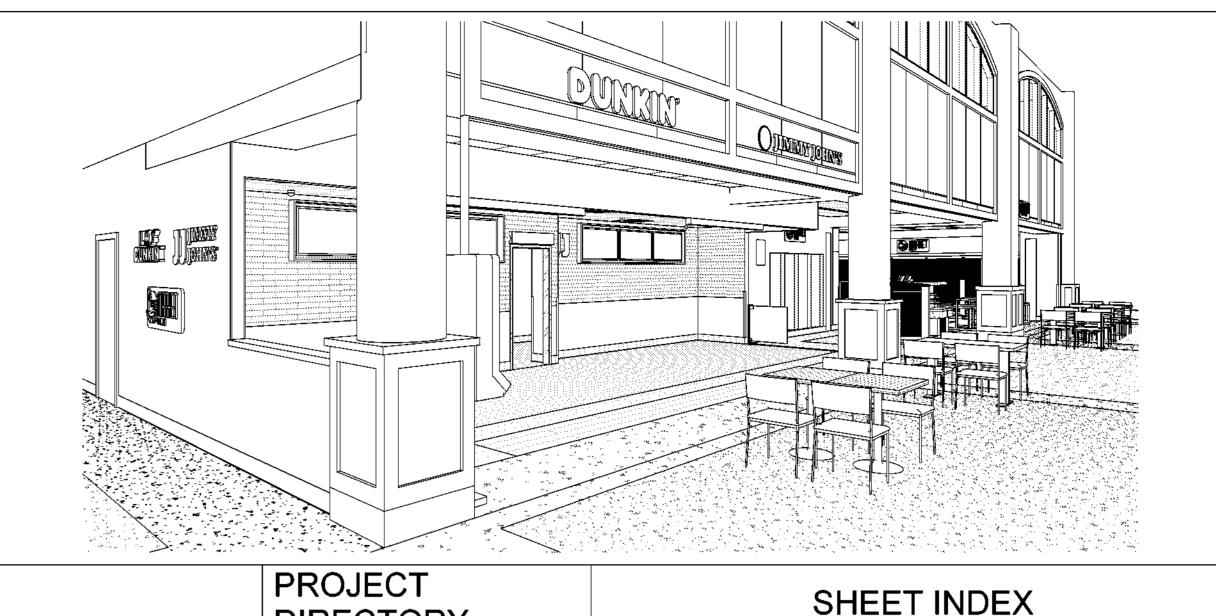

DESIGN ARCHITECTURE

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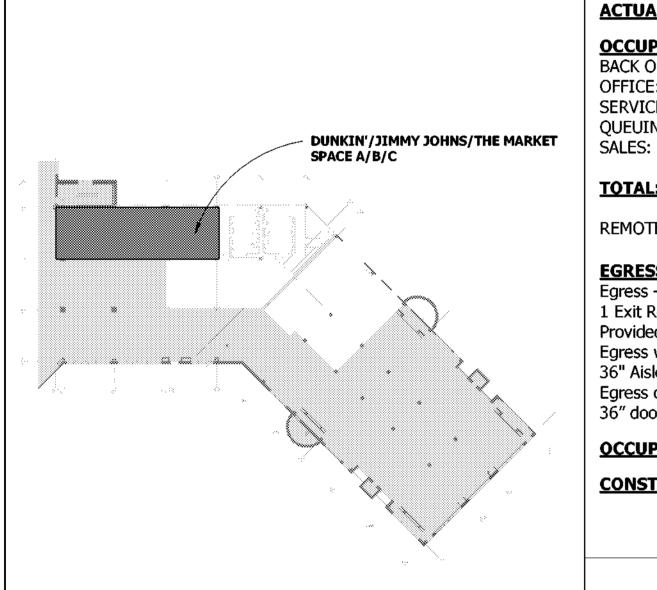
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Silhouette Design Architecture, Inc.

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MEP Design Engineer/Associate FSC MEP Engineers, LLC.



ACTUAL PROJECT AREA: 2,416 SQ. FT.

OCCUPANCY:

561 SF / 200 SF = 3 PERSONSBACK OF HOUSE: OFFICE: 52 SF / 150 SF = 1 PERSONS SERVICE: 412 SF / 200 SF = 3 PERSONSQUEUING: 236 SF / 60 SF = 4 PERSONS1070 SF / 60 SF = 18 PERSONS

PROJECT DATA

TOTAL: = 29 PERSONS

REMOTE STORAGE 1024 SF / 300 SF = 4 PERSONS

EGRESS

Egress – 1 Exit Required.

BUILDING CODE:

MECHANICAL CODE:

PLUMBING CODE:

ELECTRICAL CODE:

FUEL GAS CODE:

CONSERVATION

ACCESSIBILITY

FIRE CODE:

ENERGY

CODE:

CODE:

PROJECT

NORTH

TRUE

NORTH


Provided exits = 6 of 1 required. Egress width = 36" minimum, Openings > or = 36" 36" Aisles Provided

Egress capacity = .2" per occupant = 180 occupants per 36" door > 28 person occupancy load.

OCCUPANCY GROUP: B - Business

CONSTRUCTION TYPE: 1A - Fully Sprinkled

SCOPE OF WORK

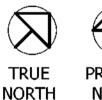

DUNKIN'/JIMMY JOHNS/THE MARKET

SPACE A/B/C

TRUE

NORTH

PROJECT



INTERIOR TENANT ALTERATION OF A RETAIL SPACE IN WILMINGTON INTERNATIONAL AIRPORT. WORK COMPROMISES OF NEW FINISHES, PARTITIONS, MILLWORK, LIGHTING, FOOD EQUIPMENT, AND INCLUDES MECHANICAL, ELECTRICAL, AND PLUMBING WORK.

APPLICABLE CODES

2018 NORTH CAROLINA STATE BUILDING

2018 NORTH CAROLINA STATE BUILDING

2018 NORTH CAROLINA STATE BUILDING

WITH NORTH CAROLINA AMMENDMENTS.

2018 NORTH CAROLINA STATE BUILDING

2018 NORTH CAROLINA STATE BUILDING

CONSERVATION CODE (IECC) WITH NORTH

2009 ICC/ANSI A-117.1 ACCESSIBLE AND

USABLE BUILDINGS AND FACILITIES 2009 OF

CODE: FIRE PREVENTION CODE

2018 INTERNATIONAL ENERGY

CAROLINA AMMENDMENTS.

NORTH CAROLINA WITHOUT

AMMENDMENTS.

CODE: EXISTING BUILDING CODE

CODE: MECHANICAL CODE

CODE: PLUMBING CODE

CODE: FUEL GAS CODE

(DRAIN) INSPECTION AND STORE OPENING. 9. INTERIOR FINISHES CLASSIFICATION INDICATED AS PER NFPA 101, 2018 EDITION AND IBC 2018.

ACCESSIBILITY NOTES

NOTES

1. ALL INSTALLATIONS, MATERIALS AND EQUIPMENT SHALL COMPLY WITH THE MOST

2. UTILITIES OUTAGES REQUIRE 72 HOURS ADVANCE NOTICE TO THE AIRPORT

3. FLOOR PENETRATIONS REQUIRE X-RAY AND APPROVAL PRIOR TO DRILLING OR

4. CONTRACTOR SHALL BE RESPONSIBLE FOR PROVIDING ILM WITH A SET OF AS-

BUILD DOCUMENTS. INCLUDES (1) HARD COPY AND DIGITAL COPY CONSISTENT

REFERENCED ON SHEET A0.2. A SET ON SITE FOR GENERAL ILM INSPECTION IS

WITH THE AIRPORT DRAWING MANUAL, OR REFER TO CLOSE-OUT DOCUMENTS AS

ILM REPRESENTATIVE "BEFORE" ANY PENETRATIONS ARE ALLOWED.

SUBMIT DIGITAL/CAD FORMAT AS BUILT DRAWINGS TO WILMINGTON

7. CONTRACTOR IS TOTALLY RESPONSIBLE FOR THE REMOVAL OF ANY

6. ALL FLOOR PENETRATIONS SHALL HAVE WATER PROOFING INSTALLED - 3'

DIAMETER FROM THE CENTER OF THE PENETRATIONS WHICHEVER GIVES THE

MAXIMUM SQUARE FOOTAGE OF THE WATER PROOFING AROUND PENETRATIONS.

ASBESTOS/HAZARDOUS WASTE. THE CONTRACTOR SHALL SUBMIT THE NECESSARY

DOCUMENTATION TO THE AIRPORT TENANT COORDINATOR FOR REVIEW AND OR

8. UNUSED/ABANDONED FLOOR/WALL OPENINGS SHALL BE SEALED OR FIRESTOPPED

CONTRACTOR SHALL MECHANICALLY SECURE ALL FLOOR DRAINS, EXCEPT FOR

INTERNATIONAL AIRPORT 6 WEEKS AFTER STORE IS OPEN.

THE BUILDING OR WORK PERMIT IS ISSUED.

ALL TIMES WHEN WORK IS TAKING PLACE.

ALSO REQUIRED.

APPROVAL.

CURRENT WILMINGTON INTERNATIONAL AIRPORT DESIGN MANUAL AT THE TIME

ENGINEERING DIVISION AND SIGNED COPY OF THE OUTAGE POSTED ON-SITE AT

CUTTING SLABS. PENETRATIONS OF THE FLOOR GREATER THAN 1 1/2" IN DEPTH

BFF REQUIRE X-RAY, REVIEW, AND ILM APPROVAL. ON-SITE PHYSICAL LAYOUT OF

SIZE AND LOCATION OF PENETRATIONS SHALL BE REVIEWED BY AN APPROPRIATE

- . THE PROJECT HAS BEEN DESIGNED TO CONFORM WITH THE ACCESSIBILITY REQUIREMENTS OF THE STATE OF NORTH CAROLINA AND THE AMERICANS WITH DISABILITIES ACT
- 2. MINIMUM DOOR WIDTH OF ACCESSIBLE DOORS MUST BE 36"
- 3. CLEARANCE ON THE PULL SIDE OF THE DOORS MUST BE A MINIMUM OF 18"
- 4. WHERE CONTROLS AND OPERATING MECHANISMS ARE PROVIDED IN ACCESSIBLE SPACES, ALONG ACCESSIBLE ROUTES OR AS PARTS OF ACCESSIBLE ELEMENTS, 2020 NATIONAL ELECTRICAL CODE, NFPA 70 OPERABLE PARTS AND CONTROLS SHALL COMPLY WITH THE REQUIREMENTS OF ADA SECTION 4.27 OPERABLE PARTS SHALL BE NO MORE THAN 48" HIGH OR LESS THAN 18" ABOVE THE FLOOR.
 - 5. WHERE ALARMS ARE PROVIDED THEY SHALL COMPLY WITHTHE REQUIREMENTS OF ADA
 - SECTION 4.27
 - 6. ACCESSIBLE SIGNAGE SHALL COMPLY WITH THE REQUIREMENTS OF THE SECTION A4.30 7. ALL EGRESS DOORS MUST SWING IN THE DIRECTION OF EGRESS AND SHALL NOT BE LOCKED FROM THE OPPOSITE SIDE OF EGRESS PASSAGE.

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TITLE SHEET **GENERAL NOTES & SPECIFICATIONS GENERAL NOTES & SPECIFICATIONS**

GENERAL NOTES & SPECIFICATIONS

DEMOLITION FLOOR PLAN

DEMOLITION REFLECTED CEILING PLAN CONSTRUCTION PLAN

REMOTE STORAGE CONSTRUCTION PLAN

REFLECTED CEILING PLAN REMOTE STORAGE RCP AND FFE PLANS

FF&E PLAN

SCHEDULES FLOOR FINISH PLAN AND SCHEDULE

REMOTE STORAGE FLOOR FINISH PLAN

SIGNAGE & GRAPHICS PLAN EMERGENCY EGRESS PLAN

ELEVATIONS

ELEVATIONS

ELEVATIONS

REMOTE STORAGE ELEVATIONS

DETAILS

EQUIPMENT PLAN

EQUIPMENT PLUMBING ROUGH-IN PLAN **EQUIPMENT ELECTRICAL ROUGH-IN PLAN**

SPECIAL CONDITIONS PLAN

PLUMBING WASTE AND VENT FLOOR PLAN - LOWER LEVEL

PLUMBING WASTE AND VENT FLOOR PLAN - BOARDING LEVEL

PLUMBING DOMESTIC WATER PLAN - BOARDING LEVEL

PLUMBING DETAILS PLUMBING SCHEDULES

PLUMBING DOMESTIC WATER RISER

PLUMBING SANITARY RISER

MEP LEGENDS AND SYMBOLS

MEP ROOF PLAN MECHANICAL DEMOLITION PLAN - BOARDING LEVEL

MECHANICAL NEW WORK PLAN - RAMP LEVEL

MECHANICAL FLOOR PLAN - BOARDING LEVEL

M500

MECHANICAL DETAILS

MECHANICAL SCHEDULES

DEMOLITION POWER & LIGHTING PLAN - RAMP LEVEL DEMOLITION POWER & LIGHTING PLAN - BOARDING LEVEL

POWER FLOOR PLAN - RAMP LEVEL

POWER FLOOR PLAN - BOARDING LEVEL

LIGHTING FLOOR PLAN - RAMP LEVEL

LIGHTING FLOOR PLAN - BOARDING LEVEL

ELECTRICAL DETAILS

ELECTRICAL SCHEDULES

ELECTRICAL SCHEDULES

TITLE SHEET

Project number 2023-019 03-29-2023 Drawn by BW Checked by

A0.0

Scale

The above drawings, specifications, ideas, designs and arrangements represented thereby are and shall remain the property of Silhouette Design Architecture, Inc. No part thereof shall be reproduced or disclosed to others, or used in the connection with any work or project other than the specified project for which they have been prepared. Written dimensions on these drawings shall have precedence over scaled dimensions: Contractors shall verify and be responsible for all dimensions and conditions on the job and this office must be notified of any variations form the dimensions and conditions shown by these drawings. Shop drawings must be submitted to this office for review before proceeding with fabrication. COPYRIGHT 2023 Scott Costello, AIA.



WILMINGTON INTERNATIONAL AIRPORT 1740 AIRPORT BLVD, WILMINGTON, NC, 28405 BOARDING LEVEL, ZONE 1 SPACE: A, B, AND C

Description

60% SUBMITTAL

Date

06/23/2023

As indicated

SPECIFICATIONS

SECTION 01000 - GENERAL REQUIREMENTS

- The Contractor shall obtain and pay for the Building Permit for the work. All work, including the material, stresses and methods of construction shall
- conform to Local and State codes. All work to be performed by Contractors licensed to work within the local Jurisdiction.
- Project Meetings: Contractor and related subcontractors shall be required to attend project meetings at the project site when required by the Owner or
- Submittals: Required shop drawings to tenant and architect, product data and samples shall be submitted to the Architect for approval. Any
- moneys spent or work performed without prior approval is done at the Contractors own risk. Submit shop drawings to architect in PDF format.
- Submit (3) three samples of the full range of required samples.
- Submit (3) three copies of project data.
- Shop Drawings, Samples and Product Data shall be required for the following items:
- All Finishes
- All Millwork including Wood Doors, Shelving and Cabinetry
- All Lighting
- All Appliances and equipment All Hardware
- Unless agreed to otherwise, all submittals shall be submitted no later than two weeks after construction starts. G.C. to submit schedule of submissions at start of construction.
- Examination of the Site. The Contractor shall examine the premises and become thoroughly familiar with all existing conditions, and all the conditions which may arise that would affect his contract. Failure to do so will not relieve the Contractor of his responsibility to complete his work at no additional cost to the Owner. Contractor shall notify the Architect immediately in writing if he discovers any discrepancies between the drawings and existing conditions.
- Existing Conditions: Before submitting his proposal, each bidder shall examine all drawings related to his, to the character of the Work required and its relations to other work in the building. No consideration will be granted for alleged misunderstanding of material to be furnished or work to be done, it being understood that the tender of a proposal carries with it the agreement to all items and conditions referred to herein. Special attention shall be made of the type and extent of removals, relocations, overtime needed for interruption of building services for disconnecting of existing and/or installation of new services, maintenance of, continuity of services, etc.
- The Contractor shall be responsible for properly laying out the Work and for lines and measurements for the Work. Verify all figures shown on
- drawings before laying out the Work and report inaccuracies of errors to the Architect before commencing the Work. The Contractor shall arrange for, provide and maintain temporary facilities and controls as required for the proper and expeditious prosecution of the
- Unless agreed upon, no signs or advertisements will be allowed to be displayed on the premises of the building.
- Heat and ventilation as required during construction may not be available for use until finish work begins, including floor finish, as same will be
- necessary to allow finishes to cure properly. Provide all required temporary heat and ventilation for proper protection of the work and the workers. Comply with all requirements of the Building management at no additional cost to the Owner.
- Contractor shall provide all temporary connections, lighting and distribution as required for the execution of the Work. Substitutions: Substitutions of items specified or shown on drawings will not be permitted unless approved in advance by the Architect.
- Materials, products and equipment shall be properly packaged and protected to prevent damage during transportation and handling. The Contractor
- shall be responsible for all unloading, rigging and installation of all materials and equipment. Available storage space at the job site is limited to the area of construction. Any additional off-site space required is the responsibility of the Contractor.
- Store and protect materials delivered to the site from damage. Do not use damaged materials at the site.
- Name plates and other identifying markings shall not be affixed on exposed surfaces of manufactured items installed in the finished spaces. Prevent accumulations of waste materials on site during the entire construction period. Remove crates, cartons and other flammable waste
- materials or trash from the work area each work day. 18. Care shall be taken by workmen not to mark, soil or otherwise deface finished surfaces. In the event that finished surfaces become defaced, clean and
- restore such surfaces to their original condition.
- Clean up immediately upon the completion of each trader's work and remove surplus materials and rubbish of every kind from the site. Before commencing any alteration or demolition Work, submit a schedule showing the commencement, the order and the completion dates for the
- various parts of this work, for review by the Architect.
- Before starting any work relating to the existing utilities (electrical, sewer, water, heat, gas, fire lanes, etc.) that will temporarily discontinue or disrupt service within the building, notify the building management and obtain approval in writing before proceeding with this phase of the Work.
- Take necessary precautions to prevent dust from rising. Protect unaltered portions of the existing building affected by the operations under this Section by dustproof partitions and other adequate means.
- Immediately clean all dust and debris related to deliveries or construction which occurs in the Public Corridors or other building areas.
- Do not close or obstruct walkways, passageways or stairways. Do not store or place materials in passageways, stairs or other means of egress. Conduct operations with minimum traffic interference.
- The Contractor shall be responsible for any damage to the existing structure or contents by reason of the insufficiency of protection provided. Execute the work in a careful manner and orderly manner, with the least possible disturbance to the public and to the occupants of the building.
- Where alterations occur, or new and old work join, cut, remove, patch, repair or refinish the adjacent surfaces or so much thereof as is required by the involved conditions, and leave in as good condition as existed prior to the commencing of the work. The materials and workmanship, unless otherwise shown or specified, shall comply with that of the original work. Alteration work shall be performed by the
- various respective trades which normally perform the particular items of work. Finish new and adjacent existing surfaces as specified for new work. Clean existing surfaces of dirt, grease, loose paint, etc., before refinishing.
- Provide any temporary protection required to adequately protect the adjoining property, the public and construction personnel. Provide locked
- entrances. Prevent intrusion to job site by those not permitted. Contractor shall post all applicable building permits in a visible location ready for inspection by the proper authorities having jurisdiction.
- Contractor shall be responsible for any and all traffic violations due to his operation and misuse of streets and sidewalk surrounding the "Area of Work".
- No alcoholic beverages or smoking will be allowed within the demised premise. Contractor shall be responsible to enforce same on all subcontractors and subordinate subcontractors. "General Conditions of the Contract for Construction" A.I.A. Document A-201, 2017 edition, of the American Institute of Architects, referred to in the
- Contract Documents as the General Conditions, together with the following articles of the Supplementary General Conditions, which amend, modify and supplement various articles and provisions of the General Conditions are made part of the Contract and shall apply to all Work under the Contract. All articles or parts of articles of the General Conditions not so amended, modified or supplemented by these Supplementary General Conditions, shall remain in full force and effect. Should any discrepancy become apparent between the General Conditions and the Supplementary General Conditions, the latter shall be given and take precedence.
- The Contractor shall guarantee all work, including labor, materials and equipment, for one (1) year from date of completion of the Project. All work shall be installed in accordance with the Contract Documents, Manufacturer's instructions and highest quality trade standards, unless more stringent. Where the Contractor is required by the Drawings or Specifications to install Owner furnished items, the Contractor shall unload safely, store, protect, assemble, install and connect such items.
- Work and Items Supplies By Others: As Noted
- Report evidence of overstress, deterioration, and damage that is found or that occurs during the Work. Report conditions that cannot be
- accommodated by ordinary means without design changes. Obtain the Architect's direction before proceeding with affected work. Substrate Preparation for Finishing: Repair, clean and recondition existing surfaces so that successful refinishing does not require additional
- preparation beyond that specified in Product Sections.
- Schedule The Contractor shall submit Progress Schedule, in easy-to-read graphic form, at the Preconstruction Conference. Show beginning date and Final Completion Date. Show beginning and completion dates for major elements of the Work. Break down major elements to define critical parts. Show dates of Contractor submittals and periods allotted for review by Architect. Update and show all changes, including percentage completion, major changes in scope, modified activities, revised projections of progress and completion, and other identifiable changes. Submit a revised copy at each Progress Meeting. Show dates for receipt of Owner supplied items and services.
- Schedule of Values: Submit in ample time for review, revision and resubmission before the first application for payment.
- Contractor shall maintain Project Record Documents and collect one copy each of the following documents and label each one PROJECT RECORD, as
 - Drawings, Specifications and Addenda.
 - Change Orders, and other Modifications. Architect's Field Orders and any written instructions.
- Field Test Records.
- Project Meeting Minutes.
- Progress Schedule. Submittals, shop drawings and cut sheets.
- Keep Record Documents in Contractor's Field Office, separate from documents used for construction and available for Architect's inspection. Mark Record Drawings, Specifications and Addenda neatly and legibly, with colored pencil or felt tip marker, to show actual construction and products used. Keep record current with construction progress; do not cover up Work until required information is recorded.
- Close-out Submittals Before applying for final payment, the Contractor shall submit:
 - Completion Notice and all Certificates of Inspections and other evidence of compliance with regulatory agency requirements. Evidence of payments and release of liens in accord with Conditions of the Contract.
 - Certificate of Insurance for Products and Completed Operations.
- Project Record Documents. Extra stock, spare parts, maintenance materials, keys and special tools required by Product Sections.
- Warranties, services/maintenance contracts, and manuals required by Product Sections. As-Built Drawings
- Other documents as required by the local jurisdiction at time of project closeout. General Contractor shall provide list of all Subcontractors to Owner's Representative and Tenant's Representative.
- General Contractor shall provide and install Fire Extinguishers as required by Code. Locations to be verified. General Contractor is to turn over the space to the owner in a clean condition which includes dusting, high dusting and general cleaning.
- 46. Insurance: all contractors (general and subcontractors) shall comply with local municipality and owner's requirement for insurance, bonds and waivers
 - Prior to commencement of the work, all contractors and subcontractors shall obtain insurance policies as outlined below. Insurance policies are to name the owner, owner's architect (silhouette design architecture, inc.), the architect's consultants (as listed on the title sheet), the landlord and the landlord's general contractor (if applicable) as additionally insured. Certificates of insurance shall be submitted
 - to those named. Workman's compensation and occupational disease insurance.

fabrication. COPYRIGHT 2023 Scott Costello, AIA.

- applicable federal (e.g.: longshoremen, harbor work, work outside the united states):- statutory-Employer's liability: \$500,000.00 per accident, \$500,000.00 disease
- Benefits required by union labor contracts as applicable
- Comprehensive general liability (including premises operations: independent contractors' protective; products and completed operations: broad form property damage; automobile coverage, and contractual liability.)

evidence of such coverage to owner on an annual basis during the aforementioned period.

- Bodily injury: \$3,000,000 each occurrence, \$3,000,000 aggregate
- Property damage (including water damage and sprinkler leakage, legal liability). \$3,000,000 each occurrence, \$3,000,000 aggregate.

Products and completed operations shall be maintained for a minimum of one (1 year after final payment and contractor shall continue to provide

- Property damage liability insurance shall include coverage for explosion and collapse.
- Contractual liability (hold harmless coverage): Bodily injury: \$2,000,000 each occurrence, Property damage: \$2,000,000 each occurrence \$2,000,000 aggregate Personal injury (with employment exclusion deleted): (G.C. to verify amt. Required w/ owner) each person
- Comprehensive automobile liability (owned, non-owned, hired): Bodily injury: \$2,000,000 each person, \$2,000,000 each accident, Property damage:
- \$2,000,000 each occurrence Other insurance and bonds as may be required by the owner verify requirements with the owner).

DIVISION 02: Site Work:

- Refer to the architectural drawings for any notes related to demolition work.
- The General Contractor is to demolish and remove from the premises in a manner acceptable to any jurisdictional agencies, the owner and the approval of the architect, all work so indicated or required by the work of the contract documents or as may be directed in the field by the architect. The work which is to be removed shall include any existing construction, furnishings, equipment or finishes not to remain in the completed work.
- Layout work:
 - General Contractor shall locate all existing utility service lines and protect them throughout the construction period. General Contractor shall lay out work and be responsible for all lines, elevations, measurements of the building utilities, and other work executed under the contract.
 - General Contractor shall verify all dimensions as they may apply to existing conditions with particular emphasis on dimensions marked "verify" or verify in field (V.I.F.) notify architect and owner immediately of any discrepancies between the drawings and existing conditions in
 - Any discrepancies, errors, or omissions discovered in the contract documents by the contractor shall be brought to the attention of the architect and owner before proceeding with related work, Otherwise, the correction of such items will be the responsibility of the contractor.

Division 03: Concrete Work:

- General Contractor shall be responsible for a smooth transition between floors and adjacent floors/public walks. The floor may require latex feathering or, where possible, grinding down of subfloor to allow for a smooth transition, if floor grinding is not permitted by owner, contact architect.
- Concrete work shall conform to the currently adopted ACI 318, building code requirements for reinforced concrete; ACI 301 specifications for structural concrete for buildings; ACI 302.1r, guide for concrete floor and slab construction.
- Ultimate compressive strength of Portland cement concrete, standard weight at twenty eight days shall be 4000 psi for slab on grade, and 3000 psi for all other concrete work. Design and submittal for concrete mix shall be in accordance with ACI 318, chapter 5 and ACI 301, chapter 3 and shall be submitted in advance to structural engineer for approval.
- Air entrained concrete shall be used for all concrete exposed to weather, except as noted in the drawings. Calcium chloride and/or admixtures containing calcium chloride shall not be included in concrete mix.
- Concrete contractor shall not pour concrete in adverse weather conditions or when such forecast for the time period following the pour, unless proper curing and protection is provided continuously until concrete develops its design strength.
- Unless otherwise noted, principle reinforcement shall have the following concrete protection: Forward surfaces in contact with soil or water, or exposed to weather --- 2 inches
- Formed surfaces not in contact with soil or water or exposed to weather --- 3/4 inch
- Concrete Floors Concrete floors to be properly prepared without holes, cracks, and bumps to insure a smooth and level floor installation. Provide concrete sealer as indicated on drawings. Follow manufacturer's instructions for floor preparation. Test concrete to verify if acid surface preparation is required prior to applying sealer. Allow sealer to dry at least 24 hours (or manufacturer's specified drying time) before subjecting to

Division 04: Masonry: NOT USED

<u>Division 05: Metals:</u> Refer to the structural drawings for specifications related to structural metal work

- General: Shear and punch metals cleanly and accurately. Remove burrs and ease exposed edges. Form bent-metal corners to smallest radius possible without impairing work.
- Welding: Weld corners and seams continuously. Use materials and methods that minimize distortion and develop strength and corrosion resistance of base
- metals. At exposed connections, finish welds and surfaces smooth with contour of welded surface matching those adjacent. Hot-dip galvanize steel fabrications at exterior locations.
- Prepare uncoated ferrous metal surfaces to comply with SSPC-SP 3, "Power Tool Cleaning," and paint with a fast-curing, lead- and chromate-free, universal modified-alkyd primer complying with MPI#79.
- Perform cutting, drilling, and fitting required for installing miscellaneous metal fabrications. Set metal fabrication accurately in location, alignment, and elevation; with edges and surfaces level, plumb, true, and free of rack.
- Fit exposed connections accurately together to form hairline joints. Setting: Nonshrink, Nonmetallic Grout: ASTM C 1107; recommended by manufacturer for exterior applications as required. Coat concealed surfaces of aluminum that will come into contact with grout, concrete, masonry, wood, or dissimilar metals with a heavy coat of bituminous

SECTION 06200 - Finish Carpentry:

- Scope of work includes, but is not limited to, rough carpentry (wood blocking) and finish carpentry (cabinetry, wood trim, hardware and accessories).
- Rough carpentry: wood blocking Provide solid blocking in stud walls where all fixtures or devices are to be mounted. All wood blocking shall be fire resistant treated. All dimensional lumber to be fire retardant with U.L. rating "non-combustible."
- All dimensional lumber, blocking & nailers to be fire retardant. All finished lumber to be rift-cut Douglas fire retardant where necessary. Utility grade boards to
- Plywood and MDF plywood for general interior carpentry shall be 3/4" APA trademarked, c-d plugged, UL labeled class a, fire-retardant treated, exposure 1 panels complying with ps-1. Provide treatment that yields a flame spread rating of not more than 25 when tested according to ASTM E84. Kiln dry afte
- Wood shall be seasoned to a 19% moisture content.

treatment to moisture content of 15% maximum.

- The G.C. shall install blocking as necessary for attachment of all interior trim & fixtures. Finish carpentry: cabinetry, and wood trim:
- All millwork shall comply with the appropriate specifications of "the architectural quality standards illustrated" of the American woodwork institute (AWI) for "custom" grade millwork.
- Stain grade finish lumber shall be `Douglas fir' sanded smooth and free of blemishes or abrasions. All wood shall have tight and uniform joints.
- Millwork contractor shall verify all dimensions affecting his work in the field prior to fabrication. Fixture millwork as noted on drawings is supplied and installed by tenant General Contractor, unless otherwise noted.

Where blind fastenings is impossible, drill holes uniformly, set and putty heads and finish as applicable to surface.

- Some field assembly of millwork is required. Follow shop drawing accompanying millwork. All field assembled millwork to be scribed and joined accurately.
- Installation to be in accordance with manufacturer's shop drawings. Make all joints inconspicuous maintaining a uniform flush connection using combination of screws, dowels and glue. Blind fasten where possible.
- All stain finish wood trim to be custom grade species as noted in drawings. Sanded with tight joints, scraped horizontal, glued, and nailed. No butt
- Intumescent coating to be American Fire Coatings, Inc., FC No.166. Apply to untreated wood finishes, following manufacturer's recommendations, must be performed off site, certificate stickers shall be required to be placed on all application locations.
- Grommets and access holes: provide 2" black plastic grommets at countertops and trough the sides of finished faces of millwork at each POS/Cash register
- location unless otherwise noted. Provide grommets in countertops when power is below counter height for above counter equipment. GC shall coordinate locations with subcontractors and owner's vendors for shop cut grommet holes or be prepared to field cut grommets.

SECTION 064116 - PLASTIC-LAMINATE-CLAD ARCHITECTURAL MILLWORK AND CABINETS

- Section Includes:
- Plastic-laminate-clad architectural cabinets.

that treated materials comply with requirements.

- Plastic-laminate-clad banquette seating.
- Cabinet hardware and accessories. Wood furring, blocking, shims, and hanging strips for installing plastic-laminate-clad architectural cabinets that are not concealed within other
- Retain subparagraphs below to cross-reference requirements Contractor might expect to find in this Section but are specified in other Sections. Coordinate sizes and locations of framing, blocking, furring, reinforcements, and other related units of Work specified in other Sections to support
- loads imposed by installed and fully loaded cabinets. Product Data: For each type of product. Include data for fire-retardant treatment from chemical-treatment manufacturer and certification by treating plant
- Sustainable Product Data: For recycled content, indicating postconsumer and preconsumer recycled content and cost. Product Certificates: For regional materials, indicating location of material manufacturer and point of extraction, harvest, or recovery for each raw material. Include distance to Project and cost for each regional material.
- Product Certificates: For regional materials, indicating location of material manufacturer and point of extraction, harvest, or recovery for each raw material. Include distance to Project, means of transportation, and cost for each regional material.
- Environmental Product Declaration (EPD): For each product. Product Data: For adhesives, indicating that product contains no urea formaldehyde.

The above drawings, specifications, ideas, designs and arrangements represented thereby are and shall remain the property of Silhouette Design Architecture, Inc. No part thereof shall be reproduced or disclosed to others, or used in the connection with any work or project other than the specified project for which they have been prepared.

- Shop Drawings: Include plans, elevations, sections, and attachment details.
- Show large-scale details.
- Indicate locations and sizes of furring, blocking, and hanging strips, including concealed blocking and reinforcement specified in other Sections. Indicate locations and sizes of cutouts and holes for items installed in plastic-laminate architectural cabinets.

Written dimensions on these drawings shall have precedence over scaled dimensions: Contractors shall verify and be responsible for all dimensions and conditions on the job and this office must be notified of any variations form the dimensions and conditions shown by these drawings. Shop drawings must be submitted to this office for review before proceeding with

- Samples: For each exposed product and for each color and texture specified, in manufacturer's or manufacturer's standard size. Product Certificates: For
- High-pressure decorative laminate.
- Adhesives. Evaluation Reports: For fire-retardant-treated materials, from ICC-ES.
- Manufacturer's Qualifications: Employs skilled workers who custom fabricate products similar to those required for this Project and whose products have a
- Do not deliver cabinets until painting and similar finish operations that might damage architectural cabinets have been completed in installation areas. Store cabinets in installation areas or in areas where environmental conditions comply with requirements specified in "Field Conditions" Article. Environmental Limitations without Humidity Control: Do not deliver or install cabinets until building is enclosed, wet-work is complete, and HVAC system is operating and maintaining temperature and relative humidity at levels planned for building occupants during the remainder of the construction period.
- Field Measurements: Where cabinets are indicated to fit to other construction, verify dimensions of other construction by field measurements before fabrication, and indicate measurements on Shop Drawings. Coordinate fabrication schedule with construction progress to avoid delaying the Work. Locate concealed framing, blocking, and reinforcements that support cabinets by field measurements before being enclosed/concealed by construction, and indicate measurements on Shop Drawings.

- Established Dimensions: Where cabinets are indicated to fit to other construction, establish dimensions for areas where cabinets are to fit. Provide allowance for trimming at site, and coordinate construction to ensure that actual dimensions correspond to established dimensions.
- Quality Standard: Unless otherwise indicated, comply with the Architectural Woodwork Standards for grades of cabinets indicated for construction, finishes, installation, and other requirements.
- Architectural Woodwork Standards Grade: Custom. Provide labels and certificates from AWI certification program indicating that woodwork
- complies with requirements of grades specified.
- Regional Materials: Wood products shall be manufactured within 500 miles (800 km) of Project site from materials that have been extracted, harvested, or
- recovered, as well as manufactured, within 500 miles (800 km) of Project site.
- Certified Wood: Wood products shall be certified as "FSC Mixed Credit" in accordance with FSC STD-01-001 and FSC STD-40-004.
- Type of Construction: See Drawings
- Door and Drawer-Front Style: See Drawings High-Pressure Decorative Laminate: NEMA LD 3, grades as indicated or if not indicated, as required by quality standard.
- See Finish Schedule for specified Laminates.
- Laminate Cladding for Exposed Surfaces: Horizontal Surfaces: Grade HGS
- Vertical Surfaces: Grade HGS Edges: ABS/PVC extruded fabrication. Pattern Direction: As indicated
- Surfaces Other Than Drawer Bodies: High-pressure decorative laminate, NEMA LD 3, Grade VGS. Edges of Plastic-Laminate Shelves: ABS/PVC extruded fabrication.
- Edges of Thermally Fused Laminate Panel Shelves: ABS/PVC extruded fabrication. Drawer Sides and Backs: Thermally fused laminate panels with ABS/PVC extrusion edge banding.
- Drawer Bottoms: Thermally fused laminate panels Dust Panels: 1/4-inch (6.4-mm) plywood or tempered hardboard above compartments and drawers unless located directly under tops. Drawer Construction: Fabricate with exposed fronts fastened to subfront with mounting screws from interior of body.
- Join subfronts, backs, and sides with glued rabbeted joints supplemented by mechanical fasteners. Colors, Patterns, and Finishes: Provide materials and products that result in colors and textures of exposed laminate surfaces complying with the
- Fire-Retardant-Treated Materials, General: Where fire-retardant-treated materials are indicated, use materials that are acceptable to authorities having jurisdiction and with fire-test-response characteristics specified as determined by testing identical products in accordance with test method indicated by a
- Use treated materials that comply with requirements of referenced quality standard. Do not use materials that are warped, discolored, or otherwise defective. Use fire-retardant-treatment formulations that do not bleed through or otherwise adversely affect finishes. Do not use colorants to distinguish
- treated materials from untreated materials. Identify fire-retardant-treated materials with appropriate classification marking of qualified testing agency in the form of removable paper label or imprint on surfaces that will be concealed from view after installation.

Fire-Retardant-Treated Lumber and Plywood: Products with a flame-spread index of 25 or less when tested in accordance with ASTM E84, with no

- evidence of significant progressive combustion when the test is extended an additional 20 minutes, and with the flame front not extending more than 10.5 ft. (3.2 m) beyond the centerline of the burners at any time during the test.
- Kiln-dry lumber and plywood after treatment to a maximum moisture content of 19 and 15 percent, respectively. For items indicated to receive a stained or natural finish, use organic resin chemical formulation. Mill lumber after treatment within limits set for wood removal that do not affect listed fire-test-response characteristics, using a woodworking
- shop certified by testing and inspecting agency. Mill lumber before treatment and implement procedures during treatment and drying processes that prevent lumber from warping and developing
- Fire-Retardant Fiberboard: MDF panels complying with ANSI A208.2, made from softwood fibers, synthetic resins, and fire retardant chemicals mixed together at time of panel manufacture to achieve flame-spread index of 25 or less and smoke-developed index of 200 or less in accordance with ASTM E84.

discolorations from drying sticks or other causes, marring, and other defects affecting appearance of architectural cabinets.

- Provide cabinet hardware and accessory materials associated with architectural cabinets. Manufacturers: Subject to compliance with requirements, provide products by one of the following:
- Accuride International.

Materials for Semiexposed Surfaces:

following requirements:

- Blum, Julius & Co., Inc.
- CompX International, Inc. Grass America Inc. Hardware Resources.
- Hettich America L.P. Knape & Vogt Manufacturing Company.

As specified in Finish Schedule in the drawings.

- BB. Continuous Piano Hinges for Cabinet Doors.
- Semiconcealed Hinges for Overlay Doors: ANSI/BHMA A156.9, B01521. Back-Mounted Pulls: ANSI/BHMA A156.9, B02011.
- DD. Cabinet Pulls: See Drawings Catches: Magnetic catches, ANSI/BHMA A156.9, B03141

Semiconcealed Hinges for Flush Doors: ANSI/BHMA A156.9, B01361.

- Adjustable Shelf Standards and Supports: ANSI/BHMA A156.9, B04071; with shelf rests, Shelf Rests: ANSI/BHMA A156.9, B04013; metal HH. Drawer Slides: ANSI/BHMA A156.9.
- Heavy-Duty (Grade 1HD-100 and Grade 1HD-200): Side mount Type: **Full** extension.
- Material: Stainless steel slides. Motion Feature: **Push to open** and **Soft close dampener**.
- Slides for Sliding Glass Doors: ANSI/BHMA A156.9, B07063; Door Locks: ANSI/BHMA A156.11, E07121. Drawer Locks: ANSI/BHMA A156.11, E07041.
- Door and Drawer Silencers: ANSI/BHMA A156.16, L03011. Tempered Float Glass for Cabinet Shelves: ASTM C1048, Kind FT, Condition A, Type I, Class 1 (clear) Quality-Q3; with exposed edges seamed before
- tempering, 6 mm thick. Tint Color: Blue-green
- NN. Grommets for Cable Passage: **2-inch (51-mm**OD, molded-plastic grommets and matching plastic caps with slot for wire passage. Color: Match Countertops
- OO. Exposed Hardware Finishes: For exposed hardware, provide finish that complies with ANSI/BHMA A156.18 for ANSI/BHMA finish number indicated.
- Dark, Oxidized, Satin Bronze, Oil Rubbed: ANSI/BHMA 613 for bronze base; ANSI/BHMA 640 for steel base; match Architect's sample. Satin Brass, Blackened, Bright Relieved, Clear Coated: ANSI/BHMA 610 for brass base; ANSI/BHMA 636 for steel base. Satin Chromium Plated: ANSI/BHMA 626 for brass or bronze base; ANSI/BHMA 652 for steel base.
- Satin Stainless Steel: ANSI/BHMA 630. PP. For concealed hardware, provide manufacturer's standard finish that complies with product class requirements in ANSI/BHMA A156.9. Furring, Blocking, Shims, and Hanging Strips: Fire-retardant-treated softwood lumber, kiln-dried to less than 15 percent moisture content. Anchors: Select material, type, size, and finish required for each substrate for secure anchorage. Provide metal expansion sleeves or expansion bolts for
- post-installed anchors. Use nonferrous-metal or hot-dip galvanized anchors and inserts at inside face of exterior walls and at floors.SS. Adhesives: Use adhesives that meet the testing and product requirements of the California Department of Public Health's "Standard Method for the Testing and Evaluation
- of Volatile Organic Chemical Emissions from Indoor Sources Using Environmental Chambers."
- Adhesives: Do not use adhesives that contain urea formaldehyde. Fabricate architectural cabinets to dimensions, profiles, and details indicated. W. Complete fabrication, including assembly and hardware application, to maximum extent possible before shipment to Project site. Disassemble components only as necessary for shipment and installation. Where necessary for fitting at site, provide ample allowance for scribing, trimming, and fitting.
- fastening devices that can be removed after trial fitting. Verify that various parts fit as intended and check measurements of assemblies against WW. Shop-cut openings to maximum extent possible to receive hardware, appliances, electrical work, and similar items. Locate openings accurately and use

Trial fit assemblies at manufacturer's shop that cannot be shipped completely assembled. Install dowels, screws, bolted connectors, and other

- templates or roughing-in diagrams to produce accurately sized and shaped openings. Sand edges of cutouts to remove splinters and burrs. For decorative plastic laminates, comply with manufacturer's written fabrication instructions.
- Install glass to comply with applicable requirements in GANA's "Glazing Manual."
- For glass in frames, secure glass with removable stops. For exposed glass edges, polish and grind smooth.
- Before installation, condition cabinets to humidity conditions in installation areas for not less than 72 hours. Assemble cabinets and complete fabrication at Project site to extent that it was not completed in the shop.
- Install cabinets level, plumb, and true in line to a tolerance of 1/8 inch in 96 inches) using concealed shims. Scribe and cut cabinets to fit adjoining work, refinish cut surfaces, and repair damaged finish at cuts. Install cabinets without distortion so doors and drawers fit openings and are accurately aligned. Adjust hardware to center doors and drawers in

openings and to provide unencumbered operation. Complete installation of hardware and accessory items as indicated.

Anchor cabinets to anchors or blocking built in or directly attached to substrates. Secure with wafer-head cabinet installation screws.

- Fasten wall cabinets through back, near top and bottom, and at ends not more than 16 inches (400 mm) o.c. with No. 10 wafer-head screws sized for not less than 1-1/2-inch (38-mm) penetration into wood framing, blocking, or hanging strips No. 10 wafer-head sheet metal screws through metal backing or metal framing behind wall finish. CCC. Retain "Inspections" Paragraph below to require inspection of installed Work by either AWI or WI. Under both AWI and WI quality programs, the Architect
- has the right to request an inspection at any time during the Project. Repair damaged and defective cabinets, where possible, to eliminate functional and visual defects. Where not possible to repair, replace architectural cabinets. Adjust joinery for uniform appearance. DDD. Clean, lubricate, and adjust hardware.
- Clean cabinets on exposed and semiexposed surfaces. Clean decorative plastic laminate surfaces in accordance with manufacturer's written care and FFF. Protect completed Work from damage for duration of construction period.

GGG. SCHEDULE See drawings for Casework Schedule **Division 07: Thermal & Moisture Protection:**

- Scope of work includes, but is not limited to, vapor barrier, building insulation, water proofing membranes and sealants. Building insulation (when applicable).
- Wall insulation sound batt 3 1/2" thick batt insulation at demising walls, toilet room wall, & stockroom walls. Spray foam insulation - Froth-Pak by DOW, class A rating Provide sealant at dissimilar materials to close gaps, including but not limited to door frames, countertops, and trim work.
- Seal and caulk around all penetrations, seams, cracks and crevices and any other openings capable of harboring insects/rodents.
- Provide waterproof membrane at all wet areas. Stonehard Stonproof ME7 liquid applied, urethane waterproofing membrane. Waterproofing shall extend 6" up wall surface. Provide Manufacturer corners, use complete system with StonClad UT flooring above.

Scale

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Description Date 60% SUBMITTAL 06/23/2023

GENERAL NOTES &

Project number 2023-019 03-29-2023 Drawn by Checked by BW

WILMINGTON INTERNATIONAL AIRPORT 1740 AIRPORT BLVD, WILMINGTON, NC, 28405

BOARDING LEVEL, ZONE 1

SPACE: A, B, AND C

SPECIFICATIONS

Division 08: Doors, Windows & Glass: Scope of work includes, but is not limited to, wood and metal doors and frames, metal windows, glass and glazing and hardware. Doors: Steel doors: Hollow metal doors (interior), as shown on drawings; 1-3/4 inch thick seamless flush doors, 18 gauge, ASTM a 366 or a 526 cold-rolled steel. Acceptable manufacturers include <u>Ceco, Kewanee or Steelcraft</u>. Stainless Steel Specialty doors by Eliason as indicated on the door schedule. Provide fire rated doors as indicated on the door schedule. Metal frames: Metal frames (interior): 16 gauge, shop primed, continuous welded type for drywall slip-on assembly, unless otherwise noted. Hardware: furnish and install hardware as noted on the hardware/door schedule. Mounting height of latching hardware shall be 30" to 44" AFF. Pressure to operate the door shall not exceed 5 lbs for exterior doors and 5 lbs for interior doors & when fire doors are required 5 lbs max or the maximum effort to operate the door may be increased to the maximum allowable by the appropriate administrative authority. Door closer when provided then the sweep period of the closer shall be adjusted so that from an open position of 70 degrees, the door will take at least 3 seconds to move to move to a point 3" from the latch, measured to the landing side of the door. Floor stops shall not be located in the path of travel and 4" maximum from walls. 5. Glass: Safety glass: clear, laminated, conforming to ASTM C1172-14; 1/2" thickness, at locations required per code. Provide neoprene gaskets, setting blocks and glazing tape at all stops. Sliding Grilles General: Supply and install where indicated folding aluminum closure model "S-126" as manufactured by Mobilflex TEL.: (800) 501-3539 Submittals: shop drawings, installation instructions, operation and maintenance instructions) shall be in accordance with general instructions. Model "S-126 WITH THUMB TURN ON INSIDE by Mobilflex Finish shall be standard clear anodized. Curtain Constructed of 5-13/16" wide sections each divided in the center by concealed, full height 5/16" diameter rods. Connecting panels spaced vertically at 16" intervals by 0.45" diameter tubes divided by hanger panels cut to 4 inches. Bi-part egress door at aisles as indicated on schedule. (Bi-part post with interior thumb turn activation). Lead post shall be equipped with a hook bolt lock with MobilFlex cylinders each side. Lead post shall engage a full height wall jamb. Trailing post shall be self-locking at the top and bottom inside the storage pocket. Free floating intermediate posts shall be located at all curves and at intervals not exceeding 10 feet (3M), 6 feet (2M) for countertop units. Intermediate posts shall be equipped with self-adjusting spring loaded drop bolts activated from the inside only. Drop bolts shall engage dust proof stainless steel receptacles. Curtain shall be hung from an overhead track 1-5/16" (33mm) wide by 1-9/16" (40mm) high. Track shall be aluminum 6351 alloy tempered to T6. 10" (255mm) radius curves (indicate location on plans). Stacking Stacking shall not exceed a depth of 1.15" per foot of closure width plus 3" for each post (lead, end or intermediate). (95mm/lin. + 76mm per post). Full egress doors add 7" (176mm). Verify that all preparation work has been completed by other trades. Verify dimensions of opening prior to installation. Closure as per printed instructions from MobilFlex and approved shop drawing. Clean and adjust closure to ensure smooth operation. Roll-down Shutters General: Supply and install where indicated roll-down aluminum shutters by Rollok (888) 840-2833. Submittals: shop drawings, installation instructions, operation and maintenance instructions, shall be in accordance with general instructions. Model: 37mm Foam Filled Rolled Aluminum Slat System See Door Schedule for Color, Rail mounting, etc. Torsion Spring LO2 Bottom Slat Lock with Bars, w/ black faceplace - all keyed alike. H4 black recessed handle BSS1 BLack Bottom Slat Stops Housing per MFR. Installation Verify that all preparation work has been completed by other trades. Verify dimensions of opening prior to installation. Closure as per printed instructions from MobilFlex and approved shop drawing. Clean and adjust closure to ensure smooth operation. Install per MFR. recommendations All locksets must be compatible with Schlage core including the overhead roll-up, or sliding gate. Review and confirm lockset with ILM Lock Shop and ILM airport contact. Aluminum storefront General: Supply and install where indicated 400SF series center glazed Aluminum Glazing System, by US. Aluminum. Submittals (shop drawings, installation instructions, operation and maintenance instructions) shall be in accordance with general instructions. Series 400: Face width 1 3/4", depth 4", glazing infills 1/4" or 3/8" as indicated. Aluminum: ASTM B221, alloy 6063-T6 for extrusions; ASTM B209, alloy 5005-H34 for sheets; or other alloys and temper recommended by manufacturer appropriate for specified finish. Internal Reinforcing: ASTM A36 for carbon steel; or ASTM B308 for structural aluminum. Shapes and sizes to suit installation. Shop coat steel components after fabrication with alkyd type zinc chromate primer complying with FS TT-P-645.] Anchorage Devices: Manufacturer's standard formed or fabricated steel or aluminum assemblies of shapes, plates, bars or tubes. Fasteners: Aluminum, non-magnetic stainless steel or other materials warranted by manufacturer to be non-corrosive and compatible with components being fastened. Do not use exposed fasteners, except where unavoidable for application of hardware. For exposed locations, provide countersunk Phillips head screws with finish matching items fastened. For concealed locations, provide manufacturer's standard fasteners. Provide nuts, washers of design having means to prevent disengagement; deforming of fastener threads is unacceptable. Expansion Anchor Devices: Lead-shield or toothed-steel, drilled-in, expansion bolt anchors. Protective Coatings: Cold-applied asphalt mastic complying with SSPC-Paint 12, compounded for 30 mil (0.77 mm) thickness for each coat; or alkyd type zinc chromate primer complying with FS TT-P-645. Glazing Gaskets: Compression type design, replaceable, molded or extruded, of neoprene or ethylene propylene diene monomer (EPDM). Conform to ASTM C509 or C864. Profile and hardness as required to maintain uniform pressure for watertight seal. Provide in manufacturer's standard black color. Internal Sealants: Types recommended by sealant manufacturer. Anti-Walk" Edge Blocking: "W" shaped EPDM blocks for use in keeping glazing material stationary under vibration or seismic loading. Baffles (at weep holes): Type as recommended by system manufacturer and shown in published installation instructions. End Dams: Type as recommended by System manufacturer and shown in the published Installation instructions. Installation Q. Division 09: Finishes

Conceal fasteners wherever possible.

Anchor securely in place, allowing for required movement, including expansion and contraction.

Separate dissimilar materials at contact points, including metal in contact with masonry or concrete surfaces, with bituminous paint or pre-formed separators to prevent contact and corrosion. Seal perimeter members as shown on manufacturer's installation instructions or as required for unique job conditions. Set other

members with internal sealants and baffles as called for in manufacturer's installation instructions. Use sealants as recommended by Coordinate installation of perimeter sealant and backing materials between assemblies and adjacent construction.

Glazing: Refer to requirements of Section 08 81 00. Utilize "anti-walk" edge blocking on all vertical edges of glazing

Perform Work in accordance with AAMA SFM-1 and manufacturer's written instructions

Scope of work includes, but is not limited to: gypsum board systems, resilient flooring, carpet, wood flooring, ceramic tile, painting and wall finishes. All interior finishes shall be Class-A per MAA DST section 15.4.2.8. If using fire retardant on finished carpentry provide Fire Marshal with manufacturers cut sheets for review prior to application and or use.

Ceiling systems Drywall ceilings are to be hung using USG drywall suspension system or approved equal. Installation is to be per manufacturer's

Acoustical 2x2 lay-in ceilings are to be installed per manufacturer's recommendations. Attach hanger wires to structure above. Do not support wires from mech or elec equipment.

Verify hanger layout. Shall not interfere with other components. Hanger spacing not to exceed 4'-0". All fixtures installed in lay-in ceiling shall be placed in center of ceiling tile unless dimensioned otherwise. Deliver to owner replacement tiles in the amount of 10% of materials.

SECTION 092216 -NON-STRUCTURAL METAL FRAMING

Fire-Resistance-Rated Assemblies: Provide materials and construction identical to those tested in assemblies per ASTM E 119 by an independent testing and inspecting agency acceptable to authorities having jurisdiction.

STC-Rated Assemblies: Provide materials and construction identical to those tested in assemblies per ASTM E 90 and classified per ASTM E 413 by a qualified independent testing and inspecting agency. METAL FRAMING AND SUPPORTS

Steel Framing Members, General: ASTM C 754. Steel Sheet Components: ASTM C 645. Thickness specified is minimum uncoated base-metal thickness.

Protective Coating: ASTM A 653/A 653M, G40 (Z120), hot-dip galvanized

a. All interior wall studs shall be a minimum of 20 gauge. Stud depth shall be determined by bearing requirements and stud length. Double 18

Studs shall be installed on each side of all door openings and 18 gauge studwork (max 2' on center) in areas that will support signs,

Suspension Systems: Tie Wire: ASTM A 641/A 641M, Class 1 zinc coating, soft temper, 0.062-inch diameter, or double strand of 0.048-inch diameter wire. Wire Hangers: ASTM A 641/A 641M, Class 1 zinc coating, soft temper, and 0.162- diameter.

Carrying Channels: Cold-rolled steel, 0.053-inch thick, 1-1/2 inches deep. Furring Channels: 3/4-inch deep, cold-rolled channels, 0.053 inch thick,

Steel studs, 0.033 inch thick, in depth indicated Steel, rigid hat-shaped channels; 7/8 inch deep, 0.033 inch thick Grid Suspension System for Gypsum Board Ceilings: Interlocking, direct-hung system. Comply with referenced installation standards and provide

accessories. Fasteners for Metal Framing: Of type, material, size, corrosion resistance, holding power, and other properties required to fasten steel members to substrates.

Isolation Strip at Exterior Walls: foam gasket Install steel framing to comply with ASTM C 754."

Gypsum Plaster Assemblies: Also comply with ASTM C 841 Portland Cement Plaster Assemblies: Also comply with ASTM C 1063.

Gypsum Veneer Plaster Assemblies: Also comply with ASTM C 844. Gypsum Board Assemblies: Also comply with ASTM C 840.

Install supplementary framing, and blocking to support fixtures, equipment services, heavy trim, grab bars, toilet accessories, furnishings, or similar

Isolate steel framing from building structure, except at floor, to prevent transfer of loading imposed by structural movement. Where studs are installed directly against exterior walls, install isolation strip between studs and wall.

Fire-Resistance-Rated Assemblies: Comply with requirements of listed assemblies. Example tolerance in paragraph below is based on ASTM C 636 for acoustical ceilings.

Install suspension systems level to within 1/8 inch in 12 feet

SECTION 09250 - GYPSUM DRYWALL ENVIRONMENTAL REQUIREMENTS: Comply with referenced standards and recommendations of gypsum board manufacturer, for environmental

conditions before, during and after application of gypsum board. Products: Manufacturers of Gypsum Board and Related products: United States Gypsum Co. or approved equal.

General: Size ceiling support components to comply with ASTM C 754. Gypsum Wallboard: ASTM C 36 of Type X for fire resistant rated assembles, and all other walls per ILM Tenant Construction Standards, Edges:

Trim: ASTM C 1047; standard trim accessories for drywall work, formed of galvanized steel with either knurled and perforated or expanded flanges for nailing or stapling, and beaded for concealment of flanges in joint compound. Provide corner beads, L-type edge trim-beads, special L-kerf-type

edge trim-beads, and one-piece control joint beads. Joint Treatment: ASTM C 475A. Joint Tape: Per reinforcing tape. Joint Compound: Ready-mixed vinyl type for interior use. Provide two separate grades; one specifically for bedding tapes and filling depressions,

Water: Clean and free of deleterious material. Installation Standard: Comply ASTM C754 and ASTM C840. Provide support for all edges of gypsum board. Use screw fasteners only.

Install supplementary framing and bracing at the terminations in the work and for support of toilet accessories and other construction. Secure hangers to structural support by connecting directly to structure where possible, otherwise connect to inserts, clips, or other anchorage

<u>SECTION 093033 - TILING</u>

Submittals: Product Data and Samples. Stone Floor Tiles: Minimum abrasion resistance of 10 per ASTM C 1353 or ASTM C 241.

Varieties and Sources: As indicated on the Drawings

Select applicable cut in first subparagraph below; delete if stone selected has no veining.

Cut: As indicated on the Drawings Finish: As indicated on the Drawings.

and one for topping and sanding.

Edges: As indicated on the Drawings Module Size: As indicated on the Drawings

Nominal Tile Thickness: As indicated on the Drawings

Joint Width: As indicated on the Drawings

Thresholds: As specified above for stone tile. Bevel edges at 1:2 slope, aligning lower edge of bevel with adjacent floor finish. Limit height of bevel to 1/2 inch (13 mm) or less and finish to match face of threshold.

Setting and Grouting Materials: Comply with material standards in ANSI's "Specifications for the Installation of Ceramic Tile" that apply to materials and methods indicated.

Grout Color: As indicated on drawings. Thin-Set Mortar: Dry-set Portland cement mortar.

Cementitious Backer Units: Complying with ANSI A118.9, of thickness indicated.

Floor Sealer: Colorless, slip- and stain-resistant, not affecting color or physical properties of stone surfaces.

Comply with tile installation standards in ANSI's "Specifications for the Installation of Ceramic Tile" that apply to materials and methods indicated. For tile floors, follow procedures in ANSI A108 for providing 95 percent mortar coverage. Comply with TCA's "Handbook for Ceramic Tile Installation."

Floor Tile Installation Method(s): TCA F114 Cement Mortar, Epoxy Grout; F122 Waterproof Membrane - Thin Set

Wall Tile Installation Method(s): TCA W243 Gypsum Board, Dry Set or Portland Cement Morar; W244C Cement Backer Unit; W245 Coated Glass Mat Water-Resistant Gypsum Back Board

Apply sealer to cleaned stone tile flooring according to sealer manufacturer's written instructions.

Installation of flooring Installation procedures will be thin set methods in strict accord with manufacturer's recommendations contained in each box of material. Accepted methods by the Tile Council of America including using the proper trowel $(1/4" \times 3/8" \times 1/4")$, beating in and back-buttering. These techniques, especially for larger tile, must be followed to obtain proper transfer and levelness.

Close area to normal traffic for 24 hours (or longer) depending on type of material and manufacturer's recommendation. Flooring will be protected from construction traffic after laying and grouting.

Provide setting and materials obtained from one source for each type and color of grout and setting materials.

All grout shall be epoxy grout. All tile installation shall comply with Tile Council of North America, Inc. 2020 TCNA Handbook for Ceramic, Glass, and Stone Tile Installation and (ANSI) the American National Standard Specification for the Installation of Ceramic Tile.

SECTION 096723 - RESINOUS FLOORING

PART 1 - GENERAL

RELATED DOCUMENTS Drawings and general provisions of the Contract, including General and Supplementary Conditions and Division 01 Specification Sections,

apply to this Section. 1.2

This Section includes one resinous flooring system, one with urethane body.

Application Method: Metal hand troweled.

1.3 SUBMITTALS Product Data: For each type of product indicated. Include manufacturer's technical data, application instructions, and recommendations for each resinous flooring component required.

Samples for Verification: For each resinous flooring system required, 5 inches (150 mm) square, applied to a rigid backing. Installer Certificates: Signed by manufacturer certifying that installers comply with specified requirements.

Maintenance Data: For resinous flooring to include in maintenance manuals. QUALITY ASSURANCE

No request for substitution shall be considered that would change the generic type of floor system specified (i.e. Urethane mortar based system). Equivalent materials of other manufactures may be substituted only on approval of Architect or Engineer. Request for substitution will only be considered only if submitted 10 days prior to bid date. Request will be subject to specification requirements described in this

Installer Qualifications: Engage an experienced installer (applicator) who is experienced in applying resinous flooring systems similar in material, design, and extent to those indicated for this Project, whose work has resulted in applications with a record of successful inservice performance, and who is acceptable to resinous flooring manufacturer.

Engage an installer who is certified in writing by resinous flooring manufacturer as qualified to apply resinous flooring systems

Contractor shall have completed at least 10 projects of similar size and complexity Source Limitations: Obtain primary resinous flooring materials, including primers, resins, hardening agents, grouting coats, and topcoats, through one source from a single manufacturer, with not less than ten years of successful experience in manufacturing and installing principal materials described in this section. Provide secondary materials, including patching and fill material, joint sealant, and repair materials, of type and from source recommended by manufacturer of primary materials.

Manufacturer Field Technical Service Representatives: Resinous flooring manufacture shall retain the services of Field Technical Service Representatives who are trained specifically on installing the system to be used on the project. Field Technical Services Representatives shall be employed by the system manufacture to assist in the quality assurance and

quality control process of the installation and shall be available to perform field problem solving issues with the installer. DELIVERY, STORAGE, AND HANDLING Deliver materials in original packages and containers, with seals unbroken, bearing manufacturer's labels indicating brand name and

directions for storage and mixing with other components. Store materials to prevent deterioration from moisture, heat, cold, direct sunlight, or other detrimental effects. Store material per product

All materials used shall be factory pre-weighed and pre-packaged in single, easy to manage batches to eliminate on site mixing errors. No on site weighing or volumetric measurements allowed. PROJECT CONDITIONS Environmental Limitations: Comply with resinous flooring manufacturer's written instructions for substrate temperature, ambient

temperature, moisture, ventilation, and other conditions affecting resinous flooring application. Lighting: Provide permanent lighting or, if permanent lighting is not in place, simulate permanent lighting conditions during resinous flooring application. Close spaces to traffic during resinous flooring application and for not less than 24 hours after application, unless manufacturer

Concrete substrate shall be properly cured. A vapor barrier must be present for concrete subfloors on or below grade. Otherwise, an osmotic pressure resistant grout must be installed prior to the resinous flooring

Manufacturer shall furnish a single, written warranty covering both material and workmanship for a period of (1) full years from date of installation, or provide a joint and several warranty signed on a single document by material manufacturer and applicator jointly and severally warranting the materials and workmanship for a period of (1) full year from date of installation. A sample warranty letter must be included with bid package or bid may be

Installer to provide an additional warranty on workmanship.

PART 2 - PRODUCTS

2.1 RESINOUS FLOORING

Available Products: Subject to compliance with requirements, product that may be incorporated into the work include, Unsealed or "self-sealing" urethane mortar systems, multiple layers of liquids and broadcasts will not be accepted, and will result in a

Acceptable Manufactures,

Stonhard Basis of design Products: Subject to compliance with requirements:

Stonhard, Inc.; Stonproof ME7 (Waterproof Primer), Stonclad UT®. With Stonkote HT4

System Characteristics: Color and Pattern: Mushroom

Wearing Surface: Light, or medium Integral Cove Base: Yes Overall System Thickness: nominal 3/16-1/4".

System Components: Manufacturer's standard components that are compatible with each other and as follows:

Material design basis: Stonclad UT

Resin: Urethane.

Formulation Description: (4) four-component, 100 percent solids. Application Method: Screed, Trowel. Thickness of Coats: 3/16".

Number of Coats: One. Broadcast texture into wet mortar base. Aggregates: Pigmented Blended aggregate.

Top coat: Material design basis: Stonkote HT4

Resin: Urethane. Formulation Description: (2) two-component, 100 percent solids.

Type: pigmented. Finish: standard. Number of Coats: One.

required by the Specifications, whether or not such products are specifically listed above.

Note: Components listed above are the basis of design intent; all bids will be compared to this standard including resin chemistry, color, wearing surface, thickness, and installation procedures, including number of coats. Contractor shall be required to comply with all the requirements of the Specifications and all of the components

System Physical Properties: Provide resinous flooring system with the following minimum physical property requirements when tested according to test

Compressive Strength: 7,700 psi after 7 days per ASTM C 579. Tensile Strength: 1,000 psi per ASTM C 307.

Flexural Strength: 2,400 psi per ASTM C 580. Water Absorption: < 1% per ASTM C 413.

Impact Resistance: > 160 in. lbs. per ASTM D 2794. Flammability: Class 1 per ASTM E-648. Hardness: .80 to .84, Shore D per ASTM D 2240.

Flexural Modulus of Elasticity: 2.6x106 psi per ASTM C-580 Thermal Coefficient of Linear Expansion: 1.1x10-5 in./in.°F per ASTM C-531

ACCESSORY MATERIALS

Primer: Stonproof ME7 (Waterproof Primer). Formulation Description: Stonclad UT urethane mortar is self priming.

application above grade Stonproof ME7. Must include texture 3 broadcast to ensure intercoat adhesion.

Patching and Leveling: Use a four component fast setting Urethane grout. Moisture resistant polyurethane based grout designed for permanent repairs under flooring system. Stonhard, Stonset TG6. See drawings 1/4" per foot slope to drains. Use standard drain detail, saw cut and chase. Waterproofing Membrane: Type recommended by manufacturer for substrate and primer and body coats indicated. Formulation Description Only if

PART 3 - EXECUTION

PREPARATION General: Prepare and clean substrates according to resinous flooring manufacturer's written instructions for substrate indicated. Provide clean and

substrate for resinous flooring application. Concrete Substrates: Provide sound concrete surfaces free of laitance, glaze, efflorescence, curing compounds, form-release agents, dust, dirt, grease, and other contaminants incompatible with resinous flooring.

Mechanically prepare substrates as follows: Shot-blast surfaces with an apparatus that abrades the concrete surface, contains the dispensed shot within the apparatus, and recirculates the shot by vacuum pickup.

Comply with ASTM C 811 requirements, unless manufacturer's written instructions are more stringent.

Repair damaged and deteriorated concrete according to resinous flooring manufacturer's written recommendations. Verify that concrete substrates are dry a. Perform in situ probe test, ASTM F 2170. Proceed with application only after substrates do not exceed a maximum potential

equilibrium relative humidity of 85 percent. Test above provides a more accurate indication as to whether or not a concrete slab has dried sufficiently to allow finish flooring application than the tests below. For applying impermeable resinous flooring systems, 3 lb of water/1000 sq. ft. (1.36 kg of water/92.9 sq. m) of slab in 24 hours is generally considered a safe moisture-

vapor-emission rate. Consult manufacturers for appropriate rates for permeable systems that will allow moisture vapor to continue through them once cured. Perform anhydrous calcium chloride test, ASTM F 1869. Proceed with application only after substrates have maximum moisture-vaporemission rate of 6 lb of water/1000 sq. ft. of slab in 24 hours.

Perform additional moisture tests recommended by manufacturer. Proceed with application only after substrates pass testing... Use patching and fill material to fill holes and depressions in substrates according to manufacturer's written instructions. Treat control joints and other nonmoving substrate cracks to prevent cracks from reflecting through resinous flooring according to manufacturer's recommendations. Allowances should be included for Stonflex MP7 joint fill material, and CT5 concrete crack treatment.

3.2 APPLICATION General: Apply components of resinous flooring system according to manufacturer's written instructions to produce a uniform, monolithic wearing surface of thickness indicated.

> Coordinate application of components to provide optimum adhesion of resinous flooring system to substrate, and optimum intercoat adhesion. Cure resinous flooring components according to manufacturer's written instructions. Prevent contamination during application and curing

At substrate expansion and isolation joints, provide joint in resinous flooring to comply with resinous flooring manufacturer's written

Apply joint sealant to comply with manufacturer's written recommendations. Apply primer where required by resinous system, over prepared substrate at manufacturer's recommended spreading rate.

Integral Cove Base: Stonclad UR mortar, apply cove base mix to wall surfaces before applying flooring. Apply according to manufacturer's written instructions and details including those for taping, mixing, priming, troweling, sanding, of cove base. Round internal and external corners. Integral Cove Base: 6" inches high.

Mortar: Mix mortar material according to manufacturer's recommended procedures. Uniformly spread mortar over substrate at manufacturer's recommended height using specially designed trowel and or Screed box. Broadcast desired texture directly into mortar base. Field verify texture needed Apply topcoat in number of coats indicated for flooring system and at spreading rates recommended in writing by manufacturer.

3.3 TERMINATIONS

Chase edges to "lock" the flooring system into the concrete substrate along lines of termination.

Penetration Treatment: Lap and seal the flooring system onto the perimeter of the penetrating item by bridging over compatible elastomer at the interface to compensate for possible movement.

Trenches: Continue flooring system into trenches to maintain monolithic protection. Treat cold joints to assure bridging of potential cracks. Treat floor drains by chasing the flooring system to lock in place at point of termination.

JOINTS AND CRACKS

Treat control joints to bridge potential cracks and to maintain monolithic protection. Treat cold joints and construction joints to bridge potential cracks and to maintain monolithic protection on horizontal and vertical surfaces as well as horizontal and vertical interfaces. Discontinue floor coating system at vertical and horizontal contraction and expansion joints by installing backer rod and compatible sealant after coating

installation is completed. Provide sealant type recommended by manufacturer for traffic conditions and chemical exposures to be encountered. FIELD QUALITY CONTROL Material Sampling: Owner may at any time and any numbers of times during resinous flooring application require material samples for testing for

compliance with requirements. Owner will engage an independent testing agency to take samples of materials being used. Material samples will be taken, identified, sealed, and certified in presence of Contractor. Testing agency will test samples for compliance with requirements, using applicable referenced testing procedures or, if not referenced, using

testing procedures listed in manufacturer's product data. If test results show applied materials do not comply with specified requirements, pay for testing, remove noncomplying materials, prepare surfaces coated with unacceptable materials, and reapply flooring materials to comply with requirements.

Protect resinous flooring materials from damage and wear during construction operation. Where temporary covering is required for this purpose, comply

CLEANING, PROTECTING, AND CURING A. Cure resinous flooring materials in compliance with manufacturer's directions, taking care to prevent contamination during stages of application and prior to completion of curing process. Close area of application for a minimum of 18 hours.

with manufacturer's recommendations for protective materials and method of application. General Contractor is responsible for protection and cleaning Cleaning: Remove temporary covering and clean resinous flooring just prior to final inspection. Use cleaning materials and procedures recommended by resinous flooring manufacturer.

END OF SECTION 096723

DESIGN ARCHITECTURE

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E: tcarmichael@silhouetteinc.com MEP CONSULTANT: Logan Unrein MEP Design Engineer/Associate FSC MEP Engineers, LLC. 8675 W. 96th Street Overland Park, KS 66212

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BRAND Inspire Brands Inc. Jay Bauch Construction Manager T: (508) 574-9566 E: jay.bauch@inspirebrands.com



60% SUBMITTAL



Date

06/23/2023

BOARDING LEVEL, ZONE 1

SPACE: A, B, AND C

GENERAL NOTES & SPECIFICATIONS

2023-019 Project number 03-29-2023 Drawn by BW Checked by

Scale

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SECTION 09900 - PAINTING Annotation List Samples: Submit samples for review of each required color and texture. Identity materials used on samples. ABOVE NOT IN CONTRACT Submit paint samples on 8.5" x 11" hardboard. Resubmit samples until they are acceptable. Apply full-coat finish samples on at least 60 sq. ft of wall where directed, until required sheen, color and texture are AIR CONDITIONING NOT TO SCALE obtained under finished lighting. ACT ACOUSTICAL CEILING TILE Apply water-based paints only when temperature of surfaces to be painted and surrounded air temperatures are **ADJUSTABLE** ON CENTER between 50 degrees F and 90 degrees F, unless otherwise permitted by paint manufacturer's instructions. OPPOSITE AFF ABOVE FINISHED FLOOR OPP Apply solvent-thinned paints only when temperature of surfaces to be painted and surrounding air temperatures are between 45 degrees F and 90 degrees F, unless otherwise permitted by paint manufacturer's instructions. ORIENTED STRAND BOARD Do not apply paint when relative humidity exceeds 85%; or to damp or wet surfaces; unless otherwise permitted by BOARD paint manufacturer's Instructions. BUILDING Do not paint over dirt, rust, scale, grease, moisture, or conditions detrimental to formation of a durable paint film. PLASTIC LAMINATE Provide barrier coats over incompatible primers or remove and re-prime as required. BLOCKING PLUMB PLUMBING Remove hardware, accessories, lighting fixtures, and similar items not to be field-painted, or provide suitable BEAM OR BENCHMARK protection. Remove items if necessary, for painting of items or adjacent surfaces. BACK OF HOUSE Clean surfaces to be painted. Remove oil and grease prior to other cleaning. Be sure that cleaning materials do not fall onto newly-painted surfaces. BETWEEN Available Manufacturer's: Subject to compliance with requirements, provide products as manufactured by Benjamin **QUARRY TILE** Moore and Co. or approved equal. CABINET OUARTER Colors: As specified by Architects. Volatile Organic Materials: Provide paint and coating products to comply with applicable environmental regulations CONTROL JOINT QUANTITY authorities. Federal numbers where specified, are for guidelines only. CL CENTERLINE Primers and Undercoat: Provide primers and undercoat recommended by the finish coating manufacturer for suitability CLG CEIING RADIUS with the substrate and compatibility with finish coats. CONCRETE MASONRY UNIT RB RUBBER BASE Cementitious Materials: Remove efflorescence, chalk, dust, and dirt, grease, oils, and release agents. Correct alkalinity before application of paint. CO CLEAN OUT REFERENCE Wood: Scrape, clean and seal all architectural woodwork items, scheduled to be field painted, before priming as COL COLUMN REINFORCE CONCRETE REQUIRED Ferrous Metals: Clean unfinished ferrous surfaces of oil, grease, dirt, loose mill scale and other foreign by solvent or mechanical cleaning. Touch-up defective shop-prime coats with shop primer. CONTINUOUS RMROOM Note: No spraying of oil based paints or materials permitted. ROUGH OPENING CONSTRUCTION Apply paint in accordance with manufacturer's directions. Use applicators and techniques best suited for substrate and CG CORNER GUARD type of material being applied. Mix and prepare painting materials in accordance with manufacturer's directions. Maintain containers used in mixing CPT CARPET SOUARE FEET and application paint in clean condition, free of foreign materials and residue. CSMT CASEMENT SHT SHEET Use only thinners approved by the paint manufacturer and only within recommended limits. SIMILAR Provide finish coats which are compatible with prime paints used. SPECIFICATIONS DIMENSION SPECS Apply additional coats when undercoats shoe through final coat of paint, until paint film is uniform finish, color and appearance, including edges, corners, crevices, welds and fasteners. DN SOD SLAB ON DECK DOWN Paint interior surfaces of duct, diffusers, radiator enclosures where visible through registers or grilles with flat, non-SOG DWG DRAWING SLAB ON GRATE specular white paint. SS STAINLESS STEEL Paint back sides of access panels, and removable doors varnish coat. Sand lightly between each succeeding enamel or varnish coat. EACH ST STONE Omit first coat (primer) on metal surfaces that have shop primed and touch-up painted. EJ **STANDARD** EXPANSION JOINT Completed Work: Match approved samples for colors and texture. Repaint work not in compliance with specified ELECTRICAL STRUCT STRUCTURAL Clean - Up: During progress work, remove from site discarded paint materials, rubbish, cans and rags at the end of EL ELEVATION each work day. Upon completion painting work clean paint spattered surfaces. Remove splattered paint by proper ELEVATOR TEMPERED, TEMPORARY methods, with care not scratch or otherwise damage finished surfaces. **EQUAL** T.O. TOP OF Interior Paint and Finish Schedule: General: Subject to compliance with requirements, provide following interior paint EQUIP EQUIPMENT systems, or equal by other specified manufactures, of color as selected by the Architect. Completely cover material to TONGUE AND GROOVE provide a smooth surface of uniform finish in color, appearance and coverage. Cloudiness, spotting, holidays, laps, EXH **EXHAUST** TEL **TELEPHONE** brush marks, runs, sags, ropiness or other surface imperfections will not be acceptable. EXISTING TRANSFORMER See finish schedule for further information. EXT EXTERIOR TV TELEVISION TYPICAL **Division 10: Miscellaneous Specialties:** FIRE ALARM FLOOR DRAIN FIRE EXTINGUISHER F.F. FINISHED FLOOR FLR FLOOR VERTICAL FOH VEST FRONT OF HOUSE VESTIBULE

MEZZANINE MANUFACTURER

MISCELLANEOUS

MILLWORKER

MINUMU

METAL

MISC MTL

MW

General Contractor (GC) to install owner supplied furnishing and equipment (as noted in the division of work).

104416 FIRE EXTINGUISHERS

19.

Fire extinguishers: GC is to furnish and install hook mounted or cabinet mounted (per drawings) 10 lb fire extinguishers as required by code or as directed by the Fire Marshall. Provide type ABC for general use and type K for use in kitchens. Locate as directed by the Fire Marshall and verify location with Architect.

BEV WAY - BEVERAGE LINE CONDUIT SYSTEMS


- The Beverage Line Conduit Systems to be installed hereunder shall be 4", 6", 8" or 10" as specified on the Food Service drawings, corrosion resistant Aluminum conduit tubing, conforming to ASTM-B313 and ANSI-H26, and H35.1, as manufactured by Kelly BevWay Systems Co., Chicago, IL, 877-753-0600.
- Bends shall be long sweep type, of the same grade and coated in the same manner as the tubing specified above. Minimum centerline radius of all bends shall be 24" for 4"O.D., 30" for 6" O.D., 32" for 8"O.D., and 32" for 10" O.D. No segmented elbows or short radius plumbing elbows shall be permitted. All joints shall be made with a liquidtite mechanical bolted coupling system or liquidtite slip coupling system. Edges of
- tubing and bends must be deburred and smoothed prior to forming joints. Expansion sleeves with a moisture barrier must be provided where the conduit crosses building expansion joints, liquidtite integrity maintained. No spiral formed tubing or duct, or other unsmooth interior tubing or conduit will be permitted. PVC shall be used only for underground and other buried portions of the systems, Schedule 40 type with Long Radius Sweep Bends, 24" for 4"
- PVC, 30" for 6" PVC and 48" for 8" PVC. Multi-Clamped Pull Sleeves, four (4) feet long minimum, must be provided for continued access to beverage lines in accessible locations approximately every 100 feet or every three (3) bends, whichever occurs first. Where junctions are required, Pull Boxes having adequate inside dimensions for pulling and turning will be provided in place of a Pull Sleeve.
- Conduit system terminations shall be stubbed-up 4" above finished floor unless otherwise called out on drawings. All floor penetrations shall be sealed with a UL approved firestop assembly method. All terminations shall be finished with a rounded slip fitting end-mouth having a smooth bell-shaped swaged outer
- Support hangers will be double rod type and spaced on 10 foot centers. Support hangers will be provided within 1 foot of each Pull Box.

Division 11: Equipment:

General Contractor (GC) to install owner supplied furnishing and equipment (as noted in the division of work).

Division 12: Furnishings:

General Contractor (GC) to install owner supplied furnishing and equipment (as noted in the division of work).

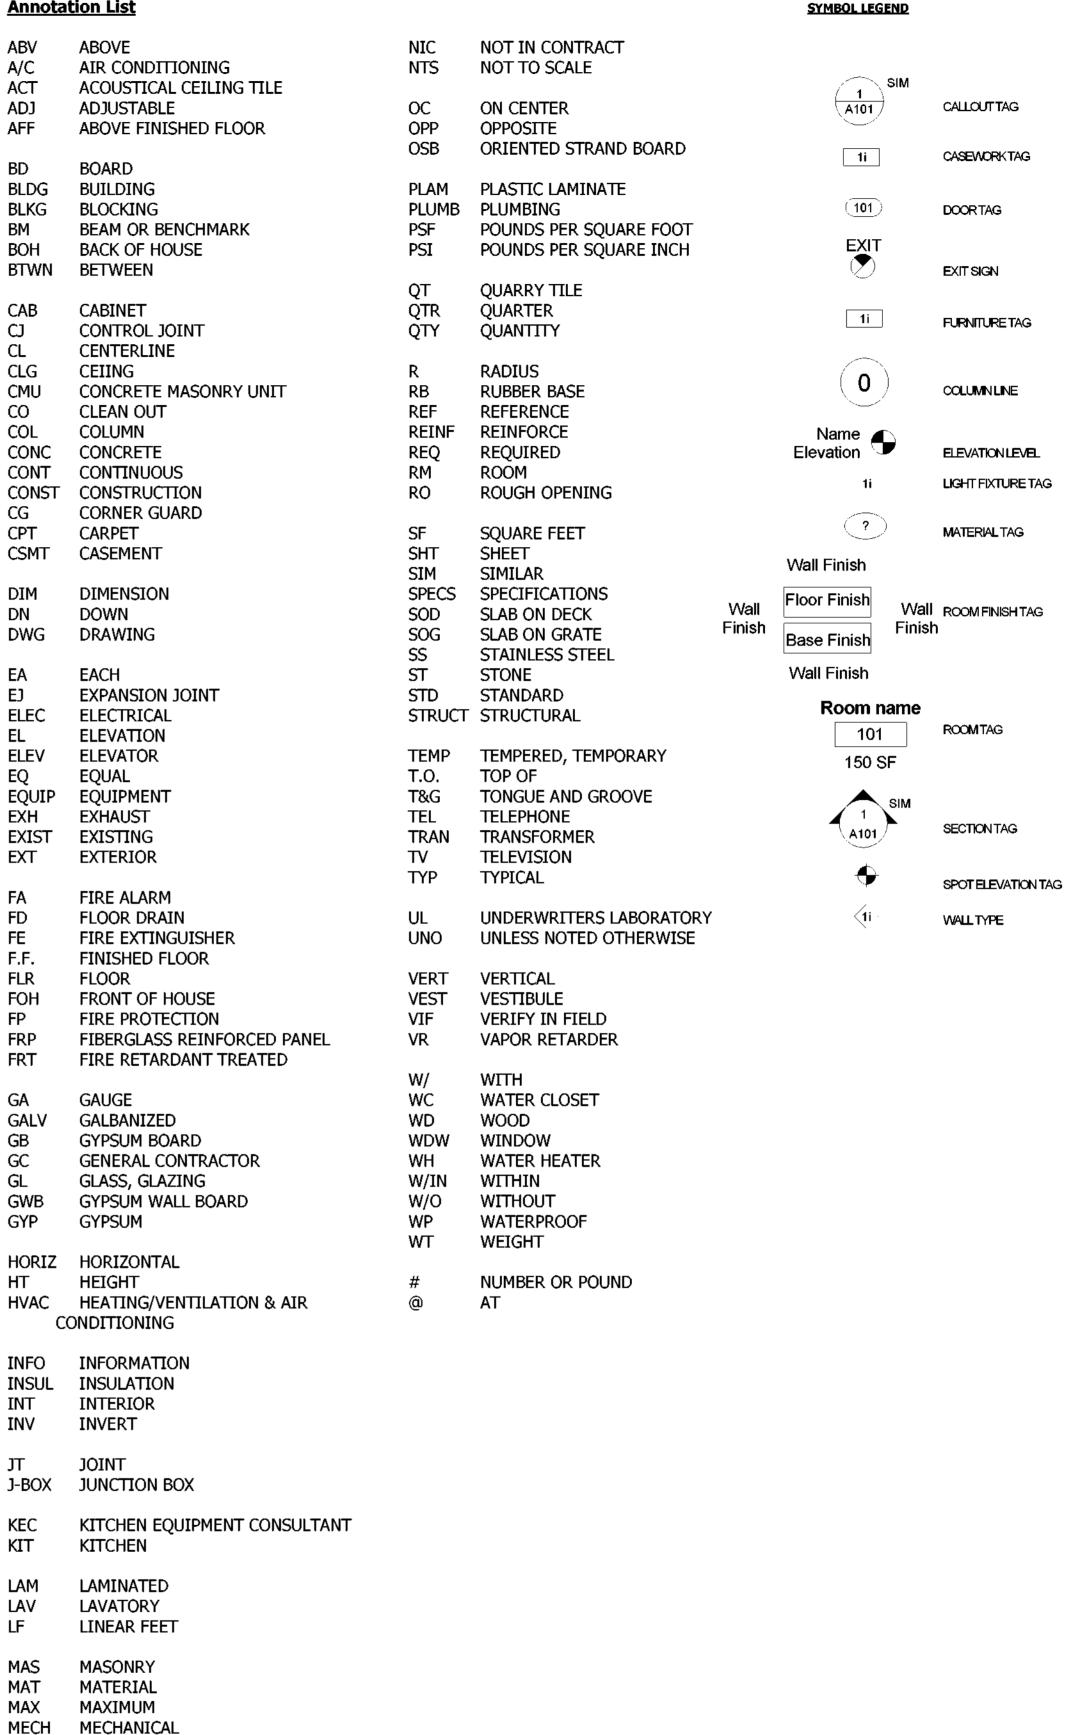

DESIGN ARCHITECTURE

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DESIGNER:

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WILMINGTON INTERNATIONAL AIRPORT 1740 AIRPORT BLVD. WILMINGTON, NC, 28405 **BOARDING LEVEL, ZONE 1** SPACE: A, B, AND C

No.	Description	Date
1	60% SUBMITTAL	06/23/202


GENERAL NOTES & SPECIFICATIONS

Project number	2023-0
Date	03-29-20
Drawn by	A
Checked by	В

Scale

A0.3

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GENERAL DEMOLITION NOTES

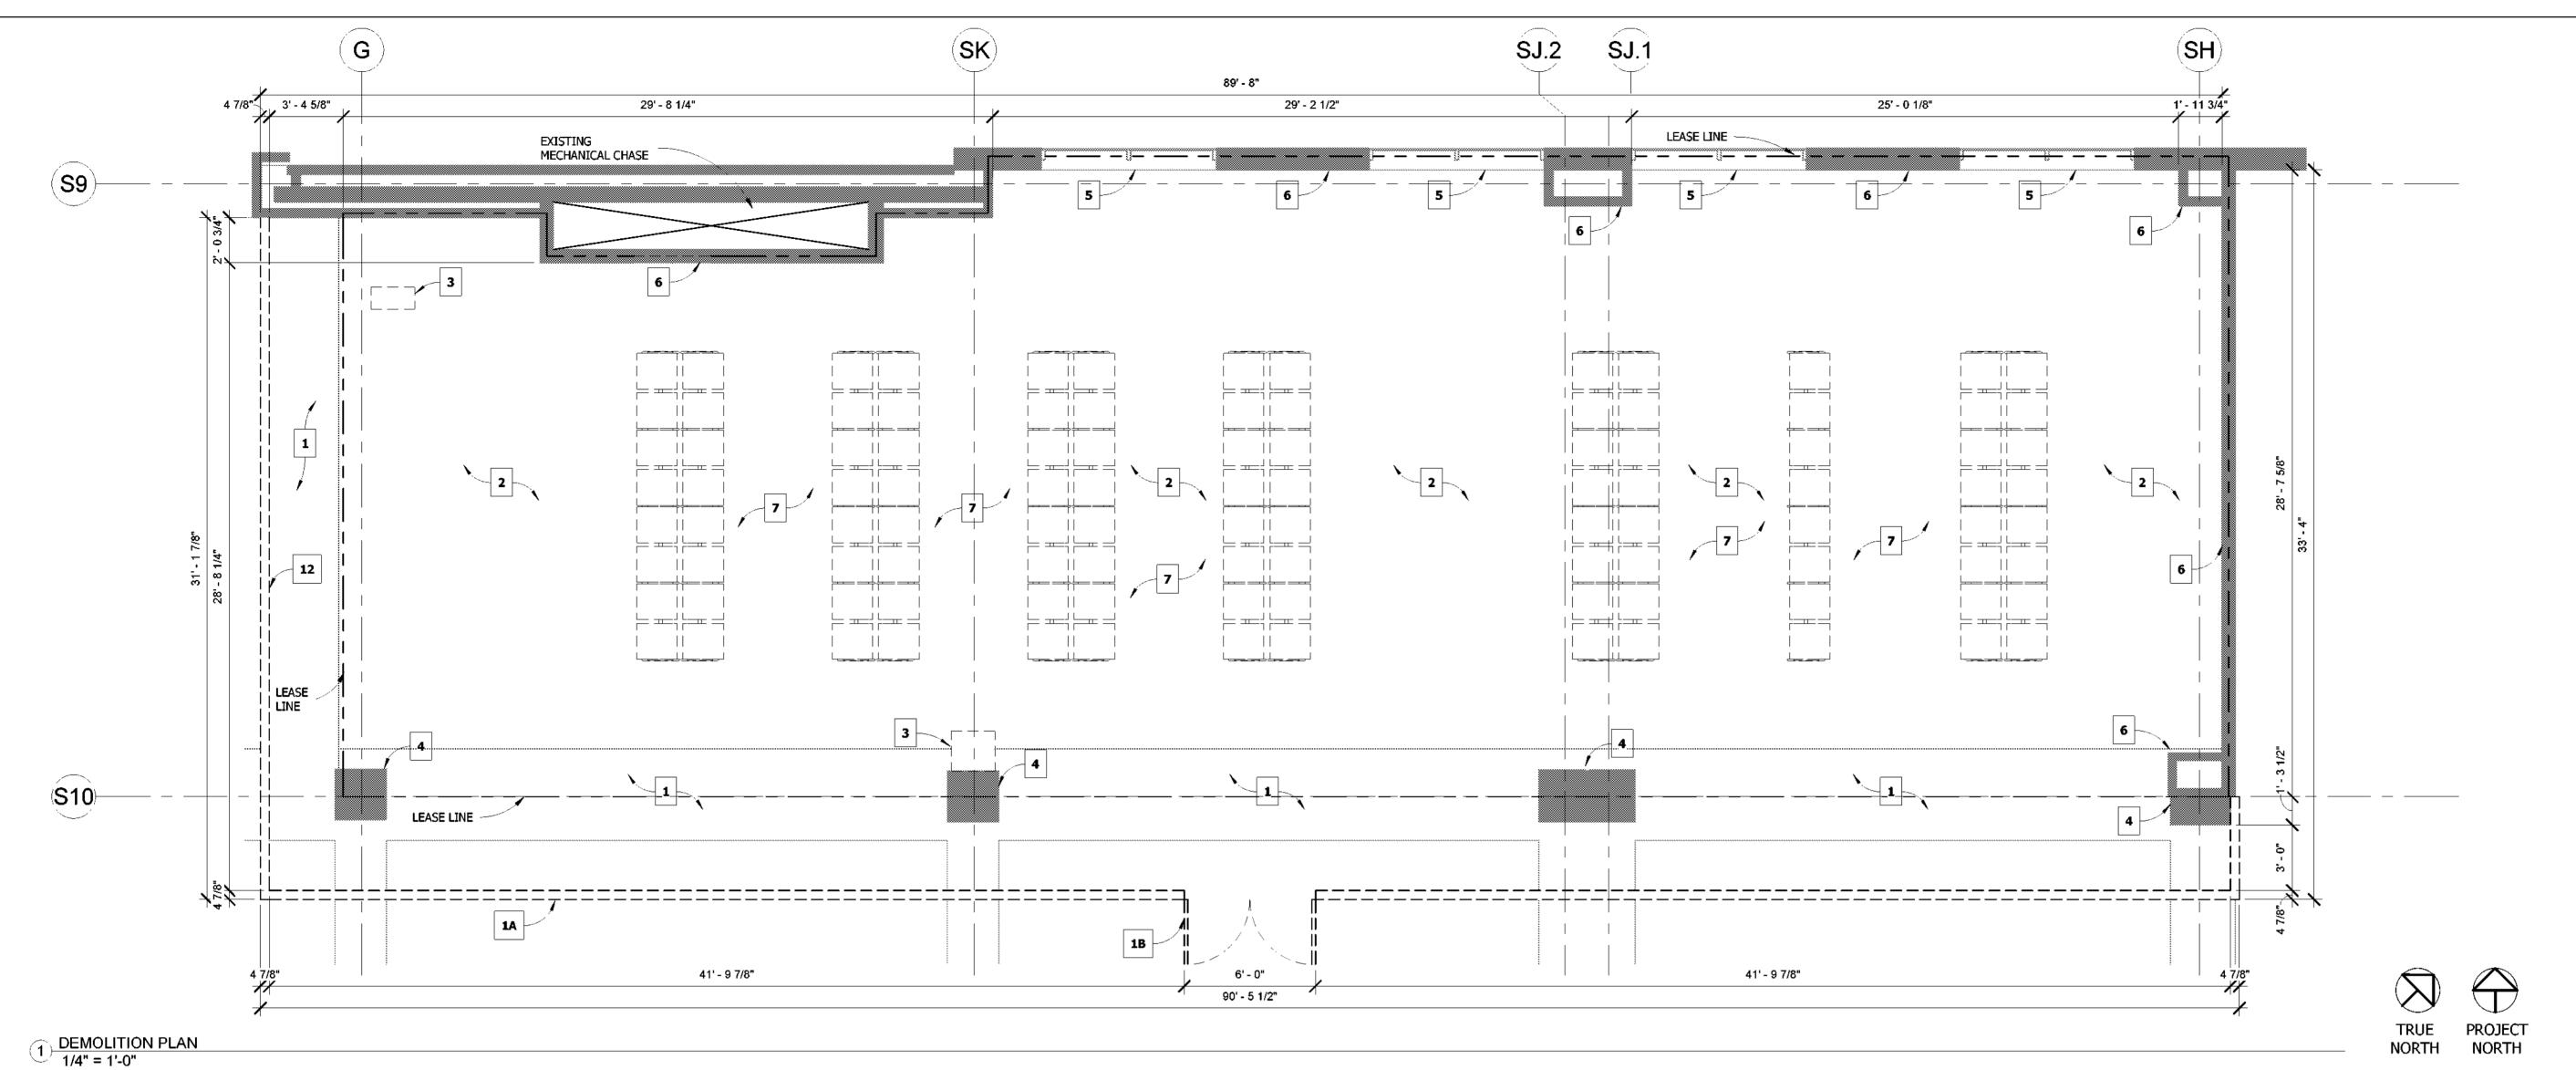- DEMOLITION PLAN IS INDICATED FOR REFERENCE ONLY. GENERAL CONTRACTOR SHALL VERIFY ALL EXISTING CONDITIONS IN THE FIELD AND COORDINATE ALL REQUIRED DEMOLITION, AS REQUIRED, PER CONSTRUCTION DRAWINGS.
- REFER TO CONSTRUCTION PLANS FOR EXTENT OF NEW CONSTRUCTION.
- COORDINATE DEMOLITION WORK WITH ELECTRICAL DRAWINGS.
- CARE SHOULD BE TAKEN TO PROTECT, MAINTAIN, AND NOT INTERRUPT EXISTING SERVICES AND UTILITIES SERVING THE BLDG.
- GENERAL CONTRACTOR SHALL VERIFY ALL CONDITIONS IN THE FIELD AND NOTIFY ARCHITECT IMMEDIATELY OF ANY DISCREPANCIES BETWEEN PLANS AND EXISTING CONDITIONS.
- ASBESTOS/ HAZARDOUS WASTE CONTACT AND REMOVAL: THE OWNER SHALL BE IMMEDIATELY NOTIFIED IF DEMOLITION AND/OR CONSTRUCTION UNDER THIS CONTRACT INVOLVES CONTACT WITH ASBESTOS OR OTHER HAZARDOUS MATERIAL. IF FOUND OR SUSPECTED WITHIN THE AREAS OF DEMOLITION AND/OR CONSTRUCTION, NOTIFY OWNER IMMEDIATELY.
- CONFORM TO LOCAL BUILDING CODE FOR DEMOLITION, SAFETY OF ADJACENT STRUCTURES, DUST CONTROL, SERVICE UTILITIES AND DISCOVERED HAZARDS.
- PERMITS: GENERAL CONTRACTOR SHALL MAKE ALL ARRANGEMENTS, PAY FOR AND OBTAIN ALL DEMOLITION PERMITS, INCLUDING PERMITS REQUIRED TO DISCONNECT AND CAP ALL UTILITIES, AS REQUIRED, INCLUDING BUT NOT LIMITED TO DOMESTIC AND FIRE PROTECTION, WATER, GAS ELECTRICAL AND PHONE SERVICES, STORM AND SANITARY SEWERS.
- PRIOR TO CONTRACT, GENERAL CONTRACTOR SHALL INSPECT ALL AREAS AFFECTED BY DEMOLITION AND EXISTING CONSTRUCTION TO REMAIN, AS WELL AS ADJACENT AREAS AFFECTED BY DEMOLITION.
- GENERAL CONTRACTOR SHALL IMMEDIATELY NOTIFY THE OWNER OF ANY DISCREPANCIES OR HIDDEN CONDITIONS AFFECTING DEMOLITION OR PROPOSED NEW WORK.
- GENERAL CONTRACTOR SHALL REPAIR OR RESTORE TO EXISTING CONDITION ADJACENT CONSTRUCTION AND PUBLIC OR PRIVATE PROPERTY DAMAGED BY WORK.
- MAINTAIN PROTECTED EGRESS AND ACCESS AT ALL TIMES, DO NOT CLOSE OR OBSTRUCT ROADWAYS OR SIDEWALKS WITHOUT PERMITS. DO NOT CLOSE OR OBSTRUCT REQUIRED EXISTING EGRESS AT ANY TIME.
- CEASE OPERATIONS IMMEDIATELY IF ADJACENT STRUCTURES APPEAR TO BE IN DANGER. NOTIFY AUTHORITY HAVING JURISDICTION AND ARCHITECT/ ENGINEER.
- DISCONNECT, CAP AND IDENTIFY DESIGNATED UTILITIES, PER DRAWINGS AND AS REQUIRED.
- DEMOLISH COMPONENTS INDICATED, IN AN ORDERLY AND CAREFUL MANNER.
- COORDINATE SEQUENCE OF ALL DEMOLITION AND NEW CONSTRUCTION WITH OWNER.
- REMOVE DEMOLISHED MATERIALS FROM SITE AS WORK PROGRESSES.
- UPON COMPLETION OF DEMOLITION, THE PREMISES SHALL BE LEFT CLEAN AND CLEAR OF DEBRIS.

- 19. ANY PENETRATIONS TO EXISTING ROOFING SHALL MEET ALL REQUIREMENTS TO MAINTAIN OWNER WARRANTY, VERIFY REQUIREMENTS WITH OWNER.
- PROVIDE TEMPORARY SHORING AND BRACING MEMBERS WITH CONNECTIONS OF SUFFICIENT STRENGTH TO BEAR IMPOSING LOADS. REMOVE TEMPORARY CONNECTIONS AND MEMBERS WHEN PERMANENT MEMBERS ARE IN PLACE AND FINAL CONNECTIONS ARE MADE, LEVEL AND PLUMB INDIVIDUAL MEMBERS OF THE STRUCTURE WITHIN ACCEPTABLE TOLERANCES. G.C. SHALL ASSUME RESPONSIBILITY FOR PROVIDING ADEQUATE BRACING OF ALL WALLS DURING DEMOLITION AND CONSTRUCTION.
- 21. ALL WORK MUST COMPLY WITH O.S.H.A. SAFETY GUIDELINES.
- WHEN EXISTING MECHANICAL, PLUMBING AND/OR ELECTRICAL FIXTURES AND/OR EQUIPMENT ARE REMOVED FROM THE BUILDING, THEY ARE TO BE DISCONNECTED AT THE SOURCE. (UNLESS OTHERWISE NOTED)
- THE DOCUMENTS ASSUME ALL MECHANICAL, PLUMBING & ELECTRICAL DEVICES TO REMAIN ARE IN SATISFACTORY CONDITION AND ARE TO BE REUSED. ITEMS SCHEDULED FOR REUSE ARE TO BE INSPECTED BY A MECHANICAL/ ELECTRICAL CONTRACTOR AND THE OWNER SHALL BE ADVISED OF CONDITION FOR REUSE.
- ELECTRICAL CONTRACTOR SHALL DISCONNECT AND REMOVE ALL EXISTING ELECTRICAL, TELEPHONE OUTLETS AND ALL ASSOCIATED WIRES IN THE WALLS TO BE REMOVED AND TERMINATED AT THE LAST OUTLET THAT REMAINS IN SERVICE. COORDINATE WITH ELECTRICAL PLANS.
- ALL EMPTY CONDUIT AND JUNCTION BOXES TO BE REMOVED.

PROVIDE DETAILS ON THE PLAN.

- DEMOLITION CONTRACTOR SHALL REMOVE ALL FLOOR COVERINGS WHERE INDICATED AND GLUE AND PREPARE THE FLOOR FOR NEW FLOOR COVERINGS PER MFG WRITTEN RECOMMENDATIONS.
- CONTRACTOR SHALL AVOID ANY CUTTING OF EXISTING REINFORCEMENT OF EXISTING FLOOR DURING INSTALLATION OR DEMOLITION OF ANY CONDUIT OR PIPE, ETC.
- ALL DEBRIS, DIRTY WATER/RESIDUE FROM TILE CUTTING ETC MUST BE TAKEN OFF SITE AND DISPOSED OF CORRECTLY.
- REMOVE ALL TRASH FROM WORK SITE DAILY. BETWEEN THE HOURS OF 10 PM TO 4:30 AM.
- 30. ALL UNUSED EXISTING FLOOR PENETRATIONS MUST BE COMPLETELY FILLED AND PATCHED.
- AN AIR FILTER MUST BE INSTALLED ON THE RETURN AIR GRILL DURING DEMOLITION AND CONSTRUCTION. IT SHOULD BE CHECKED ROUTINELY AND REPLACED WHEN NEEDED.
- ALL UNUSED EXISTING FLOOR PENETRATIONS MUST BE COMPLETELY FILLED AND PATCHED.
- UTILITIES TO BE DEMOLISHED SHALL BE REMOVED TO THE SOURCE OR A TERMINATION POINT AS DESIGNATED BY A MA-224 REPRESENTATIVE INCLUSIVE OF BUT NOT LIMITED TO PIPE, EQUIPMENT, HANGERS, AND/OR ACCESSORIES.

BARRICADE NOTES:

- GC TO MAINTAIN INTEGRITY OF BARRICADE WALL.
- PROTECT AIRPORT FLOORING TO REMAIN. BARRICADE LOCKS MUST BE COMPATIBLE WITH BEST 7 PIN SYSTEM.
- BARRICADE CONSTRUCTION TO BE COORDINATED WITH WHITE BOX CONTRACTOR AND CONFIRMED WITH WILMINGTON INTERNATIONAL AIRPORT FOR APPROVAL CONTINUOUS CONSTRUCTION BARRICADE TO SEPARATE WORK AREA FROM NON-SECURE
- CONCOURSE AREAS. TAPE, FLOAT, AND PAINT CONCOURSE SIDE OF BARRICADE & INSTALL GRAPHICS PROJECT BY CONCESSIONS WHITE BOX CONTRACTOR PER WILMINGTON INTERNATIONAL AIRPORT
- TENANT IS RESPONSIBLE FOR COST AND INSTALLATION OF BARRICADE GRAPHIC.
- GC TO VERIFY DOOR LOCATION IN FIELD.
- GC IS RESPONSIBLE FOR RELOCATING ANY AIRPORT DEVICES SUCH AS STROBES, PULLS, TC., TO THE BARRICADE AS DIRECTED BY ILM.
- DEMOLITION OF DUST PARTITION AT CONCLUSION OF PROJECT BY GC.
- REPAIR ANY DAMAGES TO AIRPORT CEILING OR FLOORING AFTER REMOVAL OF BARRICADE.

UNDERSIDE OF ADJACENT CEILING PROVIDE 6ML VISQUEEN TO UNDERSIDE OF EXISTING ADJACENT CEILING, 18" OFF OF EXISTING CEILING, ALLOW FOR REMOVAL OF PLASTIC WITHOUT DAMAGE TO EXISTING ADJACENT CEILING. 3 5/8" METAL STUD 20 GA. 16" O.C. BRACE AT CORNER

DEMO. SIDE CONCOURSE SIDE 1 LAYER OF 5/8" TYPE X GWB CONCOURSE SIDE, WITH 2 COATS OF WHITE ILM APPROVED EGGSHELL PAINT

> BOTTOM TRACK SECURED TO FLOOR TO ALLOW FOR REMOVAL OF TRACK WITHOUT DAMAGE TO EXISTING FLOOR FINISH. BLACK RUBBER COVE BASE FINISH FLOOR TOP OF FLOOR SLAB

> > 3/4" PLYWOOD SECURED TO EXISTING FLOOR

CONTINUOUS CONSTRUCTION BARRICADE TO SEPERATE WORK AREA FROM NON-SECURE CONCOURSE AREAS TAPE, FLOAT, AND PAINT CONCOURSE SIDE OF BARRICADE AND INSTALL GRAPHICS PER LANDLORD DIRECTION. WITH COMMERCIAL GRADE DOUBLE SIDED TAPE

DEMOLITION NOTES

- NEW TEMPORARY BARRICADE BY GC. PROVIDE DEMOLITION OF BARRICADE AT
- CONCLUSION OF PROJECT, VINYL GRAPHICS BY OWNER. PROVIDE DOUBLE DOORS WITH LOCK FOR BARRICADE WALL. PROVIDE DOOR CLOSURE, PROVIDE ASTRAGAL, PROVIDE BEST 6-OR-7 PIN STORAGE LOCKSET, CONTRACTOR RESPONSIBLE FOR COMPLYING WITH AIRPORT STANDARDS. DOOR TYPE TO BE STEEL CRAFT HOLLOW METAL SERIES L.
- EXISTING AIRPORT TERRAZZO TO REMAIN. PROTECT FROM DAMAGE. GC TO REPAIR ANY
- DAMAGE CAUSED DURING DEMOLITION AND CONSTRUCTION.
- REMOVE EXISTING AIRPORT CARPET. PREPARE TO RECEIVE NEW FINISHES.
- EXISTING FURNISHINGS TO BE REMOVED OR RELOCATED. COORDINATE WITH OWNER'S
- REPRESENTATIVE ABOUT REMOVAL OR RELOCATION OF ANY FURNISHINGS. EXISTING COLUMN AND ENCLOSURE TO REMAIN.
- EXISTING WINDOWS TO REMAIN. PROTECT AND REPAIR IF DAMAGED.
- EXISTING WALL TO REMAIN. REMOVE EXISTING FINISHES ON TENANT SIDE, PATCH AND REPAIR EXISTING SUBSTRATE OR REPLACE WITH NEW IF NECESSARY, PREPARE TO RECEIVE
- NEW FINISHES. EXISTING AIRPORT FURNITURE TO BE REMOVED OR RELOCATED. COORDINATE WITH
- AIRPORT REPRESENTATIVE ABOUT REMOVAL OR RELOCATION OF ANY FURNISHINGS. EXISTING AIRPORT CEILING TO REMAIN, PROTECT AND REPAIR IF DAMAGED.
- EXISTING AIRPORT HEADERS TO REMAIN. PROTECT AND REPAIR IF DAMAGED.
- EXISTING AIRPORT LIGHT FIXTURES, CAMERAS, SPEAKERS, DIFFUSERS TO REMAIN. REMOVE EXISTING AIRPORT ACT TILES. ACT GRID CEILING TO REMAIN. PROTECT AND
- REPAIR IF DAMAGED.
- REMOVE EXISTING BASE BUILDING HEADER. REMOVE EXISTING LIGHTING FIXTURES, CAMERAS, SPEAKERS, DIFFUSERS, ETC.

GENERAL CONTRACTOR TO COORDINATE WITH ADJACENT TENANT REGARDING BARRICADE TERMINATION LOCATION.

WATERPROOF MEMBRANE NOTE:

OF ANY DISCREPENCIES OBSERVED.

VERIFY DIMENSIONS OF ALL EXISTING ITEMS IN FIELD. INFORM DESIGNER

GC TO VERIFY ALL FIELD DIMENSIONS AND CONTACT PROJECT

ARCHITECT WITH ANY SITE DISCREPANCIES.

FIRE RATED WOOD IS REQUIRED FOR ALL BLOCKING.

REFER TO ARCHITECTURAL, ELECTIRCAL, MECHANICAL, AND PLUMBING

FOR INCLUSION IN BASE BID. THE REQUIREMENT WILL BE STRICTLY

ENFORCED. NO CHANGE ORDERS WILL BE ALLOWED SHOULD THE

CONTRACTOR FAIL TO PERFORM THIS FUNCTION.

AND WRAP 6" UP WALLS.

DIMENSIONS NOTE:

GENERAL NOTE:

IMPORTANT BID NOTE:

60% SUBMITTAL EXISTING WALL

LEASE LINE GC TO PROVIDE CONTINUOUS WATERPROOF MEMBRANE IN WET AREAS

DEMOLITION FLOOR PLAN

Project number 2023-019 03-29-2023 DRAWINGS FOR ADDITIONAL NOTES, SPECIFICATIONS, DETAILS, CONTROLS ETC. THAT FORM A PART OF THIS CONTRACT. ANY CONFLICTS SHALL BE Drawn by BROUGHT TO THE ATTENTION OF THE ARCHITECT AND CLARIFIED BY THEM Checked by

As indicated

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BARRICADE SECTION





Date

06/23/2023

BW

WILMINGTON INTERNATIONAL AIRPORT 1740 AIRPORT BLVD, WILMINGTON, NC, 28405

DESIGN ARCHITECTURE

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DESIGNER:

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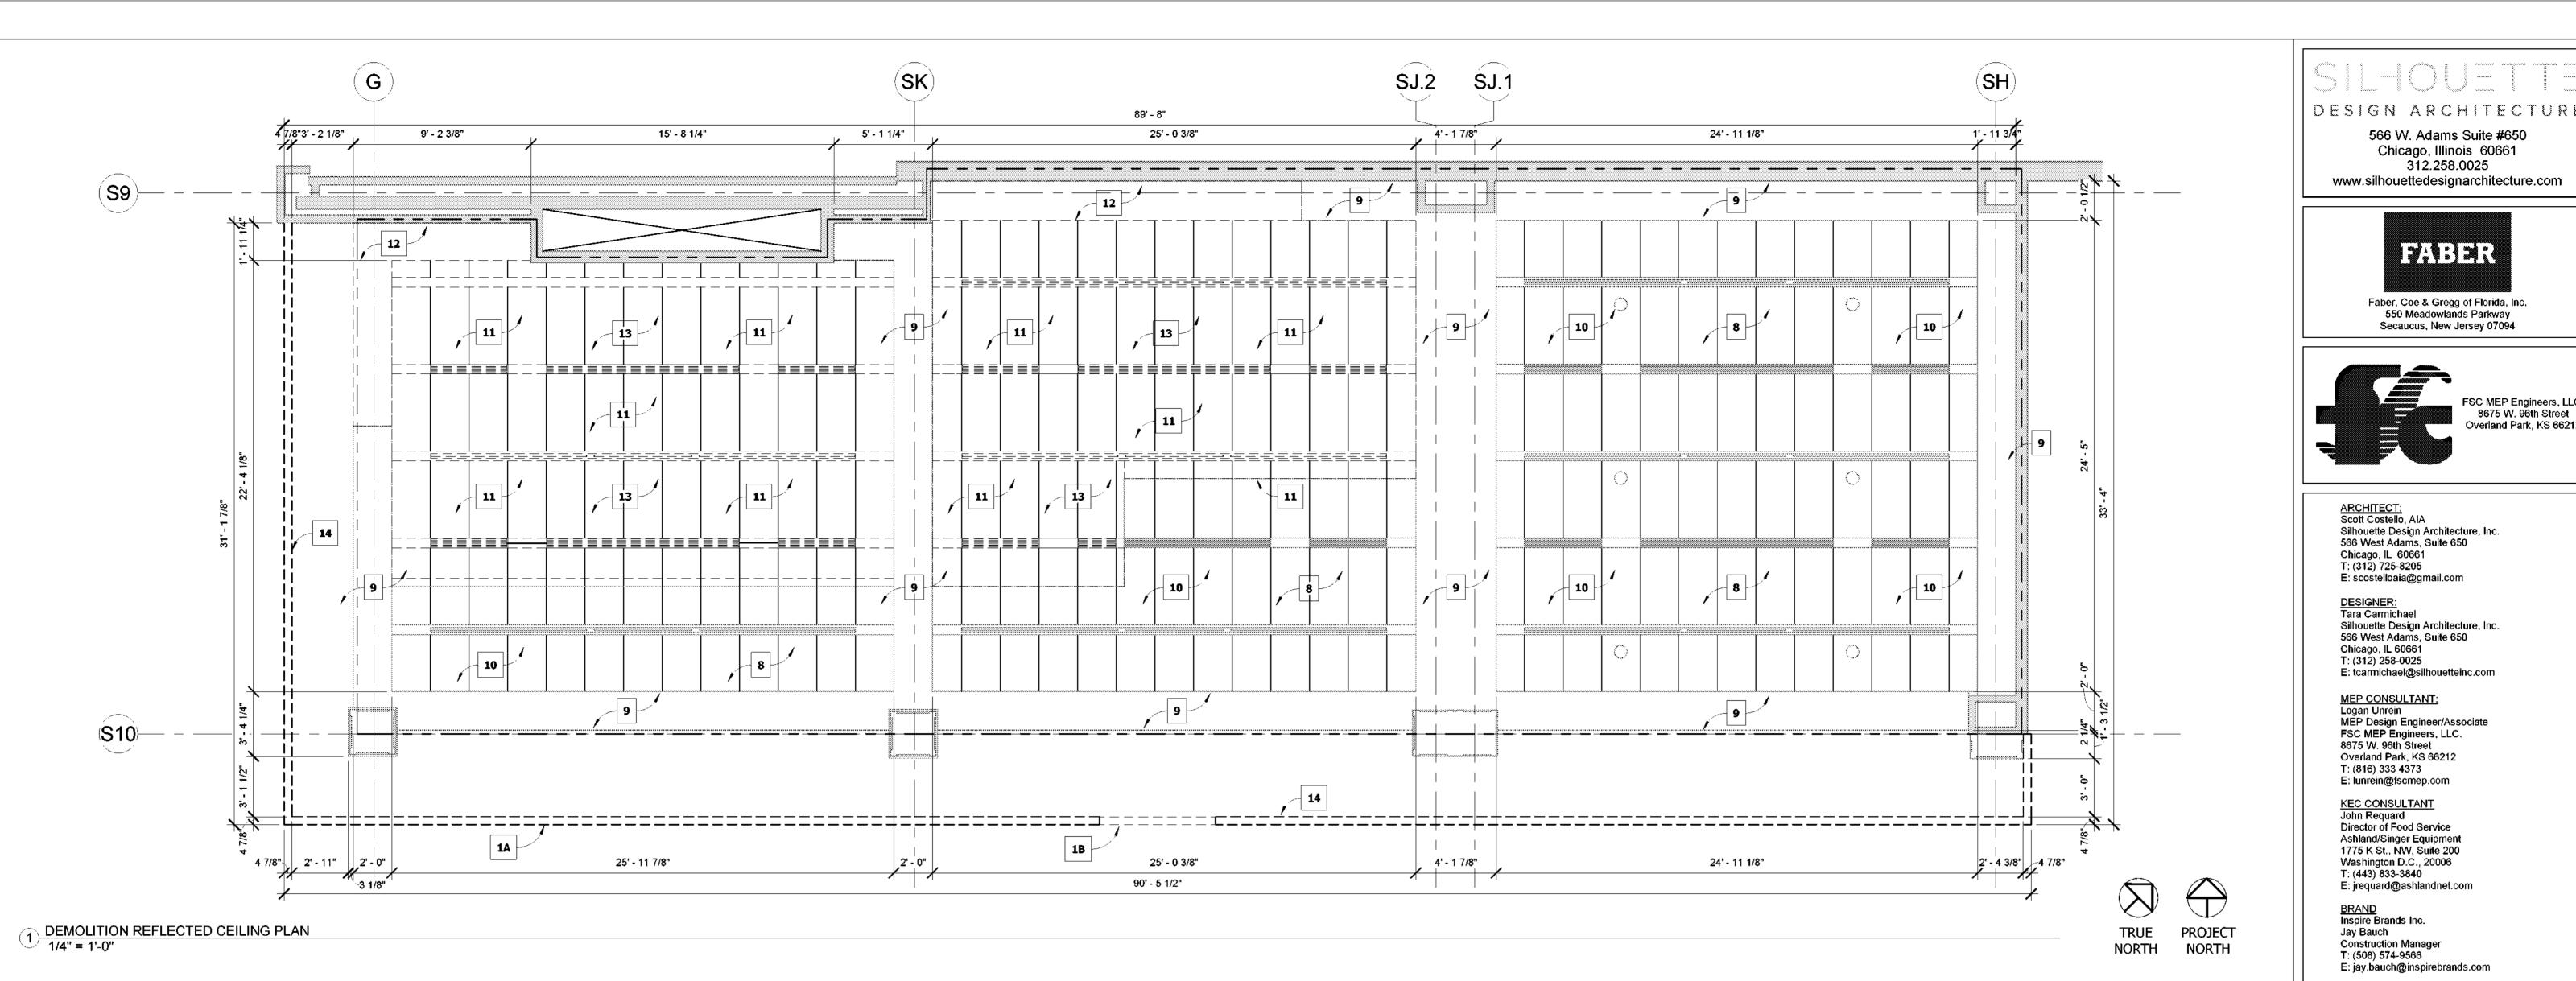
FSC MEP Engineers, LLC.

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312.258.0025 www.silhouettedesignarchitecture.com

BOARDING LEVEL, ZONE 1 SPACE: A, B, AND C

Description



GENERAL DEMOLITION NOTES

- DEMOLITION PLAN IS INDICATED FOR REFERENCE ONLY. GENERAL CONTRACTOR SHALL VERIFY ALL EXISTING CONDITIONS IN THE FIELD AND COORDINATE ALL REQUIRED DEMOLITION, AS REQUIRED, PER CONSTRUCTION DRAWINGS.
- REFER TO CONSTRUCTION PLANS FOR EXTENT OF NEW CONSTRUCTION.
- COORDINATE DEMOLITION WORK WITH ELECTRICAL DRAWINGS.
- CARE SHOULD BE TAKEN TO PROTECT, MAINTAIN, AND NOT INTERRUPT EXISTING SERVICES AND UTILITIES SERVING THE BLDG.
- GENERAL CONTRACTOR SHALL VERIFY ALL CONDITIONS IN THE FIELD AND NOTIFY ARCHITECT IMMEDIATELY OF ANY DISCREPANCIES BETWEEN PLANS AND EXISTING CONDITIONS.
- ASBESTOS/ HAZARDOUS WASTE CONTACT AND REMOVAL: THE OWNER SHALL BE IMMEDIATELY NOTIFIED IF DEMOLITION AND/OR CONSTRUCTION UNDER THIS CONTRACT INVOLVES CONTACT WITH ASBESTOS OR OTHER HAZARDOUS MATERIAL. IF FOUND OR SUSPECTED WITHIN THE AREAS OF DEMOLITION AND/OR CONSTRUCTION, NOTIFY OWNER IMMEDIATELY.
- CONFORM TO LOCAL BUILDING CODE FOR DEMOLITION, SAFETY OF ADJACENT STRUCTURES, DUST CONTROL, SERVICE UTILITIES AND DISCOVERED HAZARDS.
- PERMITS: GENERAL CONTRACTOR SHALL MAKE ALL ARRANGEMENTS, PAY FOR AND OBTAIN ALL DEMOLITION PERMITS, INCLUDING PERMITS REQUIRED TO DISCONNECT AND CAP ALL UTILITIES, AS REQUIRED, INCLUDING BUT NOT LIMITED TO DOMESTIC AND FIRE PROTECTION, WATER, GAS ELECTRICAL AND PHONE SERVICES, STORM AND SANITARY SEWERS.
- PRIOR TO CONTRACT, GENERAL CONTRACTOR SHALL INSPECT ALL AREAS AFFECTED BY DEMOLITION AND EXISTING CONSTRUCTION TO REMAIN, AS WELL AS ADJACENT AREAS AFFECTED BY DEMOLITION.
- GENERAL CONTRACTOR SHALL IMMEDIATELY NOTIFY THE OWNER OF ANY DISCREPANCIES OR HIDDEN CONDITIONS AFFECTING DEMOLITION OR PROPOSED NEW WORK.
- 11. GENERAL CONTRACTOR SHALL REPAIR OR RESTORE TO EXISTING CONDITION ADJACENT CONSTRUCTION AND PUBLIC OR PRIVATE PROPERTY DAMAGED BY WORK.
- MAINTAIN PROTECTED EGRESS AND ACCESS AT ALL TIMES. DO NOT CLOSE OR OBSTRUCT ROADWAYS OR SIDEWALKS WITHOUT PERMITS. DO NOT CLOSE OR OBSTRUCT REQUIRED EXISTING EGRESS AT ANY TIME.
- CEASE OPERATIONS IMMEDIATELY IF ADJACENT STRUCTURES APPEAR TO BE IN DANGER. NOTIFY AUTHORITY HAVING JURISDICTION AND ARCHITECT/ ENGINEER.
- DISCONNECT, CAP AND IDENTIFY DESIGNATED UTILITIES, PER DRAWINGS AND AS REQUIRED.
- DEMOLISH COMPONENTS INDICATED, IN AN ORDERLY AND CAREFUL MANNER.
- COORDINATE SEQUENCE OF ALL DEMOLITION AND NEW CONSTRUCTION WITH OWNER.
- 17. REMOVE DEMOLISHED MATERIALS FROM SITE AS WORK PROGRESSES.
- 18. UPON COMPLETION OF DEMOLITION, THE PREMISES SHALL BE LEFT CLEAN AND CLEAR OF

- 19. ANY PENETRATIONS TO EXISTING ROOFING SHALL MEET ALL REQUIREMENTS TO MAINTAIN OWNER WARRANTY, VERIFY REQUIREMENTS WITH OWNER.
- PROVIDE TEMPORARY SHORING AND BRACING MEMBERS WITH CONNECTIONS OF SUFFICIENT STRENGTH TO BEAR IMPOSING LOADS. REMOVE TEMPORARY CONNECTIONS AND MEMBERS WHEN PERMANENT MEMBERS ARE IN PLACE AND FINAL CONNECTIONS ARE MADE. LEVEL AND PLUMB INDIVIDUAL MEMBERS OF THE STRUCTURE WITHIN ACCEPTABLE TOLERANCES, G.C. SHALL ASSUME RESPONSIBILITY FOR PROVIDING ADEQUATE BRACING OF ALL WALLS DURING DEMOLITION AND CONSTRUCTION.
- 21. ALL WORK MUST COMPLY WITH O.S.H.A. SAFETY GUIDELINES.
- WHEN EXISTING MECHANICAL, PLUMBING AND/OR ELECTRICAL FIXTURES AND/OR EOUIPMENT ARE REMOVED FROM THE BUILDING, THEY ARE TO BE DISCONNECTED AT THE SOURCE. (UNLESS OTHERWISE NOTED)
- THE DOCUMENTS ASSUME ALL MECHANICAL, PLUMBING & ELECTRICAL DEVICES TO REMAIN ARE IN SATISFACTORY CONDITION AND ARE TO BE REUSED. ITEMS SCHEDULED FOR REUSE ARE TO BE INSPECTED BY A MECHANICAL/ ELECTRICAL CONTRACTOR AND THE OWNER SHALL BE ADVISED OF CONDITION FOR REUSE.
- ELECTRICAL CONTRACTOR SHALL DISCONNECT AND REMOVE ALL EXISTING ELECTRICAL. TELEPHONE OUTLETS AND ALL ASSOCIATED WIRES IN THE WALLS TO BE REMOVED AND TERMINATED AT THE LAST OUTLET THAT REMAINS IN SERVICE. COORDINATE WITH ELECTRICAL PLANS.
- 25. ALL EMPTY CONDUIT AND JUNCTION BOXES TO BE REMOVED.
- DEMOLITION CONTRACTOR SHALL REMOVE ALL FLOOR COVERINGS WHERE INDICATED AND GLUE AND PREPARE THE FLOOR FOR NEW FLOOR COVERINGS PER MFG WRITTEN RECOMMENDATIONS.
- 27. CONTRACTOR SHALL AVOID ANY CUTTING OF EXISTING REINFORCEMENT OF EXISTING FLOOR DURING INSTALLATION OR DEMOLITION OF ANY CONDUIT OR PIPE, ETC.
- ALL DEBRIS, DIRTY WATER/RESIDUE FROM TILE CUTTING ETC MUST BE TAKEN OFF SITE AND DISPOSED OF CORRECTLY.
- REMOVE ALL TRASH FROM WORK SITE DAILY. BETWEEN THE HOURS OF 10 PM TO 4:30 AM.
- ALL UNUSED EXISTING FLOOR PENETRATIONS MUST BE COMPLETELY FILLED AND PATCHED.
- AN AIR FILTER MUST BE INSTALLED ON THE RETURN AIR GRILL DURING DEMOLITION AND CONSTRUCTION. IT SHOULD BE CHECKED ROUTINELY AND REPLACED WHEN NEEDED.
- ALL UNUSED EXISTING FLOOR PENETRATIONS MUST BE COMPLETELY FILLED AND PATCHED. PROVIDE DETAILS ON THE PLAN.
- 33. UTILITIES TO BE DEMOLISHED SHALL BE REMOVED TO THE SOURCE OR A TERMINATION POINT AS DESIGNATED BY A MA-224 REPRESENTATIVE INCLUSIVE OF BUT NOT LIMITED TO PIPE, EQUIPMENT, HANGERS, AND/OR ACCESSORIES.

DEMOLITION NOTES

- NEW TEMPORARY BARRICADE BY GC. PROVIDE DEMOLITION OF BARRICADE AT CONCLUSION OF PROJECT. VINYL GRAPHICS BY OWNER.
- PROVIDE DOUBLE DOORS WITH LOCK FOR BARRICADE WALL. PROVIDE DOOR CLOSURE, PROVIDE ASTRAGAL, PROVIDE BEST 6-OR-7 PIN STORAGE LOCKSET, CONTRACTOR RESPONSIBLE FOR COMPLYING WITH AIRPORT STANDARDS, DOOR TYPE TO BE STEEL CRAFT HOLLOW METAL SERIES L.
- EXISTING AIRPORT TERRAZZO TO REMAIN, PROTECT FROM DAMAGE, GC TO REPAIR ANY
- DAMAGE CAUSED DURING DEMOLITION AND CONSTRUCTION. REMOVE EXISTING AIRPORT CARPET, PREPARE TO RECEIVE NEW FINISHES.
- EXISTING FURNISHINGS TO BE REMOVED OR RELOCATED. COORDINATE WITH OWNER'S REPRESENTATIVE ABOUT REMOVAL OR RELOCATION OF ANY FURNISHINGS.
- EXISTING COLUMN AND ENCLOSURE TO REMAIN.
- EXISTING WINDOWS TO REMAIN, PROTECT AND REPAIR IF DAMAGED. EXISTING WALL TO REMAIN. REMOVE EXISTING FINISHES ON TENANT SIDE, PATCH AND
- REPAIR EXISTING SUBSTRATE OR REPLACE WITH NEW IF NECESSARY. PREPARE TO RECEIVE
- NEW FINISHES. EXISTING AIRPORT FURNITURE TO BE REMOVED OR RELOCATED, COORDINATE WITH
- AIRPORT REPRESENTATIVE ABOUT REMOVAL OR RELOCATION OF ANY FURNISHINGS. EXISTING AIRPORT CEILING TO REMAIN. PROTECT AND REPAIR IF DAMAGED.
- EXISTING AIRPORT HEADERS TO REMAIN. PROTECT AND REPAIR IF DAMAGED.
- EXISTING AIRPORT LIGHT FIXTURES, CAMERAS, SPEAKERS, DIFFUSERS TO REMAIN.
- REMOVE EXISTING AIRPORT ACT TILES. ACT GRID CEILING TO REMAIN. PROTECT AND
- REPAIR IF DAMAGED. REMOVE EXISTING BASE BUILDING HEADER.
- REMOVE EXISTING LIGHTING FIXTURES, CAMERAS, SPEAKERS, DIFFUSERS, ETC.
 - TERMINATION LOCATION.
- GENERAL CONTRACTOR TO COORDINATE WITH ADJACENT TENANT REGARDING BARRICADE

BARRICADE NOTES:

- GC TO MAINTAIN INTEGRITY OF BARRICADE WALL
- PROTECT AIRPORT FLOORING TO REMAIN. BARRICADE LOCKS MUST BE COMPATIBLE WITH BEST 7 PIN SYSTEM.
- BARRICADE CONSTRUCTION TO BE COORDINATED WITH WHITE BOX CONTRACTOR AND CONFIRMED WITH WILMINGTON INTERNATIONAL AIRPORT FOR APPROVAL.
- CONTINUOUS CONSTRUCTION BARRICADE TO SEPARATE WORK AREA FROM NON-SECURE CONCOURSE AREAS.
- TAPE, FLOAT, AND PAINT CONCOURSE SIDE OF BARRICADE & INSTALL GRAPHICS PROJECT BY CONCESSIONS WHITE BOX CONTRACTOR PER WILMINGTON INTERNATIONAL AIRPORT
- DIRECTION.
- TENANT IS RESPONSIBLE FOR COST AND INSTALLATION OF BARRICADE GRAPHIC. GC TO VERIFY DOOR LOCATION IN FIELD.
- GC IS RESPONSIBLE FOR RELOCATING ANY AIRPORT DEVICES SUCH AS STROBES, PULLS, ETC., TO THE BARRICADE AS DIRECTED BY ILM.
- DEMOLITION OF DUST PARTITION AT CONCLUSION OF PROJECT BY GC.
- REPAIR ANY DAMAGES TO AIRPORT CEILING OR FLOORING AFTER REMOVAL OF BARRICADE.

WALL LEGEND

EXISTING WALL

LEASE LINE

WATERPROOF MEMBRANE NOTE: GC TO PROVIDE CONTINUOUS WATERPROOF MEMBRANE IN WET AREAS AND WRAP 6" UP WALLS.

DIMENSIONS NOTE: VERIFY DIMENSIONS OF ALL EXISTING ITEMS IN FIELD. INFORM DESIGNER OF ANY DISCREPENCIES OBSERVED.

GENERAL NOTE: GC TO VERIFY ALL FIELD DIMENSIONS AND CONTACT PROJECT ARCHITECT WITH ANY SITE DISCREPANCIES.

FIRE RATED WOOD IS REQUIRED FOR ALL BLOCKING.

IMPORTANT BID NOTE: REFER TO ARCHITECTURAL, ELECTIRCAL, MECHANICAL, AND PLUMBING DRAWINGS FOR ADDITIONAL NOTES, SPECIFICATIONS, DETAILS, CONTROLS ETC. THAT FORM A PART OF THIS CONTRACT. ANY CONFLICTS SHALL BE BROUGHT TO THE ATTENTION OF THE ARCHITECT AND CLARIFIED BY THEM FOR INCLUSION IN BASE BID. THE REQUIREMENT WILL BE STRICTLY ENFORCED. NO CHANGE ORDERS WILL BE ALLOWED SHOULD THE CONTRACTOR FAIL TO PERFORM THIS FUNCTION.

DEMOLITION REFLECTED CEILING **PLAN**

WILMINGTON INTERNATIONAL AIRPORT

1740 AIRPORT BLVD,

WILMINGTON, NC, 28405

BOARDING LEVEL, ZONE 1

SPACE: A, B, AND C

Date

06/23/2023

Description

60% SUBMITTAL

566 W. Adams Suite #650 Chicago, Illinois 60661 312.258.0025 www.silhouettedesignarchitecture.com

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KEC CONSULTANT John Requard

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Construction Manager

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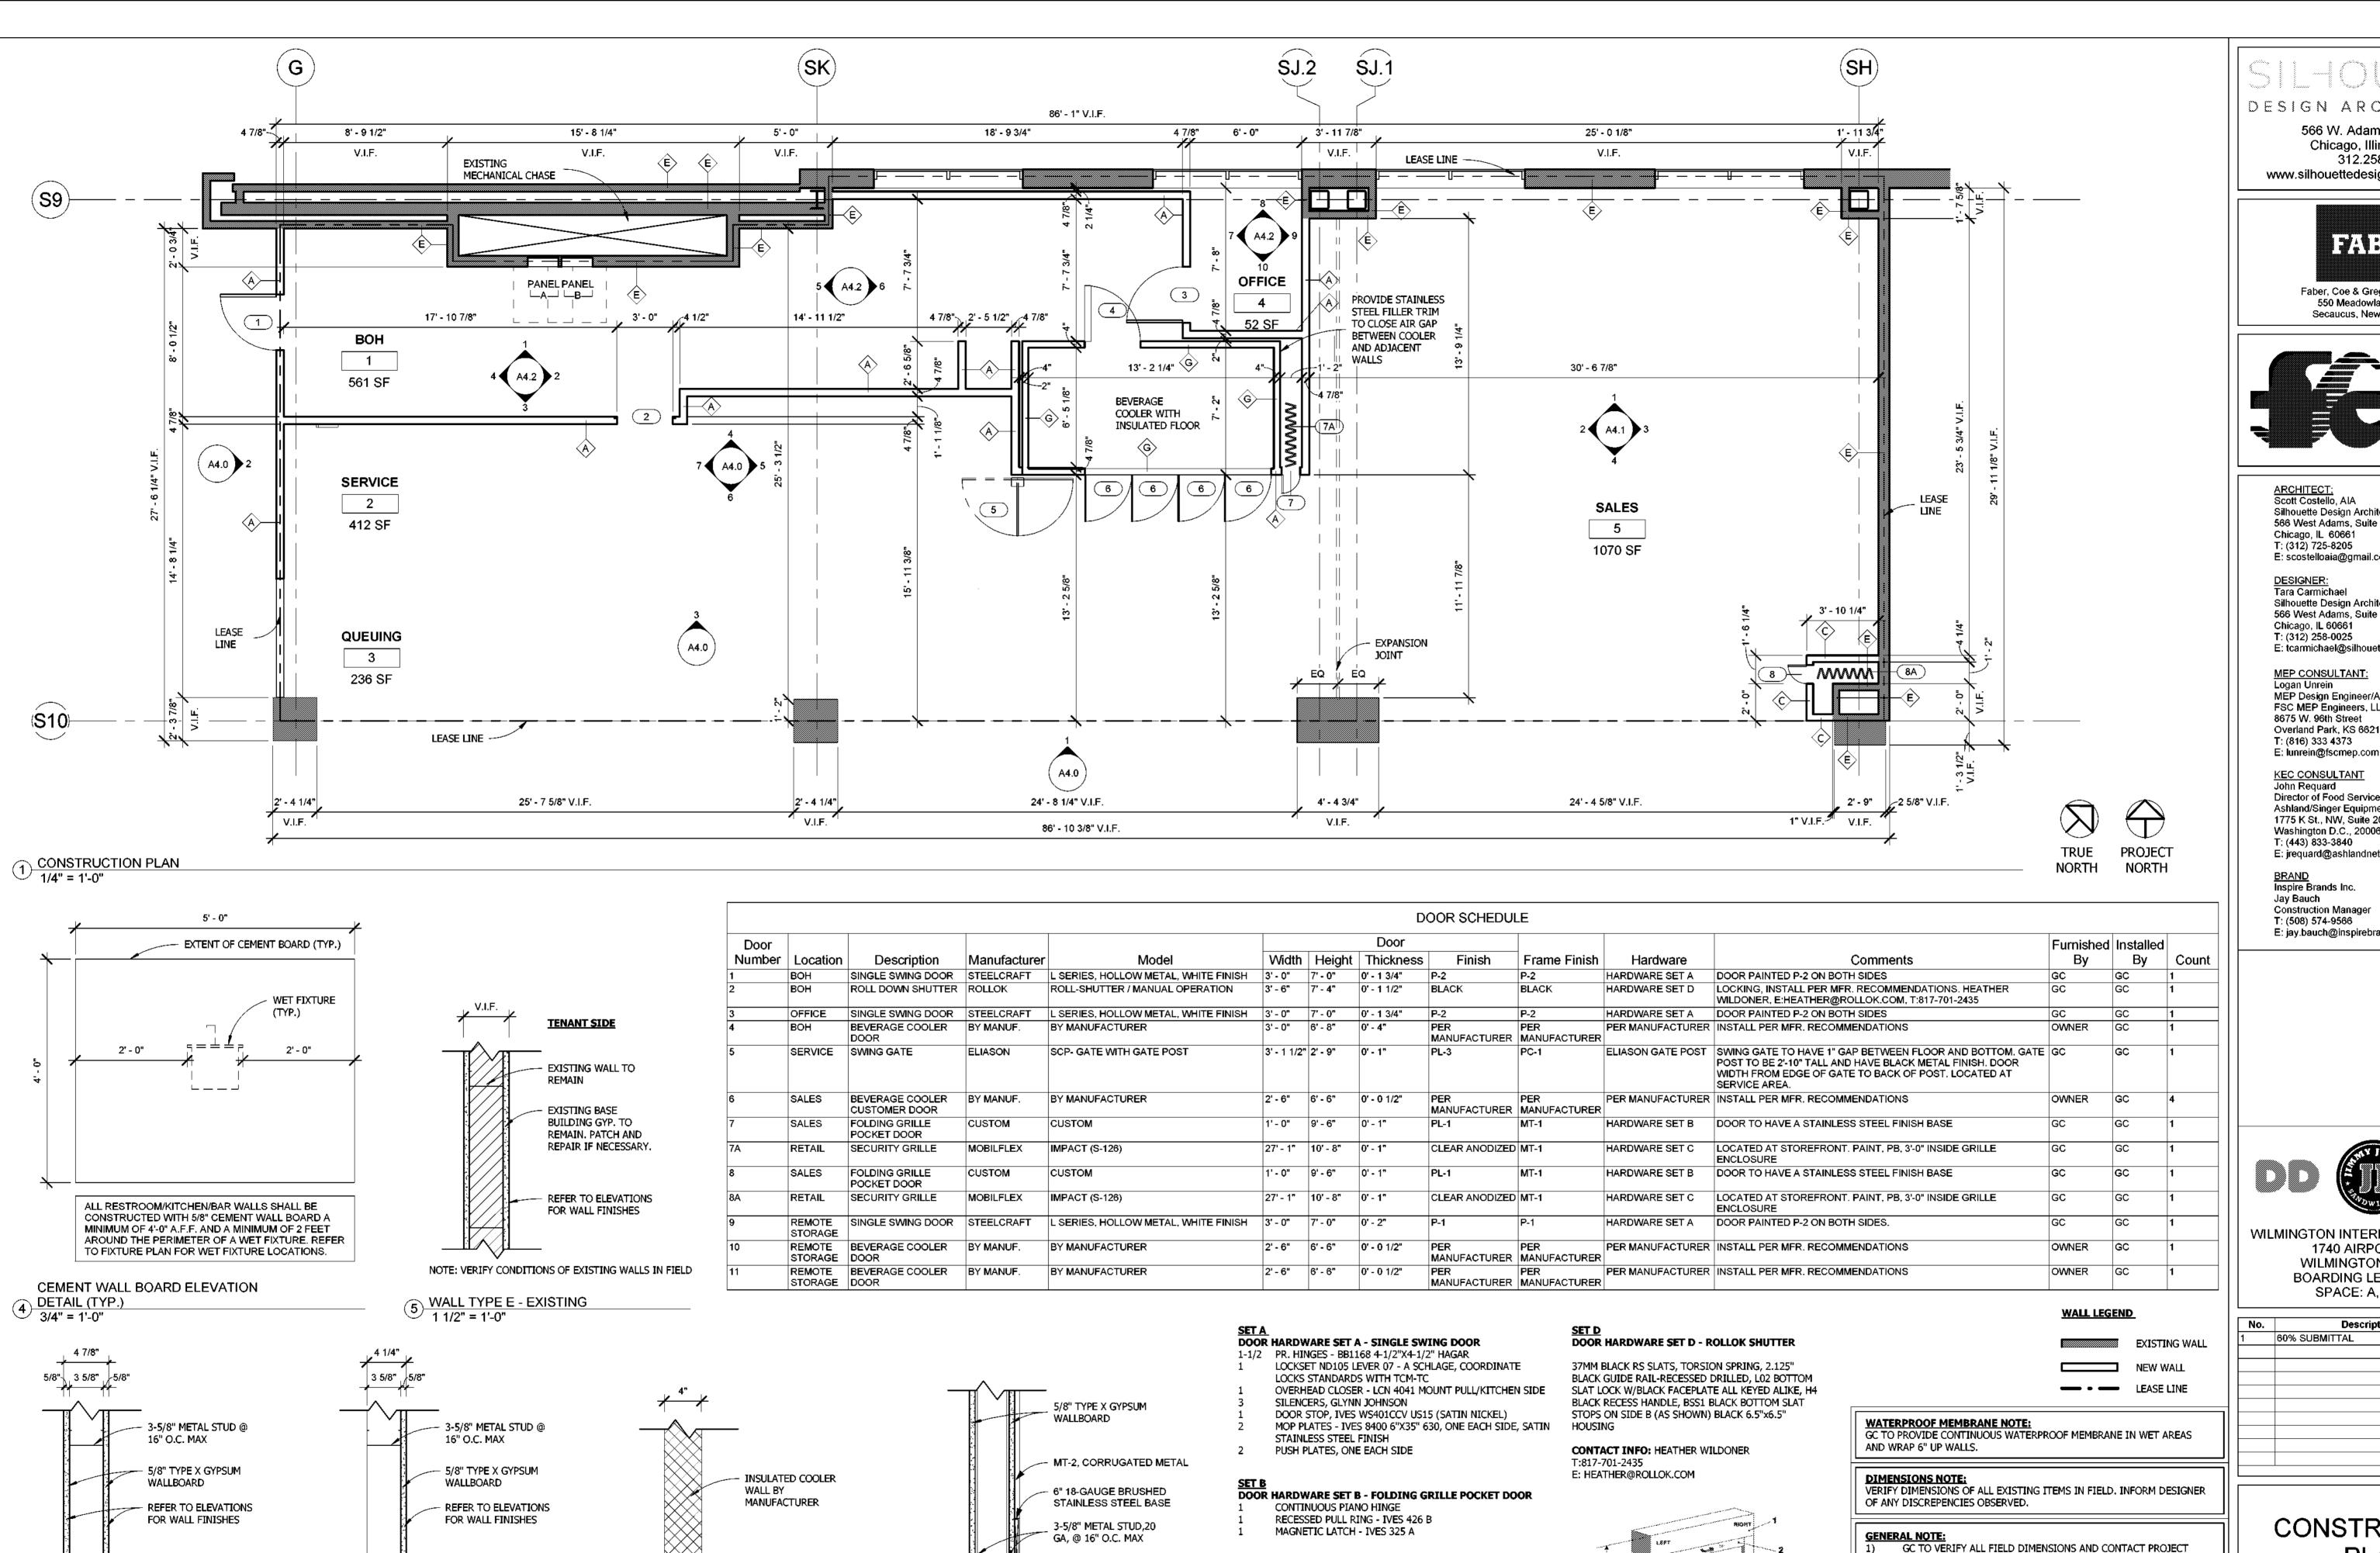
MEP Design Engineer/Associate FSC MEP Engineers, LLC. 8675 W. 96th Street Overland Park, KS 66212 T: (816) 333 4373 E: lunrein@fscmep.com

FSC MEP Engineers, LLC. 8675 W. 96th Street Overland Park, KS 66212

Project number 2023-019 03-29-2023 Drawn by BW Checked by

1/4" = 1'-0" Scale

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NOTE: REFER TO ELEVATIONS FOR WALL FINISHES. NO

MITRED STEEL CORNERS; BASE TO WRAP THE CORNER

STAINLESS STEEL BASE

1 1/2" = 1'-0"

3 WALL TYPE G - COOLER 1 1/2" = 1'-0"

WALL TYPE C - (1) GYP LAYER

2 WALL TYPE A 1 1/2" = 1'-0"

CONCRETE SLAB

DOOR HARDWARE SET C - SECURITY GRILLE PROVIDE INTERMEDIATE POST PER MFR

STRIKE AT POSTS

FLUSH BOLT LOCATIONS

KEYED ACCESS EXTERIOR / TUMB TURN INTERIOR

PROVIDE NOTICE: 'GRILLE MUST BE OPEN DURING

(POLYCARBONATE PANELS) PROVIDES DP-1 DUST PROOF

ONE SWING OUT EGRESS DOORS IN GRILLE.

DESIGN ARCHITECTURE

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T: (312) 725-8205 E: scostelloaia@gmail.com DESIGNER: Tara Carmichael

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BRAND Inspire Brands Inc. Jay Bauch **Construction Manager** T: (508) 574-9566 E: jay.bauch@inspirebrands.com



ARCHITECT WITH ANY SITE DISCREPANCIES. FIRE RATED WOOD IS REQUIRED FOR ALL BLOCKING.

ENFORCED. NO CHANGE ORDERS WILL BE ALLOWED SHOULD THE

CONTRACTOR FAIL TO PERFORM THIS FUNCTION.



WILMINGTON INTERNATIONAL AIRPORT 1740 AIRPORT BLVD, WILMINGTON, NC, 28405 **BOARDING LEVEL, ZONE 1**


SPACE: A, B, AND C

No.	Description	Date
1	60% SUBMITTAL	06/23/2023

CONSTRUCTION **PLAN**

IMPORTANT BID NOTE:	Project number	2023-019
REFER TO ARCHITECTURAL, ELECTIRCAL, MECHANICAL, AND PLUMBING DRAWINGS FOR ADDITIONAL NOTES, SPECIFICATIONS, DETAILS, CONTROLS,	Date	03-29-2023
ETC. THAT FORM A PART OF THIS CONTRACT. ANY CONFLICTS SHALL BE BROUGHT TO THE ATTENTION OF THE ARCHITECT AND CLARIFIED BY THEM	Drawn by	AR
FOR INCLUSION IN BASE BID. THE REQUIREMENT WILL BE STRICTLY	Checked by	BW

As indicated

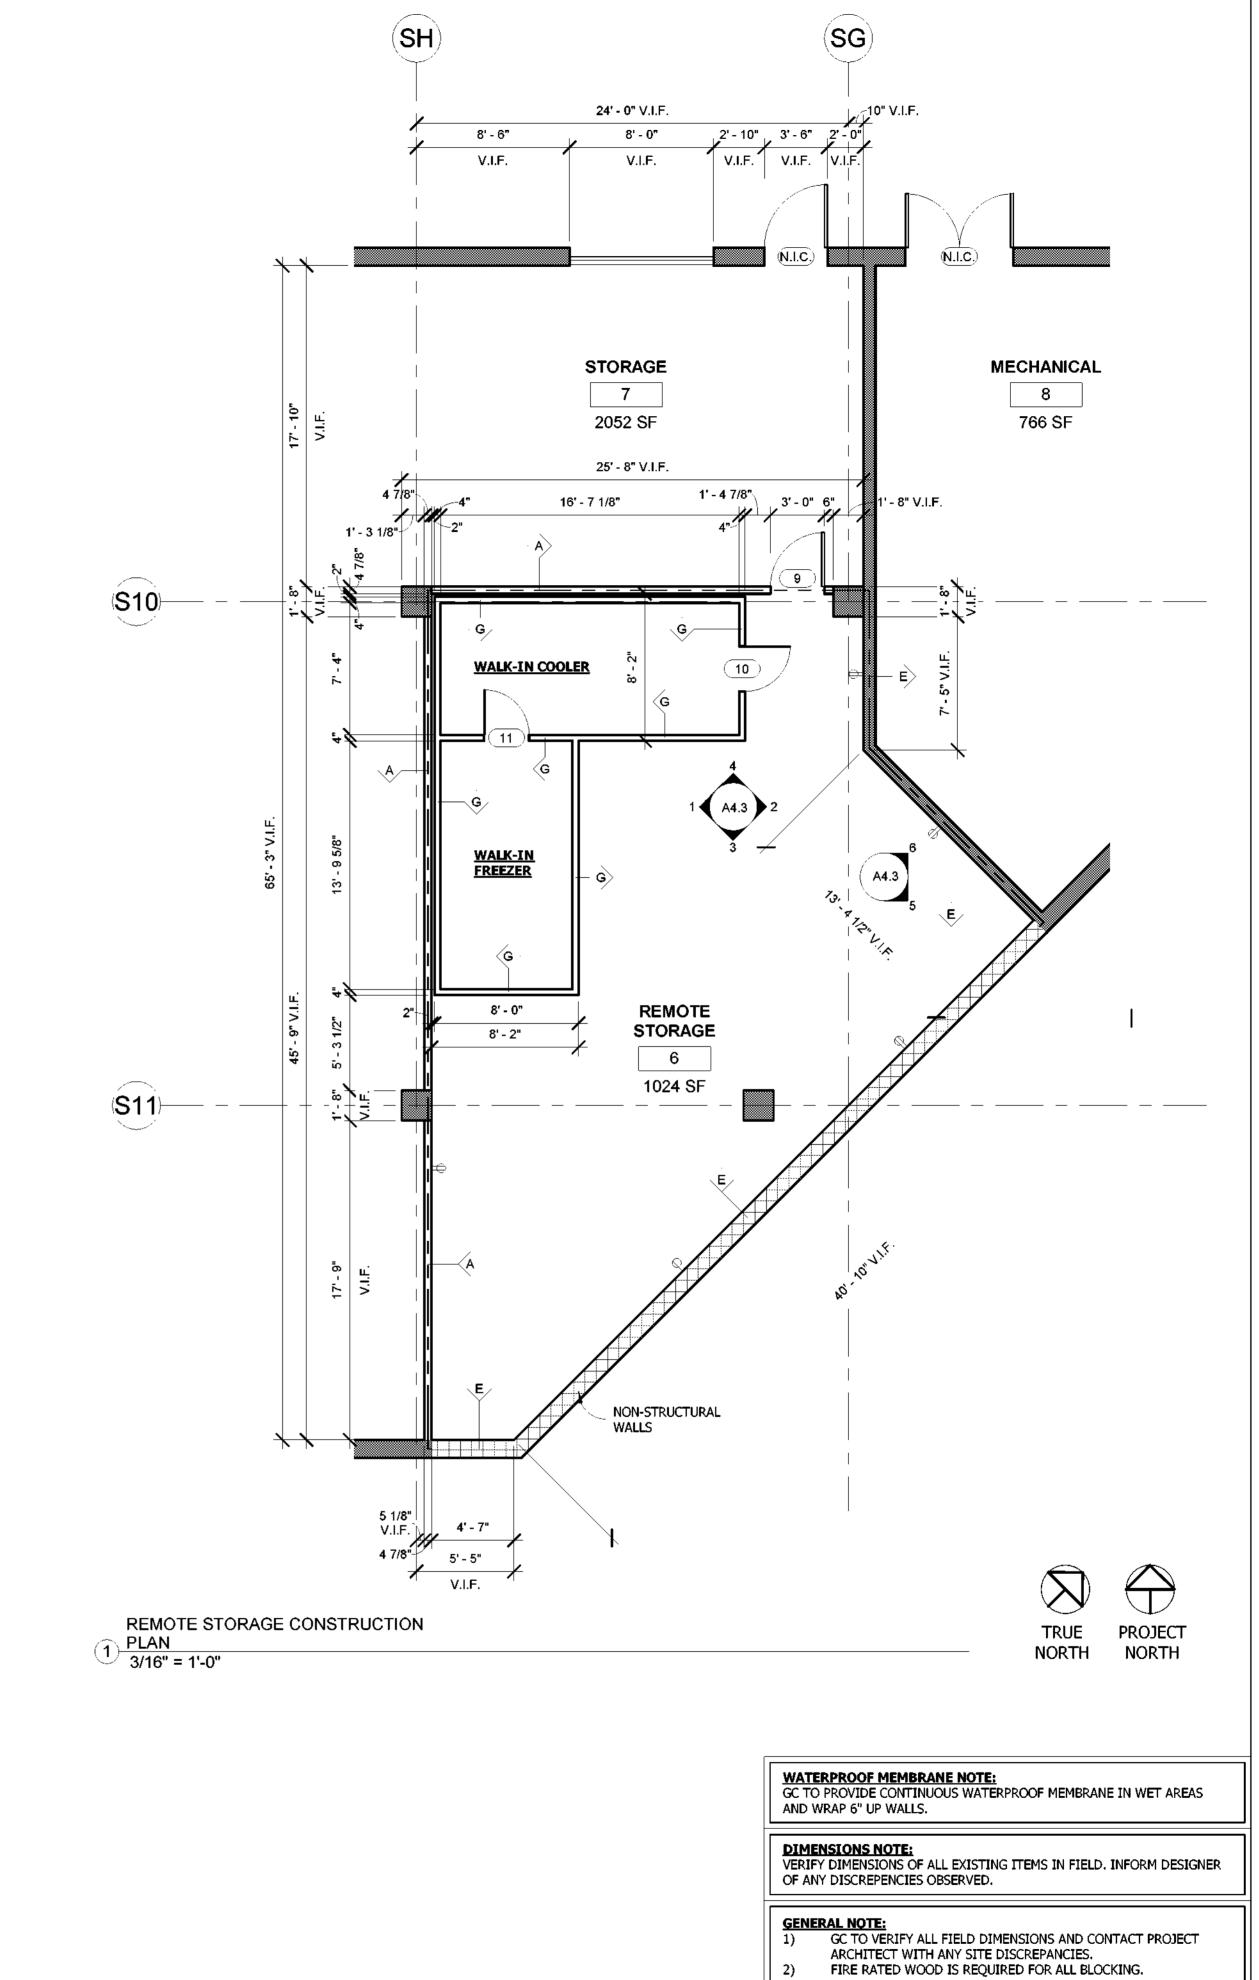

WALL LEGEND

EXISTING WALL

NEW WALL

- LEASE LINE

IMPORTANT BID NOTE:
REFER TO ARCHITECTURAL, ELECTIRCAL, MECHANICAL, AND PLUMBING

FOR INCLUSION IN BASE BID. THE REQUIREMENT WILL BE STRICTLY

ENFORCED. NO CHANGE ORDERS WILL BE ALLOWED SHOULD THE

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DRAWINGS FOR ADDITIONAL NOTES, SPECIFICATIONS, DETAILS, CONTROLS, ETC. THAT FORM A PART OF THIS CONTRACT. ANY CONFLICTS SHALL BE

BROUGHT TO THE ATTENTION OF THE ARCHITECT AND CLARIFIED BY THEM

SILIOUETTE

DESIGN ARCHITECTURE

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Jay Bauch
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WILMINGTON INTERNATIONAL AIRPORT 1740 AIRPORT BLVD, WILMINGTON, NC, 28405 BOARDING LEVEL, ZONE 1

No. Description Date

1 60% SUBMITTAL 06/23/2023

SPACE: A, B, AND C

REMOTE STORAGE CONSTRUCTION PLAN

 Project number
 2023-019

 Date
 03-29-2023

 Drawn by
 AR


 Checked by
 BW

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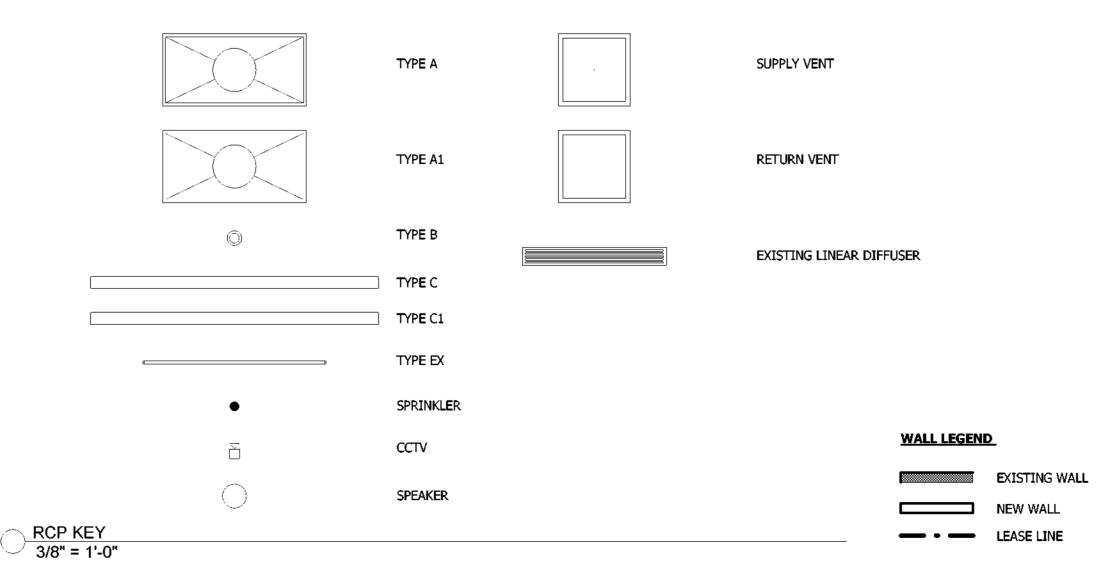
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	LIGHTING FIXTURE SCHEDULE. NO SUBSTITUTIONS. USE SPECIFIED VENDORS.										
Туре	Description	Manufacturer	Model	Listing	Lamp	Wattage	Vendor	Comments	Furnished	Installed	Count
Α	2X4 TROFFER	TCP	2X4 TROFFER, 39W, 3000K, COLOR: WHITE, TCP-DTF4UZD3930K	UL	LED	39W	LIGHTOLOGY, ASHLEY RUTTER, T: 312-229-7458, E: ARUTTER@LIGHTOLOGY.COM	TO BE USED AT BACK OF HOUSE	GC	GC	7
A1	2X4 SUSPENDED TROFFER	GREEN CREATIVE	3000K, SUSPENDED LIGHT, ORDER WITH SUSPCABLE24 ACCESSORY	ETL	LED	38W	LIGHTOLOGY, ASHLEY RUTTER, T: 312-229-7458, E: ARUTTER@LIGHTOLOGY.COM	TO BE USED AT REMOTE STORAGE	GC	GC	10
В	RECESSED DOWNLIGHT		NIO-4RNDC-30X (3000K)-WW WHITE/WHITE / 10 / 14W, NEW CONSTRUCTION	UL	LED	14W	LIGHTOLOGY, ASHLEY RUTTER, T: 312-229-7458, E: ARUTTER@LIGHTOLOGY.COM	TO BE USED AT SERVICE AREA	GC	GC	5
С	DUNKIN' ORANGE LIGHT BAR		EDGE EX3, 3" SUSPENDED DIRECT LINEAR 96" LENGTH, 80 CRI 830 HE, 3000K. FINISH: RAL 2003	UL	LED	37W	LIGHTOLOGY, ASHLEY RUTTER, T: 312-229-7458, E: ARUTTER@LIGHTOLOGY.COM	LOCATED AT SERVICE FRONT COUNTER	GC	GC	1
C1	JIMMY JOHN'S GREY LIGHT BAR	1	EDGE EX3, 3" SUSPENDED DIRECT LINEAR 96" LENGTH, 80 CRI 830 HE, 3000K. FINISH: RAL 9004	UL	LED	37W	LIGHTOLOGY, ASHLEY RUTTER, T: 312-229-7458, E: ARUTTER@LIGHTOLOGY.COM	LOCATED AT SERVICE FRONT COUNTER	GC	GC	1
EX	LINEAR LIGHT	EXISTING	EXISTING	EXISTING	EXISTING	EXISTING	EXISTING	EXISTING LINEAR LIGHT	EXISTING	EXISTING	24



GC TO PROVIDE CONTINUOUS WATERPROOF MEMBRANE IN WET AREAS
AND WRAP 6" UP WALLS.

DIMENSIONS NOTE:

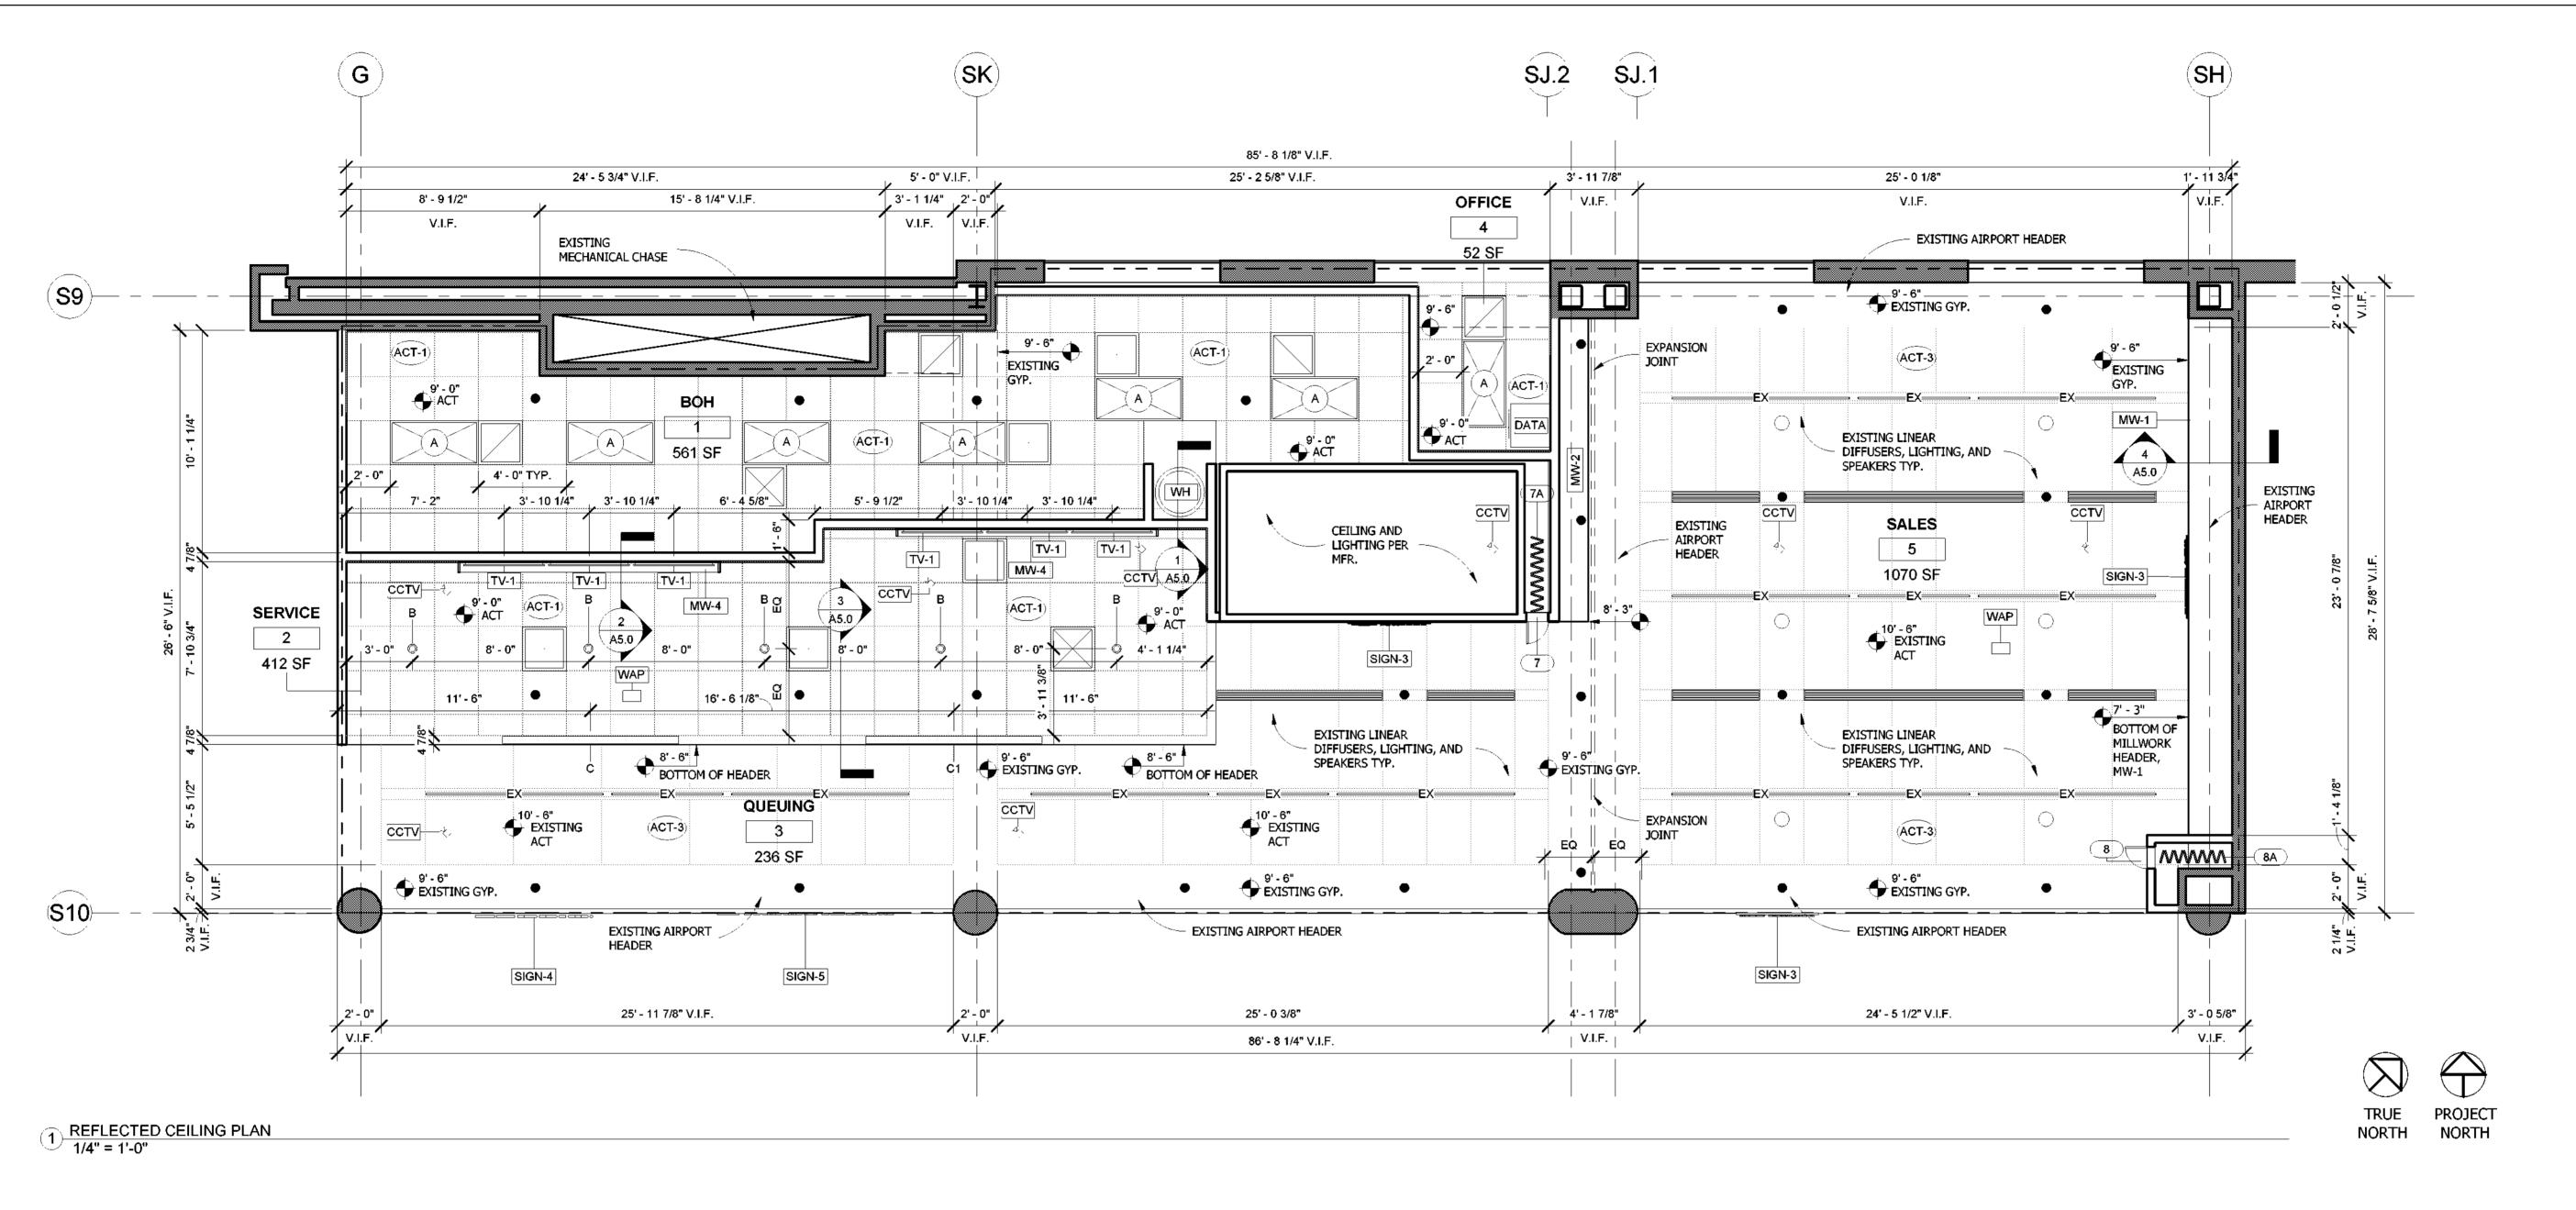OF ANY DISCREPENCIES OBSERVED.

GENERAL NOTE:

WATERPROOF MEMBRANE NOTE:

1) GC TO VERIFY ALL FIELD DIMENSIONS AND CONTACT PROJECT ARCHITECT WITH ANY SITE DISCREPANCIES.
2) FIRE RATED WOOD IS REQUIRED FOR ALL BLOCKING.

VERIFY DIMENSIONS OF ALL EXISTING ITEMS IN FIELD. INFORM DESIGNER

IMPORTANT BID NOTE:

REFER TO ARCHITECTURAL, ELECTIRCAL, MECHANICAL, AND PLUMBING DRAWINGS FOR ADDITIONAL NOTES, SPECIFICATIONS, DETAILS, CONTROLS, ETC. THAT FORM A PART OF THIS CONTRACT. ANY CONFLICTS SHALL BE BROUGHT TO THE ATTENTION OF THE ARCHITECT AND CLARIFIED BY THEM FOR INCLUSION IN BASE BID. THE REQUIREMENT WILL BE STRICTLY ENFORCED. NO CHANGE ORDERS WILL BE ALLOWED SHOULD THE CONTRACTOR FAIL TO PERFORM THIS FUNCTION.

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Written dimensions on these drawings shall have precedence over scaled dimensions: Contractors shall verify and be responsible for all dimensions and conditions shown by these drawings. Shop drawings must be submitted to this office for review before proceeding with fabrication. COPYRIGHT 2023 Scott Costello, AIA.

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Jay Bauch
Construction Manager
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E: jay.bauch@inspirebrands.com





06/23/2023

WILMINGTON INTERNATIONAL AIRPORT 1740 AIRPORT BLVD, WILMINGTON, NC, 28405 BOARDING LEVEL, ZONE 1 SPACE: A, B, AND C

60% SUBMITTAL

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REFLECTED CEILING PLAN

Project number 2023-019


Date 03-29-2023

Drawn by AR

Checked by BW

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As indicated

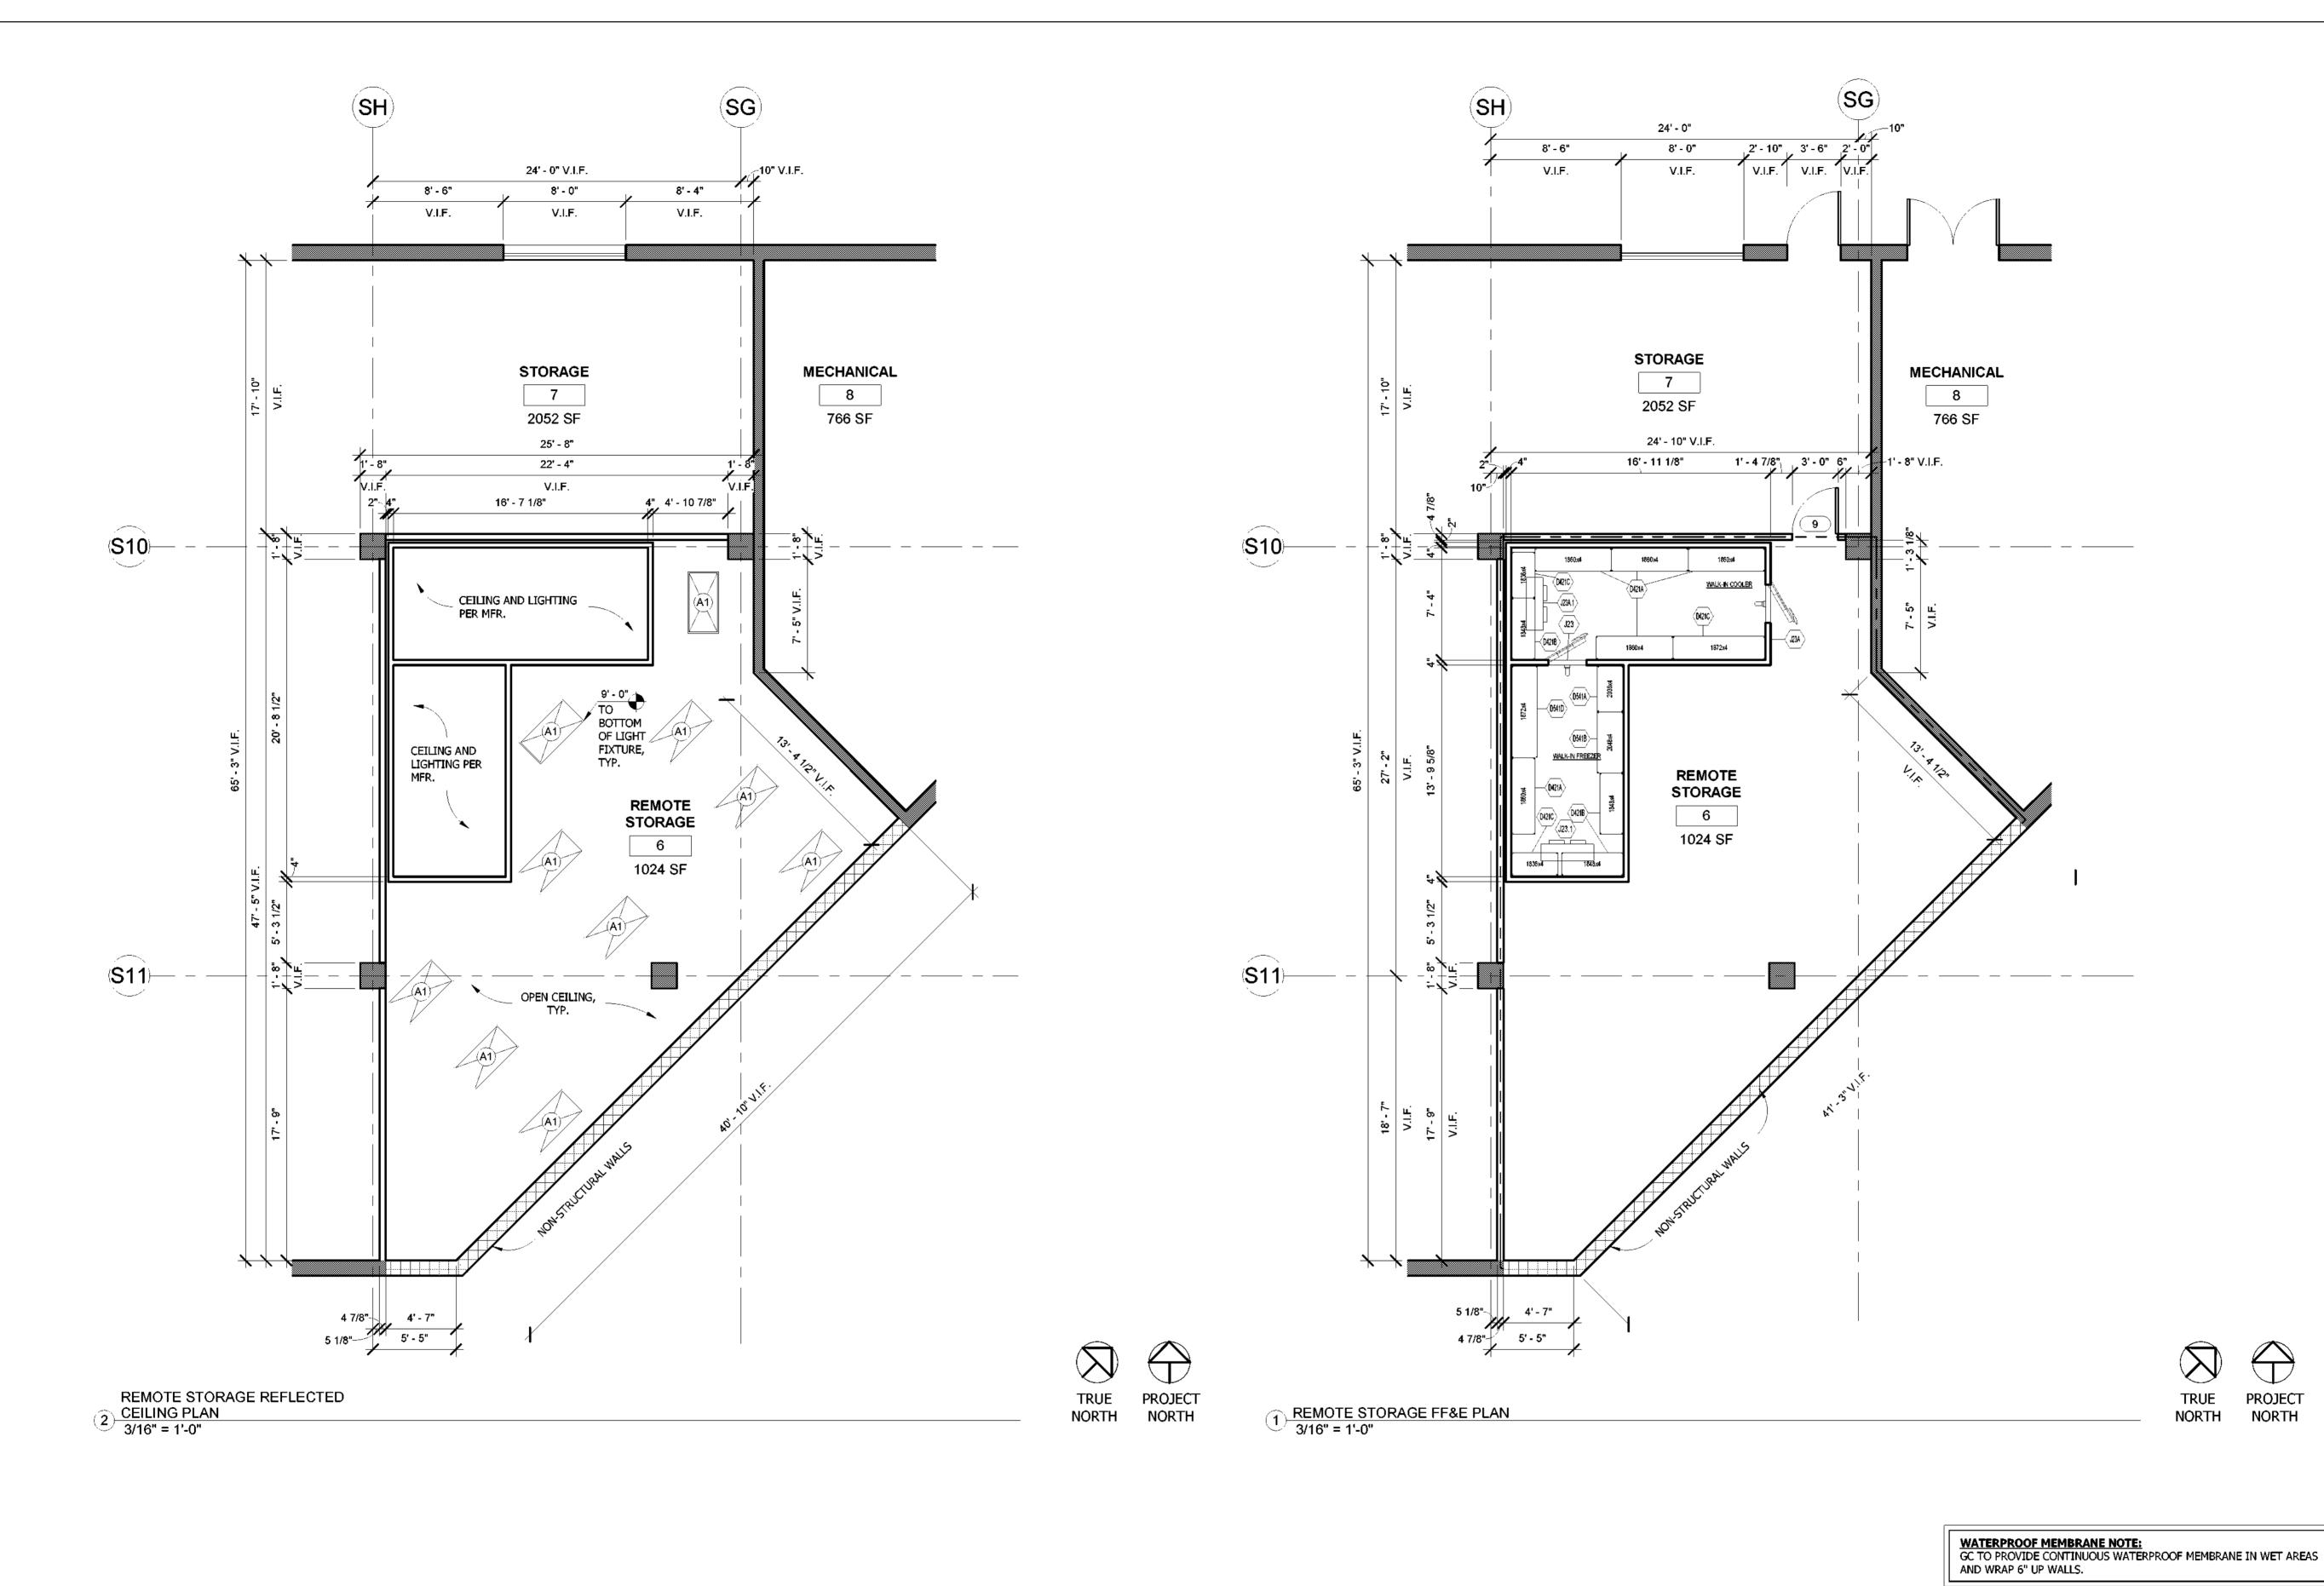

SILHOUETTE

DESIGN ARCHITECTURE

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DIMENSIONS NOTE:VERIFY DIMENSIONS OF ALL EXISTING ITEMS IN FIELD. INFORM DESIGNER

GC TO VERIFY ALL FIELD DIMENSIONS AND CONTACT PROJECT ARCHITECT WITH ANY SITE DISCREPANCIES.
FIRE RATED WOOD IS REQUIRED FOR ALL BLOCKING.

DRAWINGS FOR ADDITIONAL NOTES, SPECIFICATIONS, DETAILS, CONTROLS, ETC. THAT FORM A PART OF THIS CONTRACT. ANY CONFLICTS SHALL BE

BROUGHT TO THE ATTENTION OF THE ARCHITECT AND CLARIFIED BY THEM

IMPORTANT BID NOTE:
REFER TO ARCHITECTURAL, ELECTIRCAL, MECHANICAL, AND PLUMBING

FOR INCLUSION IN BASE BID. THE REQUIREMENT WILL BE STRICTLY

ENFORCED. NO CHANGE ORDERS WILL BE ALLOWED SHOULD THE

CONTRACTOR FAIL TO PERFORM THIS FUNCTION.

OF ANY DISCREPENCIES OBSERVED.

GENERAL NOTE:

WALL LEGEND

EXISTING WALL

NEW WALL

- LEASE LINE



WILMINGTON INTERNATIONAL AIRPORT 1740 AIRPORT BLVD, WILMINGTON, NC, 28405 BOARDING LEVEL, ZONE 1 SPACE: A, B, AND C

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Description

REMOTE STORAGE RCP AND FFE PLANS

 Project number
 2023-019

 Date
 03-29-2023

 Drawn by
 AR


 Checked by
 BW

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As indicated

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Description Manufacturer Comments | Fumished | Installed | Count | CW-1 POS STATION CW2-S0-LWF, CLASSIC COUNTERS W/ MEGAWALL CENTER PANELS, 4'-5"Lx2'-5"Dx2'11"H. STANDARD HEIGHT W/ QUARTZ LOCATED IN SALES AREA TOP. 96-102476 BLACK GROMMET, 2 3/8" DIA. F-1 RETAIL FLOOR FIXTURES C-B6006-G1 EDGE 1-MODULE GONDOLA W/ MEGAWALL PANELS, ACC. BASE AND LEVELERS. 2'-6"Lx2'-3"Wx4'-7"H LOCATED IN SALES AREA OWNER F-2 RETAIL FLOOR FIXTURES ОРТО C-B5169-4W EDGE LOW 4-WAY W/ MEGAWALL PANELS, ACC. BASE & LEVELERS 3'8"Lx3'8"Wx4'7"H LOCATED IN SALES AREA OWNER GC F-3 RETAIL NESTING TABLE OPTO C1 EDGE NESTING TABLE, 4'-8" x 4'-6" LOCATED IN SALES AREA OWNER F-4 RETAIL WALL DISPLAY OPTO ESQ-84-xXx EDGE WALL-MOUNT POST, SQUARE 85", 3"W X 7'1"H. 13-B225x1 BACK PANEL FOR CLASSIC/EDGE POST WALL, LOCATED IN SALES AREA OWNER 22"W x 72"H, FOR 7-1"H POSTS. F-5 RETAIL WALL DISPLAY OPTO ESQ-84-xXx EDGE WALL-MOUNT POST, SQUARE 85", 3"W X 7'1"H. 13-B225x1 BACK PANEL FOR CLASSIC/EDGE POST WALL, LOCATED IN SALES AREA OWNER 22"W x 72"H, FOR 7-1"H POSTS. MW-1 MILLWORK BUILD-OUT CUSTOM CUSTOM LOCATED IN SALES AREA. REFER TO ELEVATIONS AND DETAILS. MW-2 MILLWORK BUILD-OUT CUSTOM CUSTOM LOCATED IN SALES AREA. REFER TO ELEVATIONS AND DETAILS. MW-3 LOW RETAIL WALL FIXTURE CUSTOM CUSTOM LOCATED IN SALES AREA. REFER TO ELEVATIONS AND DETAILS. MW-4 DIGITAL MENU BOARD SHROUDS CUSTOM CUSTOM BY GC LOCATED IN SALES AREA. REFER TO ELEVATIONS AND DETAILS.

		FURNITURE SC	HEDULE				
Description	Manufacturer	Model	Comments	Vendor	Furnished	Installed	Count
DINING CHAIR	CONTRACT FURNITURE	PESARO DINING CHAIR WITH DOUGLASS SYMPHONY CLASSIC COLLECTION, REEF SCL-111	LOCATED IN CONCOURSE SEATING AREA	CONTRACT FURNITURE, GEORGE AGCAOILI, P:(310) 544-2382, E: GEORGE@CONTRACTFURNITURE.COM	OWNER	GC	20
OFFICE CHAIR	сиѕтом	CUSTOM, OWNER FURNISHED.	LOCATED IN OFFICE	CUSTOM	OWNER	OWNER	1
DESK	CUSTOM	CUSTOM, OWNER FURNISHED.	LOCATED IN OFFICE	CUSTOM	OWNER	OWNER	1
24x30 DINING TABLE	CONTRACT FURNITURE	24"x30" ANTIQUE ASH TABLE TOP WITH LIGHT FLAME FINISH, EASED EDGES AND CORNERS, 17" ROUND TABLE BASE, 28" OVERALL HEIGHT, FINISH: BLACK	LOCATED IN CONCOURSE SEATING AREA	CONTRACT FURNITURE, GEORGE AGCAOILI, P:(310) 544-2382, E: GEORGE@CONTRACTFURNITURE.COM	OWNER	GC	6
30x48 ADA DINING TABLE	CONTRACT FURNITURE	30"x48 ANTIQUE ASH TABLE TOP WITH LIGHT FLAME FINISH, EASED EDGES AND CORNERS, 2900 SERIES CROSS BASE, 28" OVERALL HEIGHT, FINISH: BLACK	LOCATED IN CONCOURSE SEATING AREA	CONTRACT FURNITURE, GEORGE AGCAOILI, P:(310) 544-2382, E: GEORGE@CONTRACTFURNITURE.COM	OWNER	GC	2
	DINING CHAIR OFFICE CHAIR DESK 24x30 DINING TABLE 30x48 ADA DINING	DINING CHAIR CONTRACT FURNITURE OFFICE CHAIR CUSTOM DESK CUSTOM 24x30 DINING TABLE CONTRACT FURNITURE 30x48 ADA DINING CONTRACT FURNITURE	Description Manufacturer Model DINING CHAIR CONTRACT FURNITURE PESARO DINING CHAIR WITH DOUGLASS SYMPHONY CLASSIC COLLECTION, REEF SCL-111 OFFICE CHAIR CUSTOM CUSTOM, OWNER FURNISHED. DESK CUSTOM CUSTOM, OWNER FURNISHED. 24"X30" ANTIQUE ASH TABLE TOP WITH LIGHT FLAME FINISH, EASED EDGES AND CORNERS, 17" ROUND TABLE BASE, 28" OVERALL HEIGHT, FINISH: BLACK 30"X48 ADA DINING CONTRACT FURNITURE 30"X48 ANTIQUE ASH TABLE TOP WITH LIGHT FLAME FINISH, EASED EDGES AND	DINING CHAIR CONTRACT FURNITURE PESARO DINING CHAIR WITH DOUGLASS SYMPHONY CLASSIC COLLECTION, REEF SCL-111 OFFICE CHAIR CUSTOM CUSTOM, OWNER FURNISHED. CONTRACT FURNITURE 24"x30" ANTIQUE ASH TABLE TOP WITH LIGHT FLAME FINISH, EASED EDGES AND CONTRACT FURNITURE CONTRACT FURNITURE 30"x48 ANTIQUE ASH TABLE TOP WITH LIGHT FLAME FINISH; BLACK CONTRACT FURNITURE 30"x48 ANTIQUE ASH TABLE TOP WITH LIGHT FLAME FINISH; EASED EDGES AND CONTRACT FURNITURE CONTRACT FURNITURE 30"x48 ANTIQUE ASH TABLE TOP WITH LIGHT FLAME FINISH, EASED EDGES AND CONTRACT FURNITURE	Description Manufacturer Dining Chair Contract Furniture Pesaro Dining Chair with Douglass symphony Classic Collection, Reef Scl-111 OFFICE CHAIR CUSTOM CUSTOM, OWNER FURNISHED. Desk Custom Custom, Owner Furnished. 24x30 Dining Table Contract Furniture Contract Furniture, George Agcaoili, P:(310) 544-2382, E: George Contract Furniture, George Agcaoi	Description Manufacturer Model Comments Comments Contract Furniture Pesaro Dining Chair with Douglass symphony classic collection, REEF SCL-111 COLORATED IN CONCOURSE SEATING AREA GEORGE@CONTRACT FURNITURE, COM CUSTOM, OWNER FURNISHED. LOCATED IN OFFICE CUSTOM OWNER CUSTOM OWNER CONTRACT FURNITURE 24"x30" ANTIQUE ASH TABLE TOP WITH LIGHT FLAME FINISH, EASED EDGES AND CORNERS, 17" ROUND TABLE BASE, 28" OVERALL HEIGHT, FINISH: BLACK SEATING AREA GEORGE@CONTRACT FURNITURE, GEORGE AGCAOILI, P:(310) 544-2382, E: OWNER 30x48 ADA DINING CONTRACT FURNITURE 30"x48 ANTIQUE ASH TABLE TOP WITH LIGHT FLAME FINISH, EASED EDGES AND LOCATED IN CONCOURSE CONTRACT FURNITURE, GEORGE AGCAOILI, P:(310) 544-2382, E: OWNER 30x48 ADA DINING CONTRACT FURNITURE 30"x48 ANTIQUE ASH TABLE TOP WITH LIGHT FLAME FINISH, EASED EDGES AND LOCATED IN CONCOURSE CONTRACT FURNITURE, GEORGE AGCAOILI, P:(310) 544-2382, E: OWNER 30x48 ADA DINING CONTRACT FURNITURE 30"x48 ANTIQUE ASH TABLE TOP WITH LIGHT FLAME FINISH, EASED EDGES AND LOCATED IN CONCOURSE CONTRACT FURNITURE, GEORGE AGCAOILI, P:(310) 544-2382, E: OWNER	Description Manufacturer Model Comments Vendor Furnished Installed DINING CHAIR CONTRACT FURNITURE PESARO DINING CHAIR WITH DOUGLASS SYMPHONY CLASSIC COLLECTION, REEF SCL-111 COCATED IN CONCOURSE SEATING AREA GEORGE@CONTRACT FURNITURE, GEORGE AGCAOILI, P:(310) 544-2382, E: OFFICE CHAIR CUSTOM CUSTOM, OWNER FURNISHED. LOCATED IN OFFICE CUSTOM OWNER DESK CUSTOM CUSTOM, OWNER FURNISHED. LOCATED IN OFFICE CUSTOM OWNER 24x30 DINING TABLE CONTRACT FURNITURE CONTRACT FURNITURE CONTRACT FURNITURE, GEORGE AGCAOILI, P:(310) 544-2382, E: OWNER OWNER OWNER OWNER OWNER 24x30 DINING TABLE CONTRACT FURNITURE, GEORGE AGCAOILI, P:(310) 544-2382, E: OWNER OWNER OWNER OWNER OWNER CONTRACT FURNITURE, GEORGE AGCAOILI, P:(310) 544-2382, E: OWNER

	MISCELLANEOUS EQUIPMENT SCHEDULE								
Туре	Description	Manufacturer	Model	Comments	Furnished	Installe	d Coun		
CCTV	SECURITY CAMERA	UNIVIEW TEC	IPVLP428 / COLOR: WHITE	GC TO PROVIDE CAT6 TO CAMERA LOCATIONS. OWNER HAS PROVIDED CAT 6 ON SITE, OWNER WILL PROVIDE AND INSTALL CAMERA DEVICE.	GC	GC	8		
DATA	DATA CABINET	TRIPP LITE	12U WALL MOUNT SERVER RACK CABINET	LOCATED IN ELECTRICAL	OWNER	GC	1		
PANEL A	ELECTRICAL PANEL	TBD	SEE MEP DRAWINGS	SEE ELECTRICAL DRAWINGS	GC	GC	1		
PANEL B	ELECTRICAL PANEL	TBD	SEE MEP DRAWINGS	SEE ELECTRICAL DRAWINGS	GC	GC	1		
POS	POINT OF SALE	TBD	BY OWNER	GC TO PROVIDE ALL LOW VOLTAGE & DATA LINES & LEAVE WHIPS	OWNER	GC	2		
SOK	SELF ORDERING KIOSK	ACRELEC	K27	GC TO PROVIDE ALL LOW VOLTAGE & DATA LINES & LEAVE WHIPS	OWNER	GC	1		
TV-1	DIGITAL TV SCREEN	SAMSUNG	SAMSUNG SMART SIGNAGE, QMH SERIES, QM49H, OR SIMILAR	LOCATED AT SERVICE AREA	OWNER	GC	6		
WAP	WIRELESS ACCESS POINT	CISCO	MERAKI/MR42	LOCATED AT SERVICE AREAS	OWNER	GC	2		
WH	WATER HEATER	TBD	SEE MEP DRAWINGS	BOH, ABOVE MOP SINK			1		

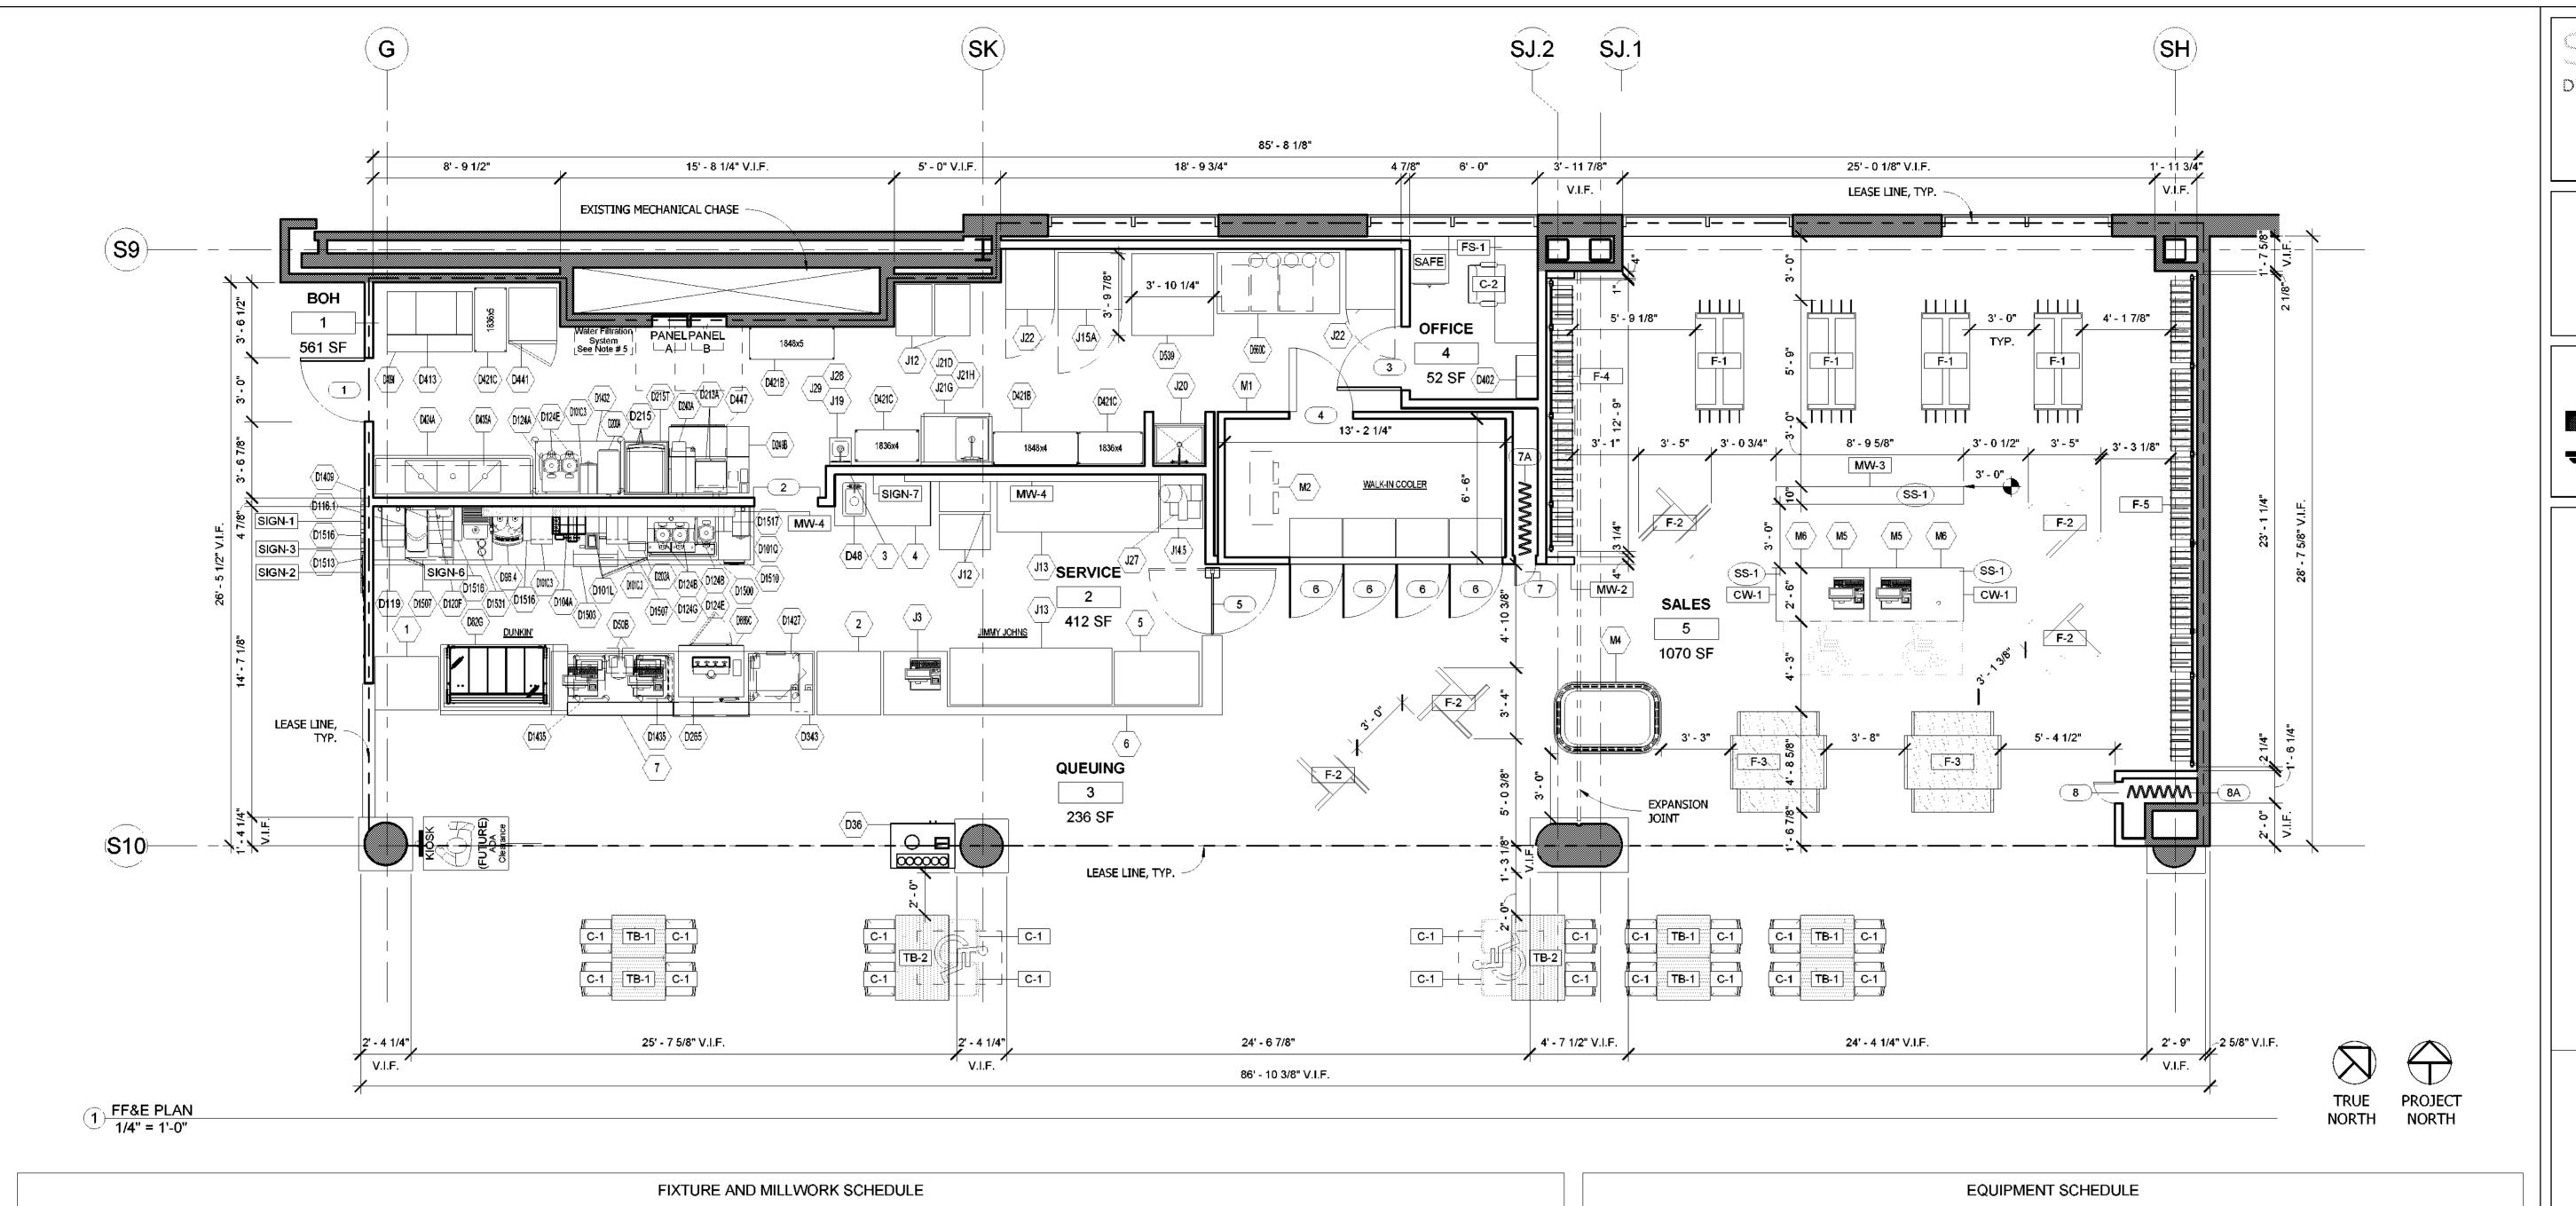	EQUIPMENT SCHEDULE									
Type	Description	Manufacturer	Model	Comments	Furnished	Installed	Count			
D402	LOCKERS	CUSTOM	SEE KEC DRAWINGS	LOCATED AT OFFICE	OWNER	OWNER	2			
J20	MOP SINK	CUSTOM	SEE KEC DRAWINGS	LOCATED AT BACK OF HOUSE	GC	GC	1			
SAFE	COLLECTION SAFE	CUSTOM	CUSTOM	LOCATED AT OFFICE	OWNER	OWNER	1			

WALL LEGEND

EXISTING WALL

NEW WALL

- LEASE LINE

WATERPROOF MEMBRANE NOTE:

OF ANY DISCREPENCIES OBSERVED.

AND WRAP 6" UP WALLS.

DIMENSIONS NOTE:

GENERAL NOTE:

IMPORTANT BID NOTE:

GC TO PROVIDE CONTINUOUS WATERPROOF MEMBRANE IN WET AREAS

VERIFY DIMENSIONS OF ALL EXISTING ITEMS IN FIELD. INFORM DESIGNER

GC TO VERIFY ALL FIELD DIMENSIONS AND CONTACT PROJECT

ARCHITECT WITH ANY SITE DISCREPANCIES. FIRE RATED WOOD IS REQUIRED FOR ALL BLOCKING.

CONTRACTOR FAIL TO PERFORM THIS FUNCTION.

DESIGN ARCHITECTURE

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<u>DESIGNER:</u> Tara Carmichael Silhouette Design Architecture, Inc. 566 West Adams, Suite 650 Chicago, IL 60661 T: (312) 258-0025

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60% SUBMITTAL



WILMINGTON INTERNATIONAL AIRPORT 1740 AIRPORT BLVD, WILMINGTON, NC, 28405 **BOARDING LEVEL, ZONE 1**

SPACE: A, B, AND C

06/23/2023

2023-019

BW

03-29-2023

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FF&E PLAN

Project number REFER TO ARCHITECTURAL, ELECTIRCAL, MECHANICAL, AND PLUMBING DRAWINGS FOR ADDITIONAL NOTES, SPECIFICATIONS, DETAILS, CONTROLS, ETC. THAT FORM A PART OF THIS CONTRACT. ANY CONFLICTS SHALL BE Drawn by BROUGHT TO THE ATTENTION OF THE ARCHITECT AND CLARIFIED BY THEM Checked by FOR INCLUSION IN BASE BID. THE REQUIREMENT WILL BE STRICTLY ENFORCED. NO CHANGE ORDERS WILL BE ALLOWED SHOULD THE

1/4" = 1'-0"

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DUNKIN DONUTS EQUIPMENT SCHEDULE (BY OTHERS) **Equipment Category** D36 CONDIMENT COUNTER D48 HAND SINK D50B TRASH RECEPTACLE D82G BAKERY CASE D96.4 ESPRESSO CAPPUCCINO MACHINE

D96.4	ESPRESSO CAPPUCCINO MACHINE
D101C.3	CREAM DISPENSER
D101L	SWEETNER DISPENSER
D101Q	COFFEE GRINDER
D104A	PUMP STATION
D116.1	FROZEN BEVERAGE DISPENSER
D119	HOT CHOCOLATE DISPENSER
D120F	UNDERCOUNTER REFRIGERATOR
D124A	DOUBLE COFFEE BREWER
D124B	THERMAL SERVER
D124E	COFFEE BREWER
D12 4 G	BEVERAGE DISPENSER STAND
D200A	ICED COFFEE BREWER
D202A	SINGER SERVE COFFEE / TEA BREWER
D213A	MODULAR HOLDING CABINETS
D215	RAPID COOK OVEN
D215T	CART
D2 4 3A	TOASTER
D249B	EXPEDITE TABLE
D265	4 TAP BEVERAGE DISPENSER
D343	PICK UP COUNTER
D402	LOCKERS
D409F	ICE BIN
D413	ICE MAKER W/ WATER FILTER
D421A	STORAGE SHELVING
D421B	STORAGE SHELVING
D421C	STORAGE SHELVING
D421L	STORAGE SHELVING
D424A	(3) COMPARTMENT SINK
D435A	WALL SHELVING
D441	REACH-IN REFRIGERATOR
D447	ASSEMBLY STATION W/ OVERSHELF
D539	VENTLESS CONVECTION OVEN
D541A	STORAGE SHELVING
D541B	STORAGE SHELVING
D5 4 1D	STORAGE SHELVING
D560C	WORKTABLE W/ OVERSHELF
D886C	MIXER CUP STATION
D1409	PUMP & POWER RACK
D1427	ON THE GO CART
D1431	MOBILE WORK TABLE
D1435	MOBILE CART
D1500	COFFEE TABLE
D1503	U/C ICE BIN
D1507	S/S TOP REFRIGERATOR
D1510	TRASH / COMPOST
D1513	MOBILE TABLE
D1516	LID HOLDER
D1517	LID HOLDER
D1531	DUMP SINK

			FINISH SCHEDULE, NO SUBSTI	TUTIONS. USE SPECIFIED VENDORS.			
Mark	Description	Manufacturer	Model	Comments	Vendor / Contact	Supplied By	Installed By
CT-1	ACOUSTIC CEILING TILE 24"X24", WHITE	ARMSTRONG	CLEAN ROOM VL #868, 24"X24" PANELS, COLOR: WHITE, 15/16" PRELUDE XL SUSPENSION GRID COLOR: WHITE, CLASS A	RETAIL AREA CEILING.	MADELINE UNDERWOOD / T: 312-405-9871 / E. MPUNDERWOOD@ARMSTRONGCEILINGS.COM	GC	GC
3-1	QUARRY TILE COVE BASE	DALTILE	Q3565 QUETREAD, GRAY COVE BASE 5"X6", FINISH: MATTE, GROUT: MAPEI, #11 SAHARA BEIGE 1/4"	TO BE USED IN BACK OF HOUSE AREA(S)	COLLEEN MORAN / T: 773-308-3769 / E: COLLEEN.MORAN@DALTILE.COM	GC	GC
3-2	RUBBER WALL BASE	TARKETT	JOHNSONITE TRADITIONAL VINYL 1/8" (TYPE TV), FINISH: #30 INK	TO BE USED IN MILLWORK BUILDOUTS IN SALES AREA	COLLEEN MORAN / T: 773-308-3769 / E: COLLEEN.MORAN@DALTILE.COM	GC	GC
B-1	FABRIC	DOUGLASS FABRICS	SYMPHONY CLASSIC COLLECTION, REEF SCL-111	CHAIR SEAT FABRIC	CONTRACT FURNITURE, GEORGE AGCAOILI / P:(310) 544-2382 / E: GEORGE@CONTRACTFURNITURE.COM	GC	GC
RP	FIBERGLASS REINFORCEMENT PANEL	MARLITE	PEBBLED SURFACE P 199 BRIGHT WHITE, CLASS A	TO BE USED IN BACK OF HOUSE AREA(S)	KAREN KANE / E: KKANE@MARLITE.COM	GC	GC
.VT-1	LUXURY VINYL TILE	TRUCOR	CHAR OAK P2238-M9101. TONGUE AND GROOVE, 7.09"X72.05"X8.0mm.	LOCATED THROUGHOUT QUEUING AND SALES AREAS	CASANDRA BALLENGER-WILLIAMS / THE DIXIE GROUP / T: 224-217-7363 / E: CASANDRA.WILLIAMS@DIXIEGROUP.COM	GC	GC
_VT-2	LUXURY VINYL TILE	TRUCOR	ASHFORD OAK P2238-M9103. TONGUE AND GROOVE, 7.09"X72.05"X8.0mm.	LOCATED THROUGHOUT QUEUING AND SALES AREAS	CASANDRA BALLENGER-WILLIAMS / THE DIXIE GROUP / T: 224-217-7363 / E: CASANDRA.WILLIAMS@DIXIEGROUP.COM	GC	GC
MT-1	STAINLESS STEEL	CUSTOM	STAINLESS STEEL 20 GAUGE	CUSTOM BY GC	CUSTOM BY GC	GC	GC
² -1	PAINT	BENJAMIN MOORE	SEACLIFF HEIGHTS 688	LOCATED THROUGHOUT SALES AREA	BENJAMINMOORE.COM	GC	GC
² -2	PAINT	BENJAMIN MOORE	CHANTILLY LACE, OC-65	LOCATED AT SERVICE AND OFFICE AREA	BENJAMINMOORE.COM	GC	GC
P-3	PAINT	BENJAMIN MOORE	POLO BLUE, 2062-10	TO BE USED BEHIND RETAIL WALL FIXTURES	BENJAMINMOORE.COM	GC	GC
P-4	PAINT	SHERWIN WILLIAMS	KNOCKOUT ORANGE	TO BE USED AT DUNKIN' MENU BOARD SHROUD	SHERWIN WILLIAMS	GC	GC
P-5	PAINT	SHERWIN WILLIAMS	SHERWIN WILLIAMS TRICORN BLACK	TO BE USED AT JIMMY JOHN'S MENU BOARD SHROUD	SHERWIN WILLIAMS	GC	GC
PL-1	PLASTIC LAMINATE	WILSONART	BRIGHT ASH Y0521K-16, CASUAL RUSTIC FINISH	OPTO FIXTURES	ROMANA MILLS / T: 614-477-4932 / E: ROMANA.MILLS@WILSONART.COM	GC	GC
PL-2	PLASTIC LAMINATE	WILSONART	CERAMIC BLUE Y0745K-22, ANTIQUE FINISH	LOCATED IN SALES AREA	ROMANA MILLS / T: 614-477-4932 / E: ROMANA.MILLS@WILSONART.COM	GC	GC
PL-3	PLASTIC LAMINATE	FORMICA	05887-26 MILLENNIUM OAK, OILED WOOD TEXTURE		MARY COTEY / T: 224-422-4523 / E: MARYCOTEY@METROHARDWOODS.COM	GC	GC
SS-1	SOLID SURFACE	WILSONART	CARRARA EMPORIO 9909SS	LOCATED IN SALES AREA; OPTO CASHWRAP FIXTURES	ROMANA MILLS / T: 614-477-4932 / E: ROMANA.MILLS@WILSONART.COM	GC	GC
SS-2	SOLID SURFACE	CORIAN	EVENING PRIMA	LOCATED IN SALES AREA; MILLWORK.	AUDRA MIKA / T: 224-407-0034 / E: AMIKA@PARKSITE.COM	GC	GC
SS-3	SOLID SURFACE	LG HI-MACS	CANTON, POLISHED	TO BE USED ON DUNKIN' COUNTER	MINDY SINZHEIMER / E: MSINZHEIMER@LXHAUSYS.COM	GC	GC
ST-1	QUARTZ	CAESARSTONE	3100 JET BLACK	TO BE USED ON JIMMY JOHN'S COUNTER	NICK BELLING / T: 630-634-0368 / E: NICK.BELLING@CAESARSTONEUS.COM	GC	GC
Г-1	WALL TILE	TILEBAR	ICE BRIGHT GLOSS, 3"x6", FINISH: WHITE, GROUT: MAPEI #38 AVALANCHE, 1/16"	LOCATED IN SERVICE AREA	ALEXARAE ANTEKEIER / T: 773-308-3769 / E:AANTEKEIR@TILEBAR.COM	GC	GC
Γ-2	QUARRY TILE	DALTILE	0Q92 (2) QUETREAD, GRAY SQUARE 6"X6", FINISH: MATTE, GROUT: MAPEI, #11 SAHARA BEIGE 1/4"	TO BE USED IN BACK OF HOUSE AREA(S)	COLLEEN MORAN / T: 773-308-3769 / E: COLLEEN.MORAN@DALTILE.COM	GC	GC
NC-1	WALL COVERING	MDC INTERIOR SOLUTIONS	HELIOS WICKER ENV1098	TO BE USED ON HEADER IN SERVICE AREA	CONNOR CESARETTI / T: 800-621-4006 / E: CCESARETTI@MDCWALL.COM	GC	GC
NC-2	WALL COVERING	KOROSEAL	SILK MIRAGE PHANTOM 2522-70	TO BE USED ON SIGNAGE WALL ON CONCOURSE	CELINE EHLERS / T: 312-420-1242 / E: CEHLERS@KOROSEAL.COM	GC	GC

tem No	Equipment Category
J3	POS SYSTEM (BY OTHERS)
J12	BREAD RACK
J13	REFRIGERATED PREP TABLE
J14.5	WORK TABLE
J15A	OVEN/BREAD PROOFER
J19	HAND SINK
J20	MOP SINK
J21D	PREP SINK
J21G	PRE-RINSE FAUCET
J21H	FAUCET
J22	REACH-IN REFRIGERATOR
J23	WALK-IN FREEZER
J23.1	FREEZER EVAPORATOR COIL
J23.2	FREEZER CONDENSING UNIT
J23A	WALK-IN COOLER
J23A.1	COOLER EVAPORATOR COIL
J23A.2	COOLER CONDENSING UNIT
J27	SLICER
J28	TOWEL DISPENSER
J29	SOAP DISPENSER

THE MARKET EQUIPMENT SCHEDULE					
Item No	Equipment Category	Supplied By	Installed By		
M1	WALK-IN BEVERAGE COOLER	OWNER	GC		
M2	COOLER EVAPORATOR COIL	OWNER	GC		
М3	COOLER CONDENSING UNIT	OWNER	GC		
M4	REFRIGERATED DISPLAY ISLAND CASE	OWNER	GC		
M5	POS SYSTEM (BY OTHERS)	OWNER	GC		
М6	MILLWORK COUNTER (BY OTHERS)	OWNER	GC		
		OWNER	GC		

EQUIPMENT SCHEDULE					
Item No	Equipment Category	Supplied By	Installed By		
1	PEPSI GRAB-N-GO (BY OTHERS)	OWNER	GC		
2	COKE GRAB-N-GO (BY OTHERS)	OWNER	GC		
3	SOAP & PAPER TOWEL DISPENSER (BY OTHERS)	OWNER	GC		
4	S/S TABLE	OWNER	GC		
5	S/S TABLE	OWNER	GC		
6	MILLWORK COUNTER (BY OTHERS)	OWNER	GC		
7	MILLWORK COUNTER (BY OTHERS)	OWNER	GC		

	ROOM FINISH SCHEDULE							
	Room Name	Area	Floor Finish	Base Finish	Wall Finish	Ceiling Finish	Ceiling Height	Comments
1	вон	561 SF	T-3	B-1	FRP, MT-1	ACT-2	9'-0"	
2	SERVICE	412 SF	T-3	B-1	FRP, T-1, SS-3, ST-1, PL-3, P-2	ACT-2	9'-0"	
3	QUEUING	236 SF	LVT-1, LVT-2	MT-1	T-1	EXISTING	10'-6"	
4	OFFICE	52 SF	LVT-1	MT-1	P-2	ACT-2	9'-6"	
5	SALES	1070 SF	LVT-1, LVT-2	MT-1, B-2	P-1, P-3, PL-2, GR-1, GR-2, SS-1	EXISTING	10'-6"	
6	REMOTE STORAGE	1024 SF	T-3	B-1	FRP	N/A	N/A	

DESIGN ARCHITECTURE

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Jay Bauch Construction Manager T: (508) 574-9566 E: jay.bauch@inspirebrands.com





BOARDING LEVEL, ZONE 1 SPACE: A, B, AND C



О.	Description	Date
	60% SUBMITTAL	06/23/2023

WATERPROOF MEMBRANE NOTE:
GC TO PROVIDE CONTINUOUS WATERPROOF MEMBRANE IN WET AREAS
AND WRAP 6" UP WALLS.

SCHEDULES

2023-019

BW

03-29-2023

Project number DRAWINGS FOR ADDITIONAL NOTES, SPECIFICATIONS, DETAILS, CONTROLS, Drawn by BROUGHT TO THE ATTENTION OF THE ARCHITECT AND CLARIFIED BY THEM

Checked by

Scale

A3.0.1

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DIMENSIONS NOTE:
VERIFY DIMENSIONS OF ALL EXISTING ITEMS IN FIELD. INFORM DESIGNER
OF ANY DISCREPENCIES OBSERVED.

GENERAL NOTE:

1) GC TO VERIFY ALL FIELD DIMENSIONS AND CONTACT PROJECT ARCHITECT WITH ANY SITE DISCREPANCIES.

2) FIRE RATED WOOD IS REQUIRED FOR ALL BLOCKING.


IMPORTANT BID NOTE:
REFER TO ARCHITECTURAL, ELECTIRCAL, MECHANICAL, AND PLUMBING

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BRAND Inspire Brands Inc. Jay Bauch Construction Manager T: (508) 574-9566 E: jay.bauch@inspirebrands.com

GENERAL NOTE:

IMPORTANT BID NOTE:

EXISTING FLOOR SLAB

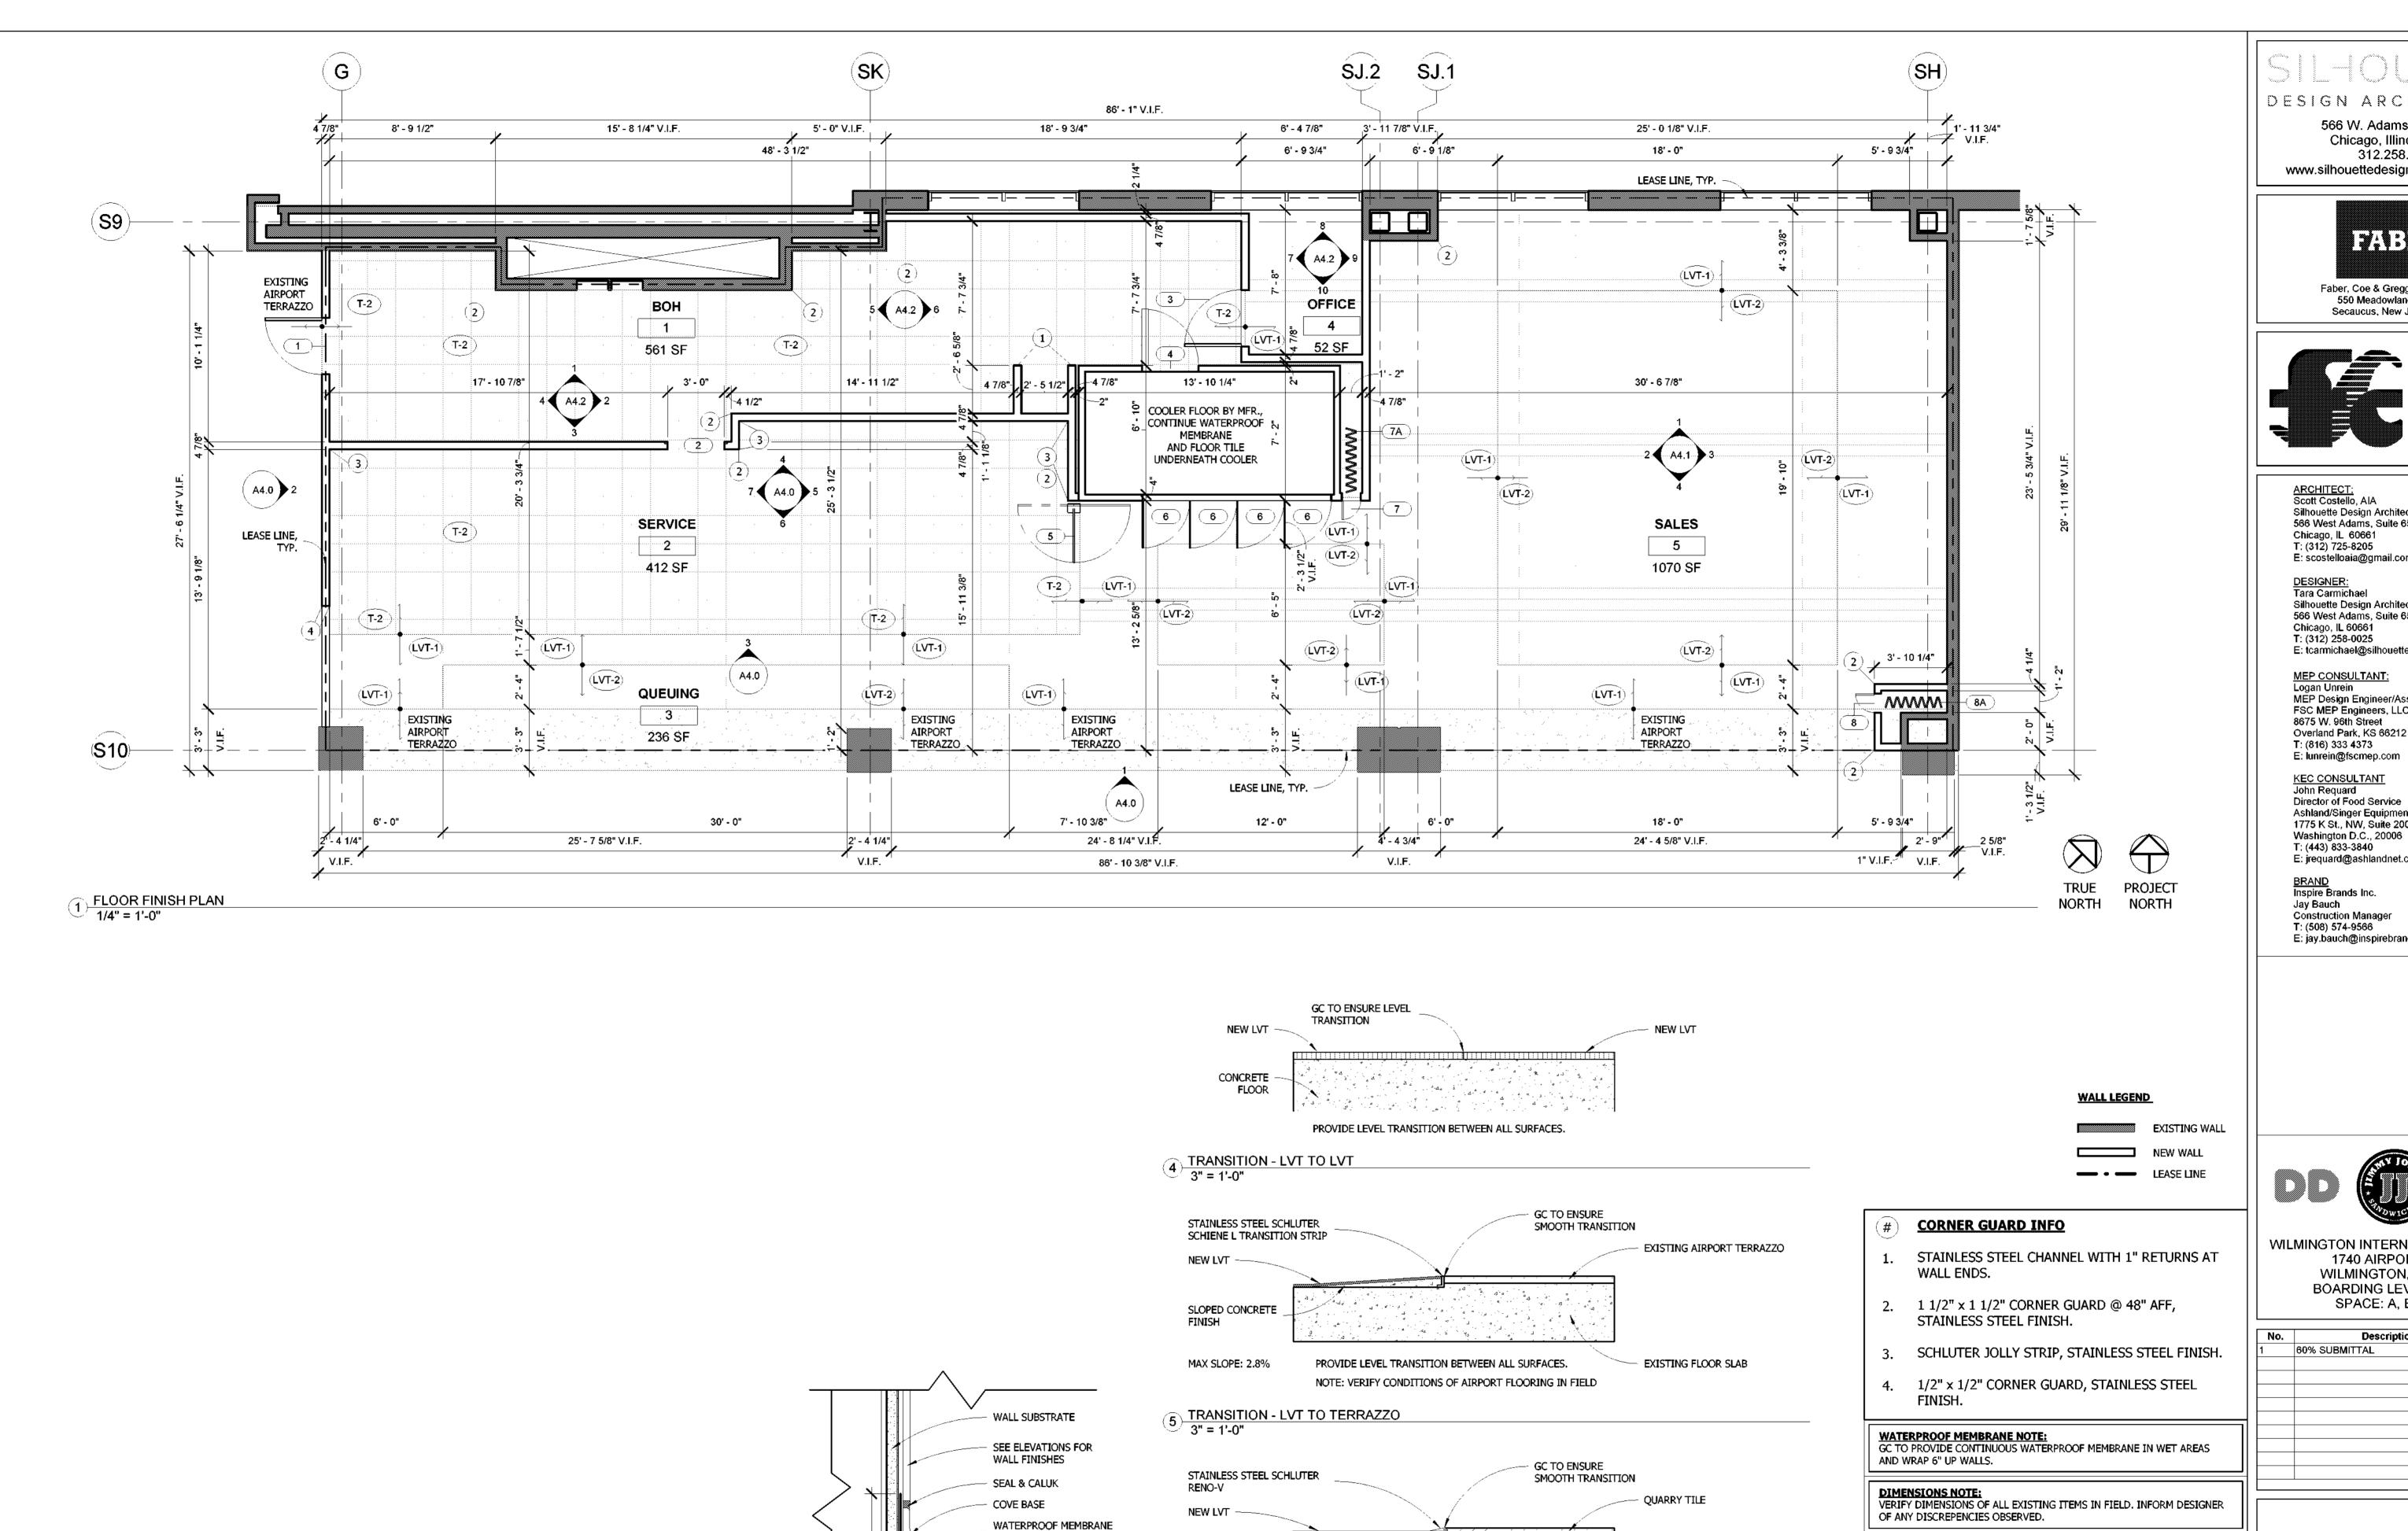GC TO VERIFY ALL FIELD DIMENSIONS AND CONTACT PROJECT

REFER TO ARCHITECTURAL, ELECTIRCAL, MECHANICAL, AND PLUMBING

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ARCHITECT WITH ANY SITE DISCREPANCIES. FIRE RATED WOOD IS REQUIRED FOR ALL BLOCKING.



WILMINGTON INTERNATIONAL AIRPORT 1740 AIRPORT BLVD, WILMINGTON, NC, 28405 **BOARDING LEVEL, ZONE 1**

SPACE: A, B, AND C

140.	Description	Date
1	60% SUBMITTAL	06/23/2023
	1	

FLOOR FINISH PLAN AND SCHEDULE

2023-019 Project number 03-29-2023 DRAWINGS FOR ADDITIONAL NOTES, SPECIFICATIONS, DETAILS, CONTROLS, Drawn by BROUGHT TO THE ATTENTION OF THE ARCHITECT AND CLARIFIED BY THEM Checked by

A3.1

Scale As indicated

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PROVIDE LEVEL TRANSITION BETWEEN ALL SURFACES.


(6) TRANSITION - LVT TO QUARRY TILE

/ 3" = 1'-0"

NOTE: VERIFY CONDITIONS OF AIRPORT FLOORING IN FIELD

IN WET AREAS ONLY

2 QUARRY TILE BASE 3" = 1'-0"

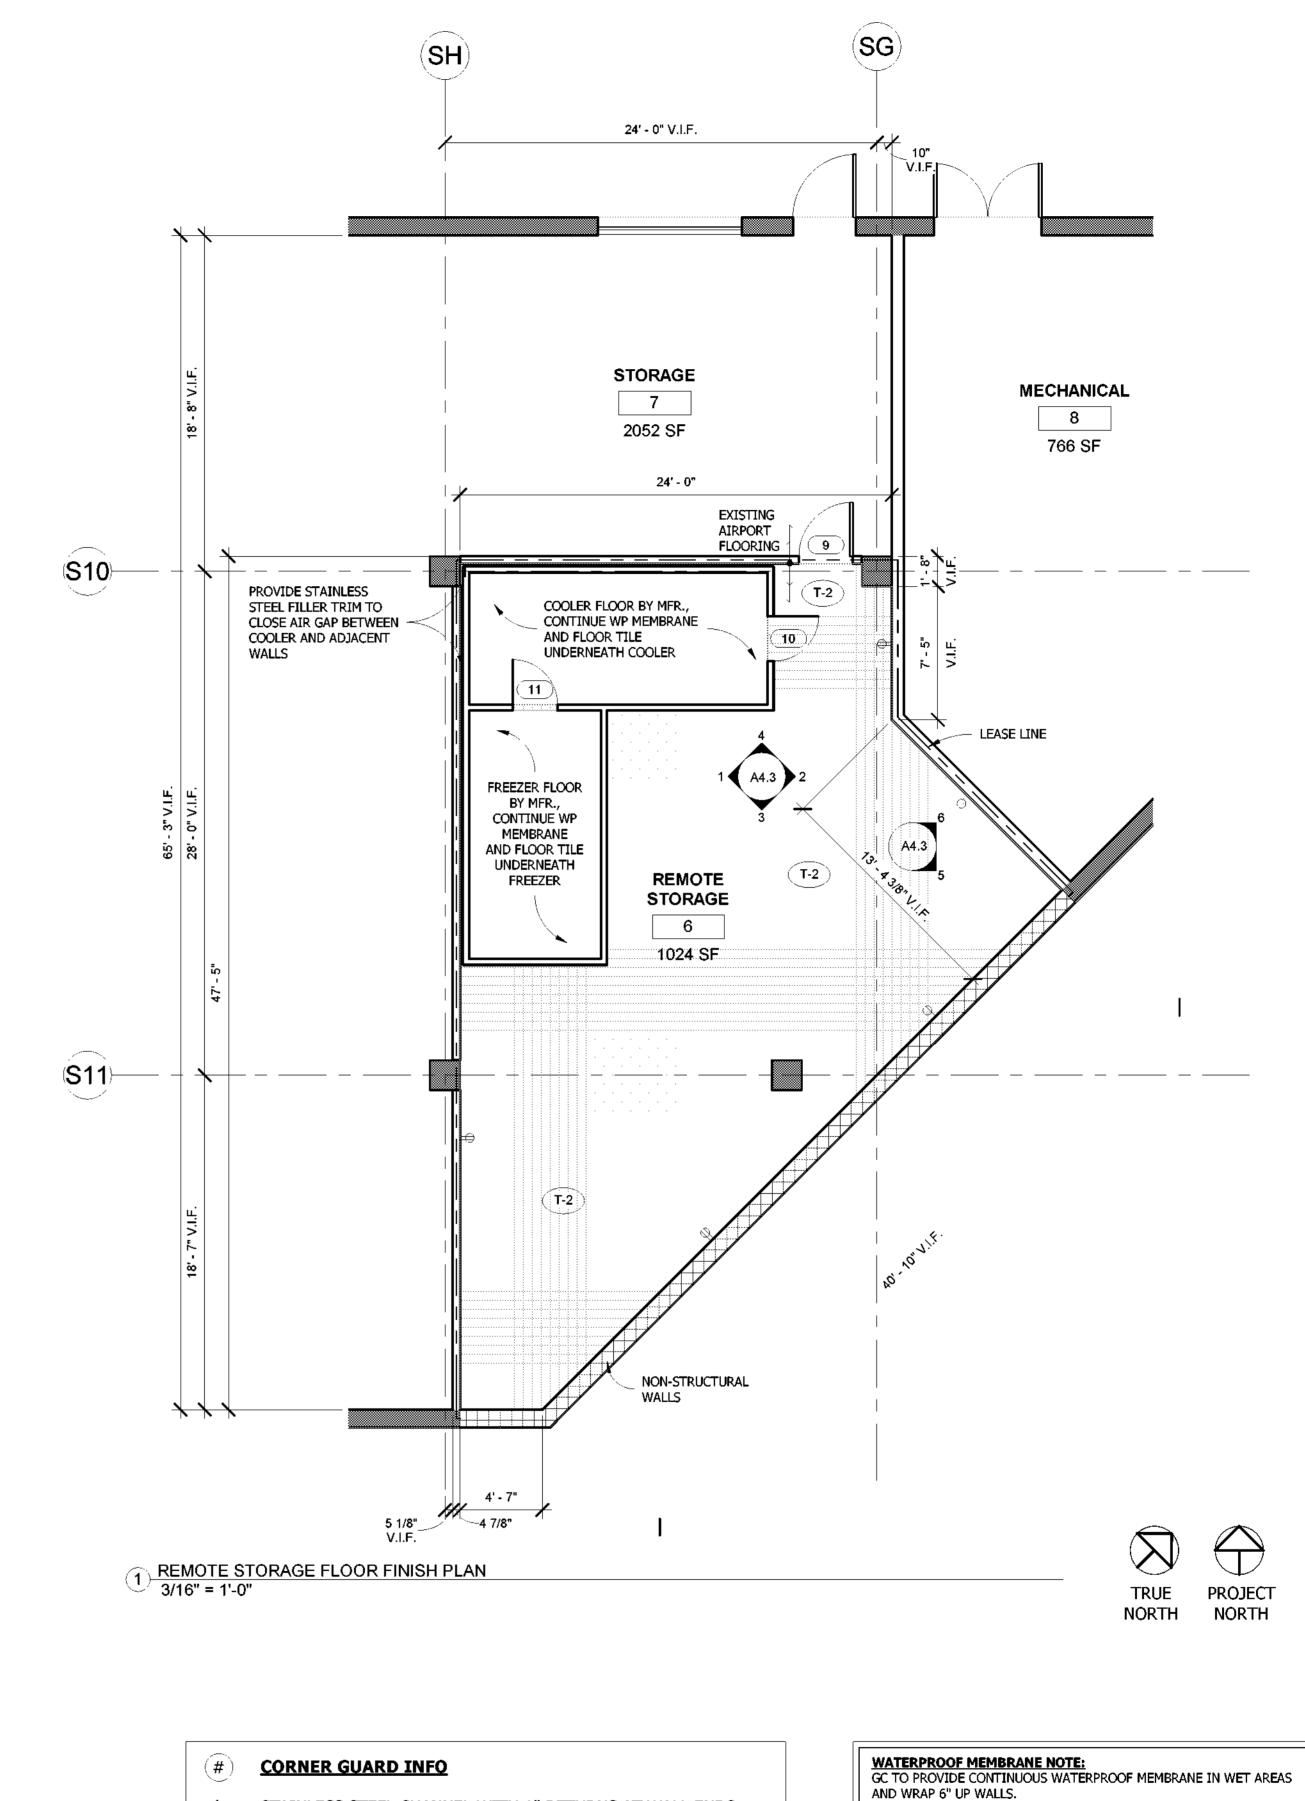

- 1. STAINLESS STEEL CHANNEL WITH 1" RETURNS AT WALL ENDS.
- 2. 1 1/2" x 1 1/2" CORNER GUARD @ 36" AFF, COLOR TO MATCH MT-1
- SCHLUTER JOLLY STRIP, STAINLESS STEEL FINISH.

WALL LEGEND

EXISTING WALL NEW WALL - LEASE LINE

<u>DIMENSIONS NOTE:</u>
VERIFY DIMENSIONS OF ALL EXISTING ITEMS IN FIELD. INFORM DESIGNER OF ANY DISCREPENCIES OBSERVED.

<u>GENERAL NOTE:</u> GC TO VERIFY ALL FIELD DIMENSIONS AND CONTACT PROJECT ARCHITECT WITH ANY SITE DISCREPANCIES.
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REMOTE STORAGE FLOOR FINISH PLAN

2023-019 Project number 03-29-2023 Drawn by Checked by

A3.1.1

As indicated

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06/23/2023

WILMINGTON INTERNATIONAL AIRPORT 1740 AIRPORT BLVD, WILMINGTON, NC, 28405

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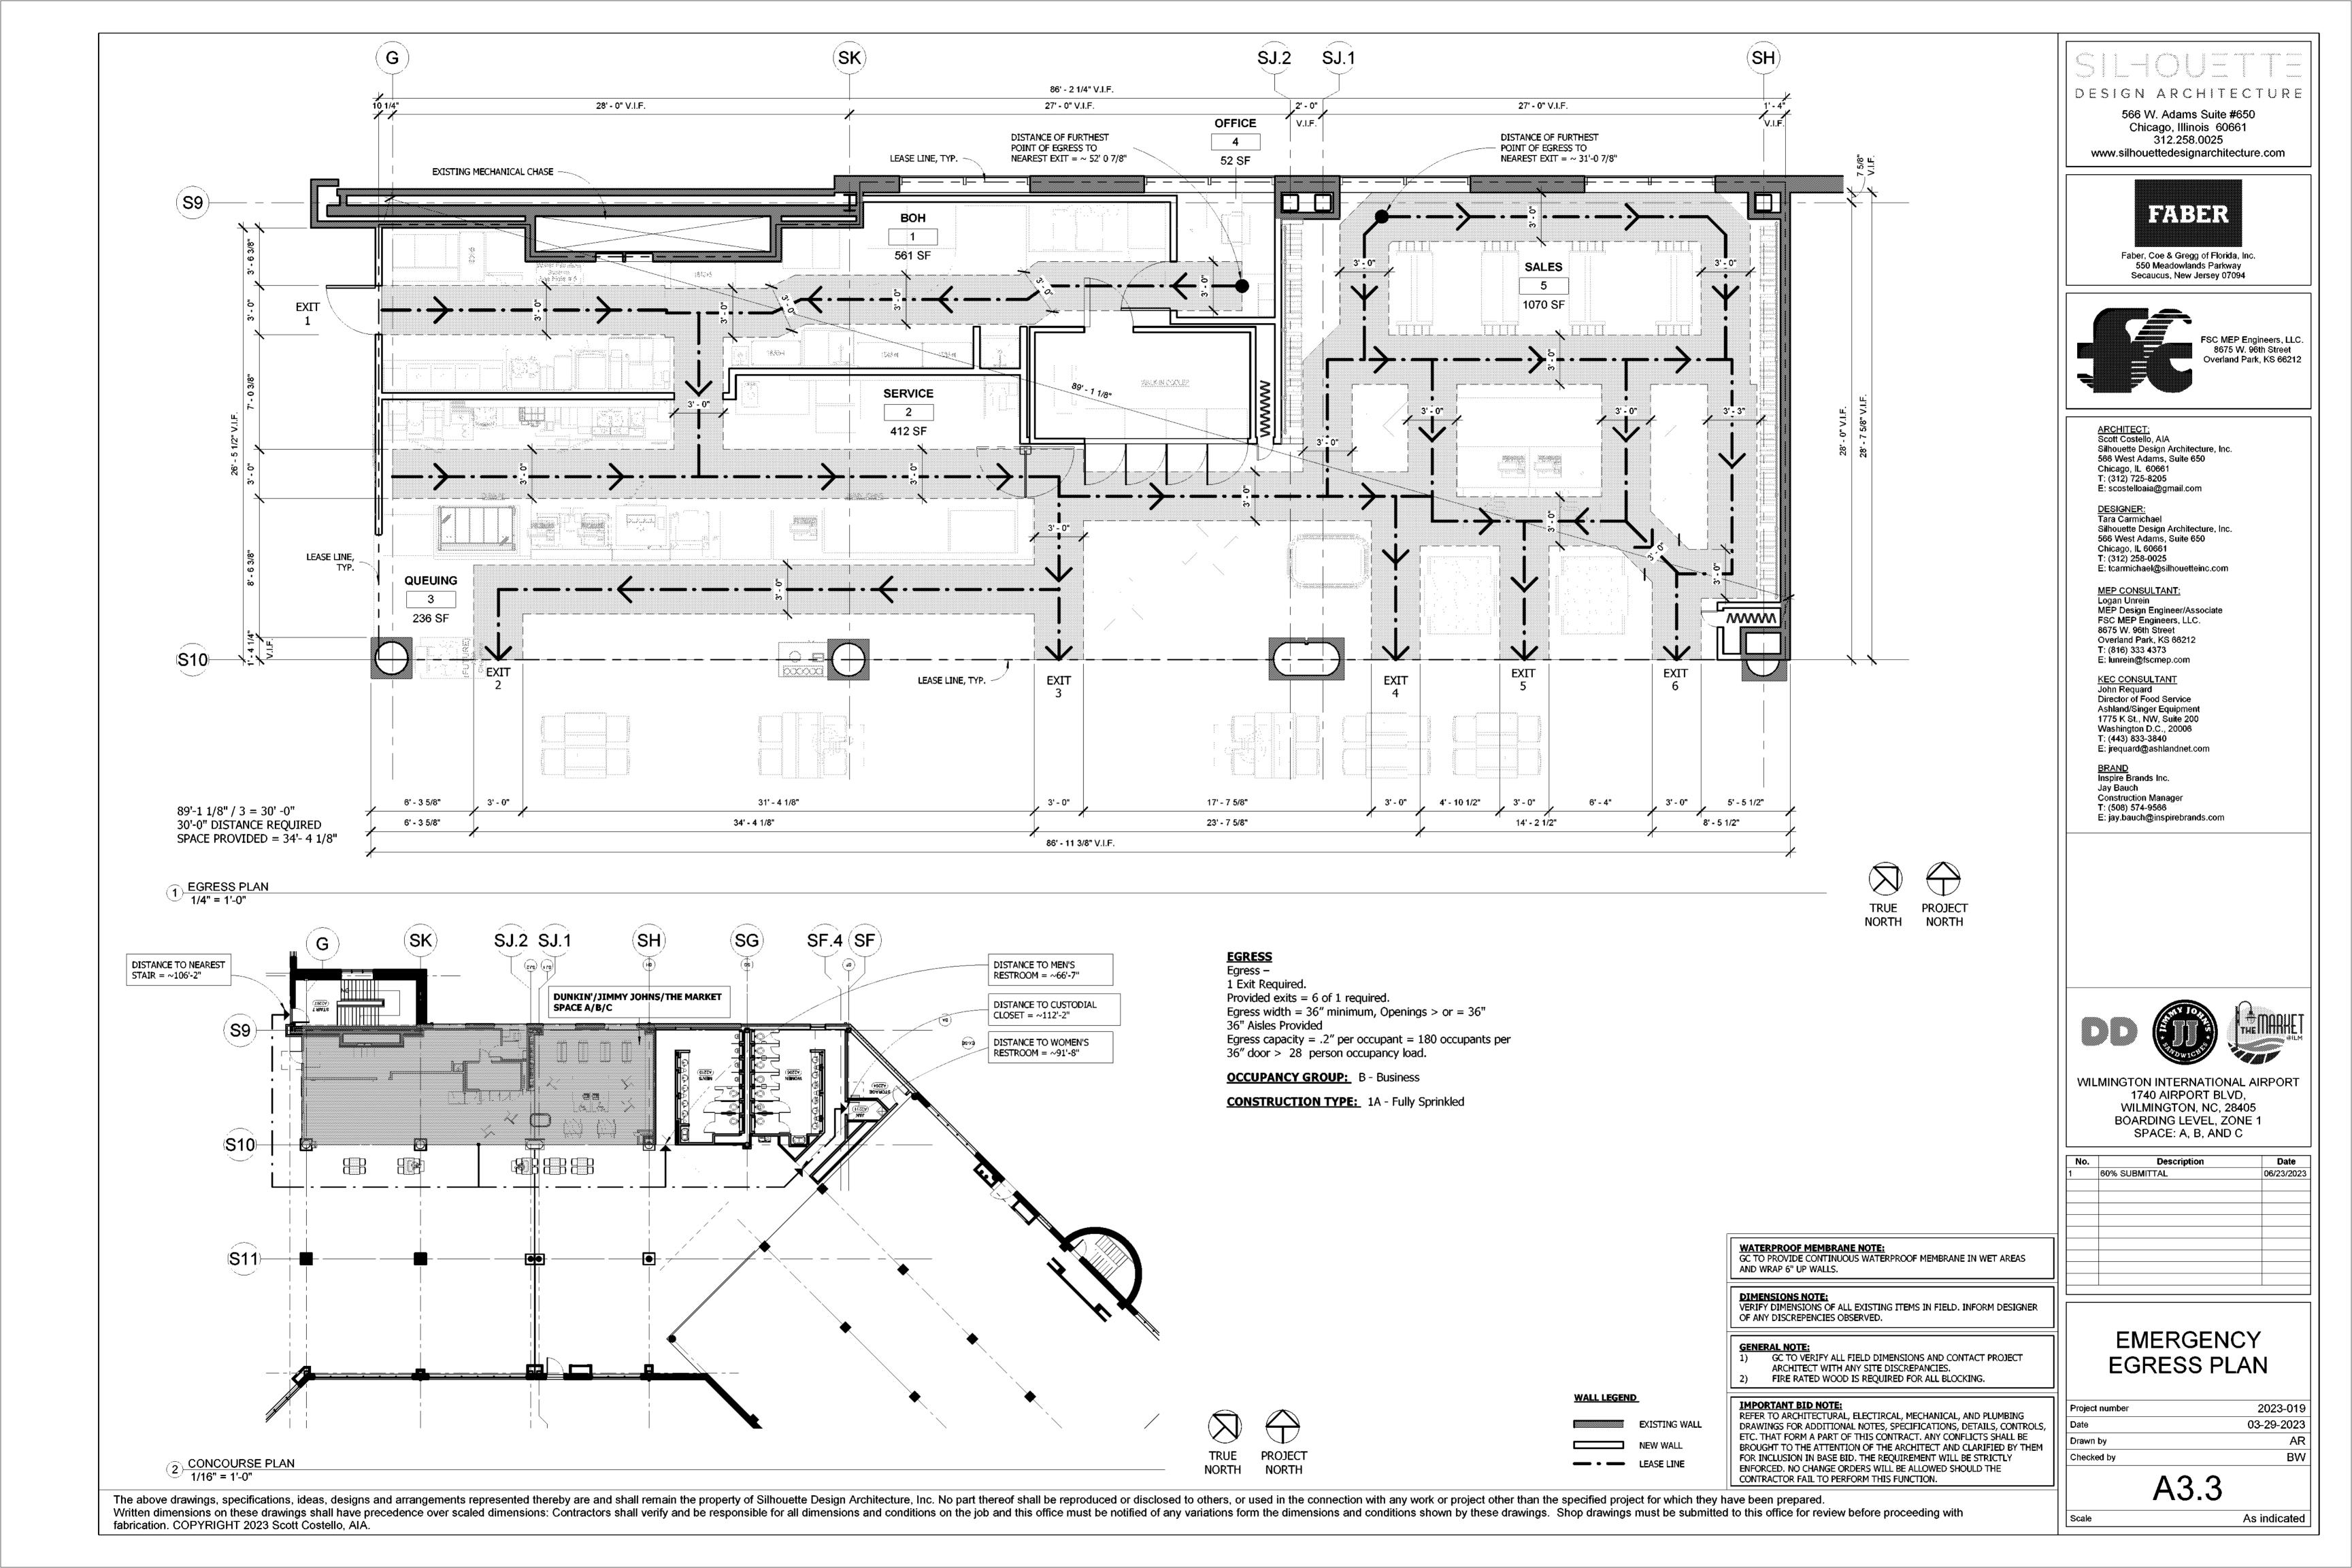
E: scostelloaia@gmail.com


FSC MEP Engineers, LLC. 8675 W. 96th Street


Overland Park, KS 66212

BOARDING LEVEL, ZONE 1 SPACE: A, B, AND C

60% SUBMITTAL



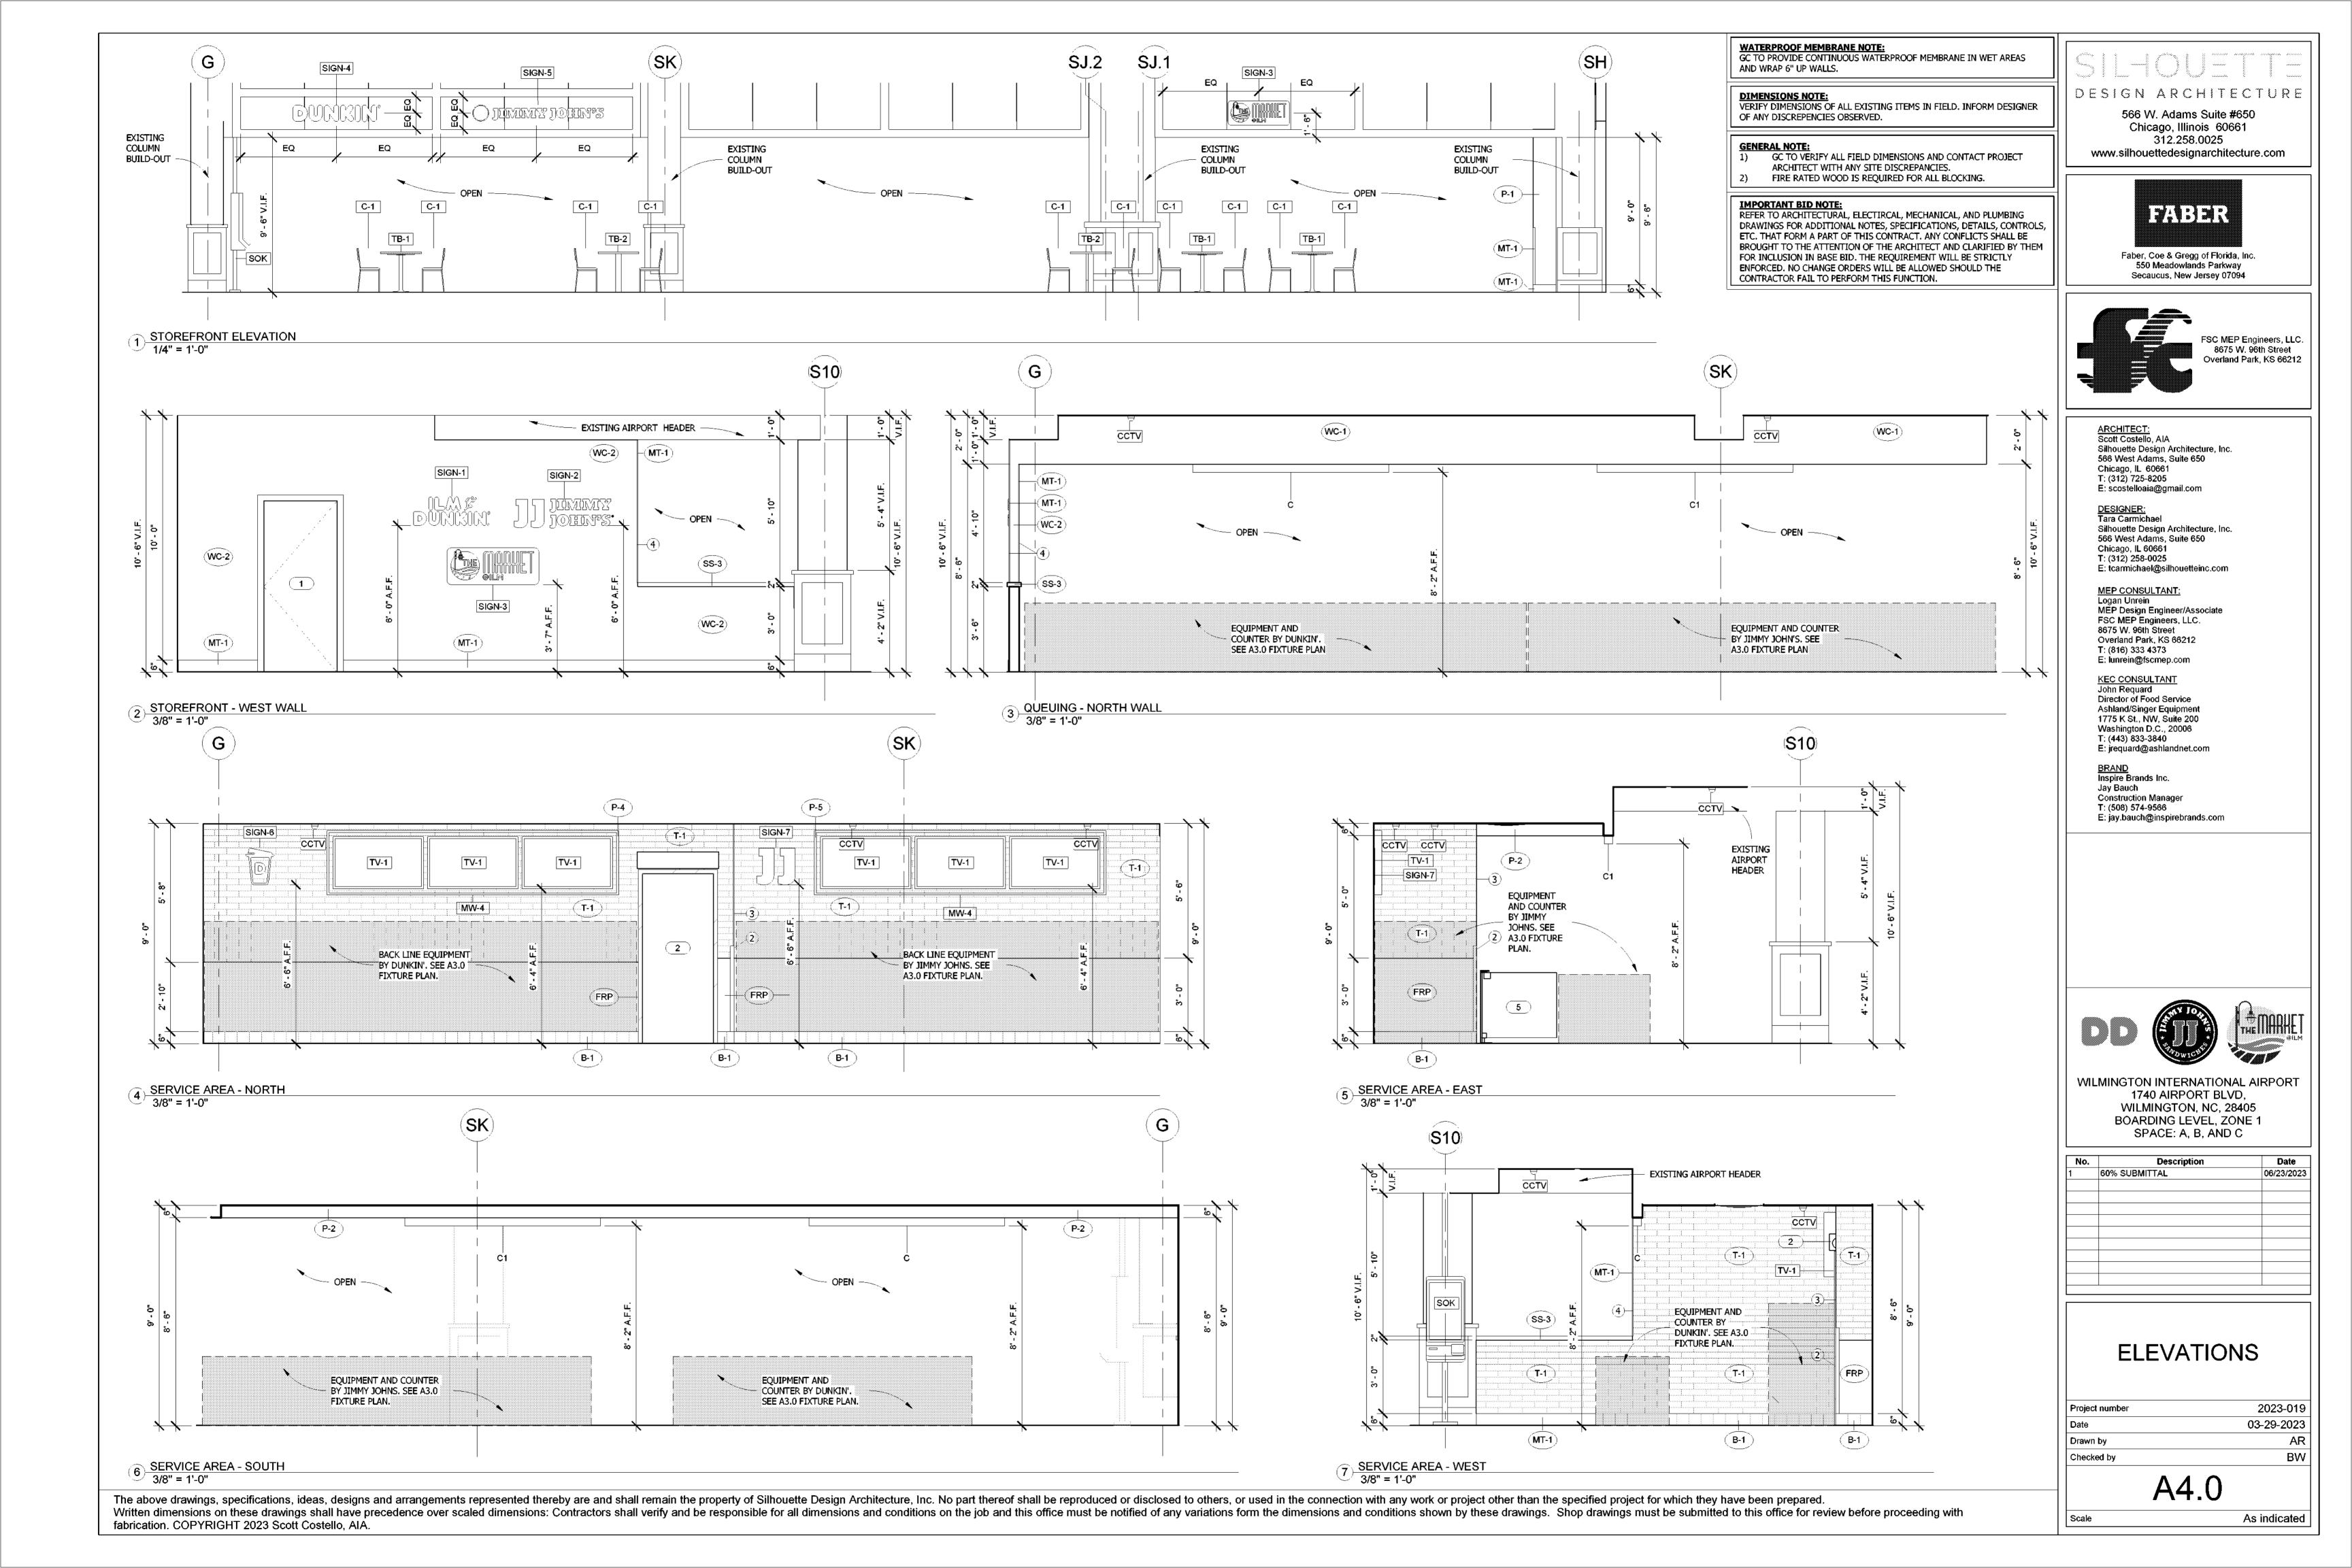

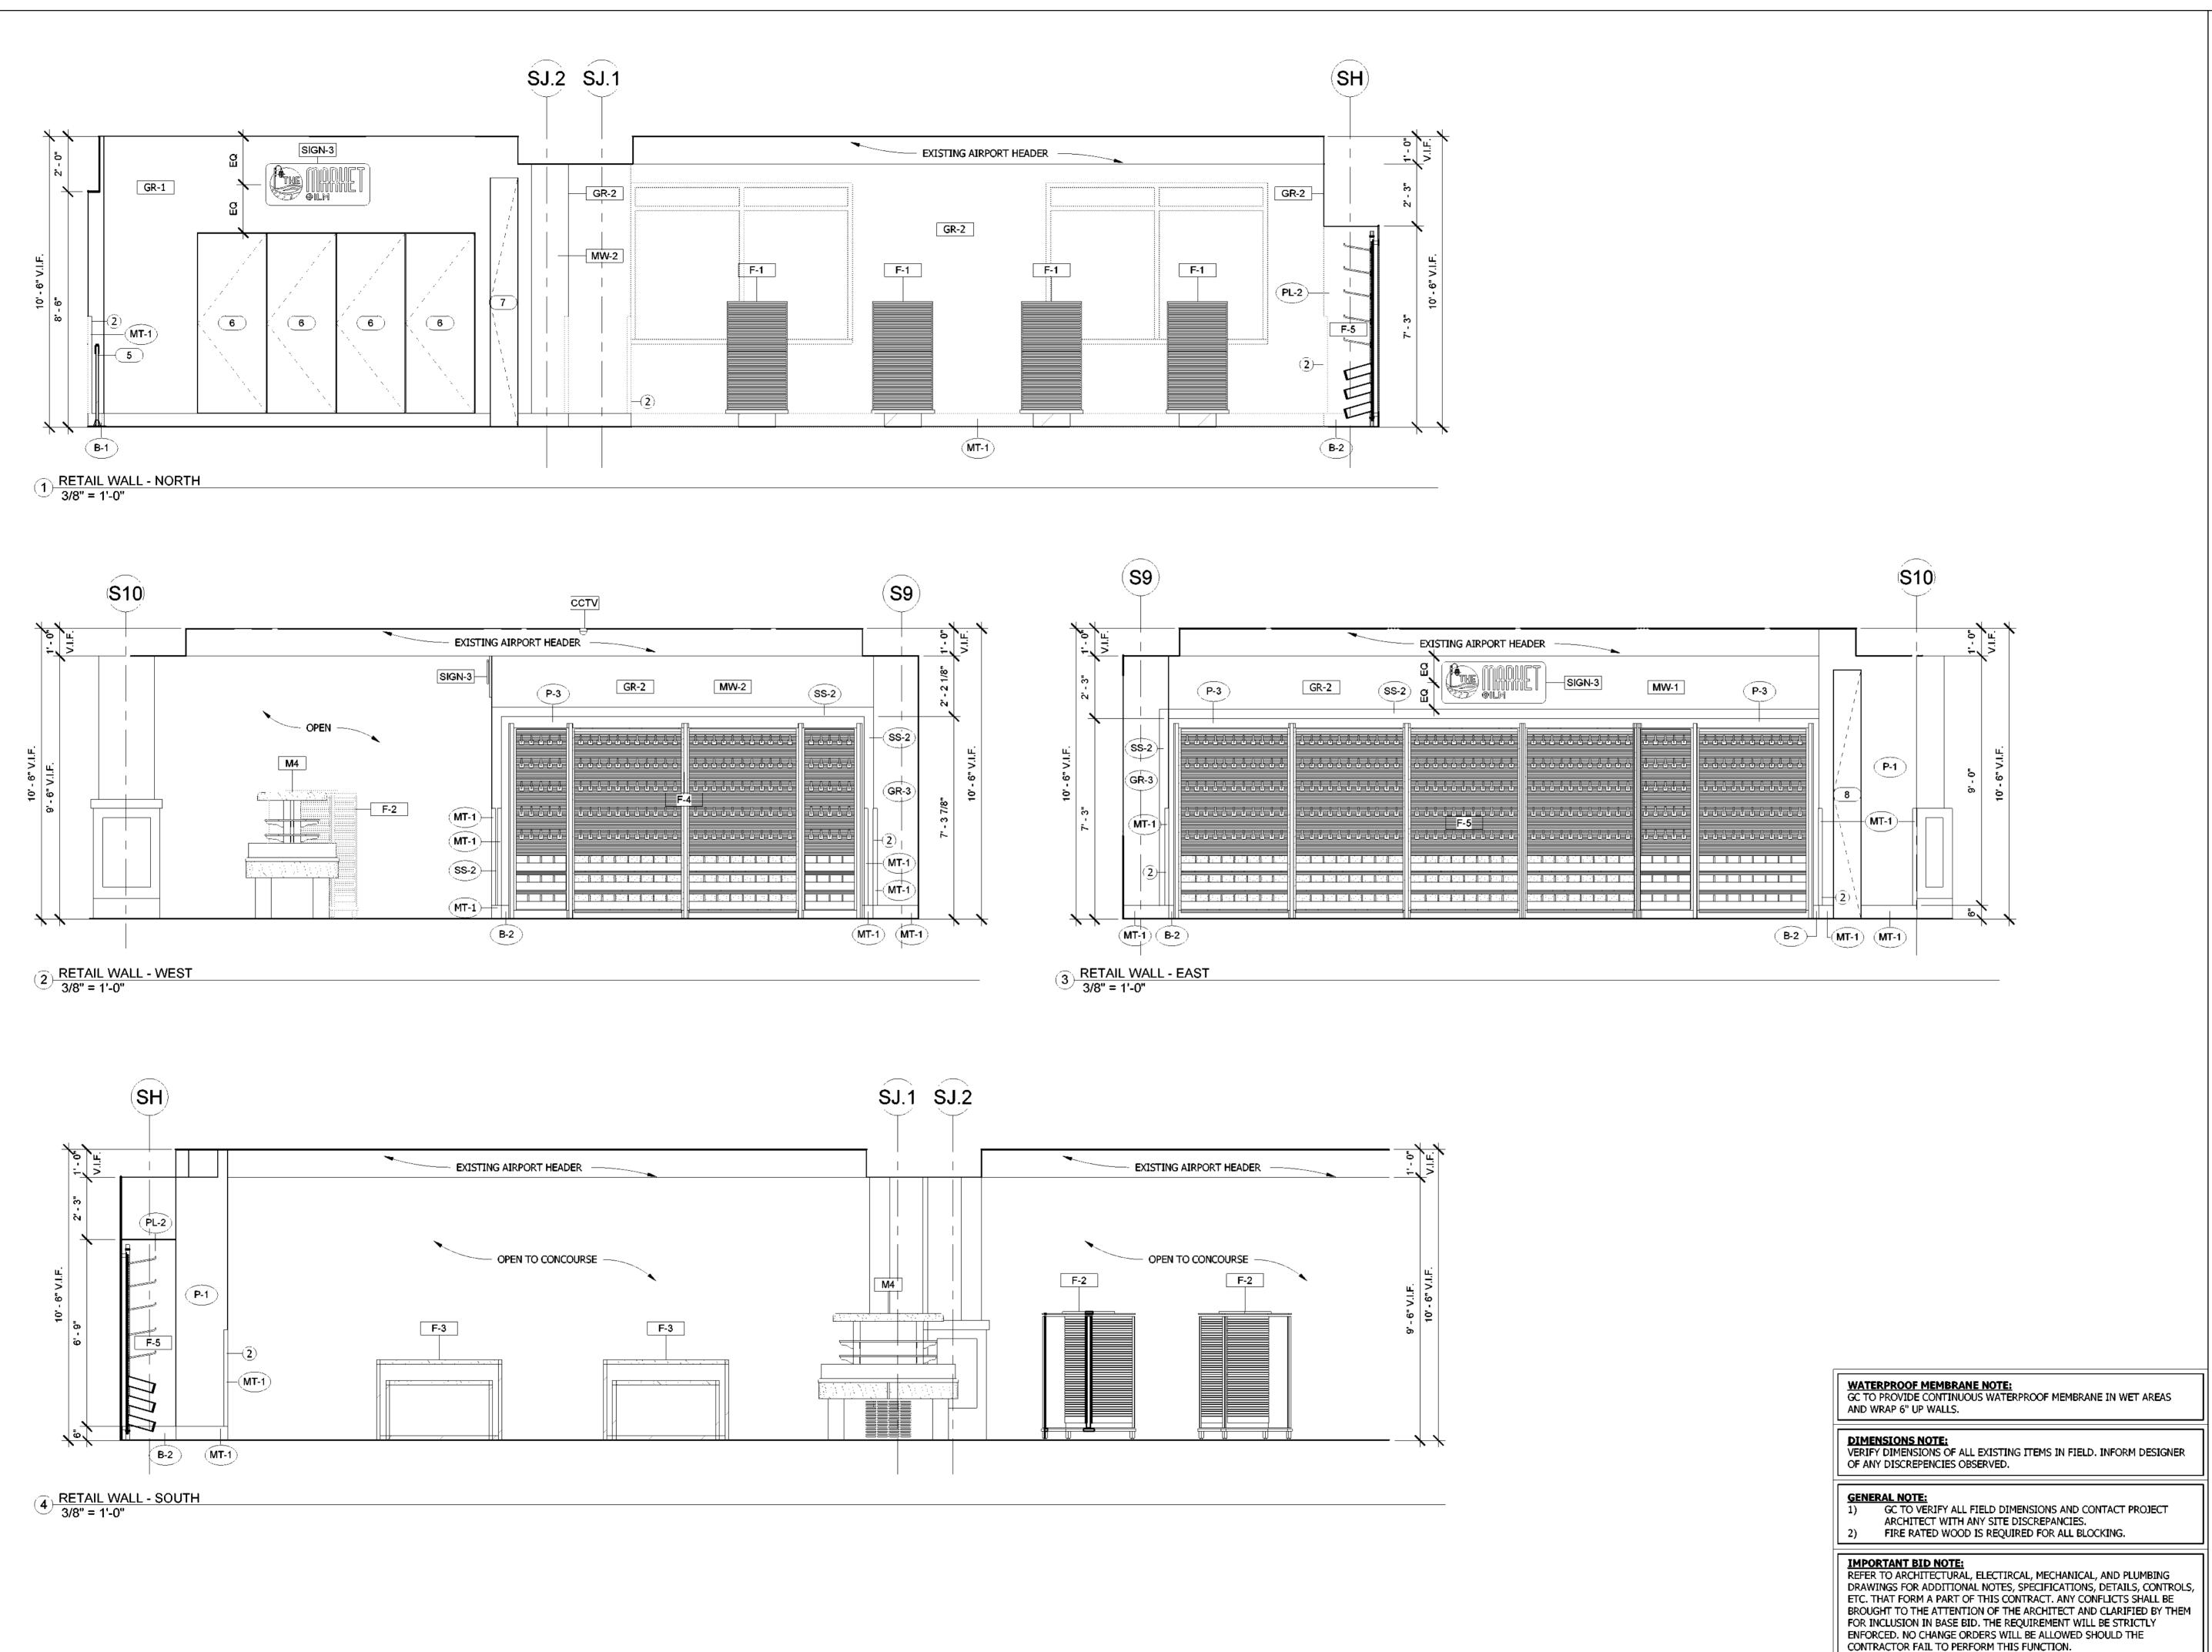

SILHOUETTE

DESIGN ARCHITECTURE

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60% SUBMITTAL



WILMINGTON INTERNATIONAL AIRPORT 1740 AIRPORT BLVD, WILMINGTON, NC, 28405 BOARDING LEVEL, ZONE 1

SPACE: A, B, AND C

06/23/2023

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ELEVATIONS

 Project number
 2023-019

 Date
 03-29-2023

 Drawn by
 AR


 Checked by
 BW

A4.1

ale 3/8" = 1'-0"

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GENERAL NOTE:

IMPORTANT BID NOTE:
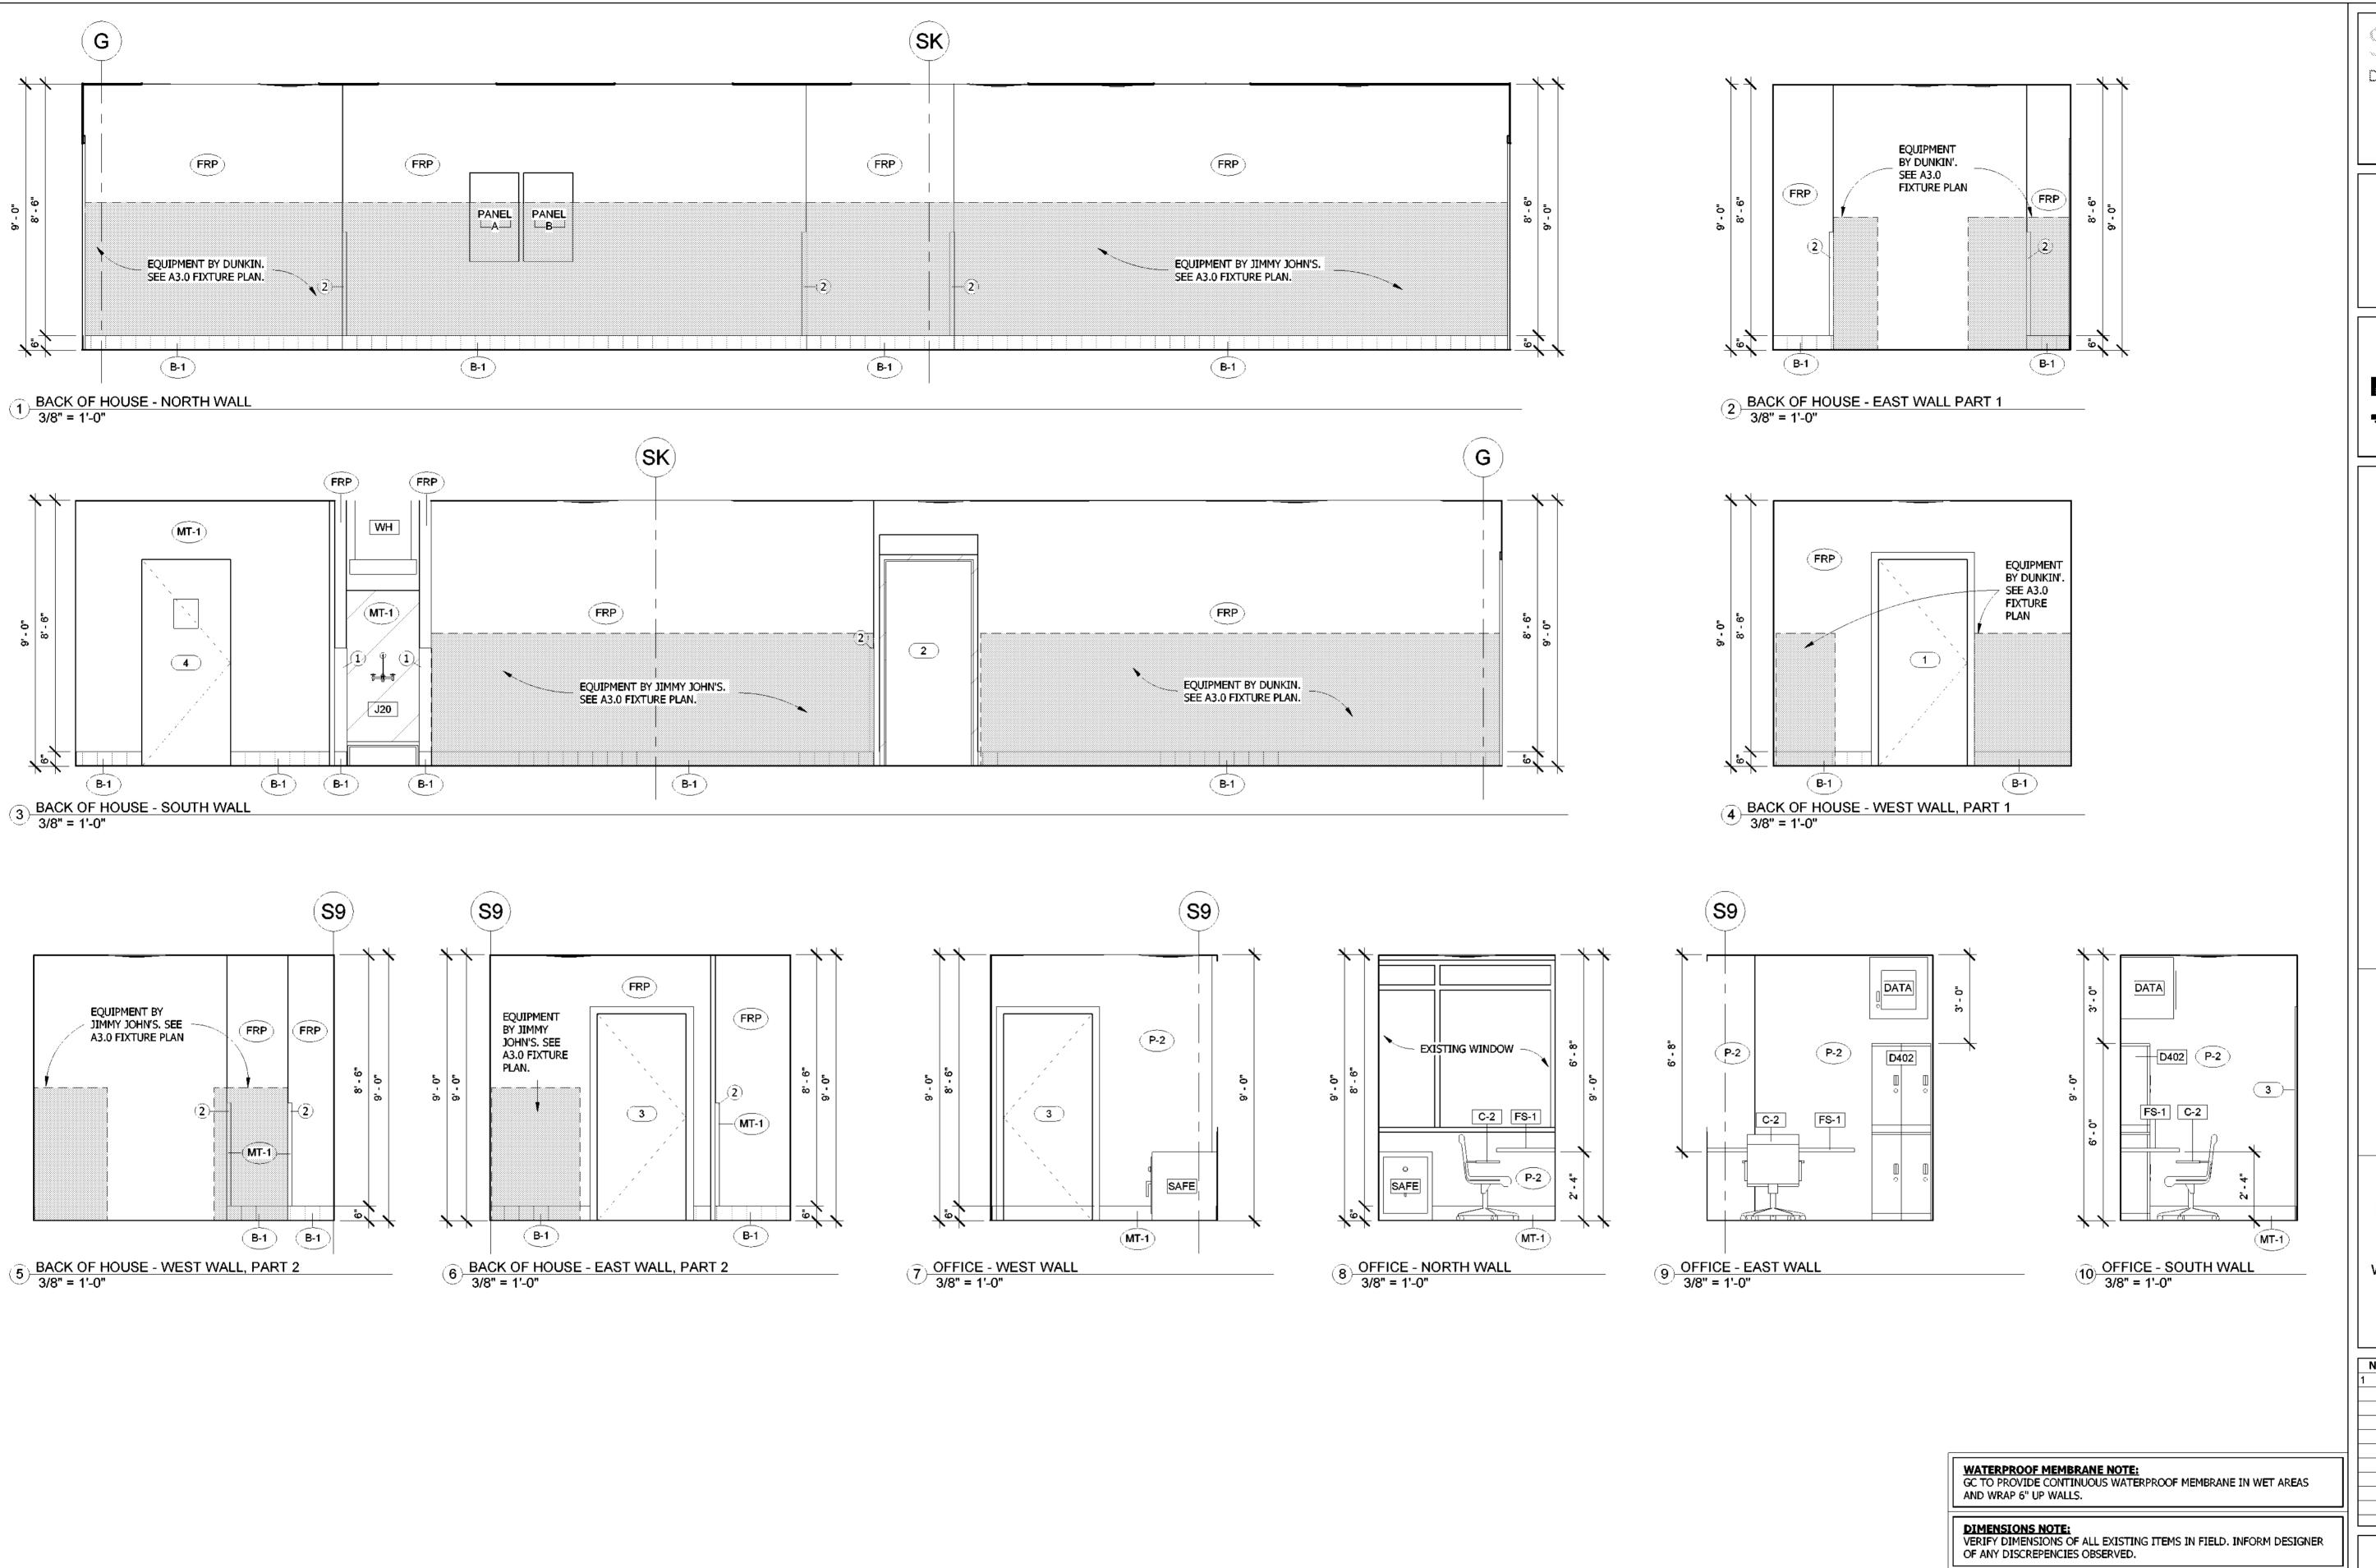
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ARCHITECT WITH ANY SITE DISCREPANCIES.
FIRE RATED WOOD IS REQUIRED FOR ALL BLOCKING.



Date

WILMINGTON INTERNATIONAL AIRPORT 1740 AIRPORT BLVD, WILMINGTON, NC, 28405 BOARDING LEVEL, ZONE 1 SPACE: A, B, AND C

Description

1	60% SUBMITTAL	06/23/2023

ELEVATIONS

 Project number
 2023-019

 Date
 03-29-2023

 Drawn by
 AR

 Checked by
 BW

A4.2

Scale

3/8" = 1'-0"

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WILMINGTON INTERNATIONAL AIRPORT 1740 AIRPORT BLVD, WILMINGTON, NC, 28405 BOARDING LEVEL, ZONE 1

SPACE: A, B, AND C

Description

Date

1	60% SUBMITTAL	06/23/2023

REMOTE STORAGE

ELEVATIONS

	\parallel	Project number	2023-019
	\parallel	Date	03-29-2023
	\parallel	Drawn by	AR
	\parallel	Checked by	BW
	ll	_	_

ETC. THAT FORM A PART OF THIS CONTRACT. ANY CONFLICTS SHALL BE BROUGHT TO THE ATTENTION OF THE ARCHITECT AND CLARIFIED BY THEM

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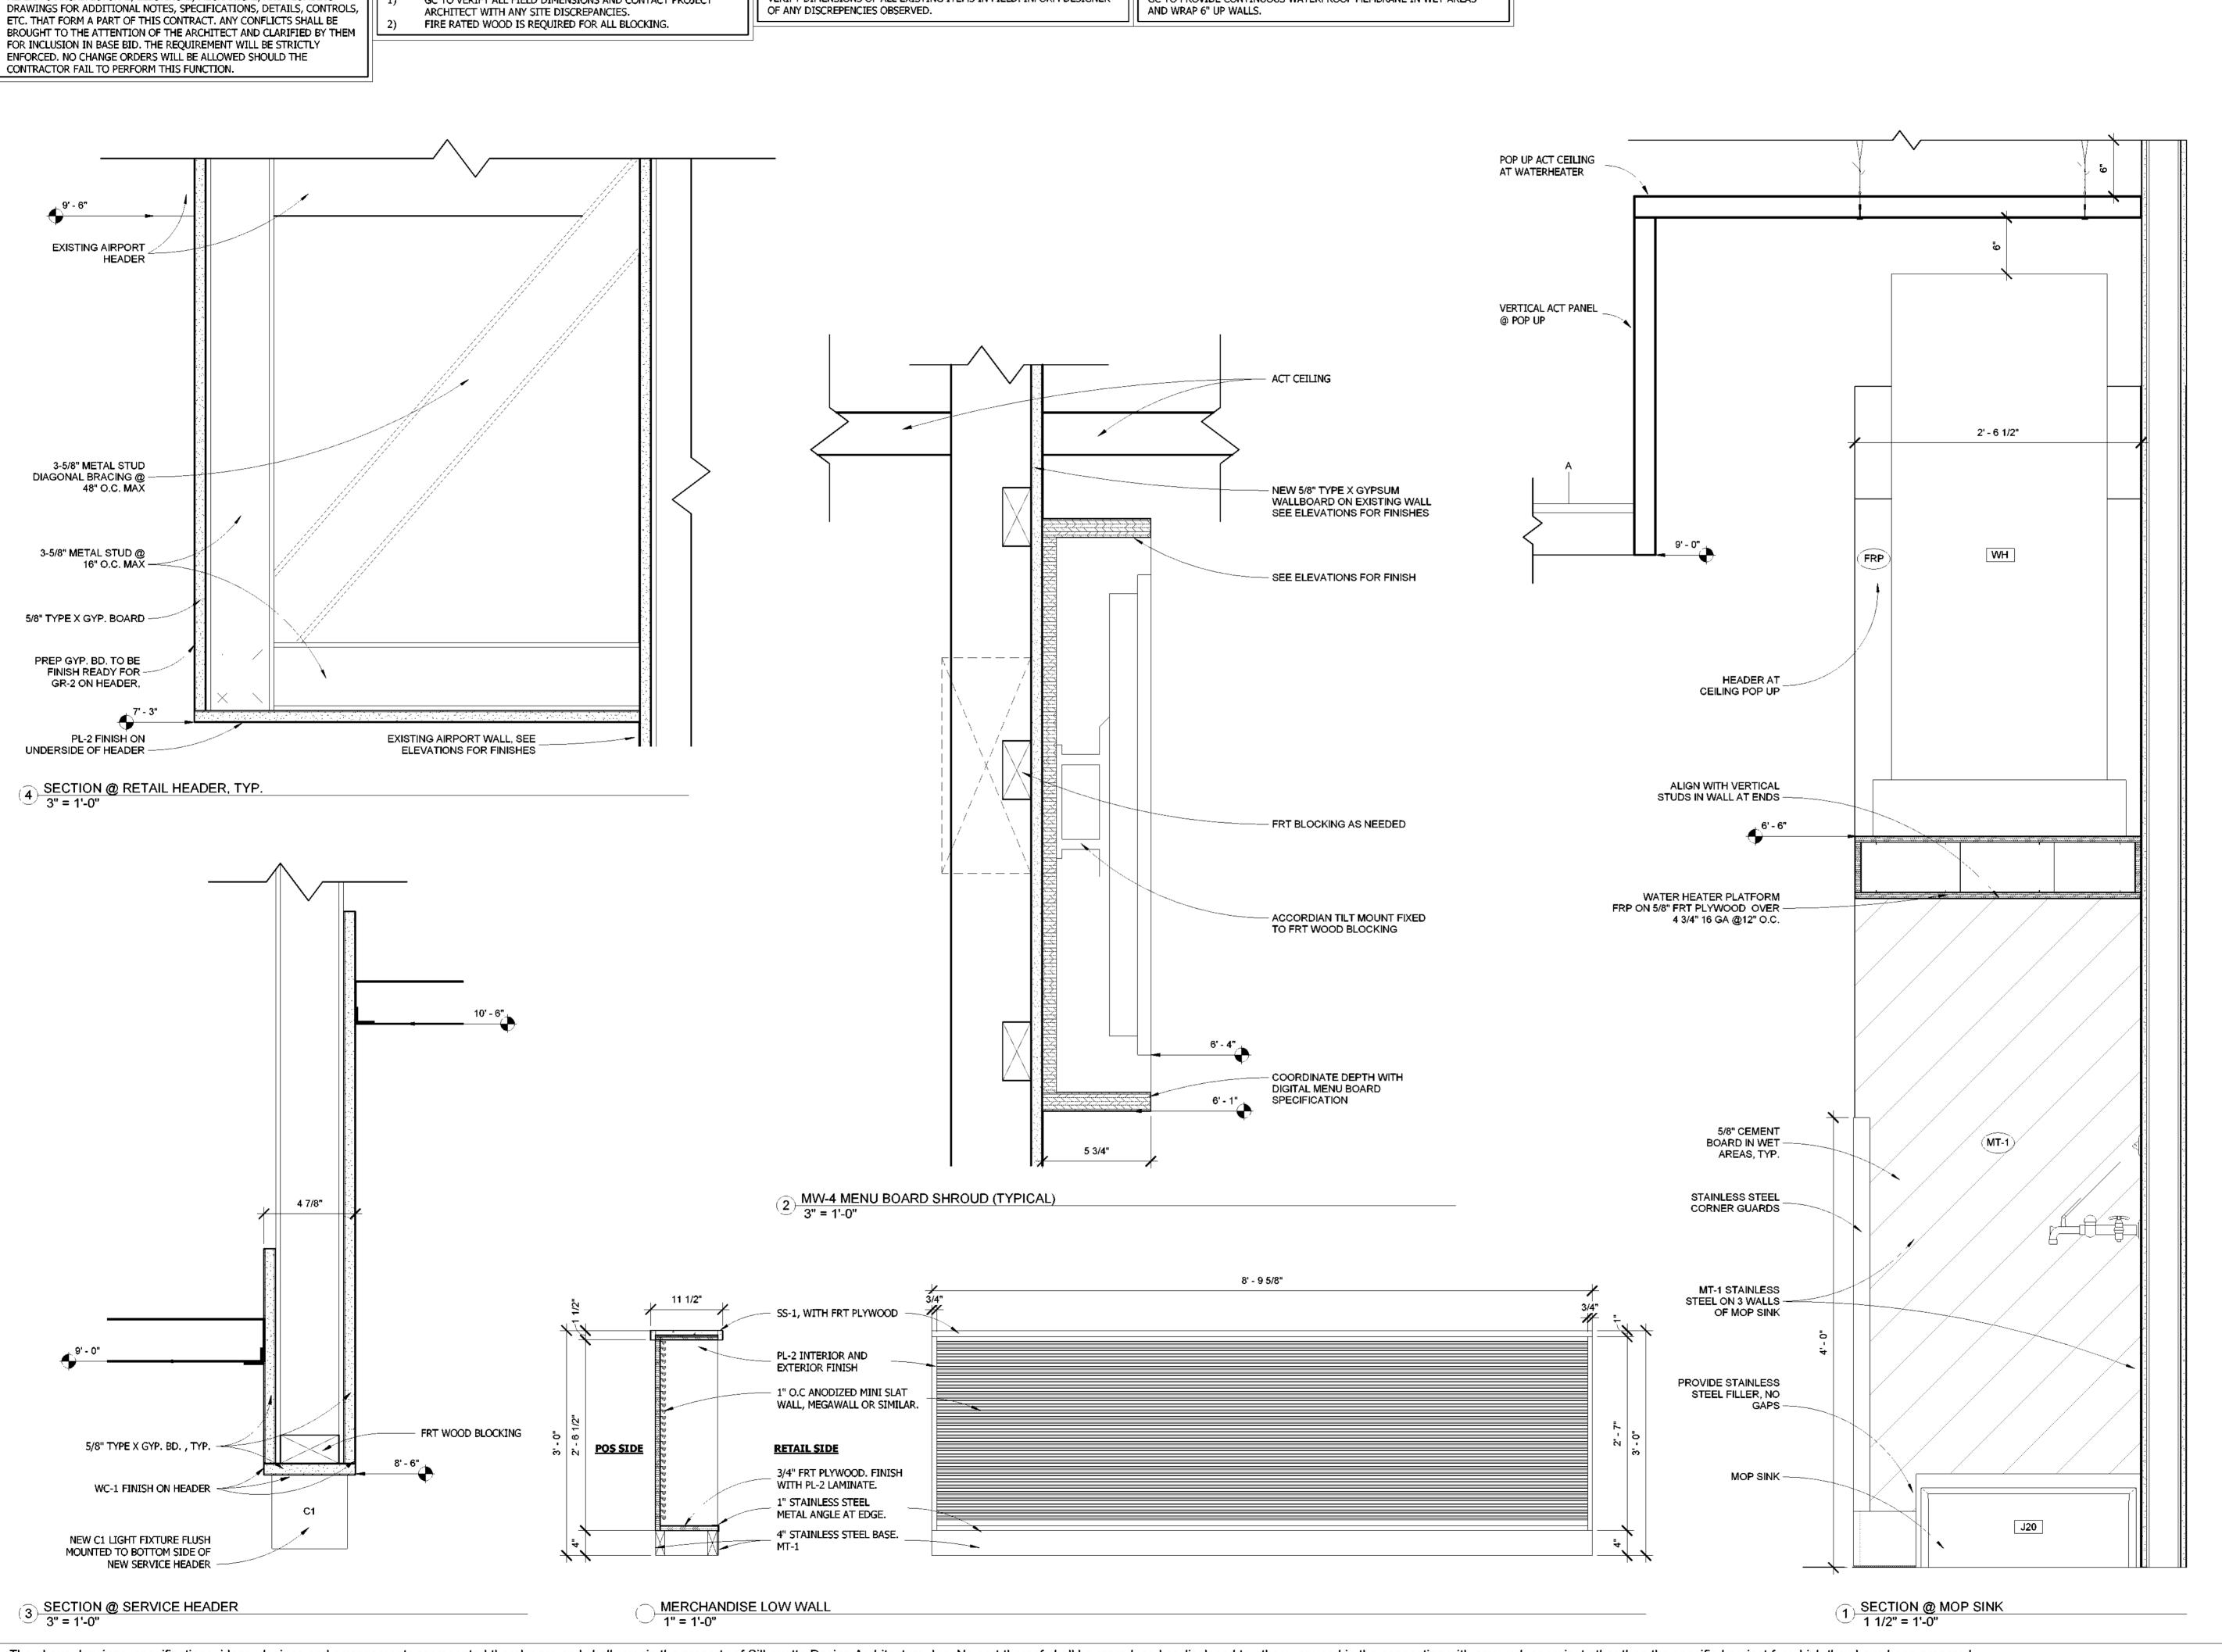
CONTRACTOR FAIL TO PERFORM THIS FUNCTION.

A4.3

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WATERPROOF MEMBRANE NOTE:

GC TO PROVIDE CONTINUOUS WATERPROOF MEMBRANE IN WET AREAS

DIMENSIONS NOTE:

VERIFY DIMENSIONS OF ALL EXISTING ITEMS IN FIELD, INFORM DESIGNER

GENERAL NOTE:

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IMPORTANT BID NOTE:
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DESIGN ARCHITECTURE



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WILMINGTON INTERNATIONAL AIRPORT 1740 AIRPORT BLVD, WILMINGTON, NC, 28405 BOARDING LEVEL, ZONE 1 SPACE: A, B, AND C

No.	Description	Date
1	60% SUBMITTAL	06/23/2023

DETAILS

 Project number
 2023-019

 Date
 03-29-2023

 Drawn by
 AR

 Checked by
 BW

A5.0

Scale


As indicated

GENERAL NOTES

- 1. THE DEMOLITION DRAWING INDICATES THE GENERAL EXTENT OF WORK.
 THE CONTRACTOR SHALL REMOVE ALL ELECTRICAL, MECHANICAL,
 PLUMBING DEVICES, PIPING, EQUIPMENT ETC NOT TO BE UTILIZED IN THE
 COMPLETED PROJECT. EQUIPMENT SHOWN IS FOR REFERENCE ONLY
 AND DOES NOT SHOW ALL ITEMS TO BE REMOVED. CONTRACTOR IS
 RESPONSIBLE FOR VERIFYING ALL DEVICES, MATERIALS AND EQUIPMENT
 TO BE REMOVED.
- 2. ALL EXISTING ELECTRICAL DEVICES/EQUIPMENT AND LIGHT FIXTURES AND CONTROLS TO REMAIN UNLESS INDICATED OTHERWISE.
- MAINTAIN/RESTORE ANY EXISTING CIRCUITS SERVING DEVICES TO REMAIN WHICH MAY BE ON THE SAME CIRCUIT AS DEVICE INDICATED TO BE REMOVED.
- CONTRACTOR SHALL FIELD VERIFY BRANCH CIRCUIT SOURCE PANEL AND NUMBER OF ANY 4. EXISTING TO REMAIN DEVICES AND FIXTURES PRIOR TO DEMOLITION.

PLAN NOTES:

- #
- EXISTING LIGHT FIXTURE/CONTROLS TO REMAIN. MAINTAIN EXISTING BRANCH CIRCUITRY AND CIRCUIT BREAKER(S).
- EXISTING DEVICE TO REMAIN. MAINTAIN EXISTING BRANCH CIRCUITRY AND CIRCUIT BREAKER(S).
- EXISTING FIRE ALARM DEVICE TO REMAIN.
- 4. REMOVE EXISTING LIGHT FIXTURE/SWITCH. REMOVE ASSOCIATED WIRES AND CONDUITS BACK TO NEAREST J-BOX.

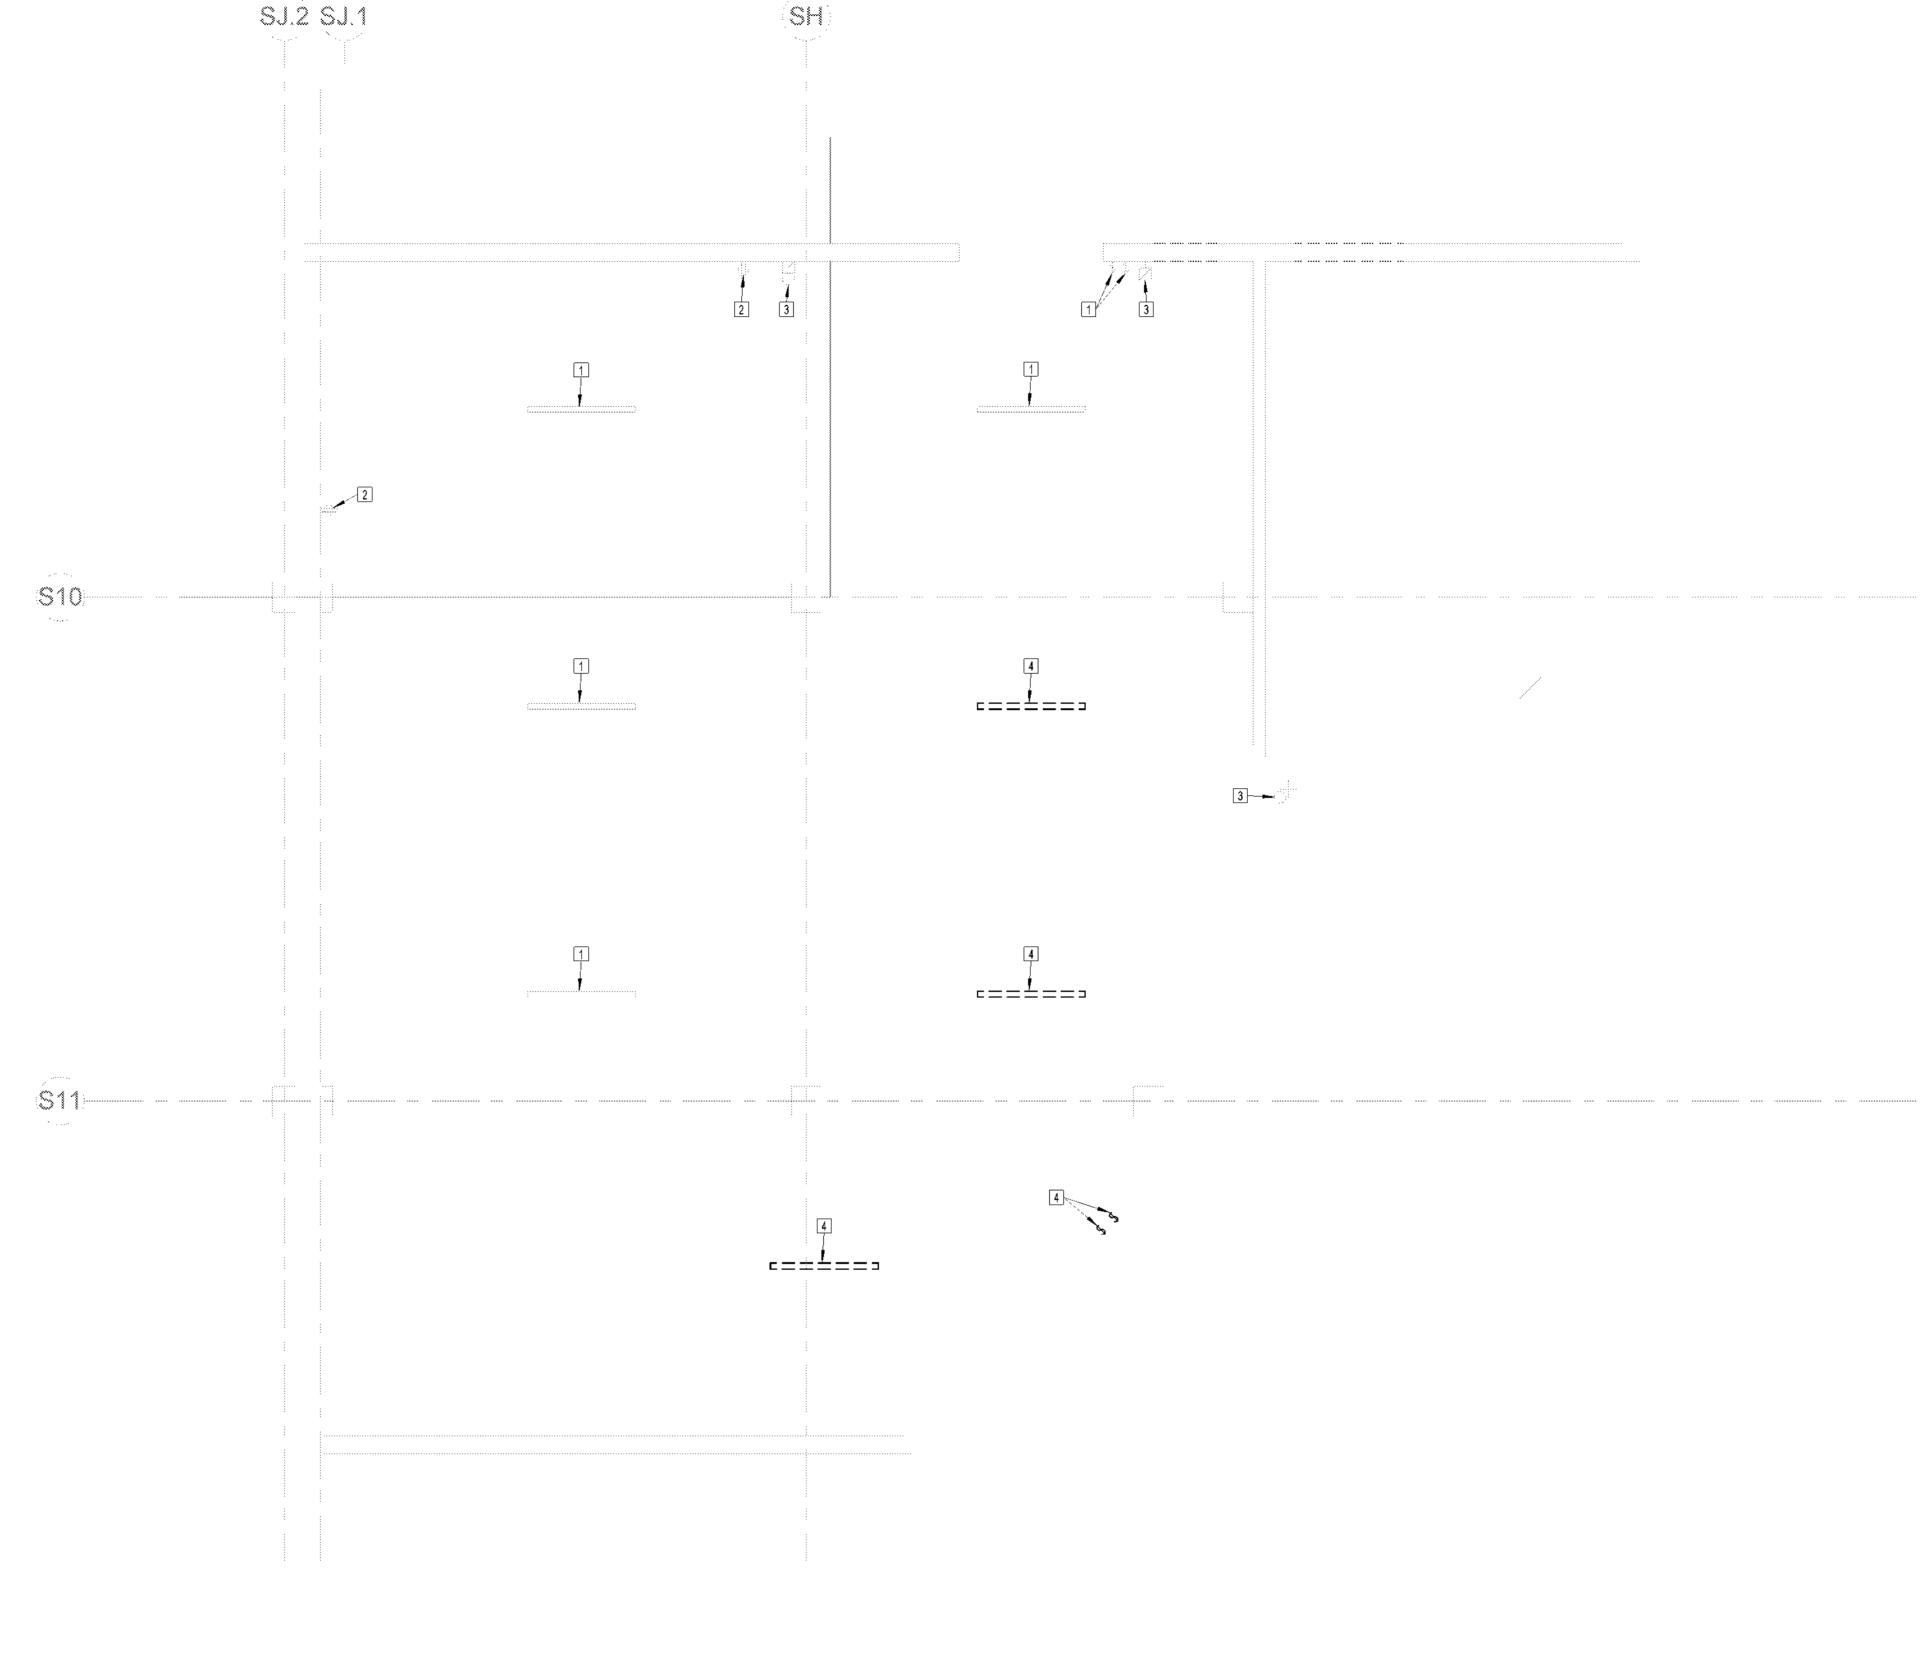

RAMP LEVEL - DEMO PLAN - LIGHTING

1 AND POWER 3/16" = 1'-0" TRUE PRO-NORTH

SILHOUETTE

DESIGN ARCHITECTURE

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No.	Description	Date
1	60% SUBMITTAL	06/23/2023

DEMOLITION POWER & LIGHTING PLAN -RAMP LEVEL

 Project number
 2023-019

 Date
 06-23-2023

 Drawn by
 Author

 Checked by
 LU

DE100

Scale

As indicated

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Written dimensions on these drawings shall have precedence over scaled dimensions: Contractors shall verify and be responsible for all dimensions and conditions form the dimensions and conditions shown by these drawings. Shop drawings must be submitted to this office for review before proceeding with fabrication. COPYRIGHT 2023 Scott Costello, AIA.

PLAN NOTES:

- #
- EXISTING LIGHT FIXTURE TO REMAIN. INTERCEPT BRANCH CIRCUITRY AND PREPARE TO BE RECIRCUITED VIA NEW TENANT PANEL. SEE SHEET EL101 FOR ADDITIONAL INFORMATION.
- EXISTING DEVICE TO REMAIN. MAINTAIN EXISTING BRANCH CIRCUITRY AND CIRCUIT BREAKER(S).
- 3. EXISTING FIRE ALARM DEVICE TO REMAIN.
- 4. REMOVE EXISTING LIGHT FIXTURE/SWITCH. REMOVE ASSOCIATED WIRES AND CONDUITS BACK TO NEAREST J-BOX.
- REMOVE EXISTING DEVICE. REMOVE ASSOCIATED WIRES AND CONDUITS BACK TO NEAREST J-
- 6. EXISTING SPEAKER TO REMAIN. PROTECT DURING CONSTRUCTION.
- REMOVE EXISTING SPEAKER. REMOVE ASSOCIATED CABLES AND CONDUITS BACK TO NEAREST J-BOX.

GENERAL NOTES

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DEMOLITION POWER & LIGHTING PLAN -BOARDING LEVEL

 Project number
 2023-019

 Date
 06-23-2023


 Drawn by
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DE101

Scale

1/4" = 1'-0"



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PLAN NOTES:

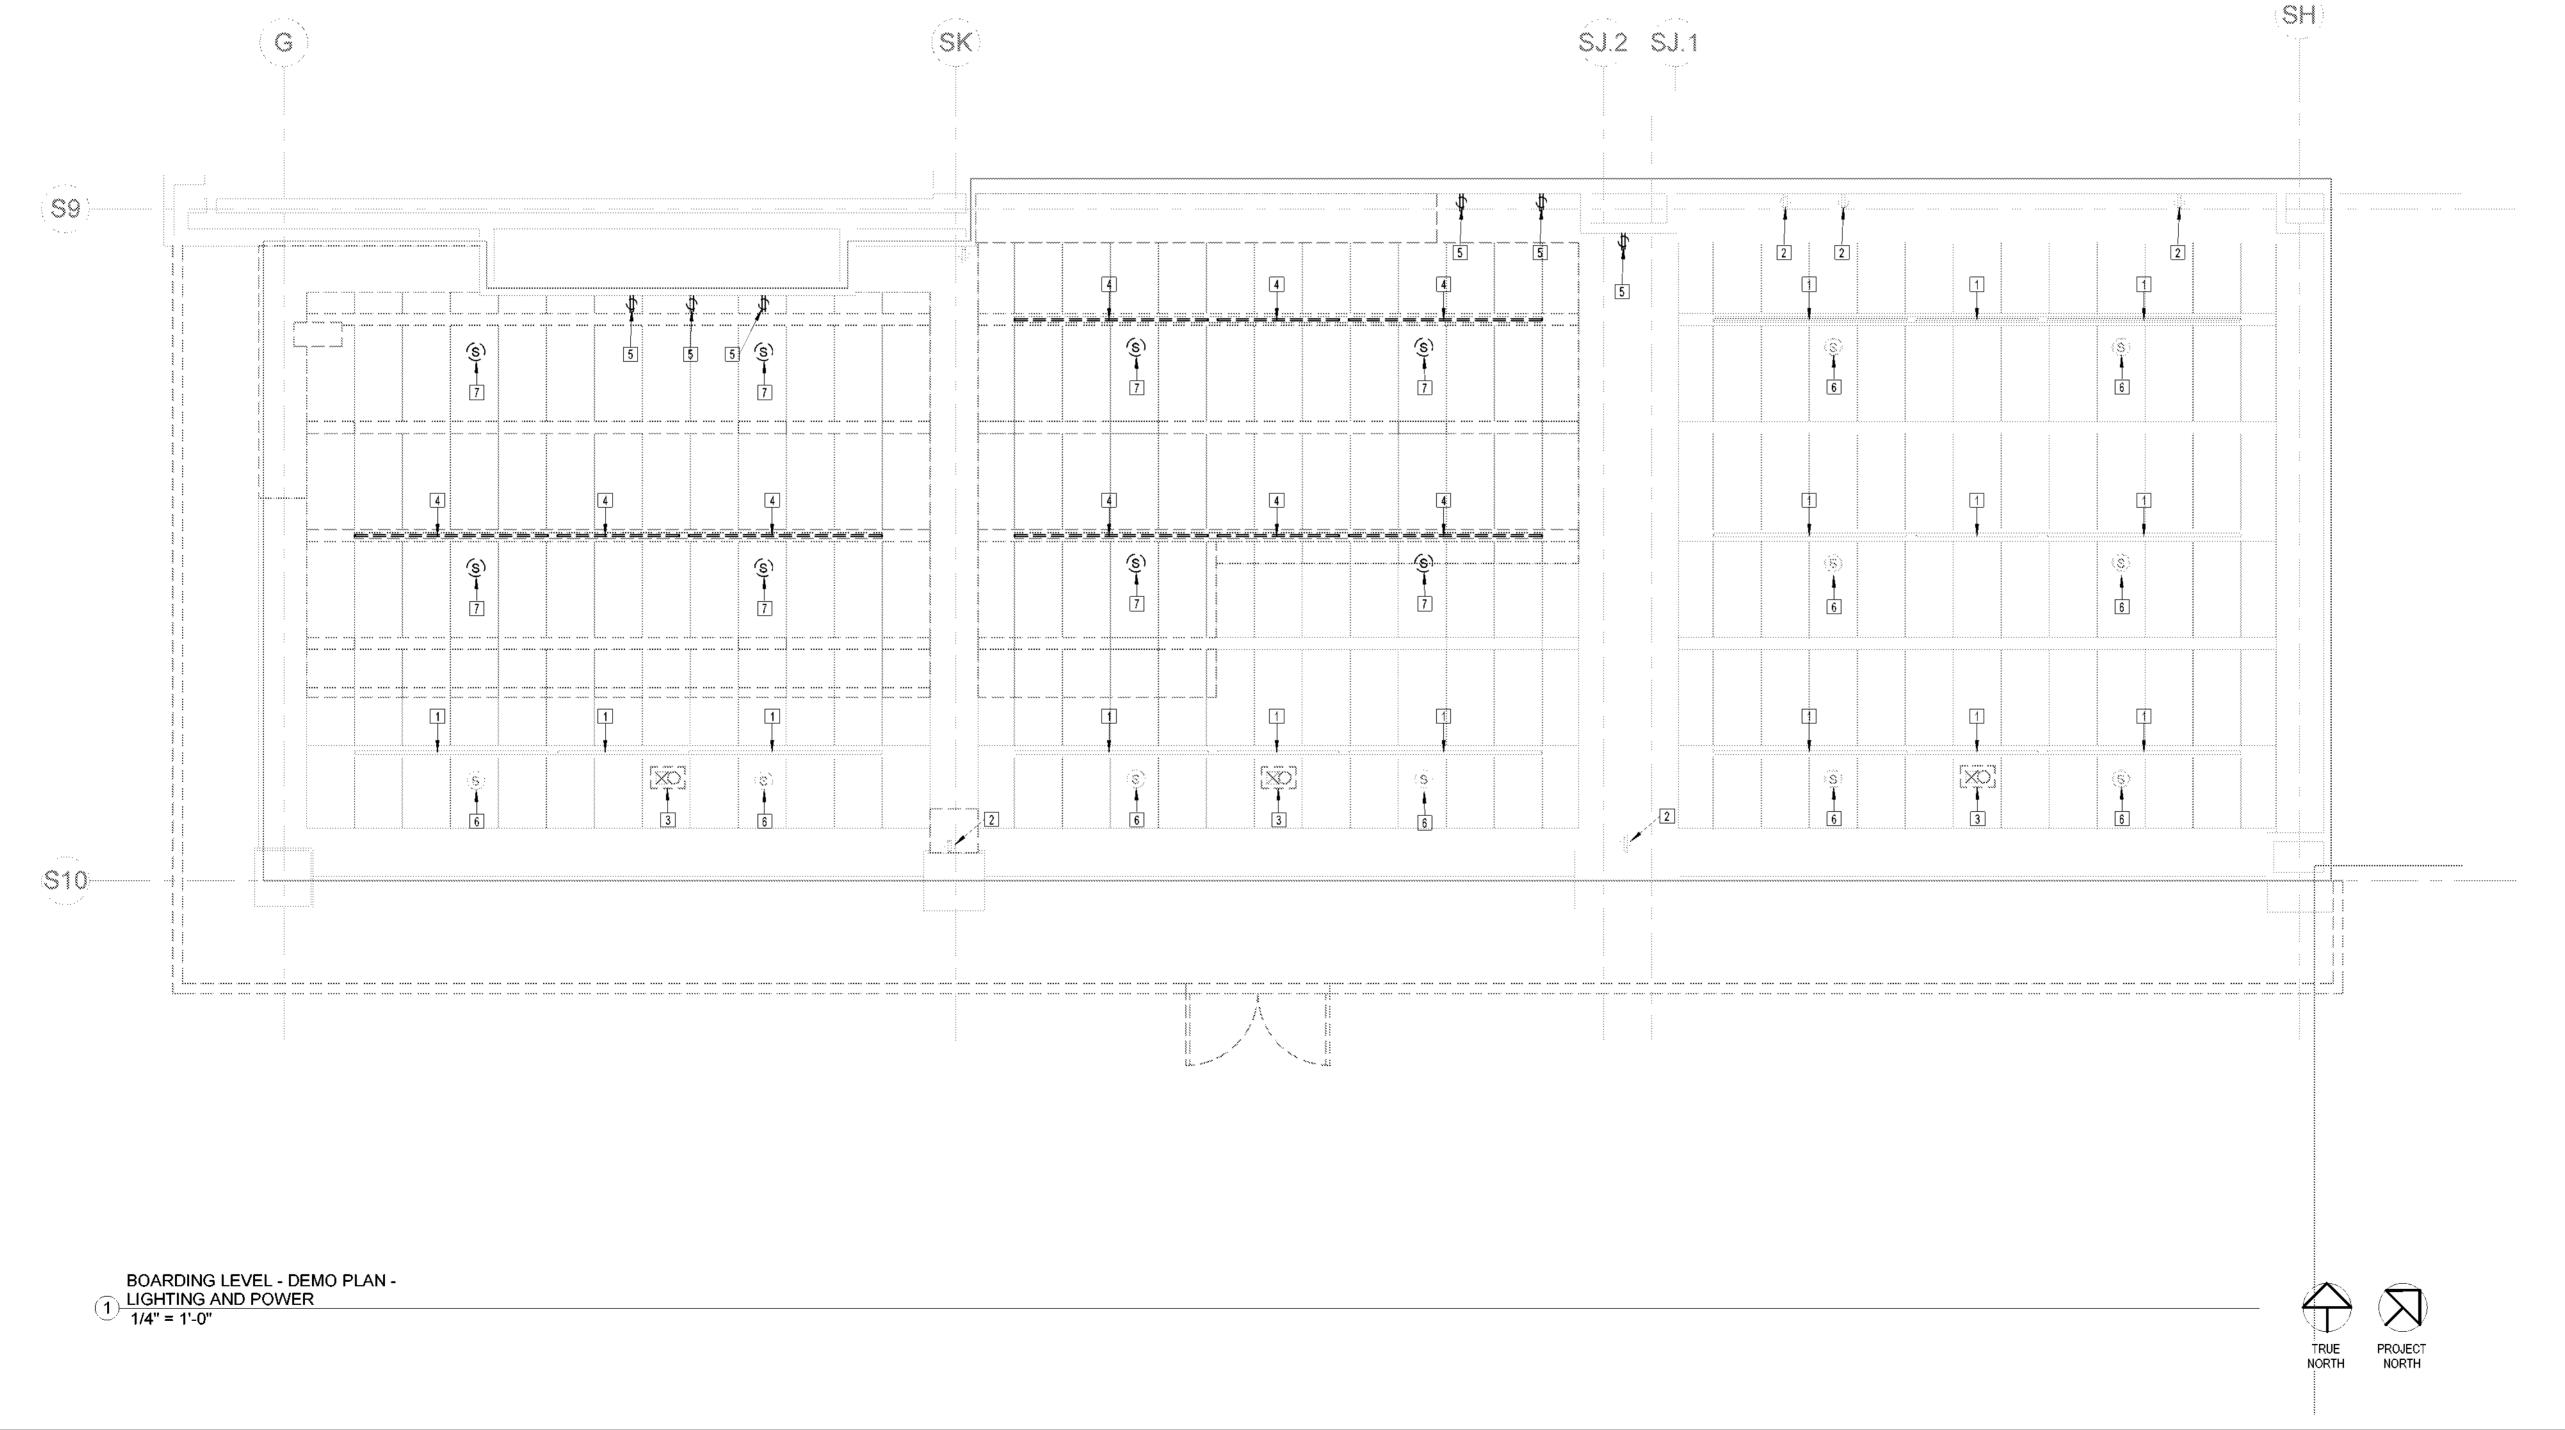(#)

EXISTING SUPPLY DIFFUSER TO REMAIN.

- 2. EXISTING BLOWER COIL TO REMAIN. SEE BLOWER COIL SCHEDULE ON SHEET M600 FOR REBALANCING OF EQUIPMENT.
- 3. EXISTING RETURN GRILLE TO REMAIN.
- 4. REMOVE EXISTING SUPPLY DIFFUSER. REMOVE EXISTING FLEX DUCT AND DUCTWORK BACK TO MAIN TRUNK AS SHOWN.
- REMOVE EXISTING RETURN GRILLE.
- 6. REMOVE AND RELOCATE EXISTING TEMPERATURE SENSOR. PREPARE EXISTING CONTROL WIRING TO BE REROUTED TO NEW LOCATION. SEE SHEET M101 FOR NEW LOCATION.

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 TO BE REMOVED.

2. CONTRACTOR SHALL FIELD VERIFY EXISTING DUCTWORK SIZES AND LOCATIONS PRIOR TO BEGINNING WORK.


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No.	Description	Date
1	60% SUBMITTAL	06/23/2023

MECHANICAL DEMOLITION PLAN -BOARDING LEVEL

 Project number
 2023-019


 Date
 06-23-2023

 Drawn by
 Author

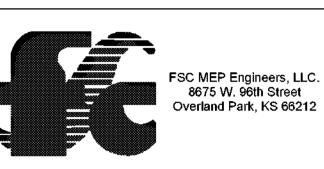 Checked by
 LU

DM101

1/4" = 1'-0"

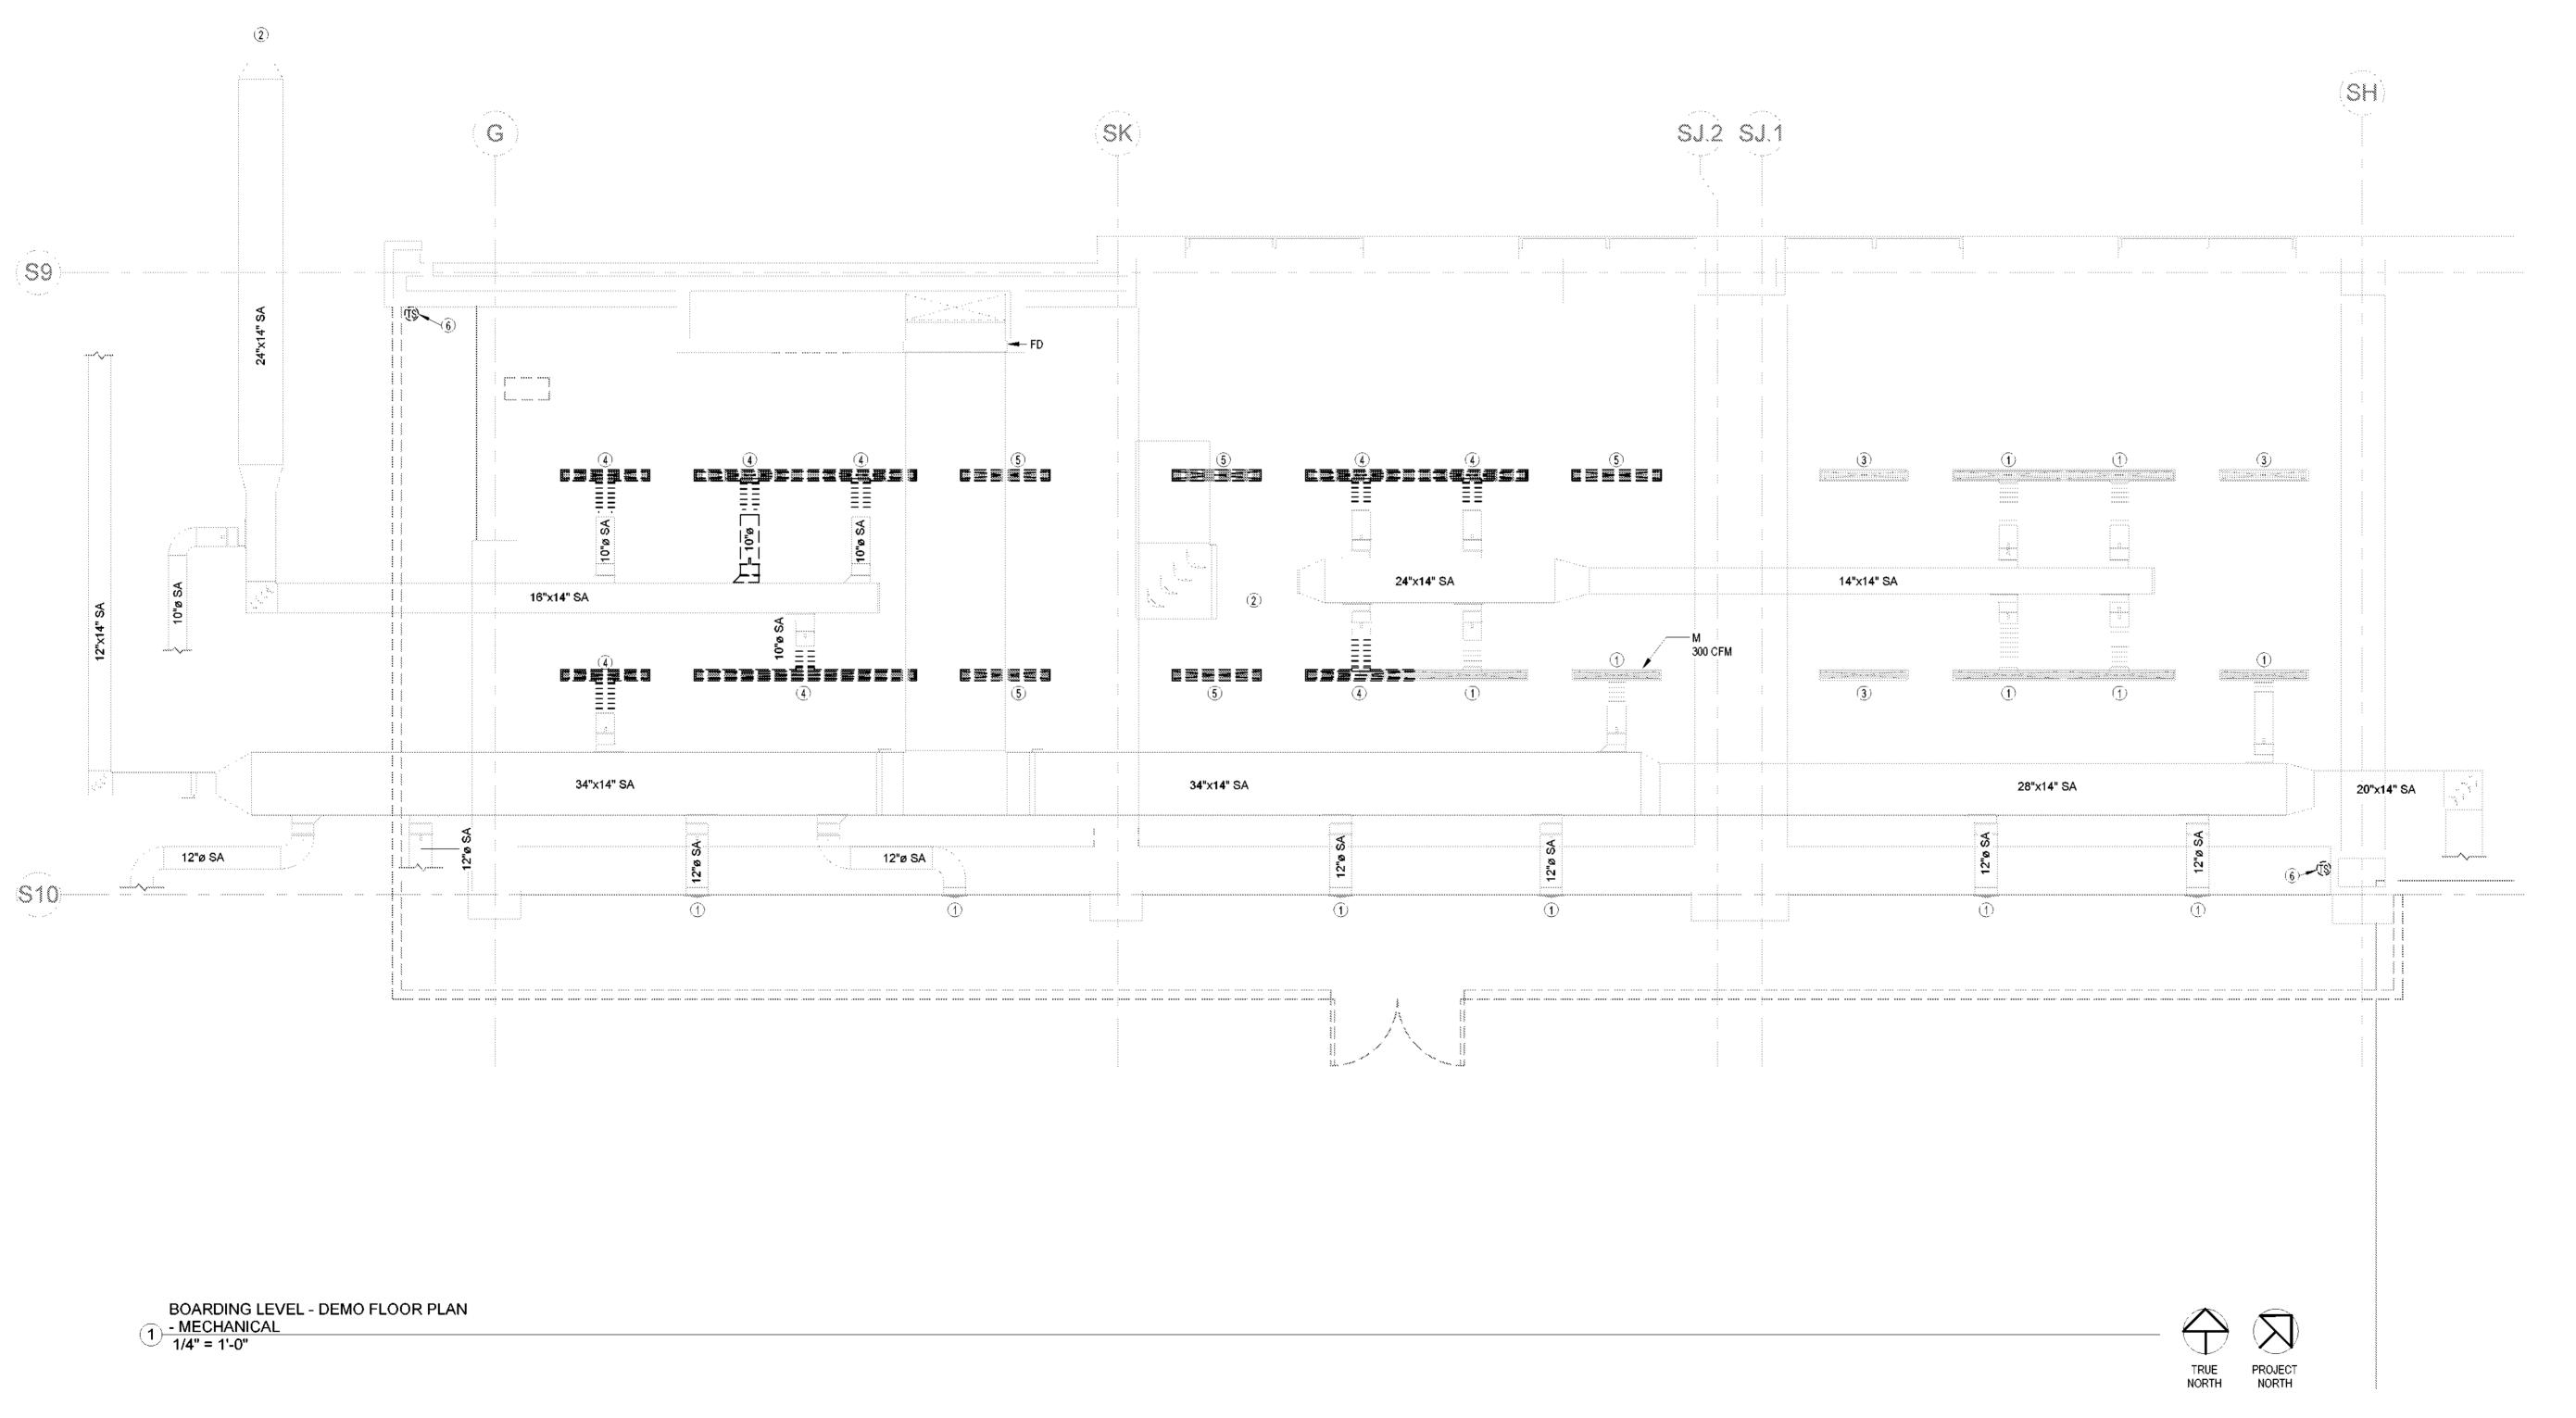

LEGEND FIRE ALARM FIRE DETECTION EQUIPMENT. DETECTOR TYPE: S=SMOKE, H=HEAT, F=FLAME, INDICATES CIRCUIT NUMBER CO C=COMBINATION SMOKE/HEAT, CO=CO SENSOR

INTERCOM

FIRE ALARM PULL STATION

FIRE ALARM - VISUAL ONLY

WALL MOUNTED 2-WAY HORN

CEILING MOUNTED 2-WAY HORN

PUSH BUTTON CONTROL SWITCH

CEILING MOUNTED SPEAKER

WALL MOUNTED SPEAKER

FIRE ALARM NOTE

CONNECT TO EXISTING

LIMIT OF DEMOLITION

CONTINUATION

MAGNETIC OR ELECTRICAL DOOR HOLDER


FIRE ALARM HORN - AUDIBLE ONLY

CEILING MOUNTED FIRE ALARM - VISUAL ONLY

FIRE ALARM - INTELLIGIBLE SPEAKER/VISUAL

CEILING MOUNTED FIRE ALARM - AUDIBLE/VISUAL

UPPER CASE LETTER INDICATES FIXTURE TYPE, LOWER CASE LETTER INDICATES SWITCHING DESIGNATION & UPPER CASE LETTER WITH NUMBER RECESSED OR PENDANT MOUNT LIGHT WITH FIXTURE MARK. D=DUCT MOUNTED - DUCT TYPE: "S"=SUPPLY PLENUM; "R"=RETURN PLENUM LIGHT WITH FIXTURE MARK, WALL BRACKET C32 FIRE ALARM HORN - AUDIBLE ONLY - CEILING MOUNTED LS32 12x48 LIGHT FIXTURE 12x48 LIGHT FIXTURE ON EMERGENCY POWER 24x24 LIGHT FIXTURE 24x24 LIGHT FIXTURE ON EMERGENCY POWER 24x48 LIGHT FIXTURE

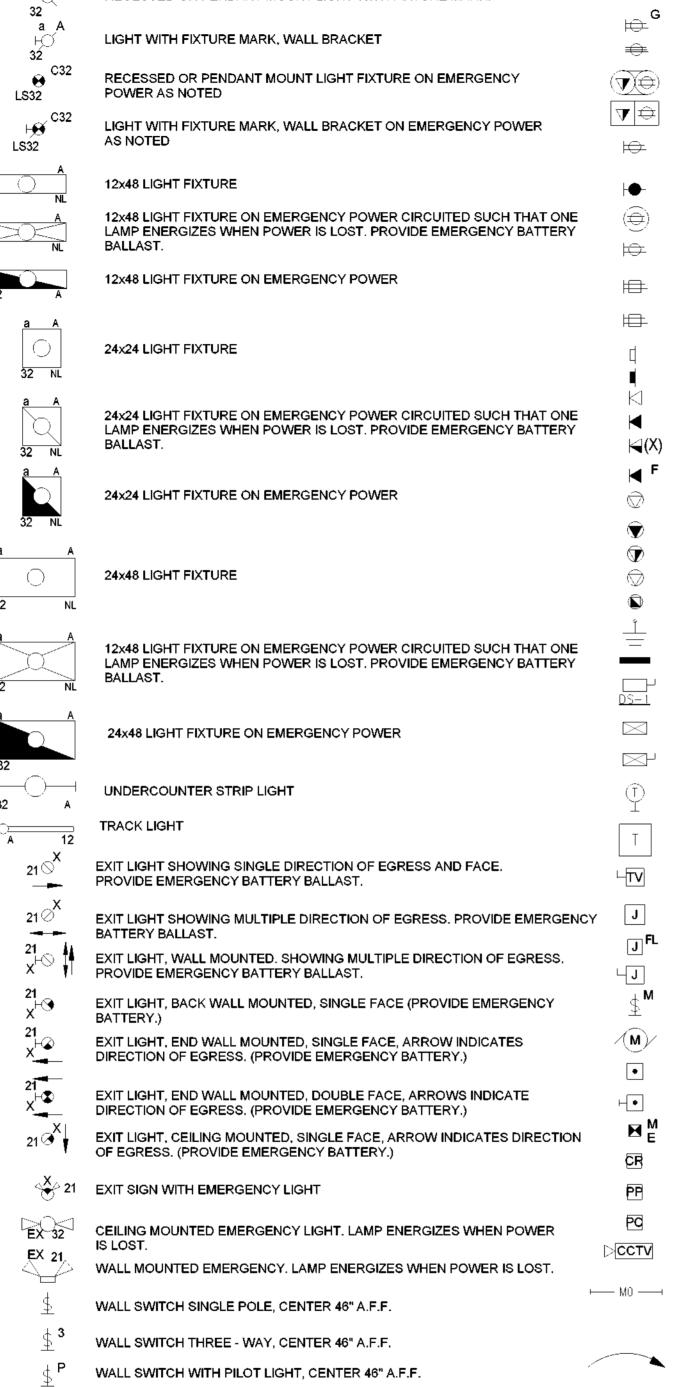

KEY OPERATED WALL SWITCH, CENTER 46" A.F.F.

COMBINATION OCCUPANCY SENSOR/SWITCH

OCCUPANCY SENSOR - CEILING MOUNTED

OCCUPANCY SENSOR - WALL MOUNTED

INDICATES LIGHTING FIXTURE SWITCHING SCHEME

NIGHT LIGHT - UNSWITCHED FOR 24-HOUR OPERATION AS NOTED

DIMMER SWITCH, CENTER 46" A.F.F.

MOTOR RATED WALL SWITCH

LIGHTING NOTE

CONTINUATION

CONNECT TO EXISTING

LIMIT OF DEMOLITION

a,b,c,d

ELECTRICAL DUPLEX GROUNDING TYPE RECEPTACLE CENTERED 4" ABOVE BACK SPLASH, COUNTER OR SURFACE. COORDINATE WITH ARCHITECTURAL CASEWORK DOCUMENTS. DUPLEX GROUNDING TYPE RECEPTACLE, CENTER 18" A.F.F. UNLESS NOTED. GROUND FAULT INTERRUPTING RECEPTACLE. CENTER 18" A.F.F. UNLESS SPECIAL RECEPTACLE AS NOTED FLOOR MOUNTED COMBINATION DATA/POWER RECEPTACLE CEILING MOUNTED COMBINATION DATA/POWER RECEPTACLE DUPLEX GROUNDING TYPE RECEPTACLE ON EMERGENCY POWER, CENTER 18" A.F.F. UNLESS NOTED. SIMPLEX GROUNDING TYPE RECEPTACLE. CENTER 18" A.F.F. UNLESS FLUSH FLOOR DUPLEX GROUNDING TYPE RECEPTACLE. DUPLEX RECEPTACLE ON ISOLATED GROUND, CENTER 18" A.F.F. UNLESS QUADRUPLEX GROUNDING TYPE RECEPTACLE. CENTER 18" A.F.F. UNLESS QUADRUPLEX GROUND FAULT INTERRUPTING RECEPTACLE. CENTER 18" A.F.F. UNLESS NOTED. GANG BOX

GANG BOX ON ISOLATED GROUND DATA OUTLET. CENTER 18" A.F.F. UNLESS NOTED. TELEPHONE OUTLET. CENTER 18" A.F.F. UNLESS NOTED. DATA OUTLET. CENTER 18" A.F.F. UNLESS NOTED. PROVIDE (2) DATA DROPS UNLESS NOTED OTHERWISE IN PARANTHESES.

FIRE DEPARTMENT EMERGENCY TELEPHONE OUTLET DATA OUTLET IN FLOOR BOX TELEPHONE OUTLET IN FLOOR BOX COMBINATION DATA/TELEPHONE OUTLET IN FLOOR BOX SPECIAL OUTLET IN FLOOR BOX FLOOR MOUNTED POWER POLE

PANELBOARD, TOP 84" A.F.F. DISCONNECT SWITCH, SIZE AND TYPE AS NOTED IN DISCONNECT SWITCH SCHEDULE. MOTOR STARTER, SIZE AND TYPE AS NOTED.

MOTOR STARTER/DISCONNECT SWITCH, SIZE AND TYPE AS NOTED. ELECTRIC THERMOSTAT/CONTROL, EQUIPMENT CONNECTION AS REQUIRED. CENTER 46" A.F.F.

WALL MOUNTED TELEVISION SINGLE GANG BOX. PROVIDE WITH 3/4" CONDUIT TO ACCESSIBLE LOCATION ABOVE CEILING. CEILING MOUNTED JUNCTION BOX FLOOR MOUNTED JUNCTION BOX WALL MOUNTED JUNCTION BOX

MOTOR SWITCH

DESK MOUNTED PUSH BUTTON CONTROL SWITCH PUSH BUTTON CONTROL SWITCH MAGNETIC OR ELECTRICAL DOOR HOLDER

POWER PACK **PHOTOCELI**

CLOSED CIRCUIT TV MULTI - OUTLET ASSEMBLY WITH OUTLETS 12" ON CENTER (SINGLE OR DOUBLE CIRCUIT AS INDICATED ON DRAWINGS). ABOVE COUNTER

HOME RUN TO PANEL. ANY CIRCUIT WITHOUT FURTHER DESIGNATION. INDICATES A 2-#12 WIRE CIRCUIT WITH GROUND, A GREATER NUMBER OF N.E.C. IF HOME RUN IS ANNOTATED, SEE FEEDER AND BRANCH CIRCUIT SCHEDULE FOR SIZE.

ELECTRICAL NOTE CONNECT TO EXISTING LIMIT OF DEMOLITION

WEATHER-PROOF

CONTINUATION

GENERAL ANNOTATION ABBREVIATIONS

MEP MECHANICAL, ELECTRICAL, PLUMBING ABOVE FINISHED FLOOR ABOVE FINISHED GRADE

LEGEND

LEGEND

CHILLED WATER SUPPLY

CHILLED WATER RETURN

REFRIGERANT LIQUID

MEDIUM PRESSURE

LOW PRESSURE STEAM

HIGH PRESSURE STEAM

MEDIUM PRESSURE STEAM

PIPING TO BE DEMOLOISHED

CONDENSATE

FA RELIEF AIR

OA OUTSIDE AIR

RA RETURN AIR

SA SUPPLY AIR

ABBREVIATIONS EA EXHAUST AIR

SLOT DIFFUSER

REFRIGERANT SUCTION

HEATING HOT WATER SUPPLY

<u>MECHANICAL</u>

HHWR-

-MPC

LPS

MECHANICAL

22x22

CONTINUATION

---- CHWR-

--- HHWS-

CW DOMESTIC COLD WATER FCW FILTERED COLD WATER SCW SOFTENED COLD WATER HW DOMESTIC HOT WATER HWR HOT WATER RECIRCULATION THW TEMPERED HOT WATER ----- THWR TEMPERED HOT WATER RECIRCULATION REFRIGERANT DISCHARGE GAS SANITARY VENT LOW PRESSURE CONDENSATE -----VBG-------VBG SANITARY VENT BELOW GRADE HIGH PRESSURE CONDENSATE SANITARY SANITARY WASTE COMPRESSED AIR _____CA_____CA -----CD----- CD CONDENSATE DRAIN NATURAL GAS - LPG LIQUEFIED PETROLEUM GAS STORM DRAIN -----OSD----- OSD OVERFLOW STORM DRAIN STORM DRAIN BELOW GRADE -NPW---- NPW NON-POTABLE WATER ____SP___ SUMP PUMP DISCHARGE OF

SEWAGE PUMP DISCHARGE

PIPING TO BE DEMOLISHED

NATURAL GAS ON ROOF

SPIN-IN WITH DAMPER IN NECK ABBREVIATIONS: AIR FLOW DIRECTION NORMALLY OPEN N.C. NORMALLY CLOSED RETURN GRILLE/DUCT FAIL OPEN FAIL CLOSE INDIRECT WASTE SUPPLY DIFFUSER/DUCT FLOOR OR EXTERIOR CLEAN OUT EXHAUST GRILLE/DUCT CLEAN OUT WALL CLEAN OUT ____ MANUAL VOLUME DAMPER BACKDRAFT DAMPER FLOOR DRAIN FIRE DAMPER FLOOR SINK FIRE/SMOKE DAMPER HOSE BIBB MOTORIZED DAMPER WALL HYDRANT

----NG-----

THERMOSTAT VENT THROUGH ROOF BACKFLOW PREVENTER **HUMIDISTAT** STRAINER BALL VALVE BALL VALVE CHECK VALVE ———— CHECK VALVE GATE VALVE BUTTERFLY VALVE PLUG VALVE BALANCING VALVE

TRIPLE DUTY/STOP-CHECK VALVE ELECTRICALLY ACTIVATED VALVE PRESSURE REDUCING VALVE ELECTRICALLY ACTIVATED VALVE ——PRESSURE REDUCING VALVE —————— FLOW CONTROL VALVE PRESSURE RELIEF VALVE COOLING TOWER HAT/BALANCE VALVE WATER METER

> EXPANSION JOINT PRESSURE INDICATOR ANCHOR PETE'S PLUG FLOW ARROW MANUAL AIR VENT PIPE REDUCTION WATER HAMMER ARRESTOR

ELBOW DOWN TEMPERATURE INDICATOR ELBOW UP PRESSURE INDICATOR FLEXIBLE PIPE CONNECTION PETE'S PLUG SUCTION DIFFUSER VACUUM RELIEF VALVE STRAINER C+-- ELBOW DOWN

- EQUIPMENT TYPE O+--- TEE UP - EQUIPMENT ID FLEXIBLE PIPE CONNECTION TERMINAL DEVICE ID PLUMBING FIXTURE TAG DRN01 NECK SIZE DESIGN AIRFLOW (CFM) -DETAIL NUMBER

MECHANICAL NOTE DETAIL TAG CONNECT TO EXISTING -SHEET DETAIL IS ON LIMIT OF DEMOLITION

PLUMBING NOTE CONNECT TO EXISTING

LIMIT OF DEMOLITION CONTINUATION

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No.	Description	Date
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MEP LEGENDS AND **SYMBOLS**

2023-019 Project number 06-23-2023 Author Drawn by

MEP000

12" = 1'-0" Scale

PLAN NOTES:

WITH KITCHEN EQUIPMENT SUPPLIER.

PROVIDE 30-AMP, 208V, 2-POLE, NON-FUSIBLE DISCONNECT SWITCH IN NEMA-3R ENCLOSURE

PROVIDE 120V CONNECTION TO INTEGRAL DISCONNECT SWITCH FOR EXHAUST FAN.

FOR WALK-IN COOLER CONDENSER, INSTALL WITHIN 5-FT OF EQUIPMENT, VERIFY LOCATIONS

PLAN NOTES:

SK

EXISTING VENT THROUGH ROOF TO REMAIN. PROTECT DURING CONSTRUCTION.

PLAN NOTES: INSTALL EXHAUST FAN ON LEVEL ROOF CURB. SEE DETAIL 7M500 EXHAUST FAN DETAIL.

- PLACE CONDENSING UNIT LEVEL ON EQUIPMENT RAILS. INSTALL PER MANUFACTURER'S REQUIREMENTS. SEE DETAIL 2M500. COORDINATE WITH KITCHEN EQUIPMENT CONSULTANT AND STRUCTURAL ENGINEER.
- PROVIDE AND INSTALL REFRIGERANT PIPING SUPPORTS PER DETAIL 3M500. ROUTE REFRIGERANT PIPING DOWN TO ASSOCIATED EVAPORATOR COIL. CONTRACTOR SHALL FIELD DETERMINE BEST ROUTING. SEE DETAIL 4M500 FOR TYPICAL REFRIGERANT PIPE PENETRATION DETAIL.

GENERAL NOTES

1. DRAWINGS ARE DIAGRAMMATIC ONLY AND REPRESENT GENERAL SCOPE OF WORK. CONTRACTOR IS RESPONSIBLE TO REVIEW GENERAL CONSTRUCTION DRAWINGS, ARCHITECTURAL, CIVIL, STRUCTURAL, MECHANICAL, ELECTRICAL AND PLUMBING DRAWINGS AND ASSOCIATED SPECIFICATIONS FOR ADDITIONAL REQUIREMENTS THAT MAY NOT BE SPECIFICALLY CALLED OUT IN THIS PORTION OF CONSTRUCTION, NOTIFY ARCHITECT OF ANY CONFLICT OR DISCREPANCIES PRIOR TO CONSTRUCTION.

COORDINATE WITH JOIST LOCATIONS BEFORE CREATING NEW PENETRATIONS IN ROOF. PROVIDE 2. STRUCTURAL FRAMING AROUND ALL NEW ROOF PENETRATIONS PER STRUCTURAL.

CONTRACTOR SHALL ENSURE ALL INTAKES ON ROOFTOP UNITS AND MAKE-UP AIR UNITS ARE A MINIMUM OF 10'-0" AWAY FROM EXHAUST FANS AND PLUMBING VENTS.


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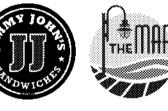
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WILMINGTON INTERNATIONAL AIRPORT 1740 AIRPORT BLVD, WILMINGTON, NC, 28405 BOARDING LEVEL, ZONE 1 SPACE: A, B, AND C


No.	Description	Date
1	60% SUBMITTAL	06/23/2023

MEP ROOF PLAN

2023-019 Project number 06-23-2023 Drawn by

MEP100

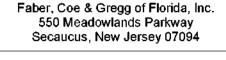1/4" = 1'-0"

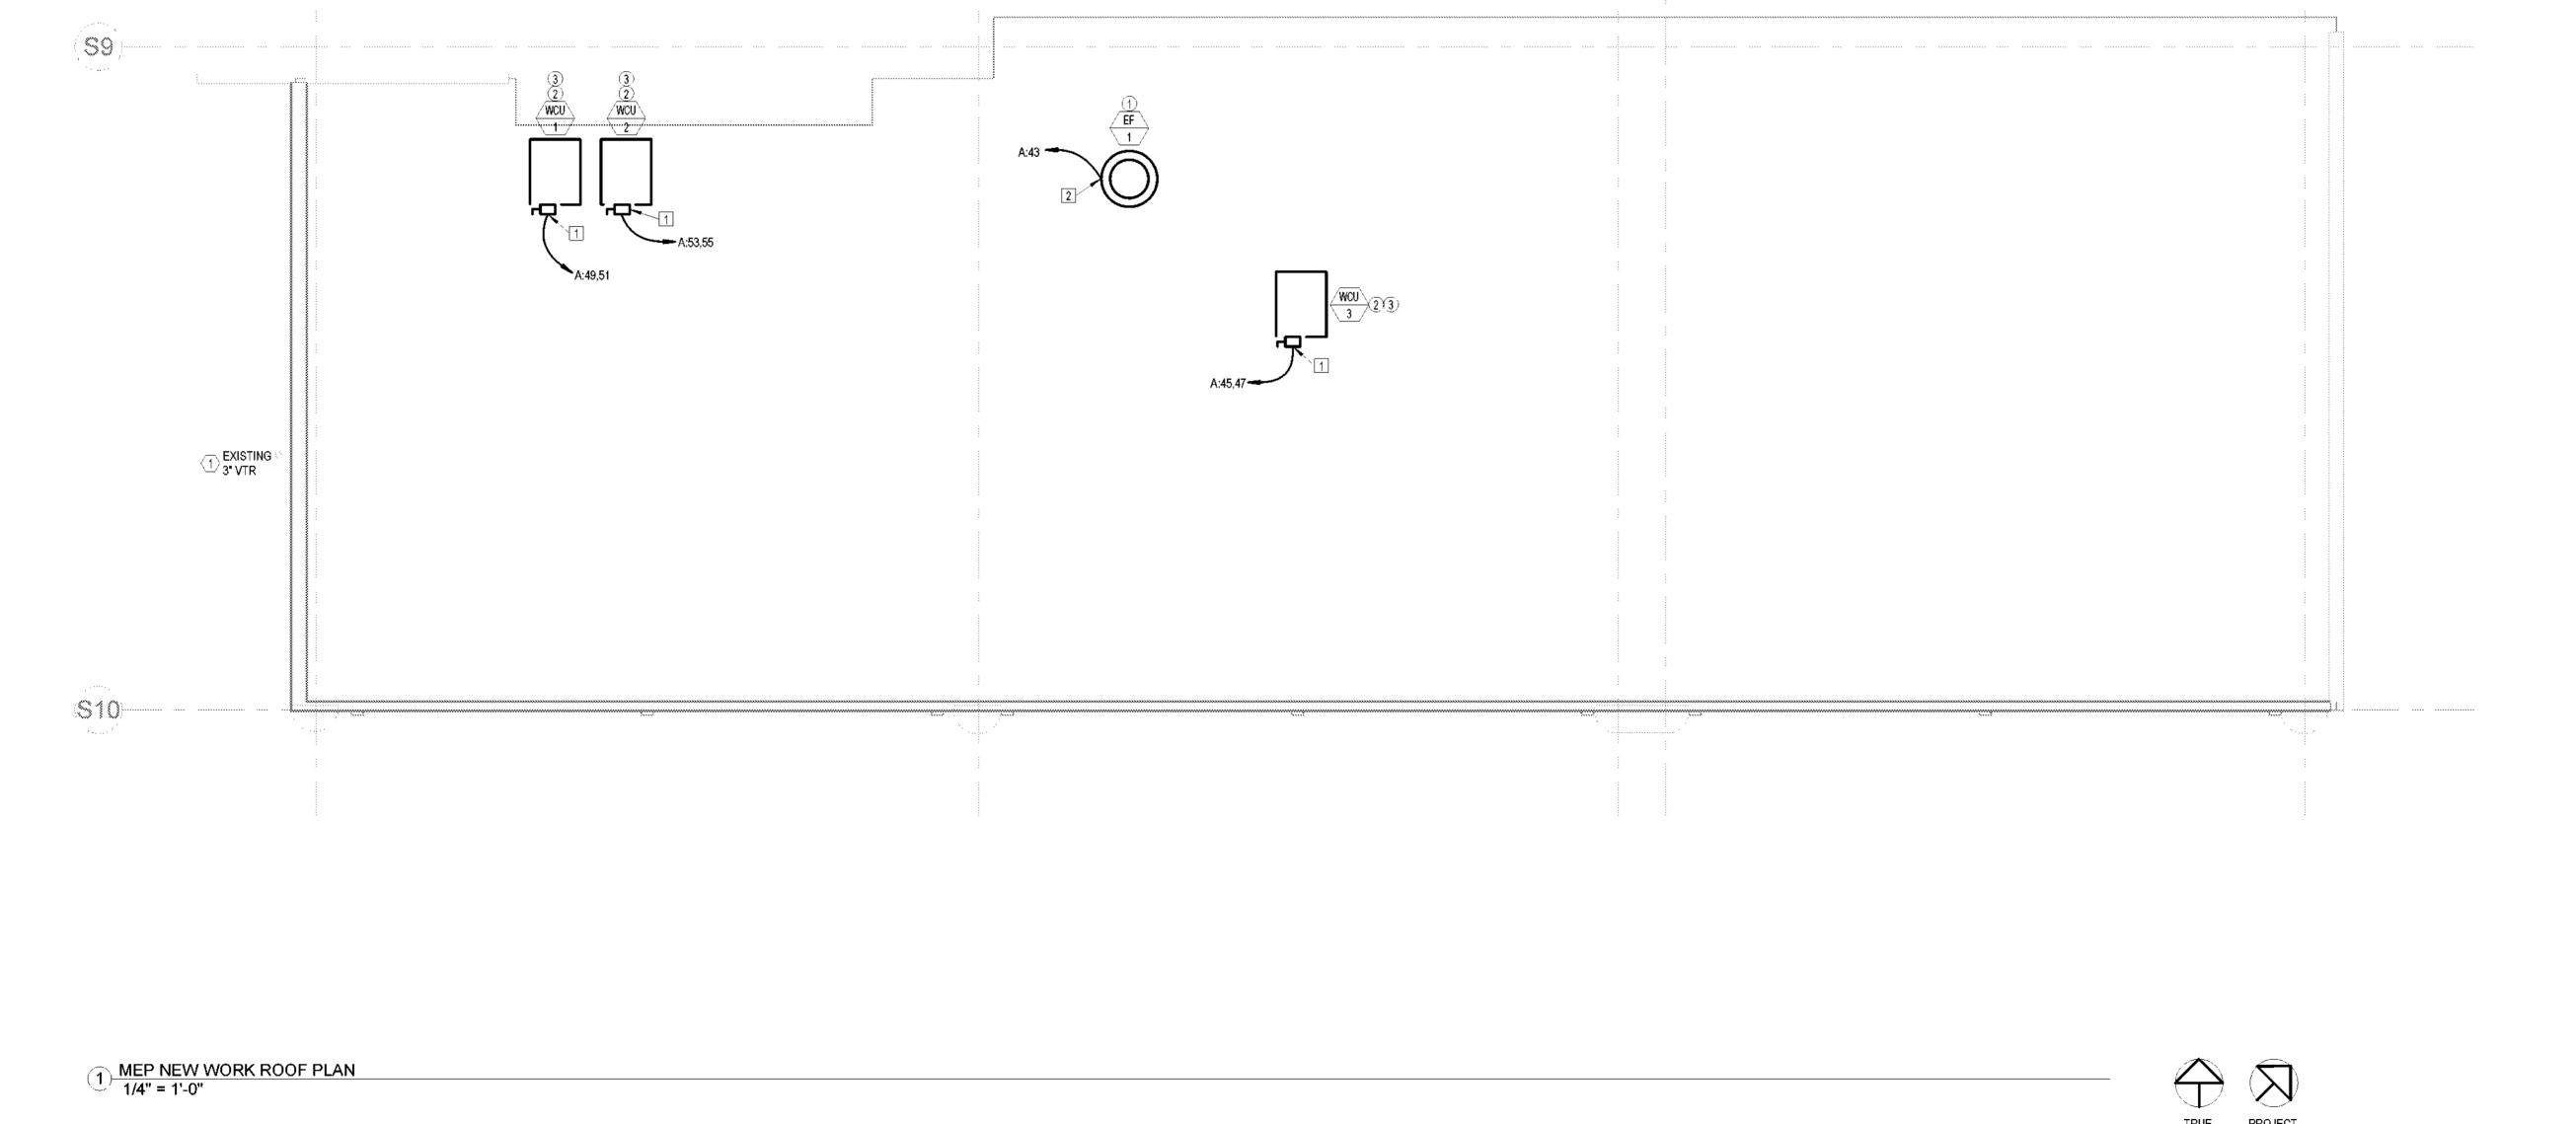


GENERAL NOTES


- 1. DRAWINGS ARE DIAGRAMMATIC ONLY AND REPRESENT GENERAL SCOPE OF WORK. CONTRACTOR IS RESPONSIBLE TO REVIEW GENERAL CONSTRUCTION DRAWINGS, ARCHITECTURAL, CIVIL, STRUCTURAL, MECHANICAL, ELECTRICAL AND PLUMBING DRAWINGS AND ASSOCIATED SPECIFICATIONS FOR ADDITIONAL REQUIREMENTS THAT MAY NOT BE SPECIFICALLY CALLED OUT IN THIS PORTION OF CONSTRUCTION. NOTIFY ARCHITECT OF ANY CONFLICT OR DISCREPANCIES PRIOR TO CONSTRUCTION.
- REFER TO ARCHITECTURAL REFLECTED CEILING PLAN FOR EXACT LIGHT FIXTURE LOCATIONS, 2. DIMENSIONS, AND HEIGHTS.
- ALL EXIT SIGNS AND EMERGENCY FIXTURES SHALL BE CONNECTED TO THE UN-SWITCHED "HOT" 3. LEG OF LIGHTING CIRCUIT.

PLAN NOTES:

- EXISTING LIGHT FIXTURE/CONTROLS TO REMAIN. MAINTAIN EXISTING BRANCH CIRCUITRY AND CIRCUIT BREAKER(S).
- CONNECT LIGHT FIXTURE TO UNSWITCHED CIRCUIT.
- PROVIDE DUAL-TECHNOLOGY, CEILING-MOUNTED OCCUPANCY SENSOR TO CONTROL FIXTURES IN THE REMOTE STORAGE SPACE.

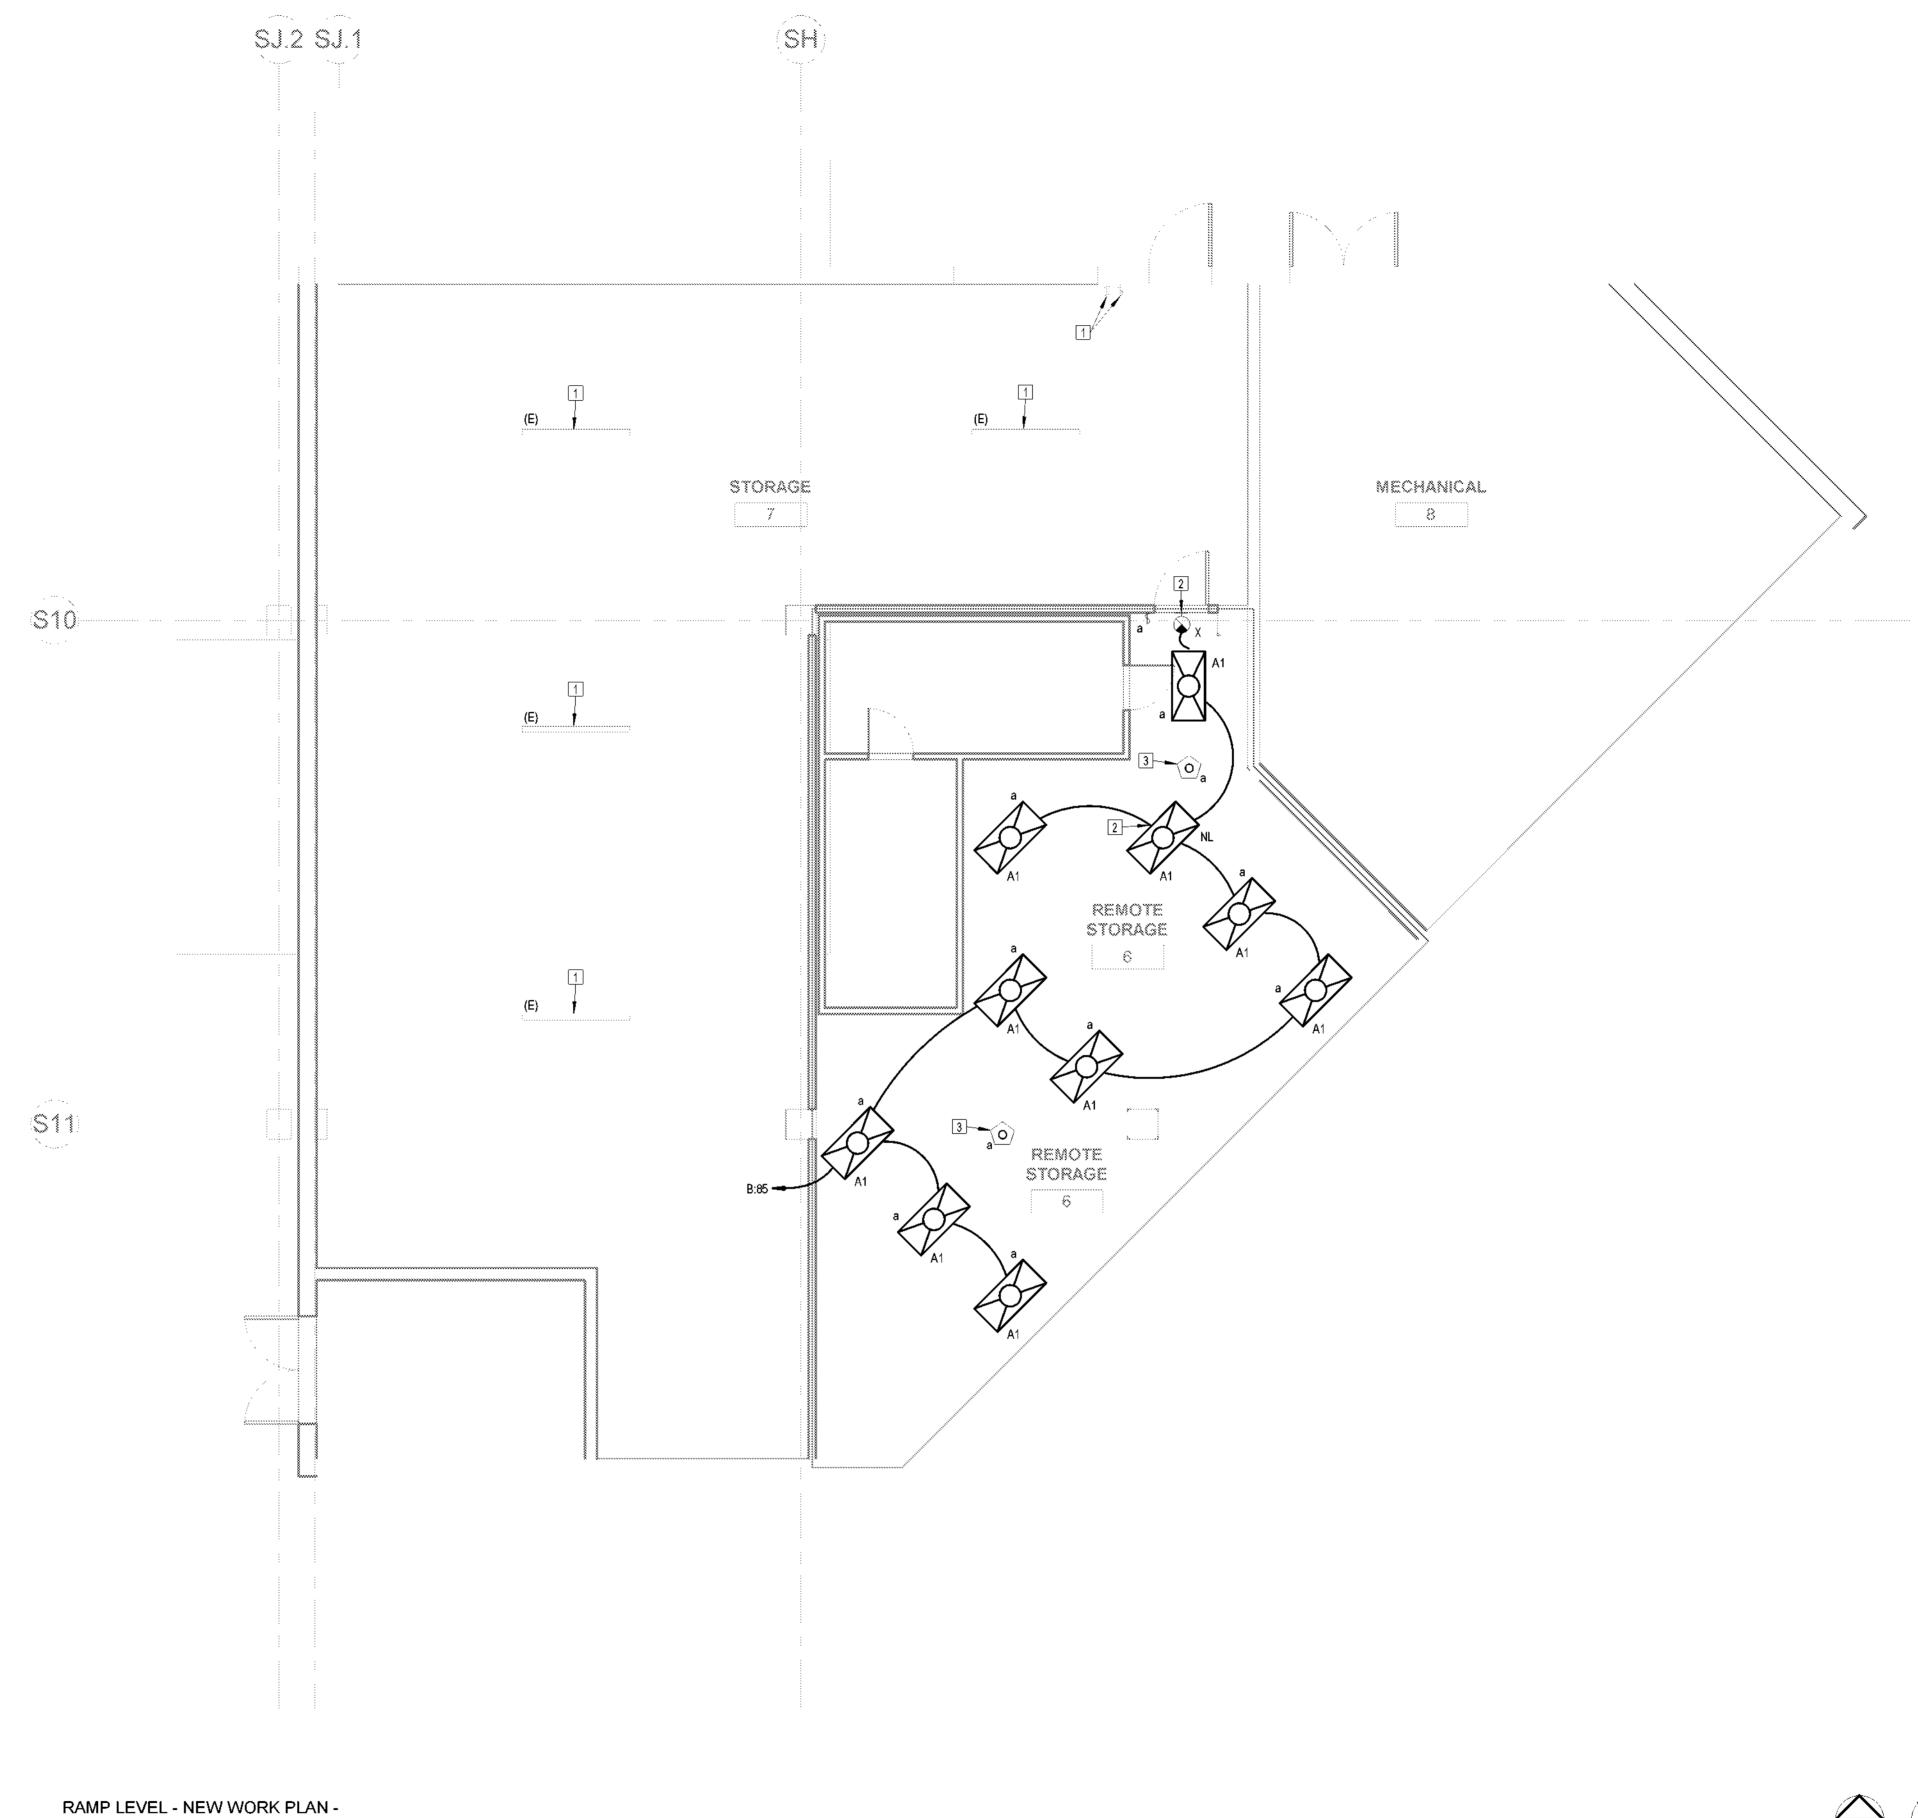

1 LIGHTING 3/16" = 1'-0"

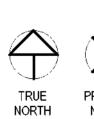



LIGHTING FLOOR PLAN -RAMP LEVEL

WILMINGTON INTERNATIONAL AIRPORT 1740 AIRPORT BLVD, WILMINGTON, NC, 28405 **BOARDING LEVEL, ZONE 1** SPACE: A, B, AND C

06/23/2023

60% SUBMITTAL

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Overland Park, KS 66212

2023-019 Project number 06-23-2023 Drawn by Checker

EL100

As indicated

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PLAN NOTES:

- #
- EXISTING LIGHT FIXTURE TO REMAIN. INTERCEPT BRANCH CIRCUITRY AND RECIRCUIT VIA NEW TENANT PANEL AS NOTED.
- 2. CIRCUIT NOTED SWITCH LEGS IN BRANCH CIRCUIT THROUGH LIGHTING CONTROL PANEL FOR AUTOMATIC ON/OFF CONTROL OF LIGHTING DURING BUSINESS HOURS.
- CONNECT LIGHT FIXTURE TO UNSWITCHED CIRCUIT.
- 4. SEE LIGHTING CONTROL PANEL SCHEDULE ON SHEET E601 FOR ADDITIONAL INFORMATION.

GENERAL NOTES

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 3. LEG OF LIGHTING CIRCUIT.

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No.	Description	Date
1	60% SUBMITTAL	06/23/2023

LIGHTING FLOOR PLAN - BOARDING LEVEL

Project number 2023-019


Date 06-23-2023

Drawn by Author

Checked by Checker


EL101

Scale 1/4" = 1'-0"

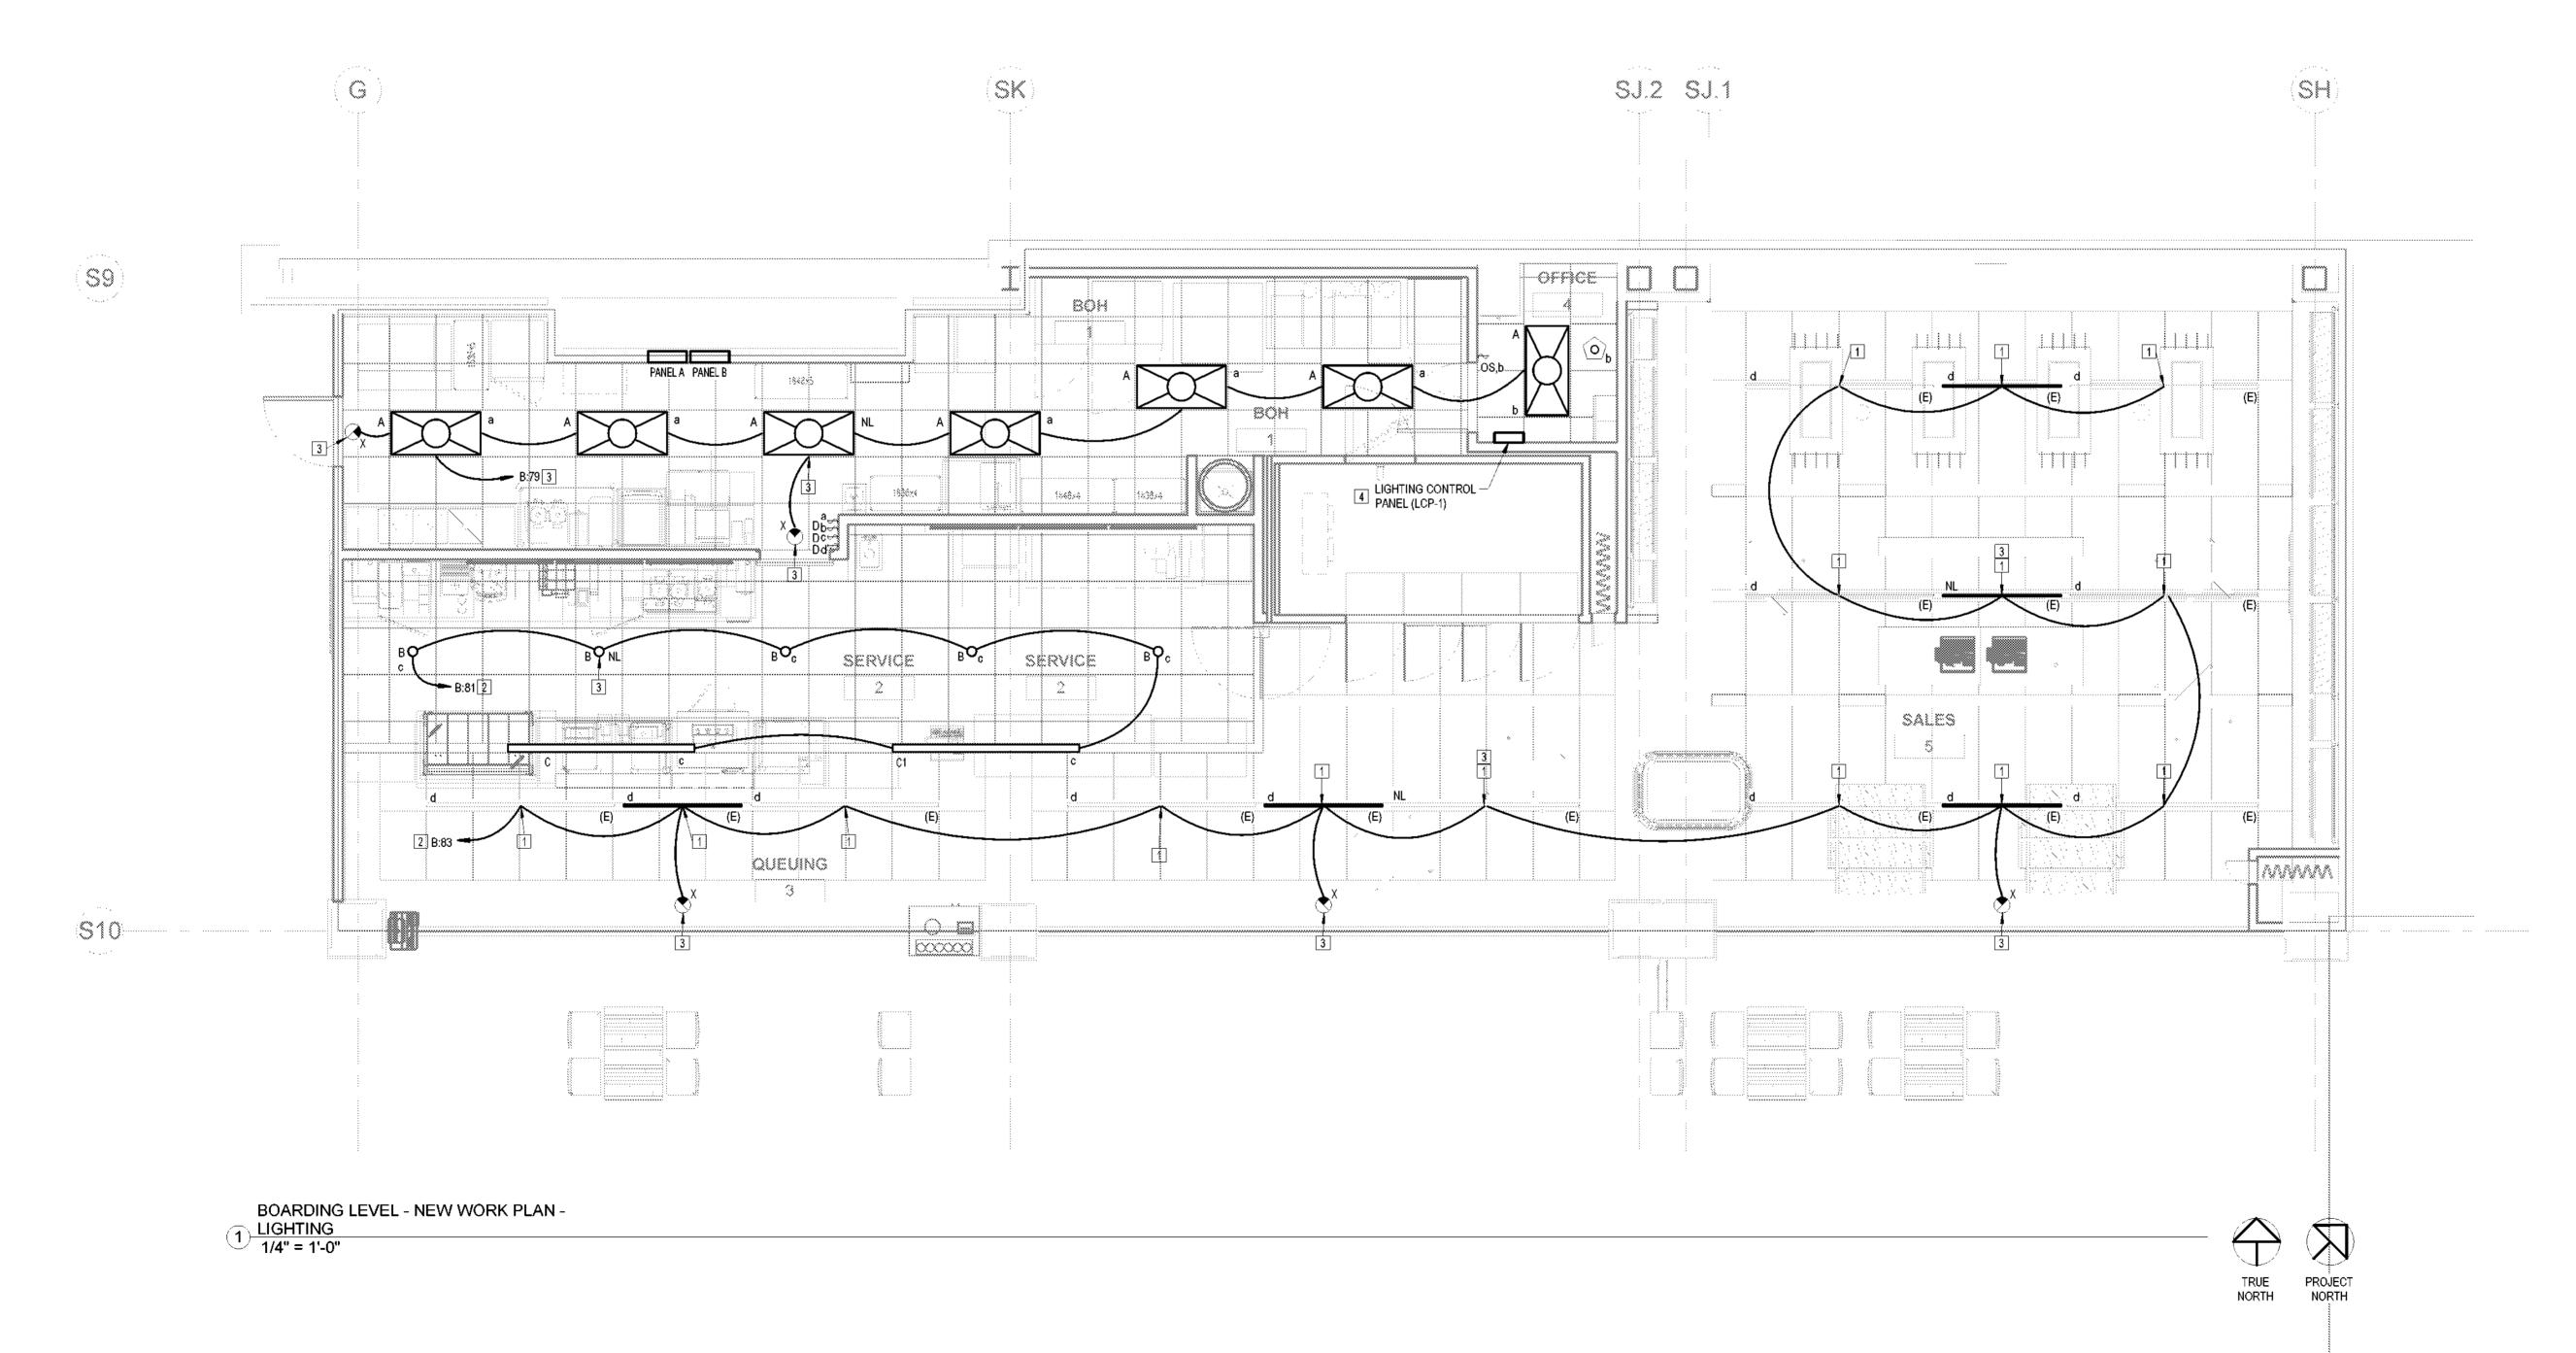

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DUNKIN DONUTS EQUIPMENT SCHEDULE (BY OTHERS)

No Equipment Category D36 CONDIMENT COUNTER DAS HAND SINK D50B (TRAGH RECEPTAGLE D026 BAKERY CASE

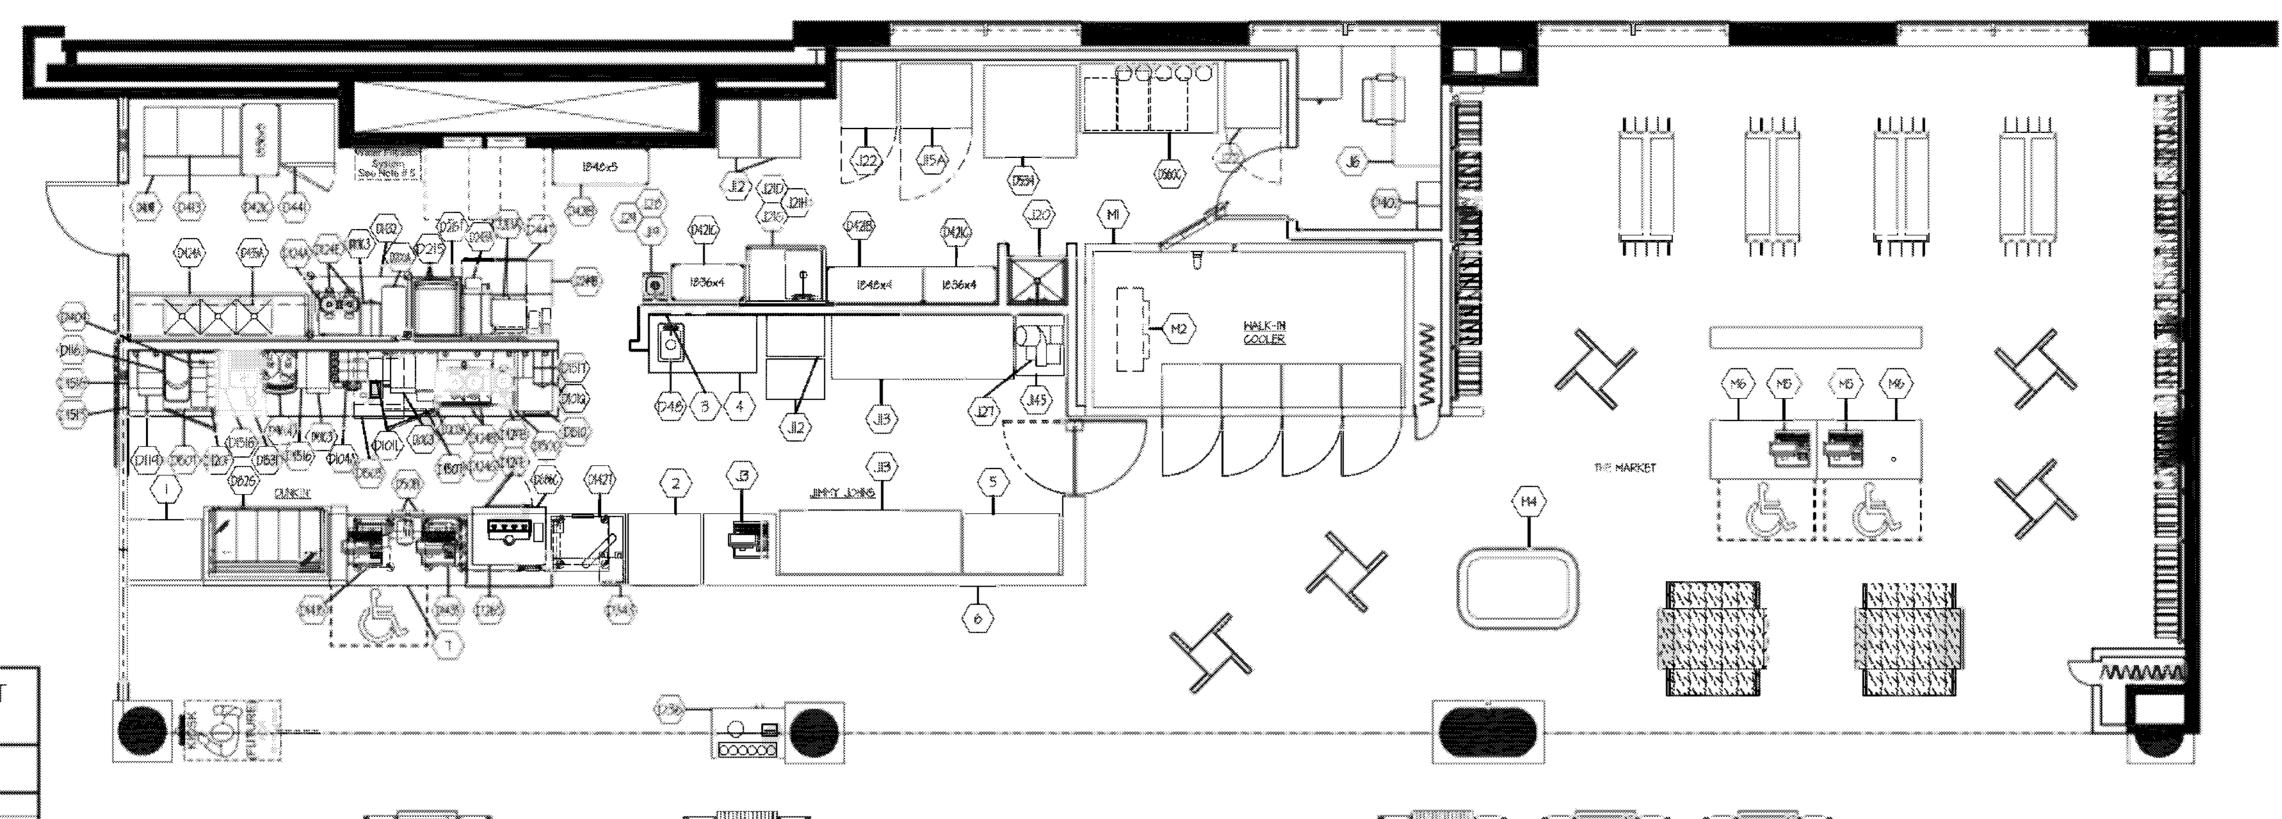D464 ESPRESSO CAPPUCCINO MACHINE DIDIC FICREAM DISPUSER DIGIL SHEETHER DISPENSER

DIOIQ COFFEE GRINDER DIO4A FUMP STATION

DIG I FROZEN BEVERAGE DISPENSER DIM DOT CHOCOLATE DISPENSER DIZOF INCERCOUNTER REPRISERATOR

DOMA DOBLE COPPLE BREIGH DIZ46 THERMAL SERVER

DI24E COFFEE BREVER

DI246 BEVERAGE DISPENSER STAND D200MICED COFFEE BRENER

0202A SUBJER SERVE COPPEE / TEA BREWIR D213A MODULAR HOLDING CABINETS

DZIS RAPID GOOK OVEN

D2151 CART

D243A TOASTER

D249B EXFEDITE TABLE D265 4 TAP BEVERAGE DISPENSER

DB48 PICK UP COUNTER

D402 LOCKERS

D409P KE BIN D413 OE MAKER W/WATER FILTER

D42IA STORAGE SIELVIKS

D428B STORAGE SHELVING D42K STORAGE SHELVING

D421. STORAGE SHELVING

D424A (3) COMPARTMENT SINK D435A WALL SHELVING

D44 REACH IN REFRIGERATOR

D447 ASSEMBLY STATION W/ OVERSHELF

DEBA IVENTLESS CONVECTION OVEN

DEMIA STORAGE SHELVING

D54ID STORAGE SHELYING

D54ID STORAGE SHELVING

D560C MORKTABLE W OVERSHELF

DAMOS MIXER CUP STATION DI409 JUMP & POWER RACK

DI427 ON THE GO CART DIADI JADBLE HORK TABLE

DI435 MOBILE CART

DISCO COFFEE TABLE


DISCO WE KE BIN DISCUI \$15 TOP REFRIGERATOR


DISIO TRASH / CONTOST

DISIS #40BILE TABLE 056 LD 40LD**G**K

DISIT LID HOLDER

DIS31 -201P SIK

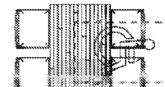

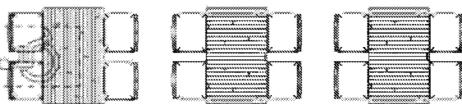

EQUIPMENT PLAN SCALE: 1/4" = 1'-0"

JIMMY JOHNS EQUIPMENT SCHEDULE Equipment Category J3 POS SYSTEM (BY OTHERS) JO DESK JI2 BREAD RACK JIB REPRIGERATED PREP TABLE JAS WORK TABLE JISA OVENEREAD PROOFER JIP HAND SINK DO MOPSHIK JOD PREPSIK JOIS PRE-RIVEE FAIKET J2IH FAIKET J22 REACH IN REFRIGERATOR

J23 WALK-IN FREEZER

J23A WALK-IN COOLER

128 TOYEL DISTRIBER

J29 SOAP DISPENSER


JZT SLICER

J231 FREEZER EVAPORATOR COIL


J232 FREEZER CONDENSING UNIT

J23A1 COOLER EVAPORATOR COIL


123A.2 COOLER CONDENSING UNIT

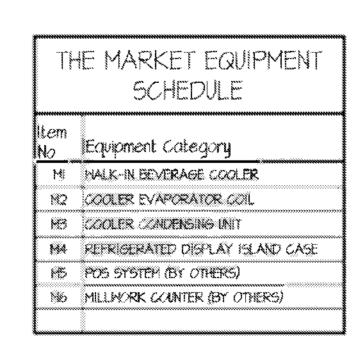

	EQUIPMENT SCHEDULE
tem Vo	Equipment Category
*	PEPSI GRAB-N-60 (BY OTHERS)
2	COKE-GRAB-N-GO (BY OTHERS)
3	SOAP I PAPER TOHEL DISPENSER (BY OTHERS)
4	S/G TADLE
5	S/S TABLE
ŕ	MILLWORK COUNTER (BY OTHERS)
7	MILLIAURK COUNTER (BY OTHERS)
:	20

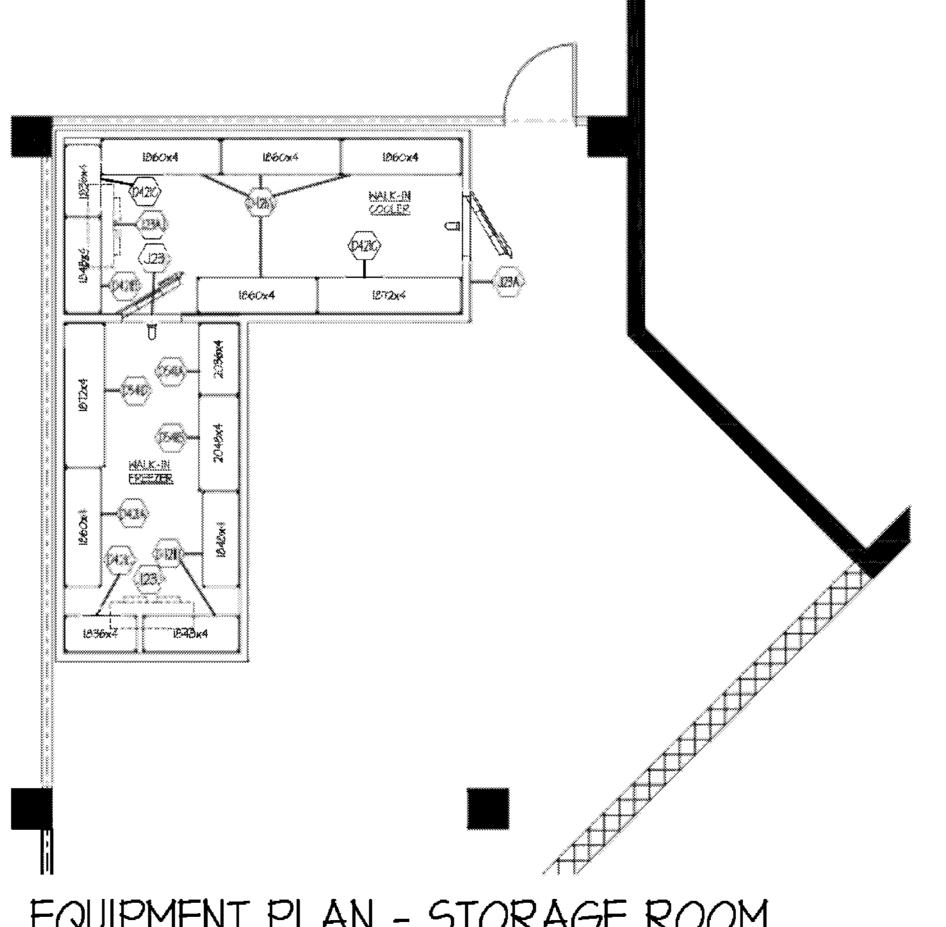

EQUIPMENT PLAN - STORAGE ROOM

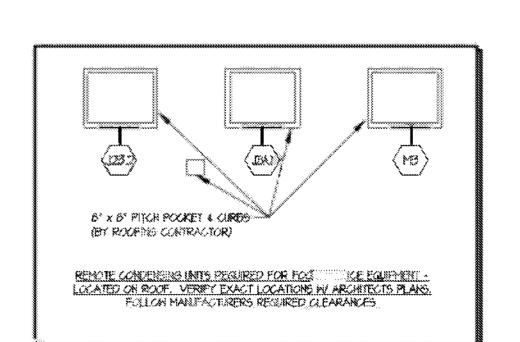


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No	Description	Date
1	60% SUBMITTAL	06/23/2023

EQUIPMENT PLAN


2023-019 Project number 03-29-2023 Drawn by Checked by

FS-1

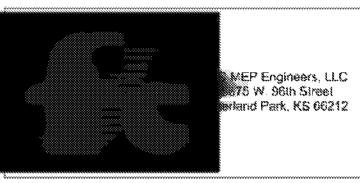Scale

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EQUIPMENT PLAN SCALE VAT = 12-0*

	PLUMBING SCHEDULE		
CONFECTION NATION	DESCRIPTION		
ğü.i	FL/XR SIK		
P-2	FLOOR DRAW		
P-3	1/2" HM, 1/2" CM, 22" AFF OCM - HAND SINK #048 # #JM & CAMP SINK #1531		
6-4	H(2" H, 24" AFF OOM - HAND SOK #DAS 1 #39		
a,	1/2" FM, 40" AFF OOM - ESPRESSO MACHINE 496.4, FROZEN BEVERAGE DISPENSER \$16.1, HOT CHXCOLATE DISPENSER \$19, DOXINE COFFEE FRENER \$124A		
	COFFEE BREVER #1240, ICEO COFFEE BREVER #0200A, & SINGLE SERVE COFFEE / TEA BREVER #0202		
P∗€	1/2° FFL 72° AFF OOM - KE MAKER \$0423		
F-7	V2" FM, V2" CM, V0" AFF CCM - THREE CCMPARTMENT SINK #D424A 4 FREP SINK FAIKET #L266		
p.g.	V2" HM, V2" CM, 3%" AFF OOM (P.C. TO LEAVE SINK ELLS IN WALL) - HOP SINK #LIZO		
pap	S' H, A' AFF SU - MOP SINK RECO		
6-10	314" CIL, 102" AFF CON, 19:6. TO PIPE CHIECONE FINITO EQUIPMENT SHOWY - MATER FILTRATION SYSTEM		

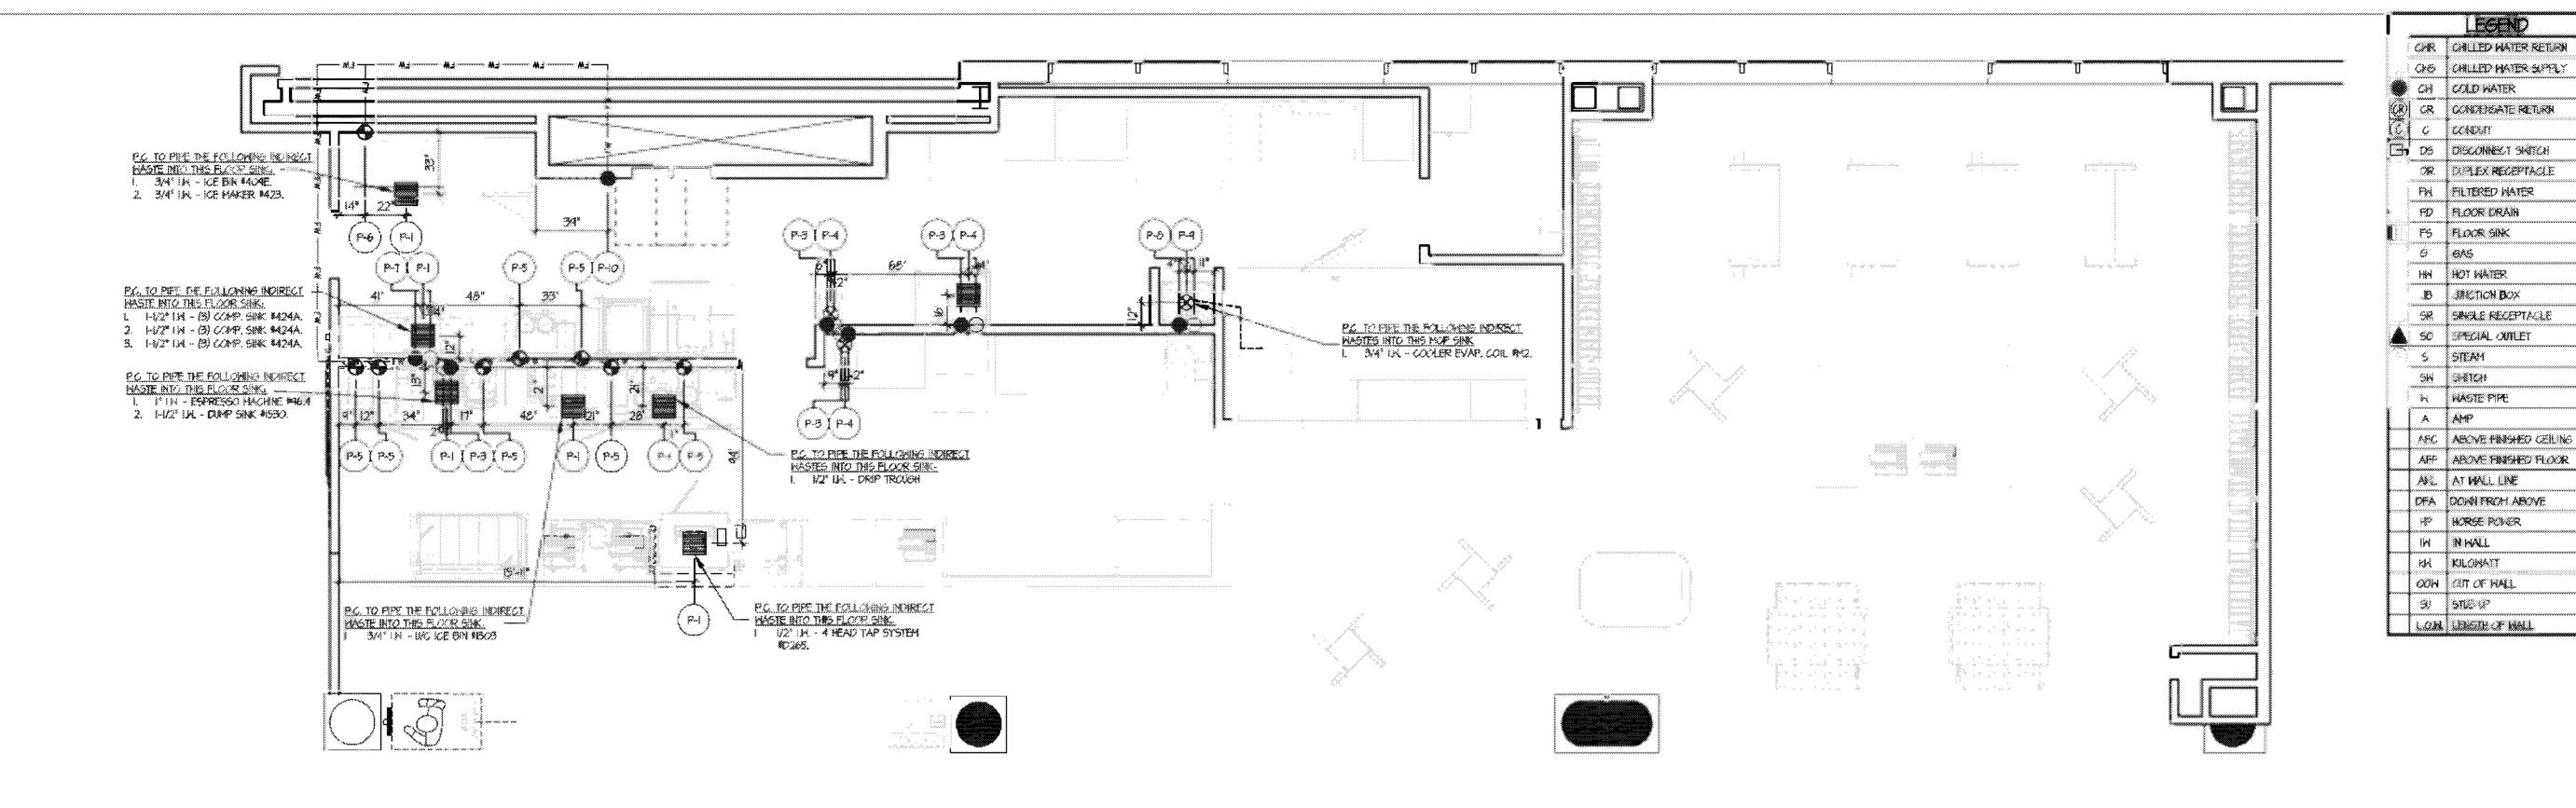PLUMBING NOTES

LALL CUTLETS AND CONFECTIONS SHOWN ON THIS DRAWING RELATE TO FOCUSERVICE EQUIPMENT ONLY. FOR ANY ADDITIONAL PLUMBING REQUIREMENTS, REFER TO ARCH / ENS. DRAMINGS.

2, THIS FLASSING ROUGH-IN CRANING IS INTENDED TO SHOW ALL ROUGH-IN LOCATIONS AND HEISHITS, CONSECTION SIZES, AND LOAD REGUIRE-1875 ALL DIMENSIONS ARE SHOWN FROM THE FINISHED FLOOR AND FINISHED WALLS. ALL HALL LOCATIONS SHOULD BE VERIFIED WITH ARCHITECTURAL DRAWNOS.

3. ALL FINAL CONSECTIONS TO ALL EQUIPMENT SHALL BE BY THE PROFESSION OF COLORS OF ALL REDIFFED MATERIAL (STOPS, VALVES, FILTERS, TRAFS, CHECK VALVES, PIPME, TUSSIO, ETC.) REGUIRED TO ASSURE PROFES INSTALLATION / OPERATION ACCORDING TO THE MANUFACTURERS RECONSTRUCTOR. ARD LOCAL CODES SHALL BE BY THE PLUTISHIC CONTRACTOR.

4. PLEASING CONTRACTOR SHALL BE RESPONSIBLE FOR FLANKSHING

AND INSTALLING THE FOLLOWING.

ALL NATER, WASTE, GAS, AND STEAM SERVICES TO POINT OF ROUGH-IN AS SHOWN ON THIS DRAWING. ROUGH-IN OUTLETS TO STUD OUT OF HALLS 4" AT HEIGHT INDICATED FROM FINISHED FLOOR TO CENTERLINE OF OUTLET. FLOOR ROUGH-INS TO STUD-UP 2", I'VEEDS STECTHED OTHERWISE, ABOVE FINISHED FLOOR OR CARDS. ALL FLOOR PENETRATIONS ARE TO BE STALED WATERTIGHT.

PRESSINE PETALING AND / OR REGULATING VALVES FOR
DISHMASHERS, BOOSTEP HEATERS, OR OTHERWISE NOTED IN
ALL FLOOR SINKS, CONFLETE WITH TOP GRATES INDICATED,
AND REMOVABLE SEDIMENT BICKETS ARE TO BE SET FLIGH
WITH THE FLOOR, WILESS SPECIFIED OTHERWISE OR

REGISTED BY LOCAL CODES.

ALL MASTE LINES, DIRECT OR INDIRECT, EXCEPT AS NOTED.

MINIPUM DIAMETER OF LINE SHALL BE AS INDICATED ON
PLAN RESARCALESS OF CONNECTION SIZE, AND SHALL BE
PITCHED DOMINARD. MAINTAIN DRAWLLINES AS INCH AS
POSSIBLE ABOVE FLOOR FOR SANITATION AND CLEANING.
ALL MASTE LINES SHALL HAVE ADEQUATE CLEAN-OUT
PROVISIONS.

- * INDIRECT MASTELLINES FROM MALK-IN EVAPORATOR COILS SHALL BE PITCHED % FER FOOT OF HORIZONTAL RIN AND TERMINATE WITH A P-TRAP OVER FLOOR DRAIN OR AFTROVED RECEPTOR WITH VACUM EREAK AS REGURED
- BY LOCAL CODE.

 * INSTALL FIRE CONTROL GAS SHIT-OFF VALVES AS COOKING BUILTHEN GAS COOKING BUILTHENT IS STECTIED!
- VACUM BREAKERS, AS REGERED, EXCEPT FOR
 DISH MASHERS AND DISPOSERS, BY THE KITCHEN EQUIPMENT
 CONTRACTOR:
 NEWLATION ON ALL STEAM, NOT MATER, AND CONDENSATE
- * ITEMATION ON ALL STEAM, NOT MATER, AND CONSERNATE RETURN LINES WITHIN THE FOODSERVICE AREAS SHALL BE COLOR-CODED ACCORDING TO LOCAL CODES.

 * CLEAN-OUT VALVES FOR STEAM AND CONDENSATE RETURN
- eines. * Gas frixkeps ag needed.


CENTRACTOR


5. PLIMENO CONTRACTOR, OR ESSIVALENT, SHALL INTERCONNECT DISMACHINE WITH BOOSTER NEATER AND HATER TYPE VENTILATORS WITH CONTROL PANELS AS REGIMED PER THE MARK ACTURER'S INSTRUCTIONS, WEN APPLICABLE AND NOTED.

6. ALL YEST PIPES SHALL BE CONCEALED IN WALLS OR COLUMN BHASES, USE LOOP VENTS FOR ISLAND FIXTURES.

T. ALL LINES ROUTED THROUGH EQUIPMENT SHALL NOT INTERFERE HITH INTERDED USE OF, OR SERVICING OF EXPENSENT.

8. PLIMENS CONTRACTOR TO MOUNT ALL FAIRETS AND WASTE ASSEMBLES PROVIDED BY THE FOODSERVICE EQUIPMENT

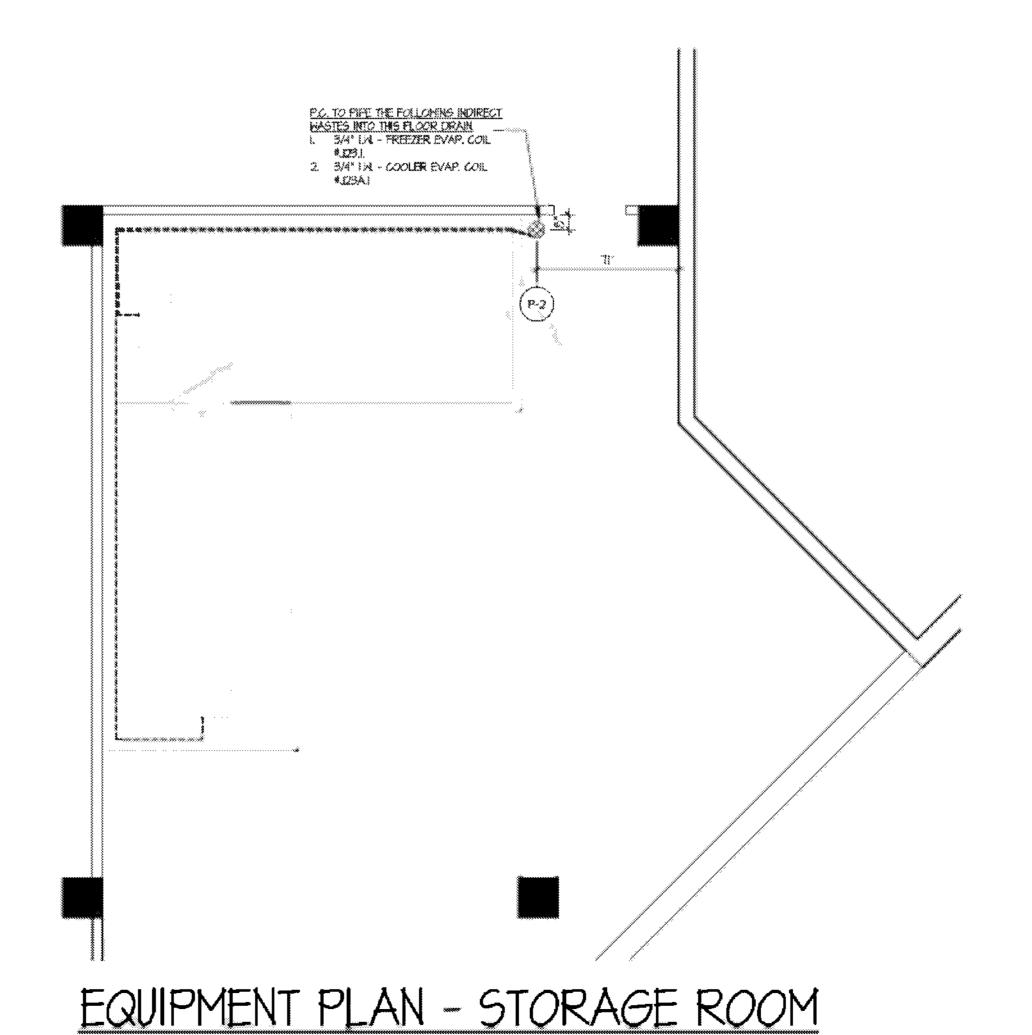

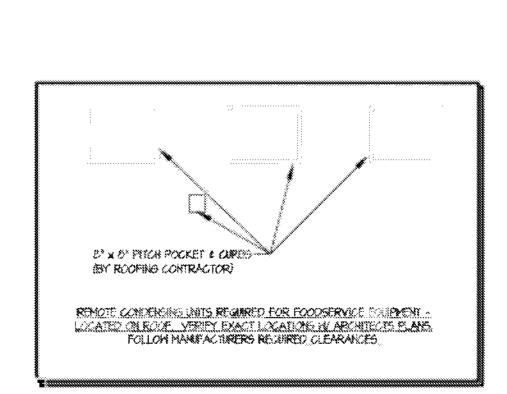


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No.	Description	Date
	60% SUBMITTAL	05/23/2023

	3	

EQUIPMENT PLUMBING ROUGH IN PLAN

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Drawn by	Ar
Checked by	RW

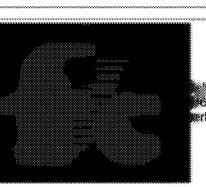
FS-2


Scale

- <u>--</u> 1/4" = 1'-0"


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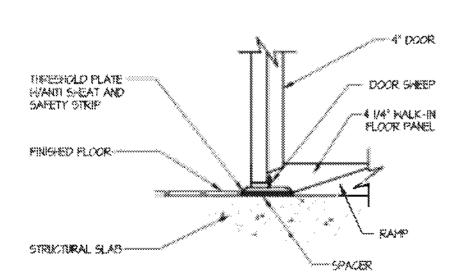




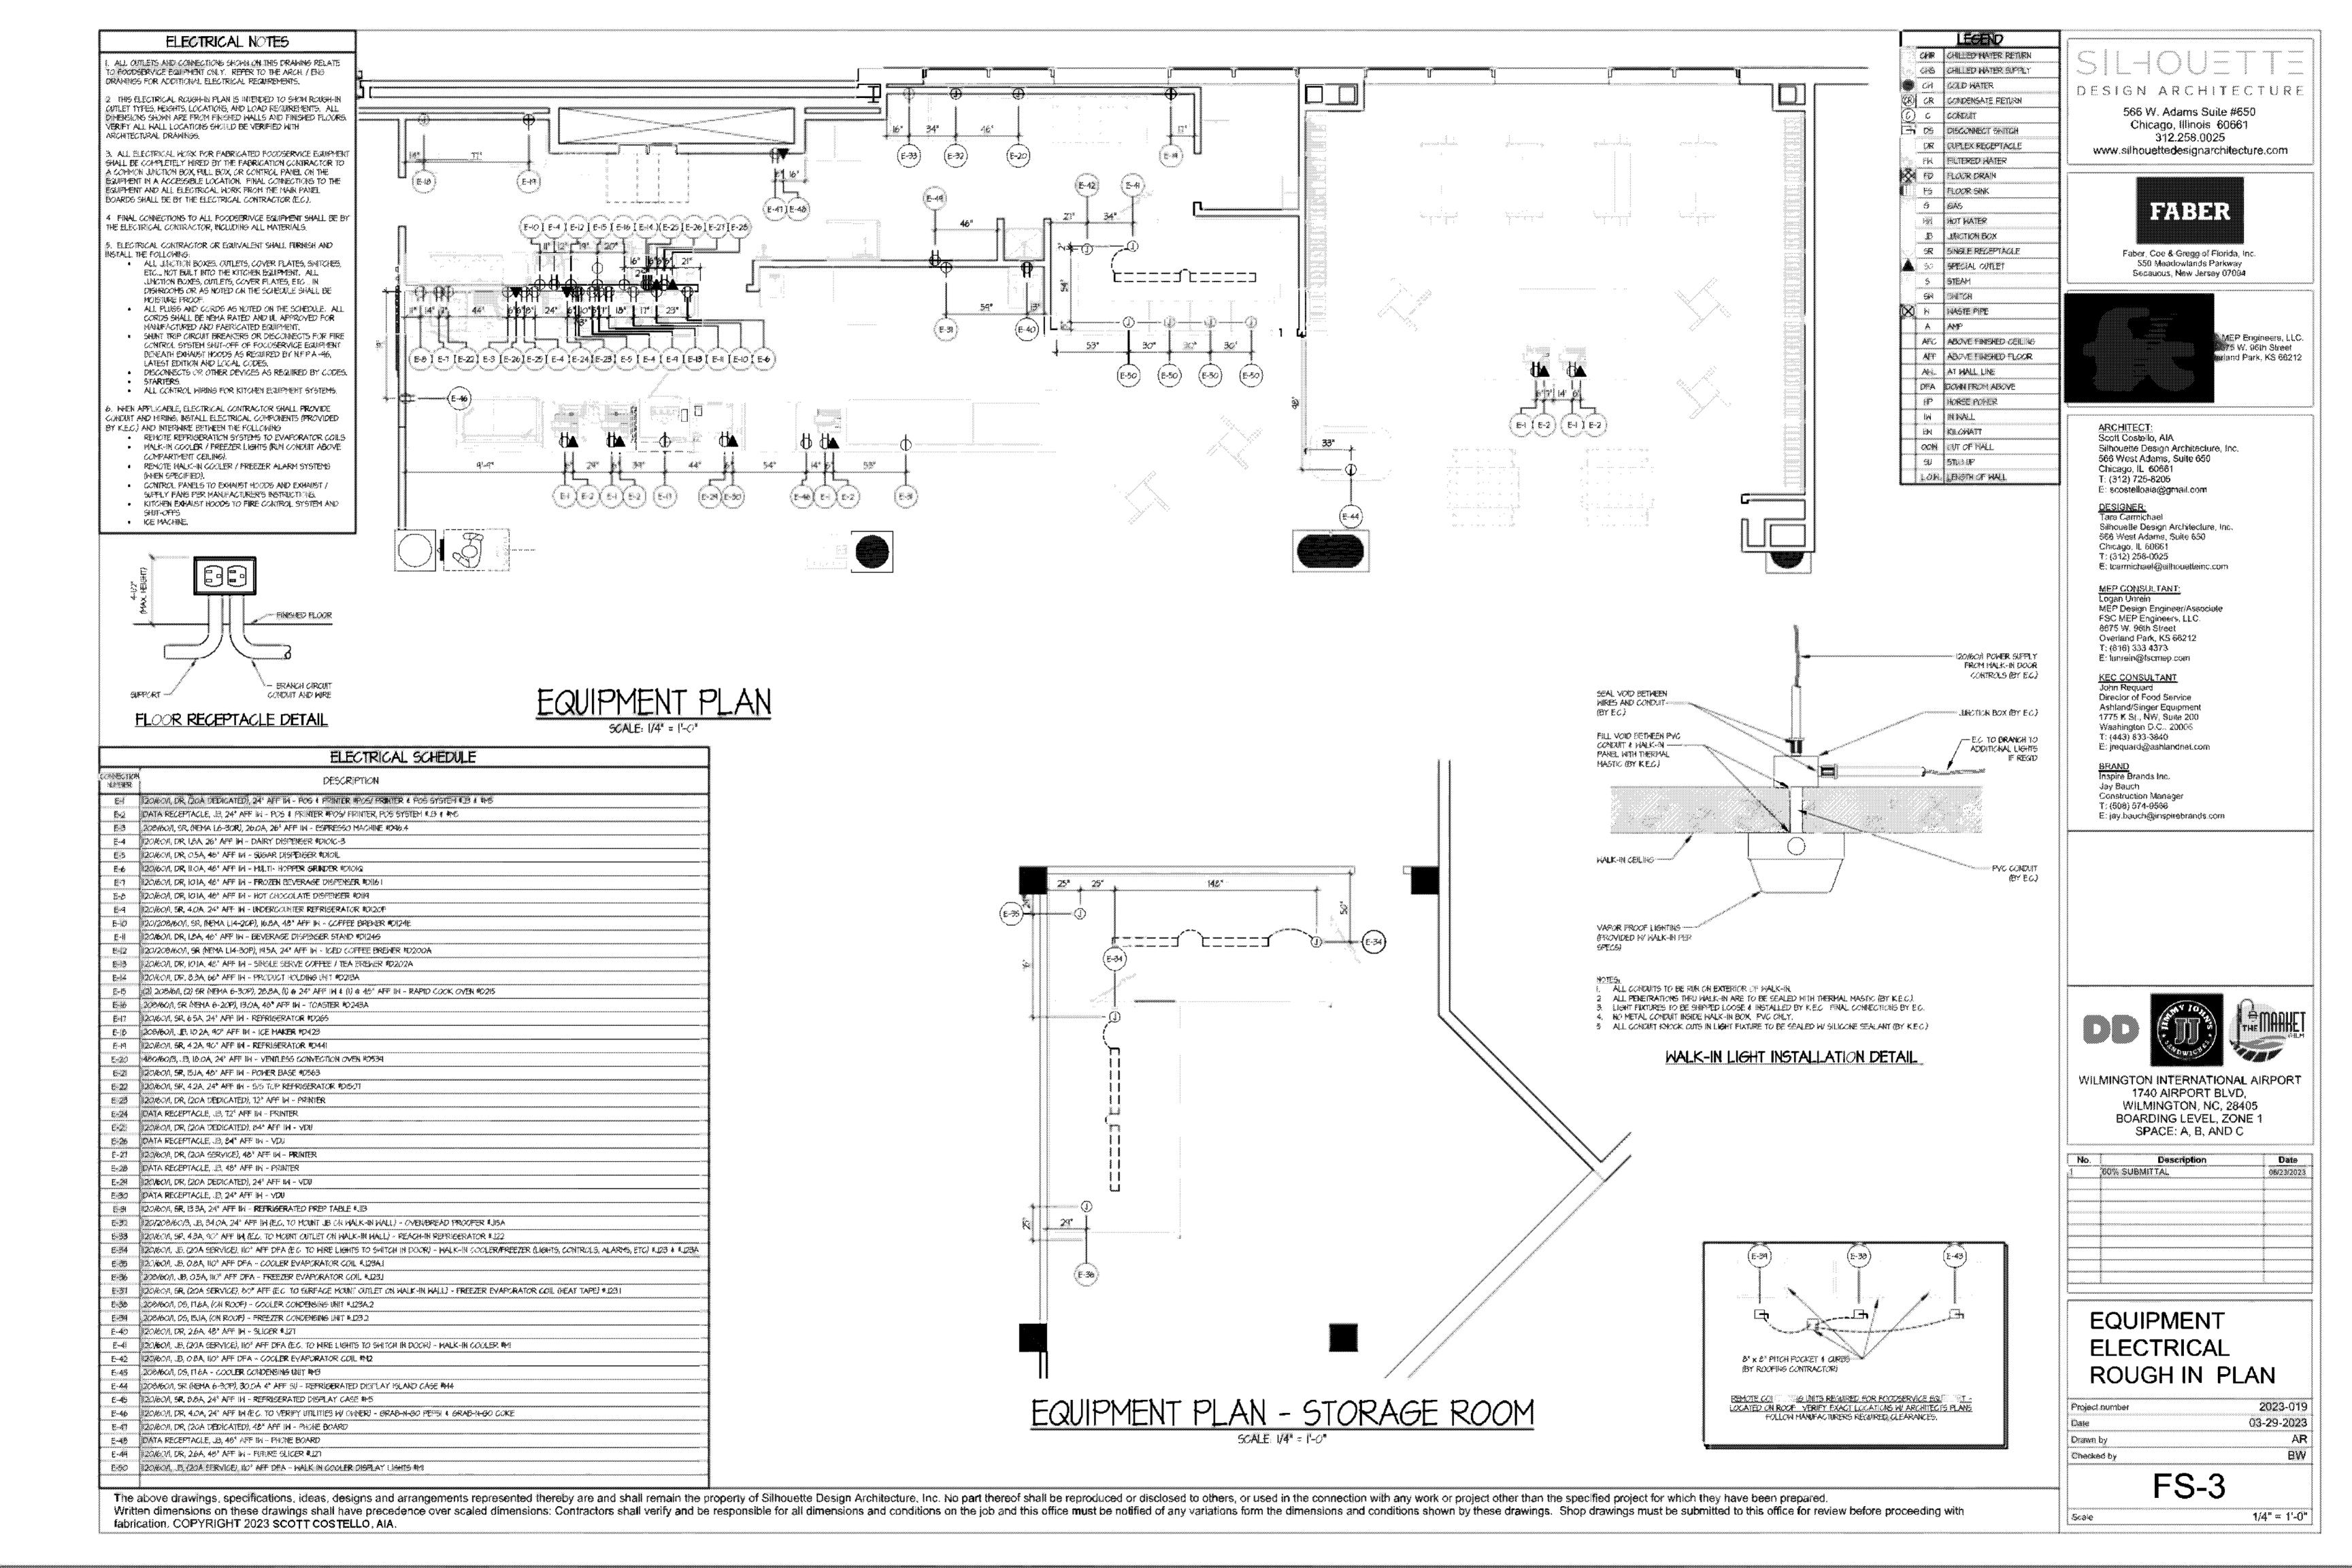


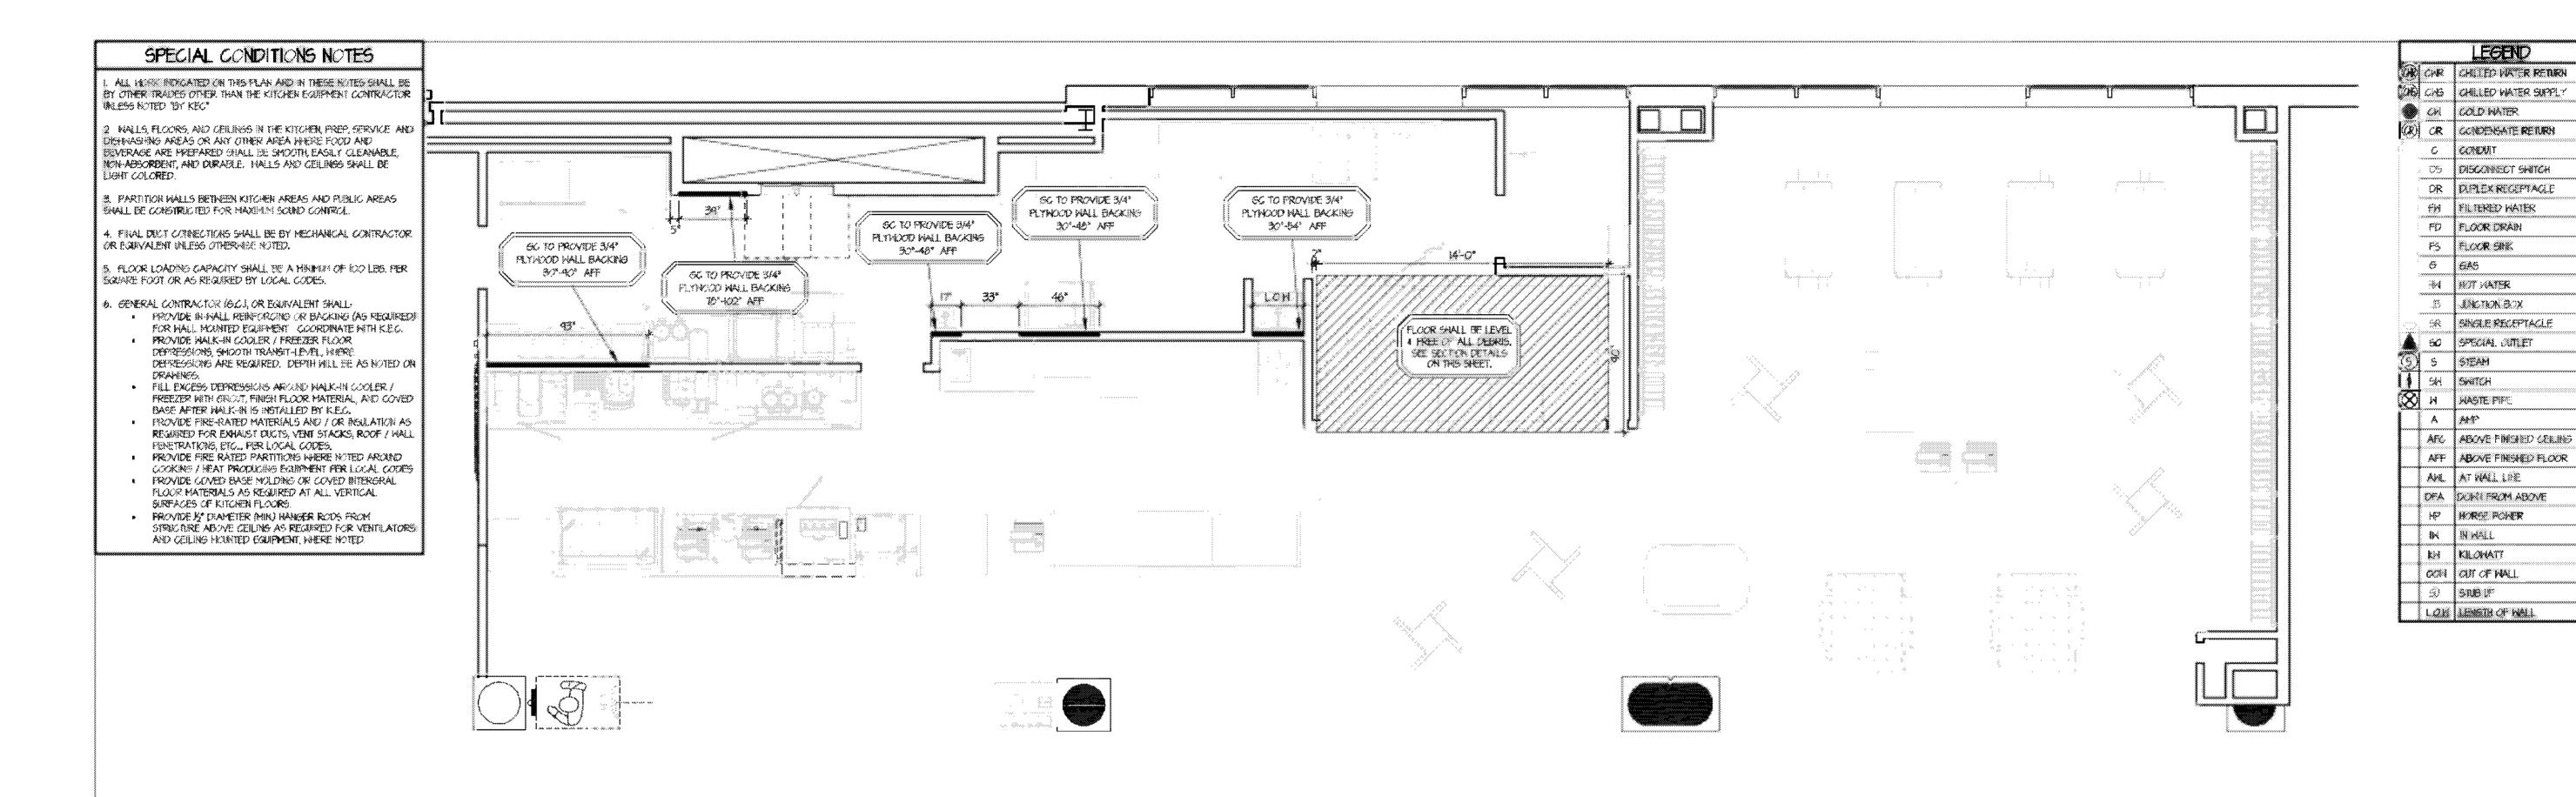


WALK-IN EXTERIOR WALL SECTION

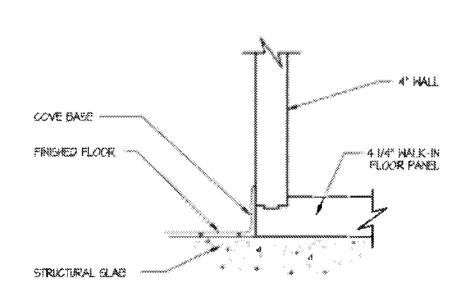

WALK-IN COOLER DOOR SECTION

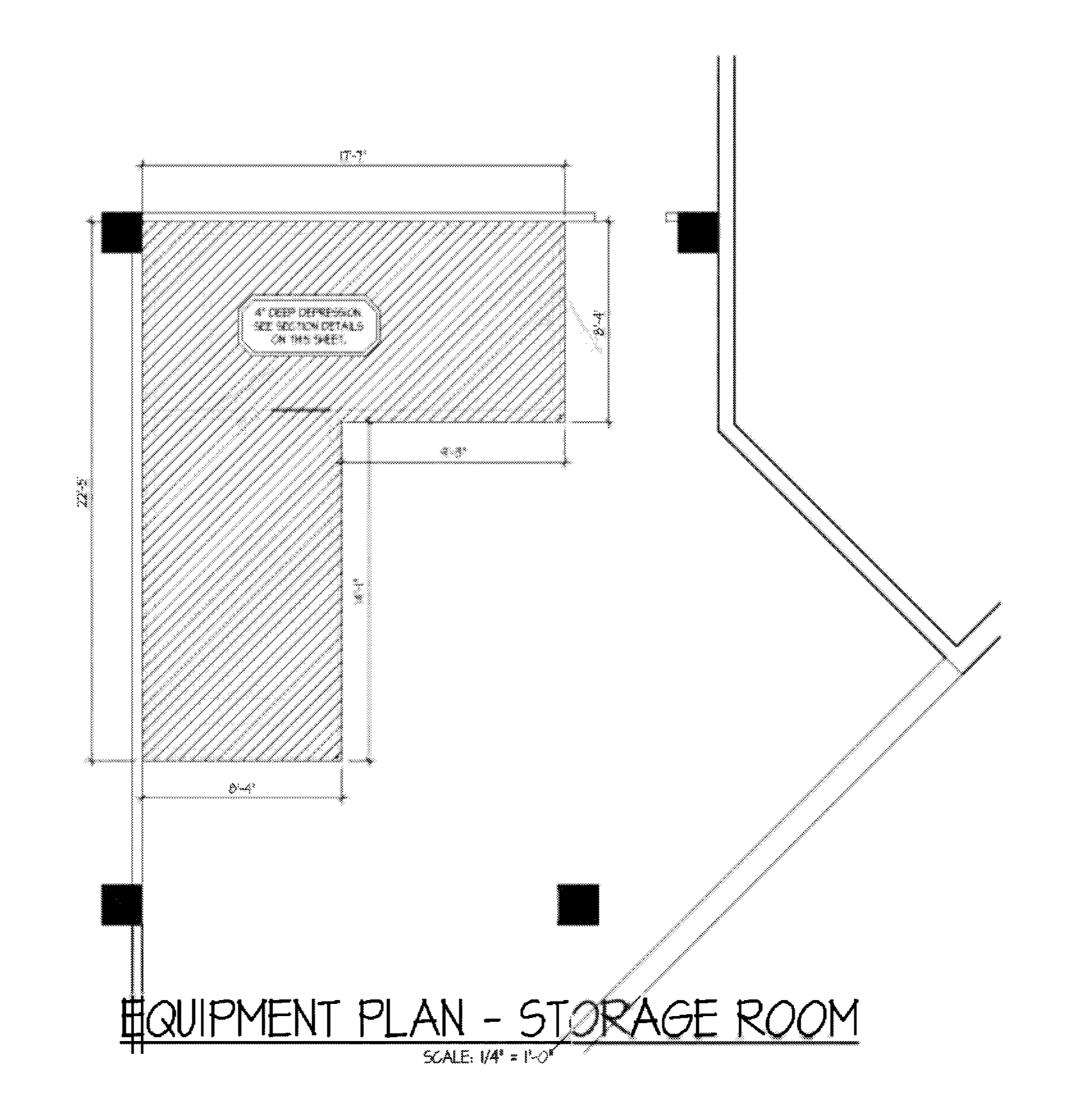

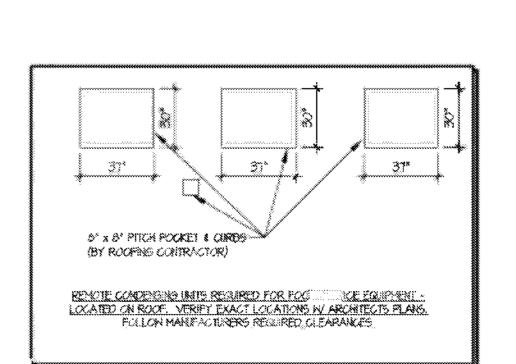


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WILMINGTON INTERNATIONAL AIRPORT 1740 AIRPORT BLVD, WILMINGTON, NC, 28405 BOARDING LEVEL, ZONE 1 SPACE: A, B, AND C

No	Description	Date
	60% SUBMITTAL	06/23/2023
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SPECIAL CONDITIONS PLAN


Project number 2023-019
Date 03-29-2023
Dyswn by AR
Checked by BW

FS-4

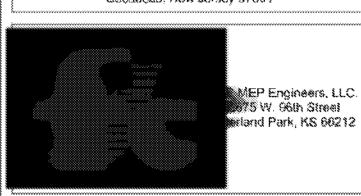Scale

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SILOUZTTZ

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WILMINGTON INTERNATIONAL AIRPORT 1740 AIRPORT BLVD, WILMINGTON, NC, 28405 BOARDING LEVEL, ZONE 1

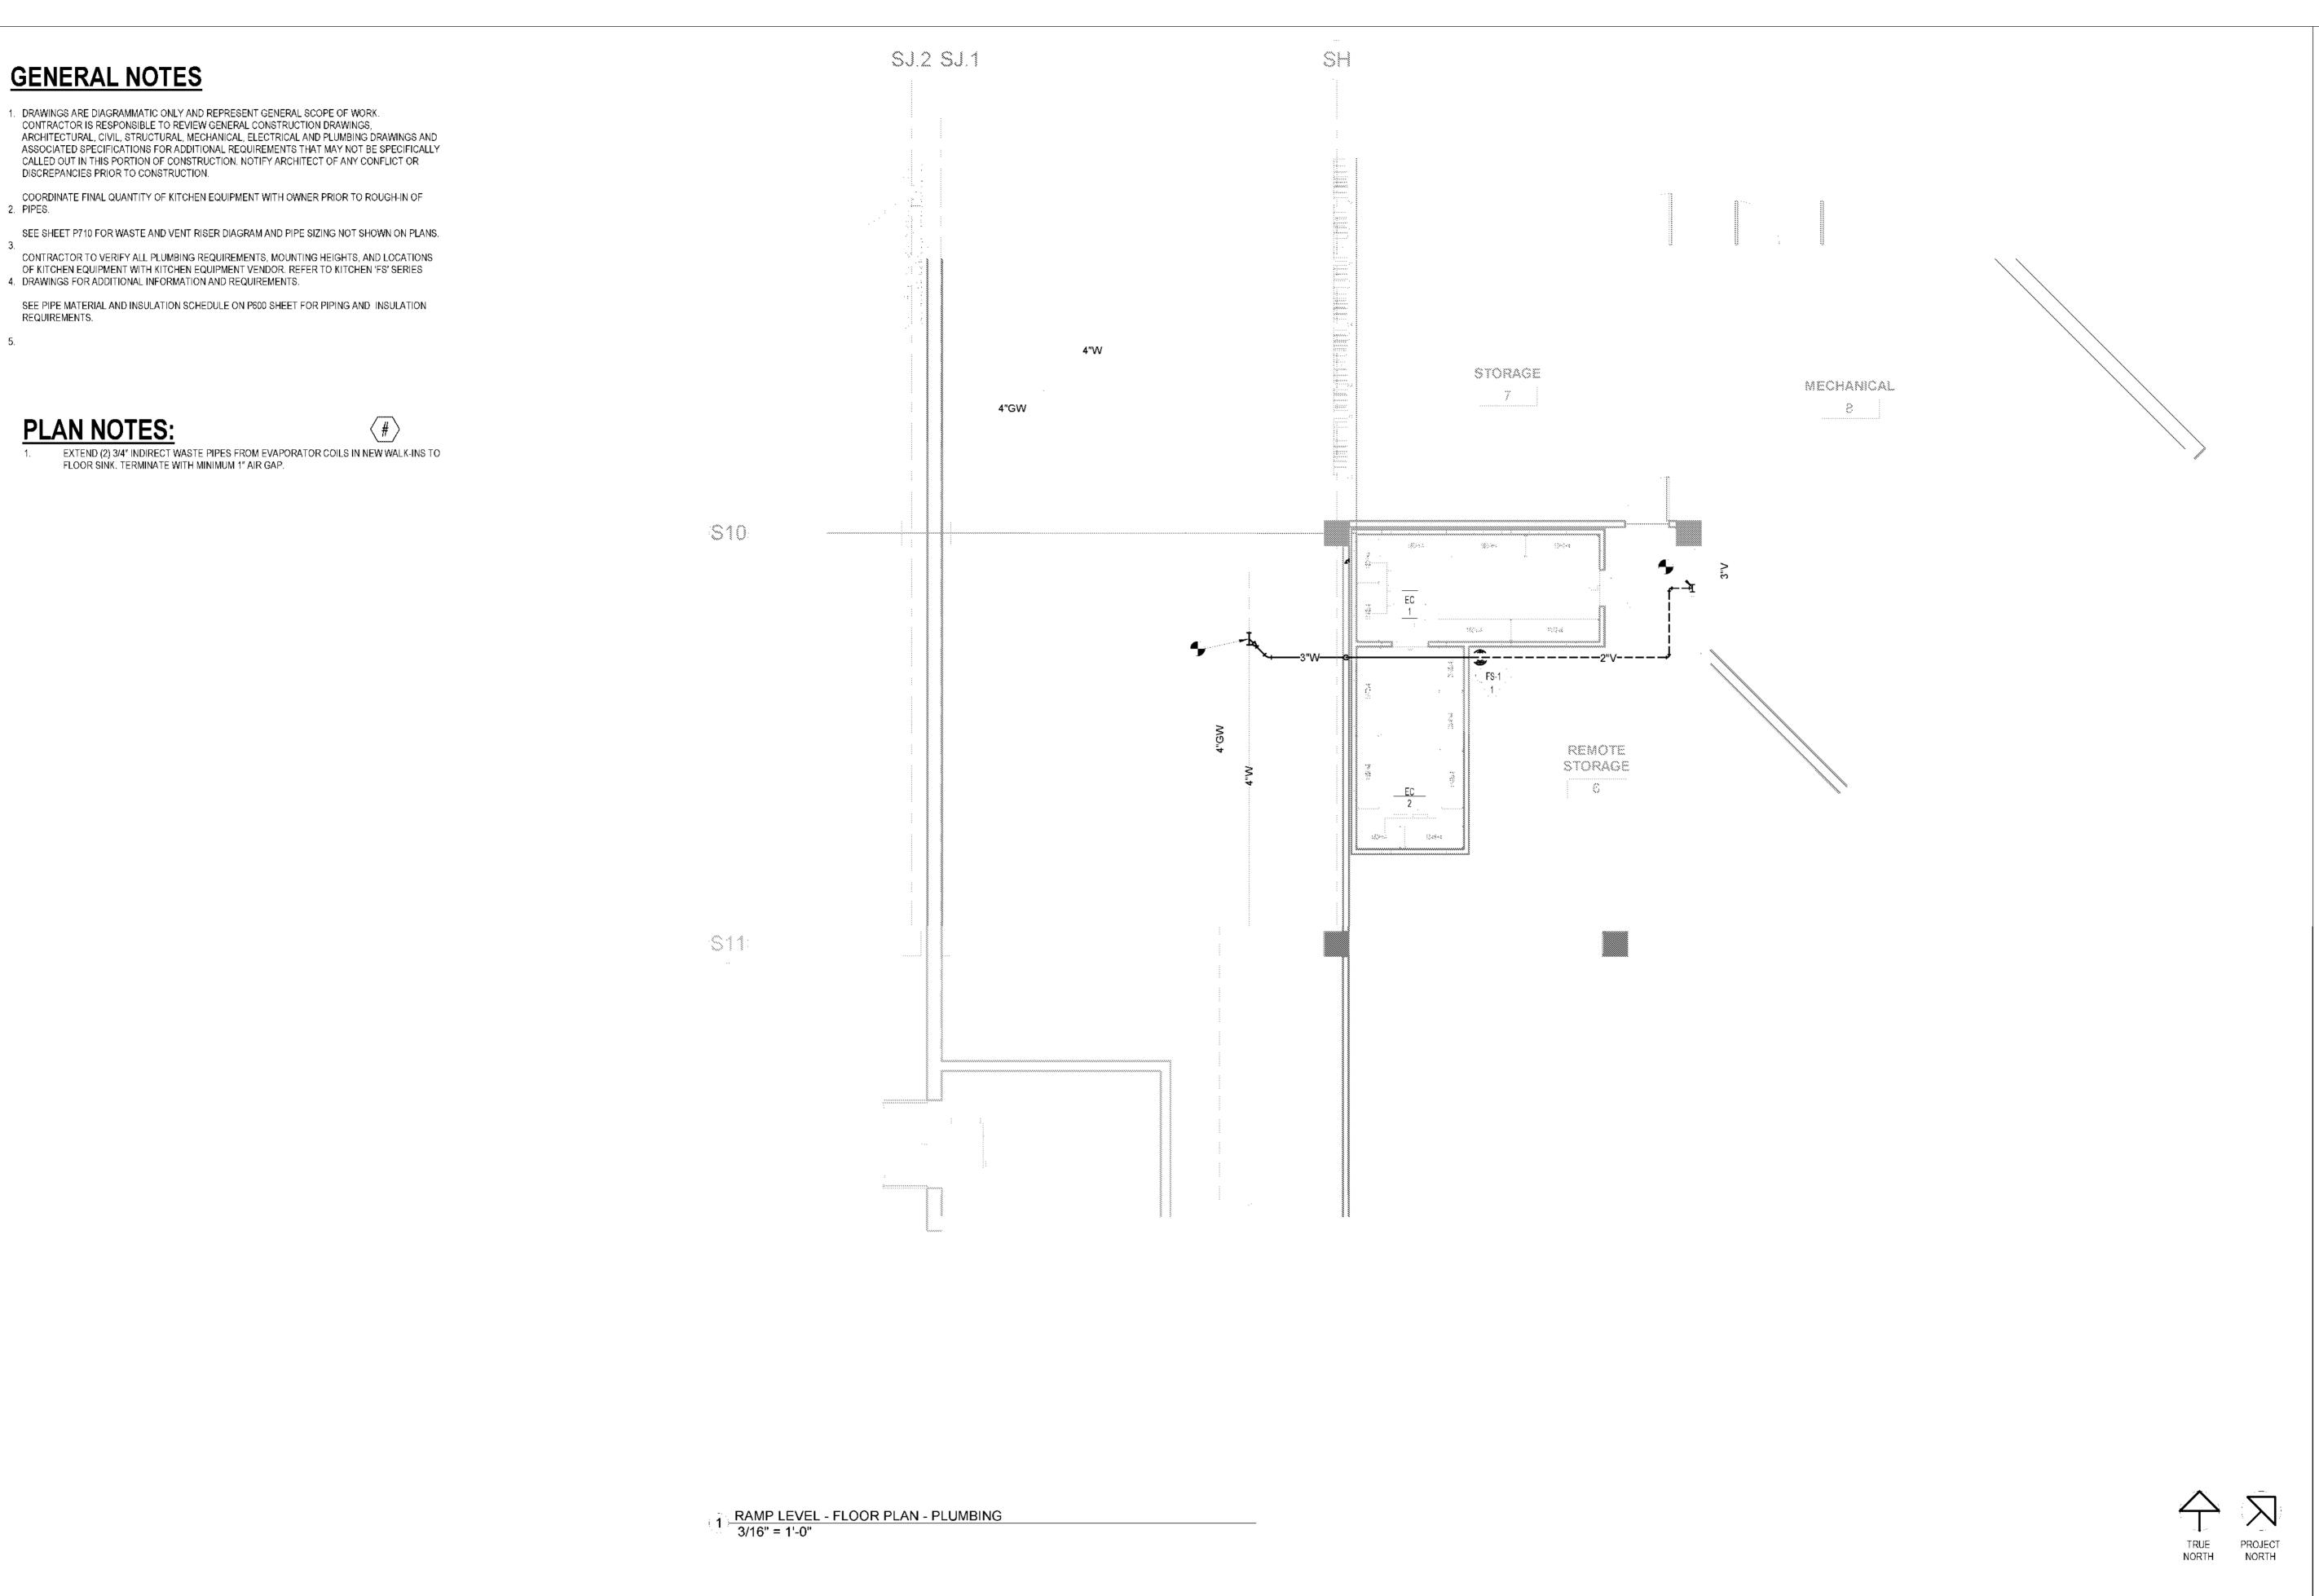SPACE: A, B, AND C

No. Description Date
1 60% SUBMITTAL 06/23/2023

PLUMBING WASTE AND VENT FLOOR PLAN - LOWER

LEVEL

Project number
Date
Drawn by

Checked by

Scale

1100

2023-019 06-23-2023

As indicated

Author

P100

# **PLAN NOTES:**

# $\langle \overline{\#} \rangle$

- EXTEND 3/4" INDIRECT WASTE PIPE FROM EVAPORATOR COIL IN NEW WALK-IN TO MOP SINK. TERMINATE WITH MINIMUM 1" AIR GAP.
- EXTEND 1-1/2" INDIRECT WASTE PIPE FROM DUMP SINK TO FLOOR SINK, TERMINATE WITH MINIMUM 1" AIR GAP.
- SINK PROVIDED BY KITCHEN EQUIPMENT SUPPLIER. SINK TO BE INSTALLED BY PLUMBING CONTRACTOR. ALLCONNECTIONS AND INSTALLATION OF COMPONENTS ASSOCIATED WITH SINK INSTALLED BY PLUMBING CONTRACTOR. SEE PLUMBING FIXTURE SCHEDULE ON SHEET P600 FOR ADDITIONAL INFORMATION. COORDINATE WITH KITCHEN EQUIPMENT SUPPLIER.
- EXTEND 1/2" INDIRECT WASTE PIPE FROM 4-HEAD TAP SYSTEM TO FLOOR SINK. TERMINATE WITH MINIMUM 1" AIR GAP.
- EXTEND 1/2" INDIRECT WASTE PIPE FROM DRIP TROUGH TO FLOOR SINK. TERMINATE WITH
- EXTEND 3/4" INDIRECT WASTE PIPE FROM UNDERCOUNTER ICE BIN TO FLOOR SINK. TERMINATE WITH MINIMUM 1" AIR GAP.
- EXTEND 1" INDIRECT WASTE PIPE FROM ESPRESSO MACHINE AND 1-1/2" INDIRECT WASTE FROM DUMP SINK TO FLOOR SINK, TERMINATE WITH MINIMUM 1" AIR GAP.
- EXTEND (3) 1-1/2" INDIRECT WASTE PIPES FROM THREE-COMP SINK DRAIN OUTLETS TO FLOOR SINK, TERMINATE WITH MINIMUM 1" AIR GAP.
- EXTEND (2) 3/4" INDIRECT WASTE PIPES FROM ICE BIN AND ICE MAKER TO FLOOR SINK. TERMINATE WITH MINIMUM 1" AIR GAP.

#### **GENERAL NOTES**

- 1. DRAWINGS ARE DIAGRAMMATIC ONLY AND REPRESENT GENERAL SCOPE OF WORK. CONTRACTOR IS RESPONSIBLE TO REVIEW GENERAL CONSTRUCTION DRAWINGS, ARCHITECTURAL, CIVIL, STRUCTURAL, MECHANICAL, ELECTRICAL AND PLUMBING DRAWINGS AND ASSOCIATED SPECIFICATIONS FOR ADDITIONAL REQUIREMENTS THAT MAY NOT BE SPECIFICALLY CALLED OUT IN THIS PORTION OF CONSTRUCTION. NOTIFY ARCHITECT OF ANY CONFLICT OR DISCREPANCIES PRIOR TO CONSTRUCTION.
- COORDINATE FINAL QUANTITY OF KITCHEN EQUIPMENT WITH OWNER PRIOR TO ROUGH-IN OF
- SEE SHEET P710 FOR WASTE AND VENT RISER DIAGRAM AND PIPE SIZING NOT SHOWN ON PLANS.
- CONTRACTOR TO VERIFY ALL PLUMBING REQUIREMENTS, MOUNTING HEIGHTS, AND LOCATIONS OF KITCHEN EQUIPMENT WITH KITCHEN EQUIPMENT VENDOR. REFER TO KITCHEN 'FS' SERIES 4. DRAWINGS FOR ADDITIONAL INFORMATION AND REQUIREMENTS.
- SEE PIPE MATERIAL AND INSULATION SCHEDULE ON P600 SHEET FOR PIPING AND INSULATION
- REQUIREMENTS.

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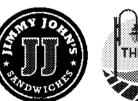
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WILMINGTON INTERNATIONAL AIRPORT 1740 AIRPORT BLVD, WILMINGTON, NC, 28405 BOARDING LEVEL, ZONE 1 SPACE: A, B, AND C


No.	Description	Date
1	60% SUBMITTAL	06/23/2023

PLUMBING WASTE AND VENT FLOOR PLAN - BOARDING

LEVEL 2023-019 Project number 06-23-2023 Drawn by

P101

1/4" = 1'-0"

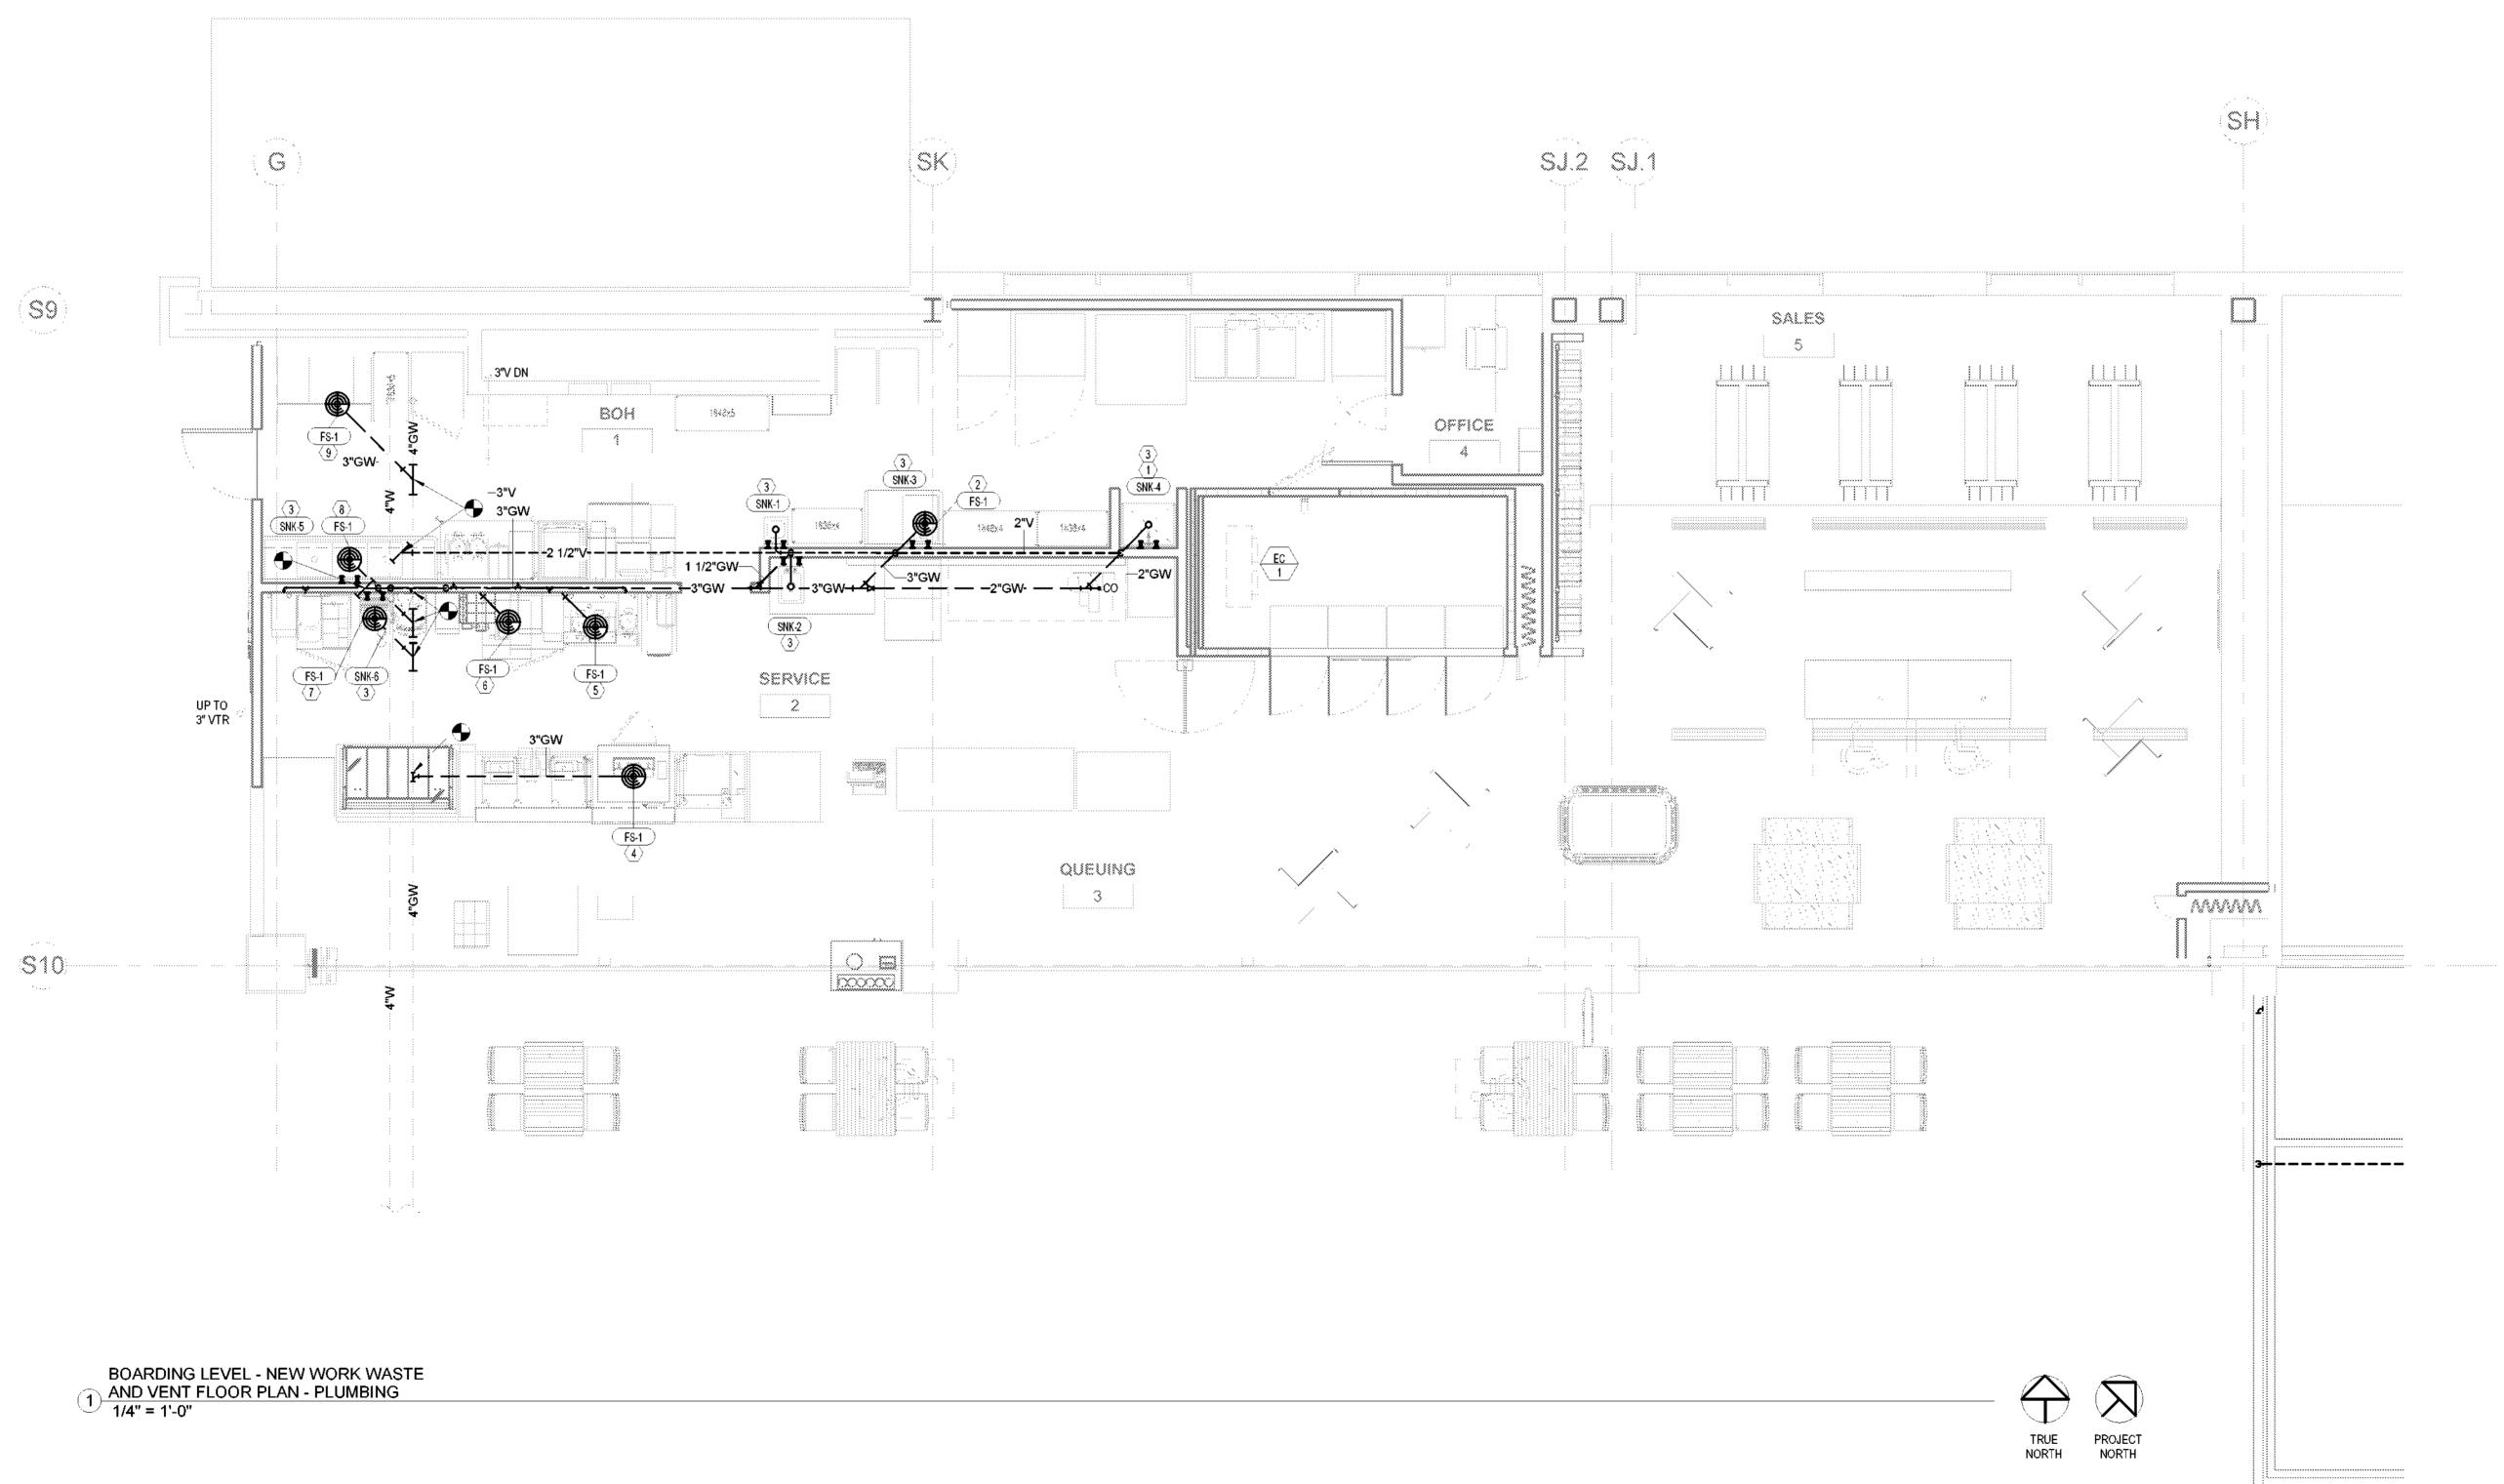

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# SINK AND FAUCET PROVIDED BY KITCHEN EQUIPMENT SUPPLIER. SINK AND FAUCET TO BE INSTALLED BY PLUMBING CONTRACTOR, ALL CONNECTIONS AND INSTALLATION OF CONTRACTOR IS RESPONSIBLE TO REVIEW GENERAL CONSTRUCTION DRAWINGS, COMPONENTS ASSOCIATED WITH SINK INSTALLED BY PLUMBING CONTRACTOR, SEE ARCHITECTURAL, CIVIL, STRUCTURAL, MECHANICAL, ELECTRICAL AND PLUMBING DRAWINGS AND PLUMBING FIXTURE SCHEDULE ON SHEET P600 FOR ADDITIONAL INFORMATION. ASSOCIATED SPECIFICATIONS FOR ADDITIONAL REQUIREMENTS THAT MAY NOT BE SPECIFICALLY COORDINATE WITH KITCHEN EQUIPMENT SUPPLIER. CALLED OUT IN THIS PORTION OF CONSTRUCTION. NOTIFY ARCHITECT OF ANY CONFLICT OR DISCREPANCIES PRIOR TO CONSTRUCTION. WATER FILTER TO BE PROVIDED BY KITCHEN EQUIPMENT SUPPLIER. WATER FILTER TO BE INSTALLED BY PLUMBING CONTRACTOR, FINAL CONNECTIONS AND COMPONENTS COORDINATE FINAL QUANTITY OF KITCHEN EQUIPMENT WITH OWNER PRIOR TO ROUGH-IN OF ASSOCIATED WITH WATER FILTER INSTALLED BY PLUMBING CONTRACTOR. COORDINATE WITH KITCHEN EQUIPMENT SUPPLIER. SEE SHEET P700 FOR DOMESTIC WATER RISER DIAGRAM AND PIPE SIZING NOT SHOWN ON PLANS. INSTALL WATER HEATER ON SHELF ABOVE MOP SINK. SEE DETAIL 3P500 FOR TYPICAL ELECTRIC WATER HEATER INSTALLATION DETAIL. CONTRACTOR TO VERIFY ALL PLUMBING REQUIREMENTS, MOUNTING HEIGHTS, AND LOCATIONS OF KITCHEN EQUIPMENT WITH KITCHEN EQUIPMENT VENDOR. REFER TO KITCHEN 'FS' SERIES SEE DETAIL 1P500 FOR TYPICAL EXPANSION TANK INSTALLATION DETAIL. 4. DRAWINGS FOR ADDITIONAL INFORMATION AND REQUIREMENTS. SEE DETAIL 2P500 FOR HOT WATER RECIRCULATION DETAIL. SEE PIPE MATERIAL AND INSULATION SCHEDULE ON P600 SHEET FOR PIPING AND INSULATION REQUIREMENTS. PROVIDE 1/2" FCW CONNECTION FOR KITCHEN EQUIPMENT WITH LEAD FREE BACKFLOW PREVENTER (WATTS LF7 OR APPROVED EQUAL), QUARTER-TURN SHUT-OFF VALVE AND ESCUTCHEON. COORDINATE WITH FS DRAWINGS FOR CONNECTION HEIGHT AFF. PROVIDE 1/2" FCW CONNECTION AND INSTALL LEAD FREE REDUCED PRESSURE BACKFLOW PREVENTER ASSEMBLY (WATTS WATTS LF7R OR APPROVED EQUAL) FOR ICE MAKER WATER LINE INLINE OF PIPE TO WATER CONNECTION. SH S9 -WATER FILTER (2) OFFICE ---3"CW -1 1/4"CW 1/2"CW 3/4"CW 1/2"HW 1/2"HW ("SNK-5") 1/2"FCW-QUEUING ~~~~~~ OB S10 000000 BOARDING LEVEL - FLOOR PLAN PLUMBING DOMESTIC WATER 1/4" = 1'-0" TRUE NORTH PROJECT NORTH

**PLAN NOTES:** 

**GENERAL NOTES** 

1. DRAWINGS ARE DIAGRAMMATIC ONLY AND REPRESENT GENERAL SCOPE OF WORK.



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WILMINGTON INTERNATIONAL AIRPORT 1740 AIRPORT BLVD, WILMINGTON, NC, 28405 BOARDING LEVEL, ZONE 1 SPACE: A, B, AND C

No.	Description	Date
1	60% SUBMITTAL	06/23/2023

PLUMBING DOMESTIC WATER PLAN - BOARDING


LEVEL

2023-019 Project number 06-23-2023 Author Drawn by

P111

1/4" = 1'-0"


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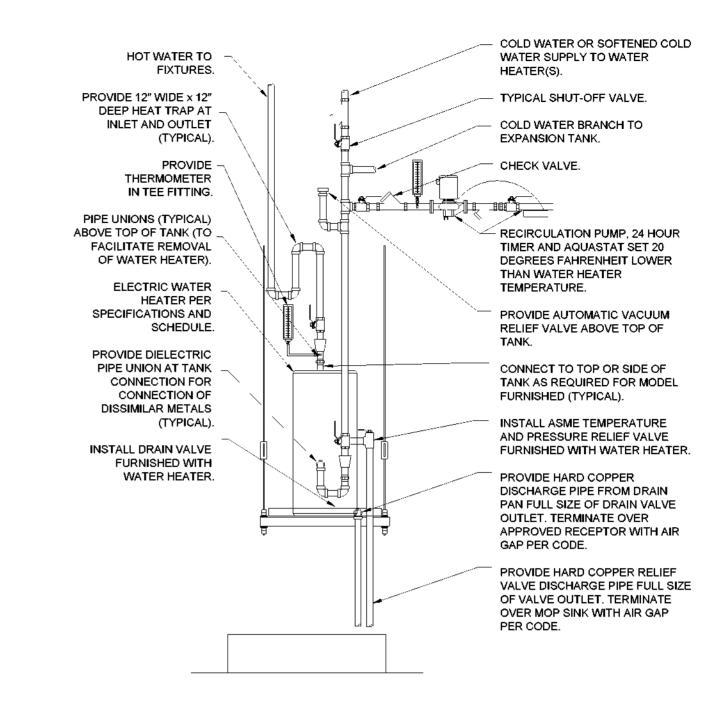


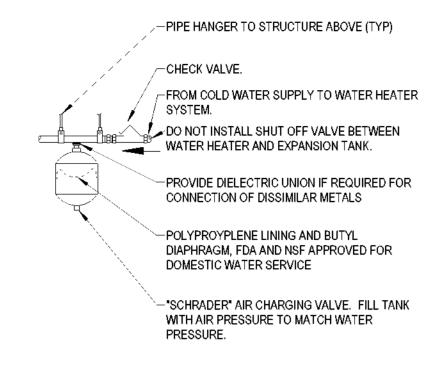FLOOR OR PLATFORM

PIPING ARRANGEMENT SHOWN IS SCHEMATIC. ADJUST TO SUIT FIELD CONDITIONS, EQUIPMENT FURNISHED. REFER TO SPECIFICATIONS, SCHEDULES AND NOTES FOR ADDITIONAL INFORMATION. REFERENCE SCHEDULES TO CONFIRM SUSPENDED OR BASE MOUNTING INSTALLATION. BRANCH PIPING SHALL BE SAME SIZE AS TANK FITTING. VERIFY PROPER OPERATION WHEN INSTALLED.

1 THERMAL EXPANSION TANK DETAIL
12" = 1'-0"



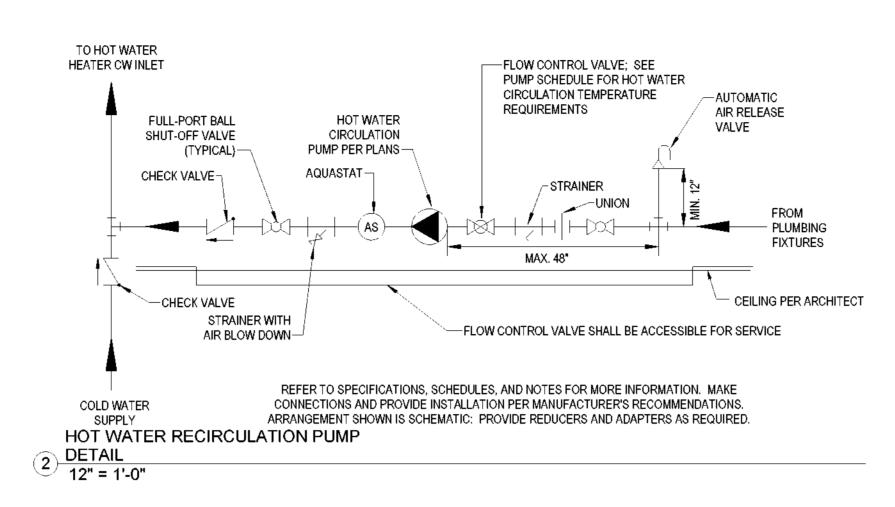

PIPING ARRANGEMENT SHOWN IS SCHEMATIC. ADJUST TO SUIT FIELD CONDITIONS, EQUIPMENT FURNISHED. REFER TO SPECIFICATIONS, SCHEDULES, AND NOTES FOR ADDITIONAL INFORMATION. PROVIDE SEISMIC STRAP(S) OR BRACING. REFERENCE ELECTRICAL PLANS FOR POWER AND MEANS OF DISCONNECT.

ELECTRIC WATER HEATER ON SHELF

3) DETAIL 12" = 1'-0"

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SPACE: A, B, AND C

No.	Description	Date
1	60% SUBMITTAL	06/23/2023

# PLUMBING DETAILS

2023-019 Project number 06-23-2023 Author Drawn by Checked by

P500

12" = 1'-0" Scale

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#### PLUMBING FIXTURE SCHEDULE

FIXTURES IN THIS SCHEDULE OR THEIR APPROVED EQUIVALENT ARE PROVIDED BY THE PLUMBING CONTRACTOR. ANY CONFLICTS BETWEEN MODEL NUMBER AND DESCRIPTION THE DESCRIPTION SHALL PREVAIL SUBMIT SHOP DRAWINGS ON EACH OF THESE ITEMS. REFER TO SPECIFICATIONS FOR FURTHER INFORMATION AND

MARK	DESCRIPTION		PIP	'E SIZE CON	NECTION	
		COLD WATER	HOT WATER	MIXED WATER	WASTE	VENT
TMV-1	THERMOSTATIC MIXING VALVE:  MANUFACTURED BY LEONARD OR APPROVED EQUAL SHALL BE: LEAD FREE BRASS BODY, COPPER ENCAPSULATED THERMOSTAT ASSEMBLY WITH POLYMER THERMOPLASTIC SHUTTLE, STAINLESS STEEL SPRINGS, BUNA-N O-RINGS, INTEGRAL CHECKS, COLD WATER BY-PASS, MOUNTING BRACKET, VANDAL RESISTANT LOCKING TEMPERATURE ADJUSTMENT CAP, ASSE 1070 CERTIFIED, CAPABLE OF 1.7 GPM WITH A 5 PSI PRESSURE LOSS, CAPABLE OF 2.3 GPM WITH A 10 PSI PRESSURE LOSS AND A MINIMUM FLOW RATE OF 0.25 GPM. 3/8" INLET AND OUTLET CAN BE CONFIGURED TO SERVE EITHER A TWO HANDLE LAVATORY/SINK OR SINGLE INLET SENSOR FAUCET. TEMPERATURE ADJUSTMENT RANGE FROM 90 TO 140 DEGREES, UNIT IS NOT FACTORY PRESET CONTRACTOR SHALL SET OUTLET TEMPERATURE TO 105 DEGREES FAHRENHEIT. MOUNT BELOW THE PLUMBING FIXTURE WHERE INDICATED ON PLAN(S).	1/2"	1/2"			
FS-1	DRAIN, FLOOR SINK: MANUFACTURED BY ZURN OR APPROVED EQUAL MANUFACTURER SHALL BE: Z1960 CAST IRON BODY, 8" ROUND, WITH SEEPAGE FLANGE AND MEMBRANE FLASHING CLAMP, ROUND, LIGHT-DUTY (FULL, 3/4 OR 1/2) GRATE WITH SLOTTED OPENINGS, ALUMINUM ANTI-SPLASH INTERIOR BOTTOM DOME STRAINER (OR ALUMINUM BUCKET OR STAINLESS STEEL MESH LINER FOR BUCKET) AND BOTTOM OUTLET. PROVIDE WITH TRAP SEAL PROTECTOR TSP-1 AS SCHEDULED. PROVIDE DRAIN BODY WITH 1/2 INCH TRAP PRIMER CONNECTION AS REQUIRED BY TRAP SEAL PROTECTOR. DRAIN BODY AND GRATE HAVE ACID RESISTANT COATING. USE PUSH-ON JOINT OF OUTLET SIZE AS SHOWN ON PLANS.				3"	2"
	LOAD RATING CLASSIFICATIONS: GRATES AND TOP RIMS SHALL BE TO MEET SAFE LOAD OF: LIGHT DUTY, UNDER 2,000 POUNDS.					
TSP-1	TRAP SEAL PROTECTION: SURE SEAL MODEL SERIES "SS" INLINE FLOOR DRAIN TRAP SEALER, SHALL BE ASSE 1072 APPROVED, SIZED PER DRIAN OUTLET WITH PERFORMANCE THAT WILL NOT DETERORIATE IN AREAS OF HEAVY GREASE OR WAXED FLOORS. UNIT SHALL HAVE A TEN YEAR WARRANTY. (UNIT SHALL BE ICC-ES LISTED: PMG-1070 AND IAPMO LISTED: C-4165)				PER PLAN	
SNK-1	WALL-HUN HAND WASH SINK: PROVIDED BY KEC VENDOR AND INSTALLED BY PLUMBING CONTRACTOR. FAUCET: PROVIDED BY KEC VENDOR AND INSTALLED BY PLUMBING CONTRACTOR. TRIM: MANUFACTURED BY McQUIRE OR APPROVED EQUAL SHALL BE: 1) BASKET STRAINER (INCLUDED WITH SINK), 2) LEAD FREE QUARTER TURN BALL VALVE ANGLE STOP VALVES WITH RISERS AND ESCUTCHEONS, 3) CAST BODY P-TRAP WITH CLEANOUT - 1-1/2" INLET TO 1-1/2" OUTLET 17 GAUGE WASTE CHROME PLATED BRASS WASTE ARM AND ESCUTCHEON. (PROVIDED AND INSTALLED BY PLUMBING CONTRACTOR). PROVIDE WITH TMV-1.	1/2"	1/2"	1/2"	1-1/2"	1-1/2"
SNK-2	DROP-IN HAND WASH SINK: PROVIDED BY KEC VENDOR AND INSTALLED BY PLUMBING CONTRACTOR. FAUCET: PROVIDED BY KEC VENDOR AND INSTALLED BY PLUMBING CONTRACTOR. TRIM: MANUFACTURED BY McQUIRE OR APPROVED EQUAL SHALL BE: 1) BASKET STRAINER (INCLUDED WITH SINK), 2) LEAD FREE QUARTER TURN BALL VALVE ANGLE STOP VALVES WITH RISERS AND ESCUTCHEONS, 3) CAST BODY P-TRAP WITH CLEANOUT - 1-1/2" INLET TO 1-1/2" OUTLET 17 GAUGE WASTE CHROME PLATED BRASS WASTE ARM AND ESCUTCHEON. (PROVIDED AND INSTALLED BY PLUMBING CONTRACTOR). PROVIDE WITH TMV-1.	1/2"	1/2"	1/2"	1-1/2"	1-1/2"
SNK-3	WORK TABLE WITH INTEGRAL SINK: PROVIDED BY KEC VENDOR AND INSTALLED BY PLUMBING CONTRACTOR. FAUCET: PROVIDED BY KEC VENDOR AND INSTALLED BY PLUMBING CONTRACTOR. TRIM: PROVIDE 1) TWIST HANDLE LEVER WASTE FOR 3-1/2" INDUSTRY STANDARD SINK OPENING, 2) LEAD FREE QUARTER TURN BALL VALVE ANGLE STOP VALVES WITH RISERS AND ESCUTCHEONS, AND 3) BASKET STRAINER WITH INCLUDED ADAPTER FOR EITHER 2" OR 1-1/2" DRAIN OUTLET. PROVIDE KROWNE ROYAL SERIES TWIST WASTE DRAIN WITH 1-1/4" OVERFLOW OUTLET.	1/2"	1/2"		1-1/2" INDIRECT WASTE	
SNK-4	MOP SINK: PROVIDED BY KEC VENDOR AND INSTALLED BY PLUMBING CONTRACTOR. FAUCET: PROVIDED BY KEC VENDOR AND INSTALLED BY PLUMBING CONTRACTOR.	1/2"	1/2"	-	2"	2"
SNK-5	THREE-COMPARTMENT BAR SINK:  PROVIDED BY KEC VENDOR AND INSTALLED BY PLUMBING CONTRACTOR.  FAUCET: PROVIDED BY KEC VENDOR AND INSTALLED BY PLUMBING CONTRACTOR.  TRIM: PROVIDE 1) TWIST HANDLE LEVER WASTE FOR 3-1/2" INDUSTRY STANDARD SINK OPENING, 2) LEAD FREE QUARTER TURN BALL VALVE ANGLE STOP VALVES WITH RISERS AND ESCUTCHEONS, AND 3) BASKET STRAINER WITH INCLUDED ADAPTER FOR EITHER 2" OR 1-1/2" DRAIN OUTLET. PROVIDE KROWNE ROYAL SERIES TWIST WASTE DRAIN WITH 1-1/4" OVERFLOW OUTLET FOR EACH COMPARTMENT.	1/2"	1/2"		(3) 1-1/2" INDIRECT WASTE	
SNK-6	WORK TABLE WITH INTEGRAL SINK:  PROVIDED BY KEC VENDOR AND INSTALLED BY PLUMBING CONTRACTOR.  FAUCET: PROVIDED BY KEC VENDOR AND INSTALLED BY PLUMBING CONTRACTOR.  TRIM: PROVIDE 1) TWIST HANDLE LEVER WASTE FOR 3-1/2" INDUSTRY STANDARD SINK OPENING, 2) LEAD FREE QUARTER TURN BALL VALVE ANGLE STOP VALVES WITH RISERS AND ESCUTCHEONS, AND 3) BASKET STRAINER WITH INCLUDED ADAPTER FOR EITHER 2" OR 1-1/2" DRAIN OUTLET. PROVIDE KROWNE ROYAL SERIES TWIST WASTE DRAIN WITH	1/2"	1/2"		1-1/2" INDIRECT WASTE	

	RECIRCULATION PUMP SCHEDULE											
				DESIGN					MOTOR			
TAG	LOCATION	MANUFACTURER	MODEL NUMBER	FLOW	HEAD	RPM	VOLTS/	FREQ.	AMPS	HORSEPOWER/ WATTS	SYSTEM	NOTES
				(GPM)	(FEET)		PHASE	(HERTZ)	Airiro	HORSEFOWER WATES		
HWP-1	KITCHEN	BELL & GOSSETT	NBF-25	3.0	.8		120 / 1	60	1.33	1/6 HP / 160 WATTS	EWH-1	1,2,3

- 1 PUMP SHALL HAVE A NON-OVERLOADING MOTOR, SINGLE SPEED SWITCH WITH CERAMIC SHAFT SUPPORTED BY CARBON BEARINGS LURICATED BY THE CIRCULATING FLUID. MOUNTING FLANGE SIZE SHALL BE THE SAME SIZE AS THE PIPE SIZE.
- 2 PROVIDE A HONEYWELL MODEL L4006B STRAP-ON AQUASTAT WITH TEMPERATURE RANGE OF 100 TO 180 DEGREE FAHRENHEIT. CONTROLLED PUMP SHALL OPERATE WHEN THERE IS A 20 DEGREE DIFFERENTIAL BETWEEN WATER HEATER SET POINT OF 180 DEGREES AND RETURN TEMPERATURE.
- 3 PROVIDE SEPARATE 24 HOUR TIMER PROGRAMMABLE IN 15 MINUTE INTERVALS. COORDINATE WITH OWNER FOR SETTING TIMER: TIMER SHALL BE ON 30 MINUTES BEFORE START OF OPERATIONS, OFF AT END OF DAY OPERATIONS. PROVIDE SUPPORT FOR PUMP INDEPENDENT OF PIPING.

	DOMESTIC WATER THERMAL EXPANSION TANK SCHEDULE												
	LOCATION	MANUFACTURER	MODEL NUMBER	TANK	VOLUM	E (GALLONS)	TA	NK	WEIGHT	SYSTEM	INITIAL FILL	SYSTEM	NOTES
TAG				RATING	TANK	ACCEPTANCE	DIAMETER	HEIGHT	AT CAPACITY *	CONNECTION	PRESSURE		
ET-1	KITCHEN	RHEEM	RRT-5	NON-ASME	2.0	0.9	8.0	12-5/8"	13 LBS.	3/4" NPTM	NOTE 1	EWH-1	1, 2, 3

1. UNIT IS PRECHARGED AT THE FACTORY. NON-ASME THERMAL EXPANSION TANKS PRECHARGED TO 40 PSI, ASME RATED THERMAL EXPANSION TANKS PRECHARGED TO 55 PSI, COMPLETE

- THE CHARGE TO THE STATIC SUPPLY PRESSURE AT THE TANKS LOCATION.
- 2. SUSPEND TANK FROM PIPING. PROPERLY SUPPORT PIPING IN EACH SIDE OF THE TANK.
- 3. TANK IS A NOT ASME RATED.
- * WEIGHT INCLUDES ACCEPTANCE WATER AT CAPACITY, FOR A TANK RATED AT 150 PSI WORKING PRESSURE.

PIPING MATERIAL SCHEDULE												
	PIPING						FITTING	3S	MAX. WO	ORKING	FIELD TEST	г —
SYSTEM	SIZE	TYPE	SCHEDULE	GRADE	ASTM	MATERIAL	MATERIAL	TYPE	PRESSURE (PSI)	TEMP. (DEG. F.)	PRESSURE (PSI)	TIME
SANITARY GREASE WASTE (ABOVE GRADE)	ALL	N/A	N/A	N/A	A 888	CI	CI	NH	4.33	-	4.33	2 HR
SANITARY VENT (ABOVE GRADE)	ALL	N/A	40	N/A	D 2665	PVC	PVC	SF	4.33	-	4.33	2 HF
NOTES: BLK- BLACK CI-CAST IRON CP- COPPER CS- CARBON STEEL MI-MALLEABLE IRON	S-BRAZED JOINT SJ-SOLDER JOINT THRD-THREADED WELD-WELDED PVC	•	SF - SOCKET NH-NO HUB	FITTING	S		NOTE: PVC	NOT AL	LOWED IN OPEN A	AIR SPACE OR RE	TURN AIR PLENUM	AS.

PIPING MATERIAL SCHEDULE												
PIPING FITTINGS MAX. WORKING FIELD TEST												
SYSTEM	SIZE	TYPE	SCHEDULE	GRADE	ASTM	MATERIAL	MATERIAL	TYPE	PRESSURE (PSI)	TEMP. (DEG. F.)	PRESSURE (PSI)	TIME
DOMESTIC COLD WATER (ABOVE GRADE)	ALL	L	N/A	N/A	B88	CP	WC	SJ	100	180	150	2 HR
DOMESTIC HOT WATER/HOT WATER RECIRC. (ABOVE GRADE)	ALL	L	N/A	N/A	B88	СР	wc	SJ	100	180	150	2 <b>H</b> R
NOTES: BLK- BLACK CI-CAST IRON CP- COPPER CS- CARBON STEEL MI-MALLEABLE IRON	S-BRAZED JOINT SJ-SOLDER JOINT THRD-THREADED WELD-WELDED WC - WROUGHT COPPE	≣R										

	ELECTRIC WATER HEATER SCHEDULE													
	TAG	MANUFACTURER	MODEL NUMBER	AREA SERVED	ENERGY SOURCE	GALLONS	TANI DIAMETER	K SIZE HEIGHT	WEIGHT	INPUT (TOTAL Kw)	VOLTAGE PHASE	AMPERAGE	RECOVERY @ 80 DEGREE	NOTES
									ASME		FREQUENCY		RISE	
EWH-1		AO SMITH	DRE-52	KITCHEN	ELECTRIC	52	21.75"	55.25"	146	18.0	208/3/60	43.3	92	A,B,C,D,E,F


- 100 DEGREE TEMPERATURE RISE WITH 140 DEGREE OPERATING TEMPERATURE.
- SET TEMPERATURE CONTROL TO FACTORY MINIMUM OF 140 DEGREES.
- SOLID BRASS, TAMPER RESISTANT, DRAIN VALVE.
- FURNISH WITH IMMERSION THERMOSTATS.
- WATER HEATER HAS TWO EQUALLY SIZED ELEMENTS THAT OPERATE SIMULATEOUSLY.

WATER HEATER HAS A 6 YEAR STANDARD WARRANTY.

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WILMINGTON INTERNATIONAL AIRPORT 1740 AIRPORT BLVD, WILMINGTON, NC, 28405 BOARDING LEVEL, ZONE 1 SPACE: A, B, AND C

No.	Description	Date
1	60% SUBMITTAL	06/23/2023

## PLUMBING SCHEDULES

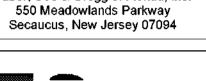
2023-019 06-23-2023 Author

Scale

P600

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PIPING ISOMETRIC - DOMESTIC WATER

1 - BOARDING LEVEL
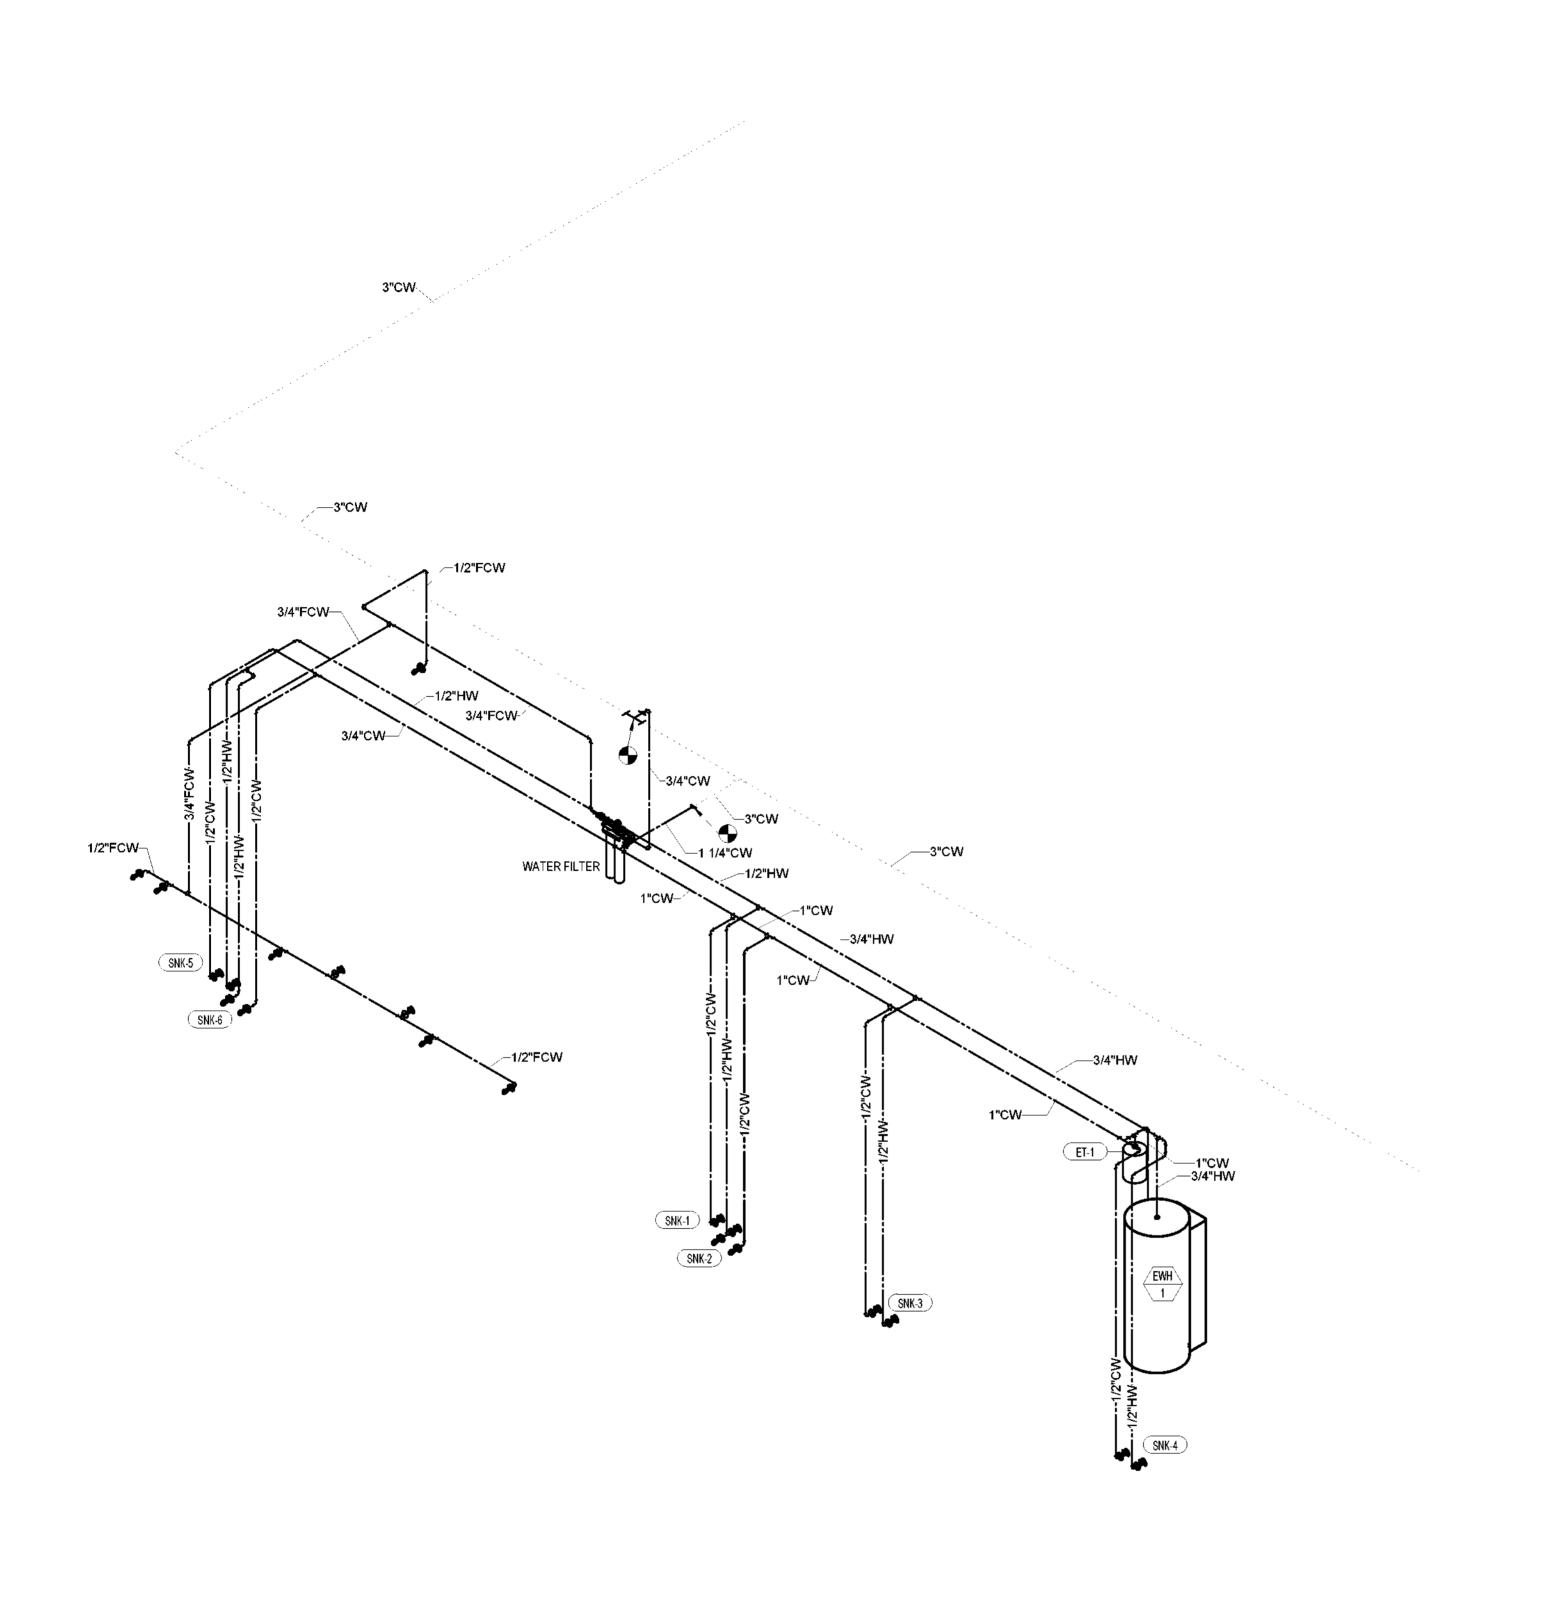
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No.	Description	Date
1	60% SUBMITTAL	06/23/2023

## PLUMBING DOMESTIC WATER RISER


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PIPING ISOMETRIC - WASTE AND VENT -

BOARDING LE

SIL-OUETTE

DESIGN ARCHITECTURE

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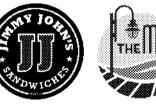
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No.	Description	Date
1	60% SUBMITTAL	06/23/2023
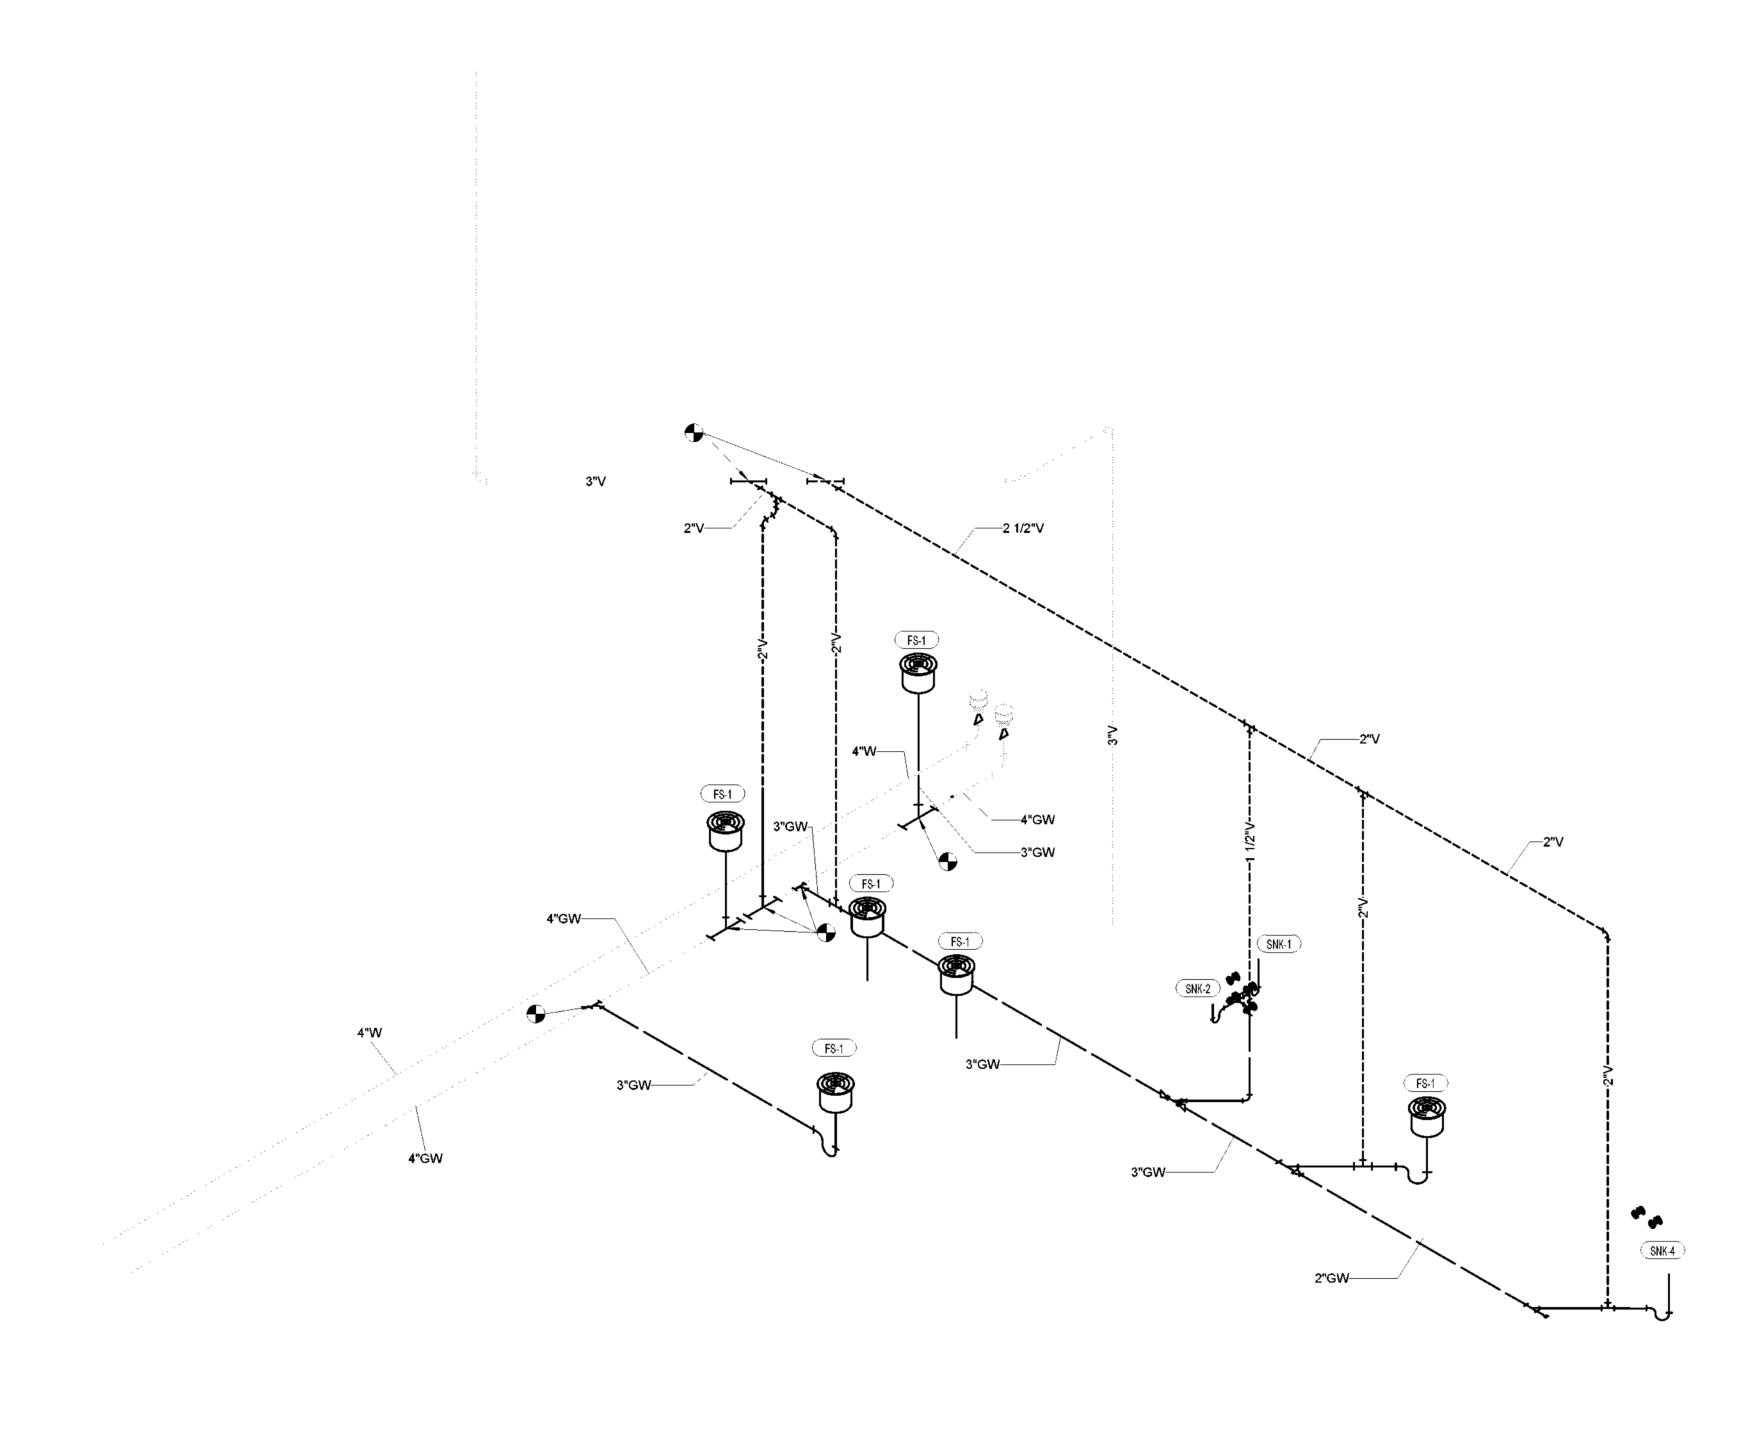
# PLUMBING SANITARY RISER

 Project number
 2023-019

 Date
 06-23-2023

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 Author

 Checked by
 LU


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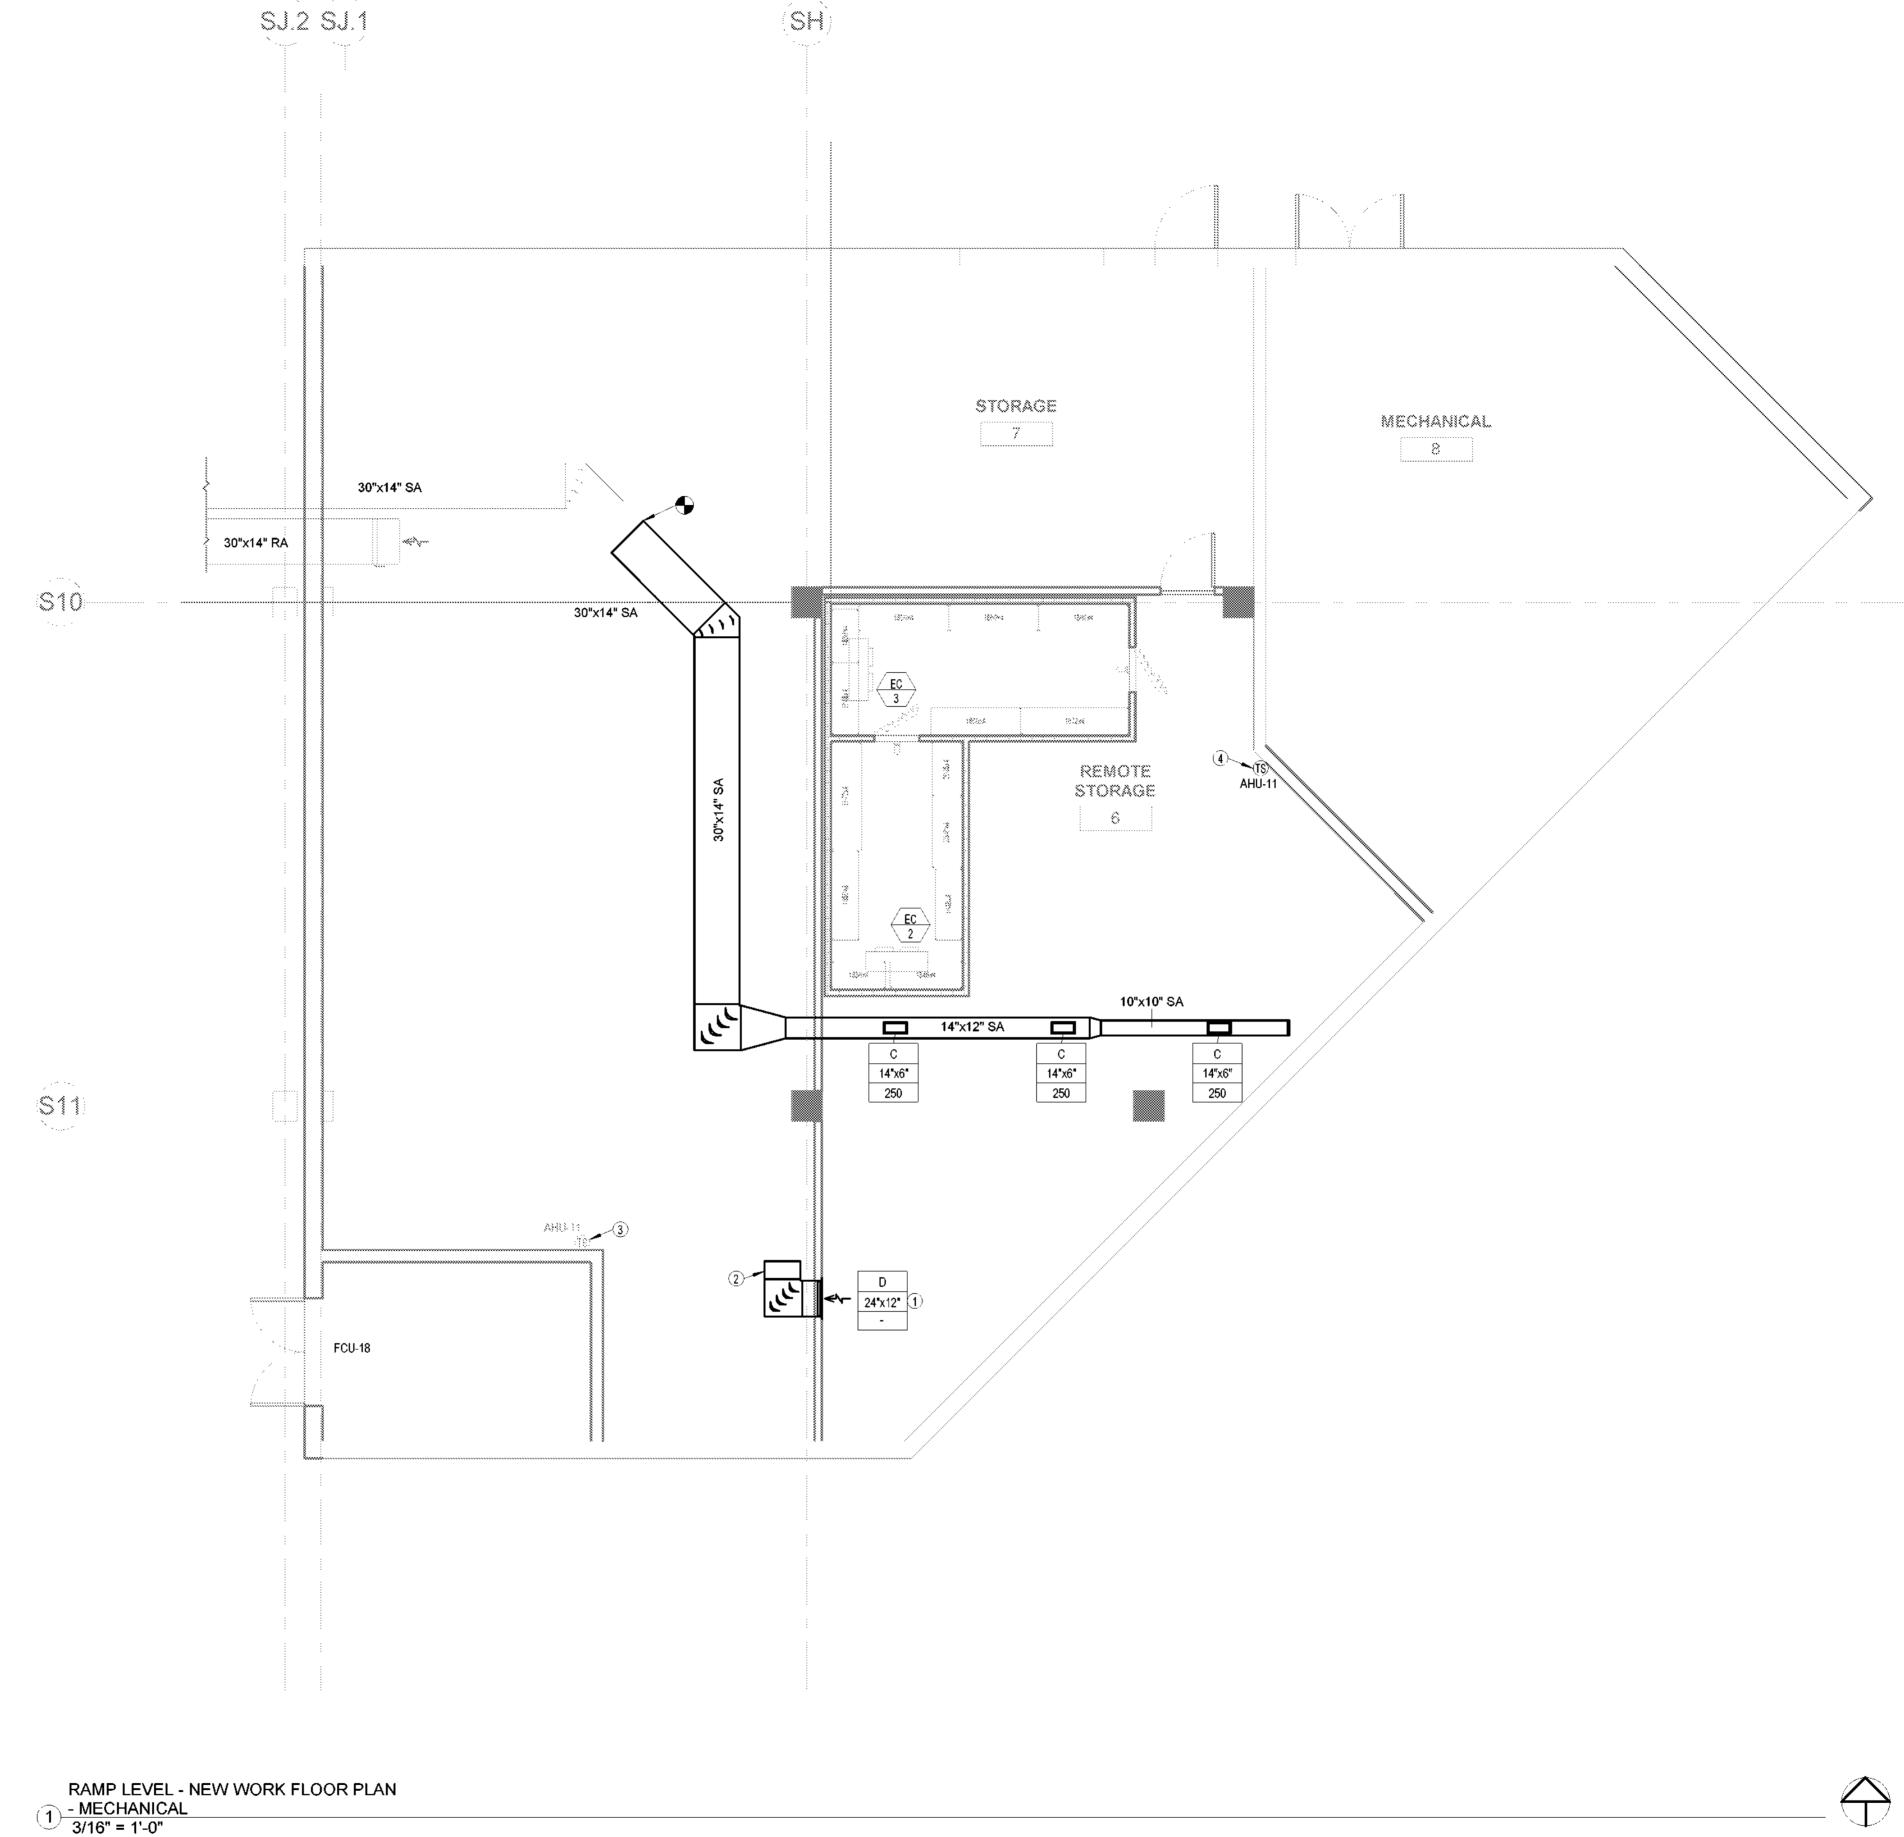
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Scale





TRUE PROJECT NORTH

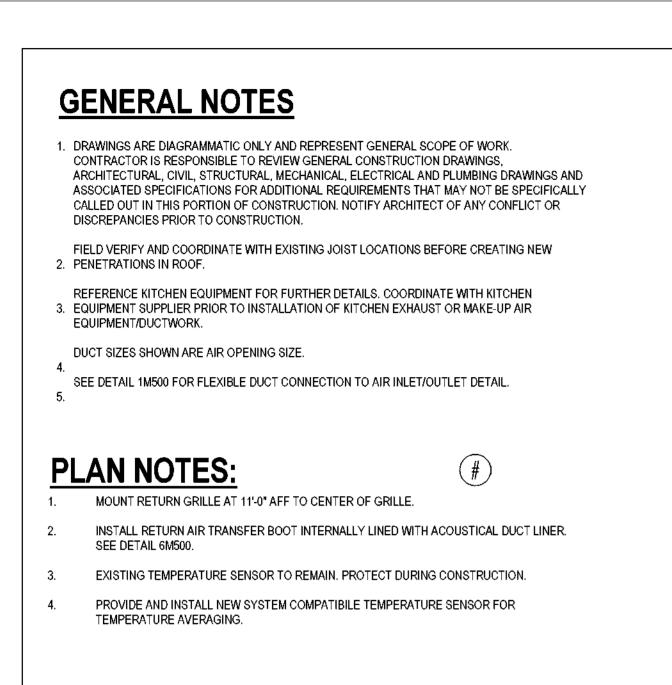

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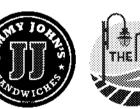
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WILMINGTON INTERNATIONAL AIRPORT 1740 AIRPORT BLVD, WILMINGTON, NC, 28405 BOARDING LEVEL, ZONE 1 SPACE: A, B, AND C

No.	Description	Date
1	60% SUBMITTAL	06/23/2023

MECHANICAL NEW WORK PLAN - RAMP LEVEL

Project number	2023-019
Date	06-23-2023
Drawn by	Author
Checked by	LU

M100

As indicated

ng with Scale

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#### **PLAN NOTES:**

- EXISTING SUPPLY DIFFUSER TO REMAIN, REBALANCE AIRFLOW AS NOTED.
- 2. EXISTING BLOWER COIL TO REMAIN. SEE BLOWER COIL SCHEDULE ON SHEET M600 FOR REBALANCING OF EQUIPMENT.
- 3. EXISTING RETURN GRILLE TO REMAIN.
- 4. SEE DETAIL 5M500 FOR TYPICAL RETURN AIR BOOT DETAIL.
- RELOCATED TEMPERATURE SENSOR. EXTEND EXISTING CONTROL WIRING TO NEW LOCATION AS REQUIRED.

#### **GENERAL NOTES**

- DRAWINGS ARE DIAGRAMMATIC ONLY AND REPRESENT GENERAL SCOPE OF WORK.
   CONTRACTOR IS RESPONSIBLE TO REVIEW GENERAL CONSTRUCTION DRAWINGS,
   ARCHITECTURAL, CIVIL, STRUCTURAL, MECHANICAL, ELECTRICAL AND PLUMBING DRAWINGS AND
   ASSOCIATED SPECIFICATIONS FOR ADDITIONAL REQUIREMENTS THAT MAY NOT BE SPECIFICALLY
   CALLED OUT IN THIS PORTION OF CONSTRUCTION. NOTIFY ARCHITECT OF ANY CONFLICT OR
   DISCREPANCIES PRIOR TO CONSTRUCTION.
- FIELD VERIFY AND COORDINATE WITH EXISTING JOIST LOCATIONS BEFORE CREATING NEW 2. PENETRATIONS IN ROOF.
- REFERENCE KITCHEN EQUIPMENT FOR FURTHER DETAILS. COORDINATE WITH KITCHEN 3. EQUIPMENT SUPPLIER PRIOR TO INSTALLATION OF KITCHEN EXHAUST OR MAKE-UP AIR EQUIPMENT/DUCTWORK.
- DUCT SIZES SHOWN ARE AIR OPENING SIZE.
- SEE DETAIL 1M500 FOR FLEXIBLE DUCT CONNECTION TO AIR INLET/OUTLET DETAIL.

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WILMINGTON INTERNATIONAL AIRPORT 1740 AIRPORT BLVD, WILMINGTON, NC, 28405 BOARDING LEVEL, ZONE 1 SPACE: A, B, AND C

No.	Description	Date
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#### MECHANICAL FLOOR PLAN - BOARDING LEVEL

 Project number
 2023-019


 Date
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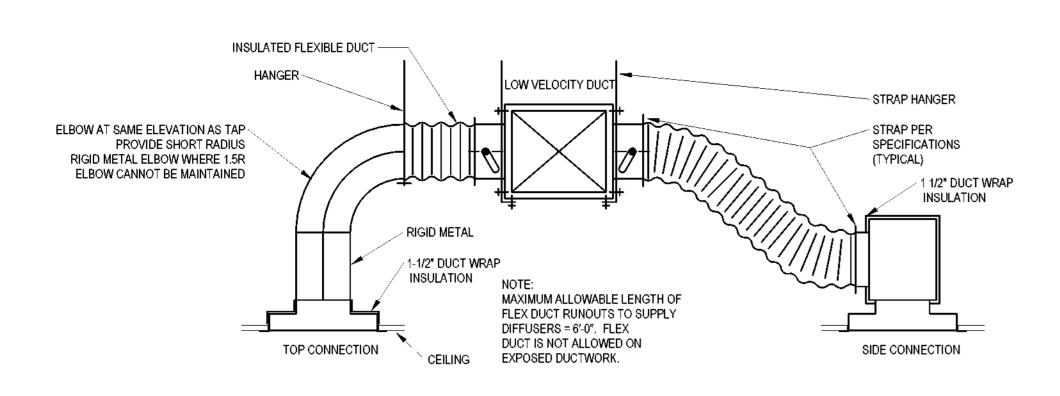
 Drawn by
 Author

 Checked by
 LU

M101


1/4" = 1'-0"



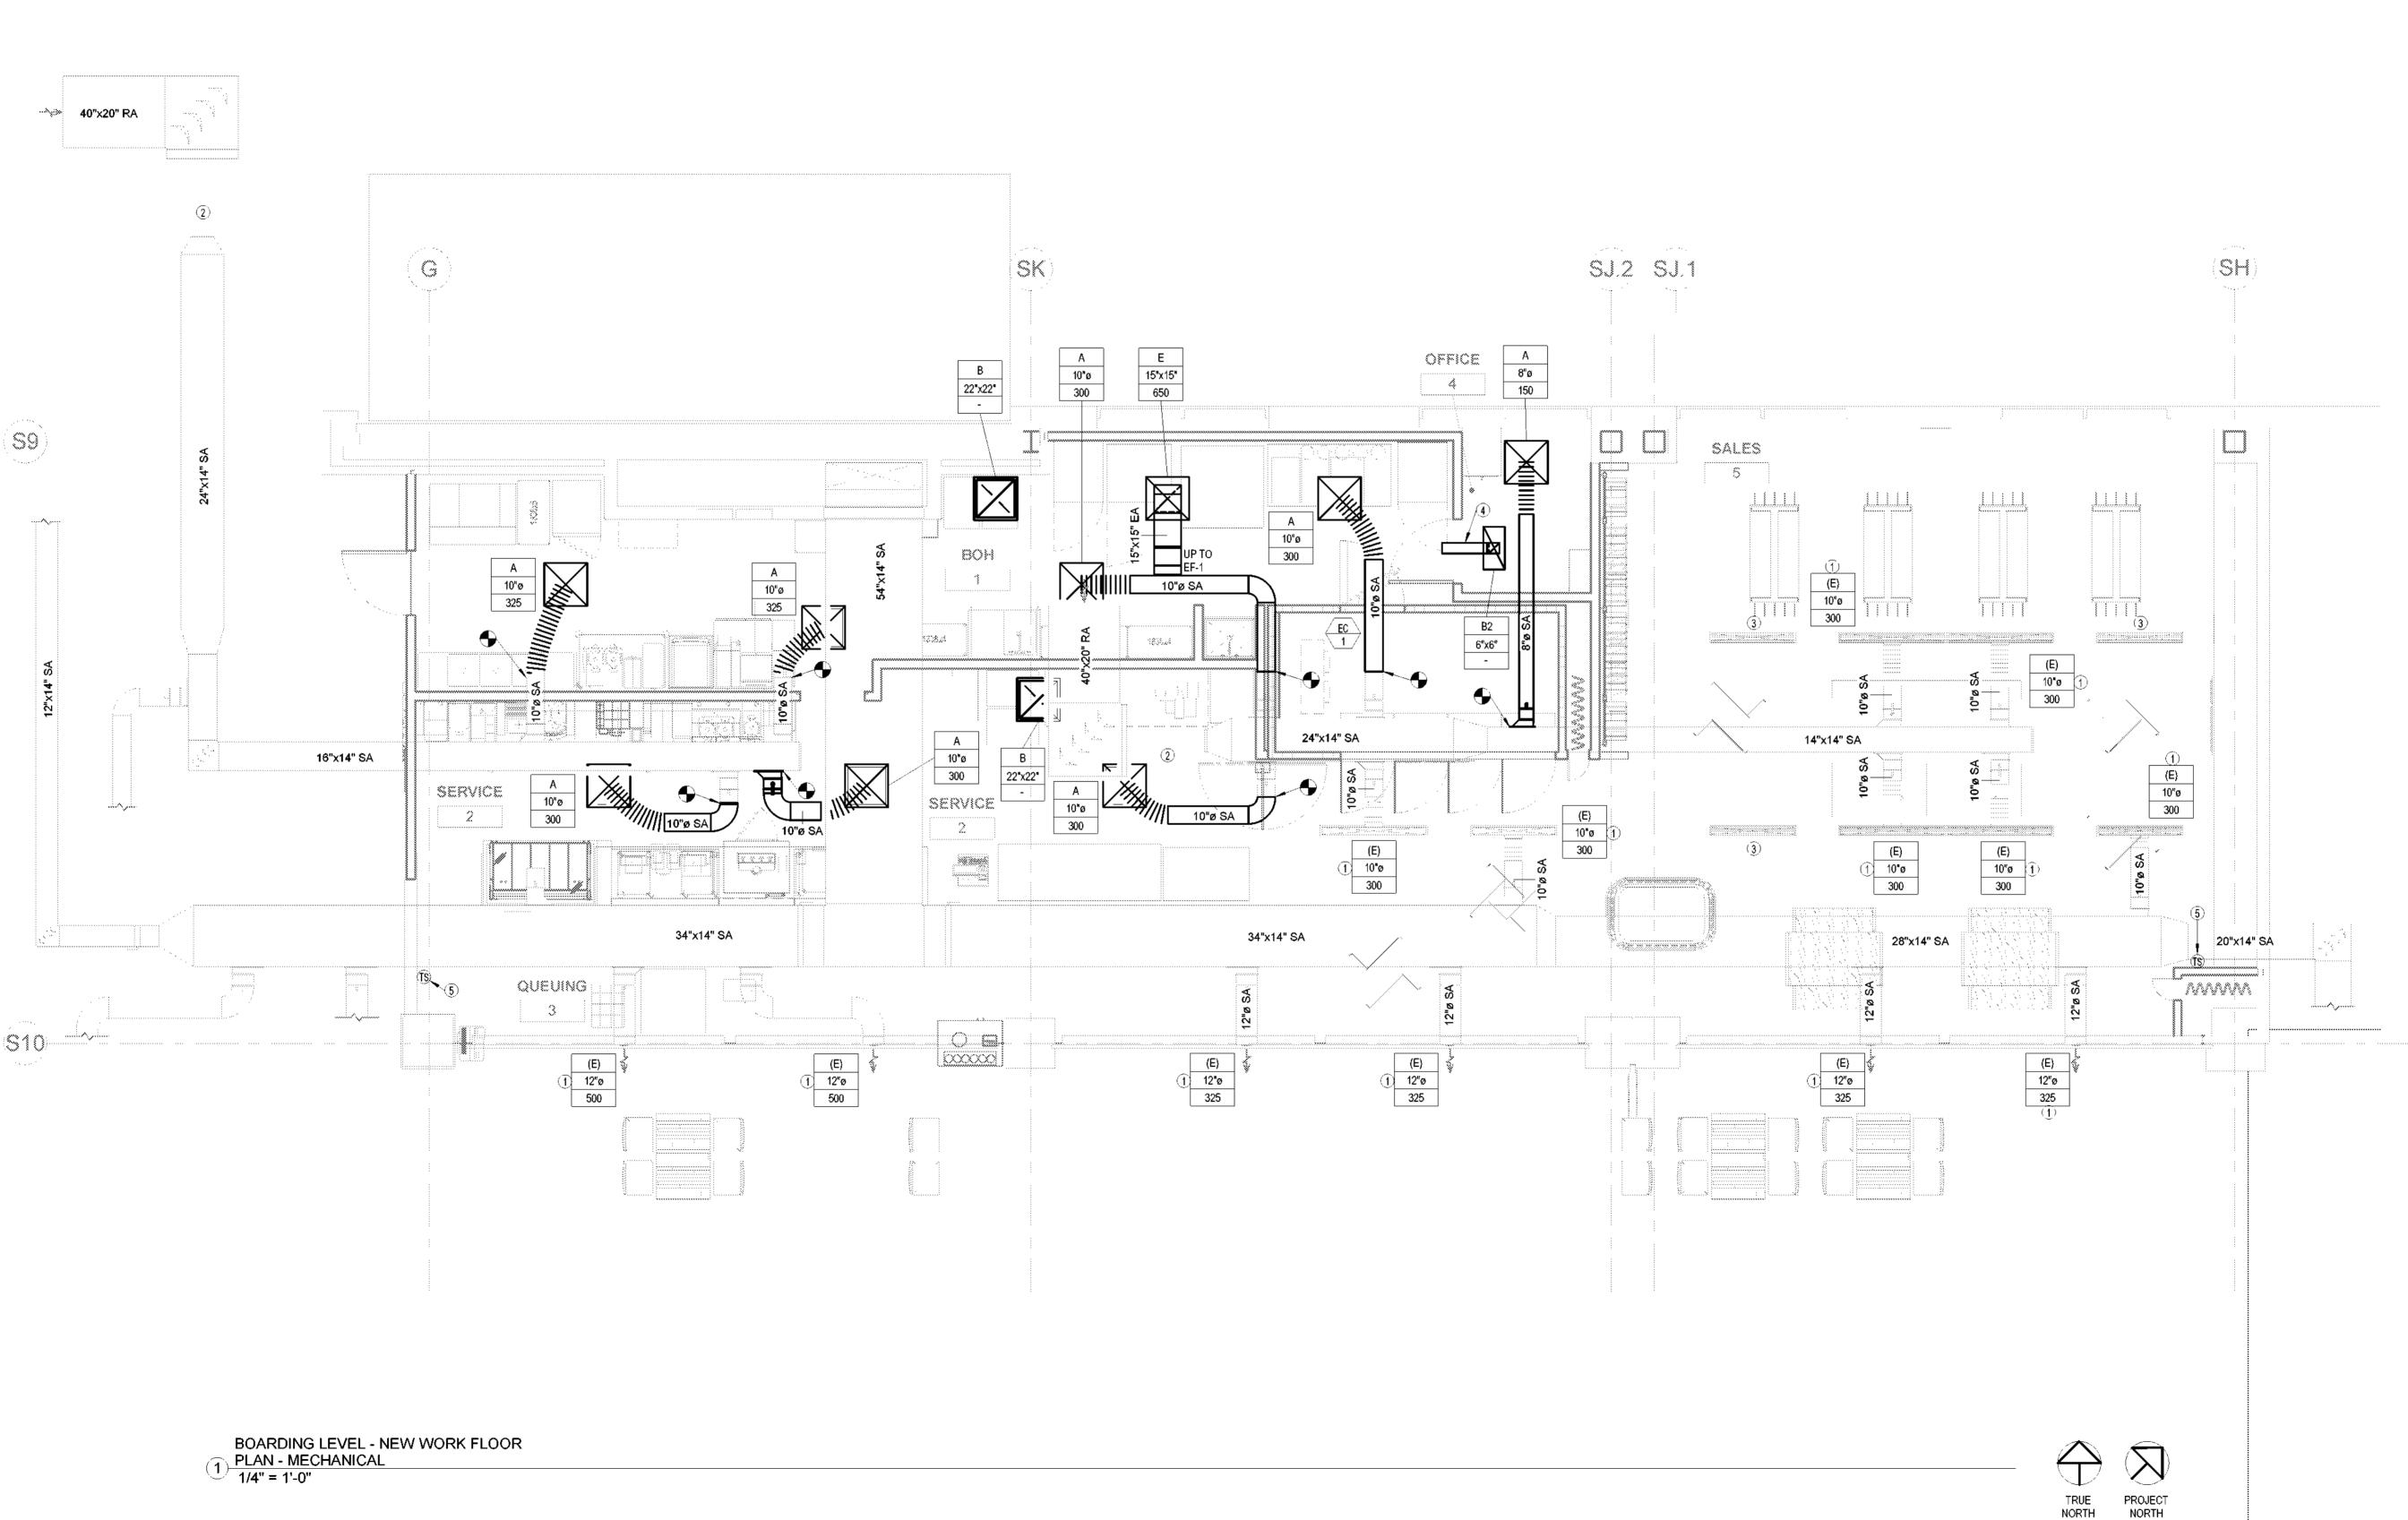

FLEXIBLE DUCT CONNECTION TO AIR

1 OUTLET/INLET 12" = 1'-0"

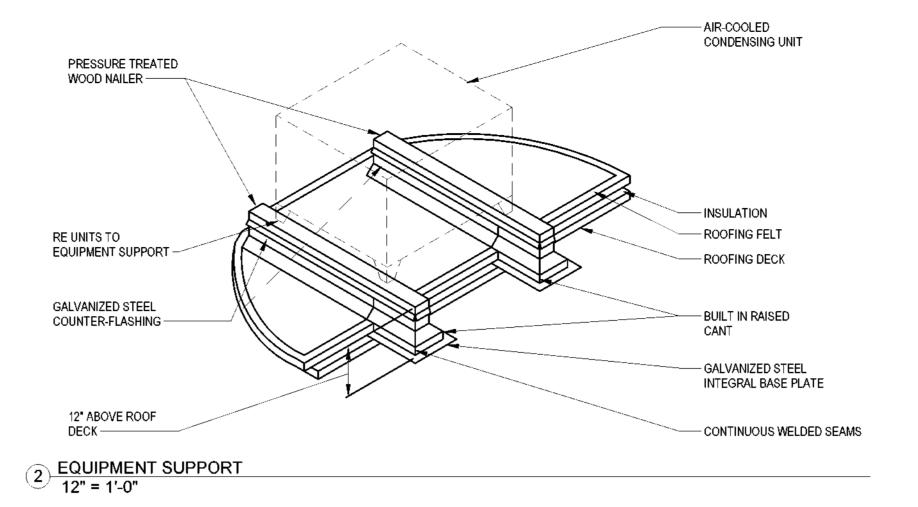

-RETURN BOOT TO BE

SUPPORTED FROM

STRUCTURE ABOVE

-SHEET METAL BOOT LINED WITH 1/2" 3 LB.

DENSITY ACOUSTICAL INSULATION

REFRIGERANT PIPE

1/4"x1-1/2" CAD.
PLATED LAG SCREWS


CAD. PLATED STEEL
ANCHOR STRAP W/
CAD. PLATED LAG
SCREWS AS REQ'D

1/4"x3" CAD. PLATED LAG
SCREWS AS REQ'D


1/4"x3" CAD. PLATED LAG
SCREWS

1/4"x3" CAD. PLATED LAG
SCREWS

3 REFRIGERENT PIPE SUPPORT DETAIL
12" = 1'-0"

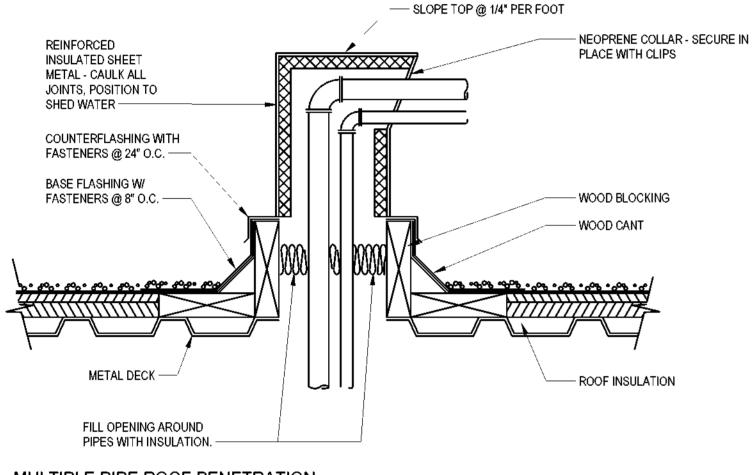

4 MULTIPLE PIPE ROOF PENETRATION
12" = 1'-0"

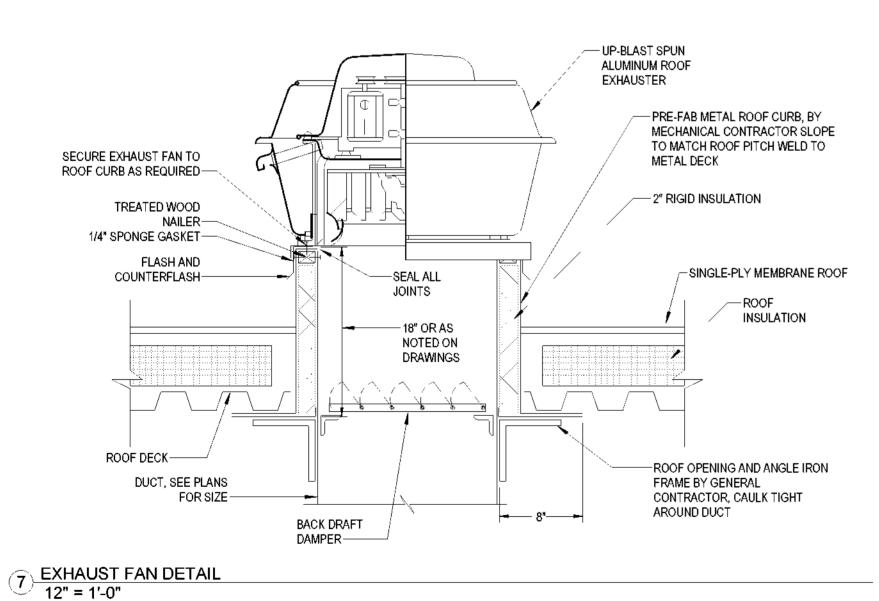

DUCT SAME SIZE AS


TERMINAL-

CEILING-

(5) RETURN BOOT DETAIL

RETURN AIR GRILLE

OR REGISTER-

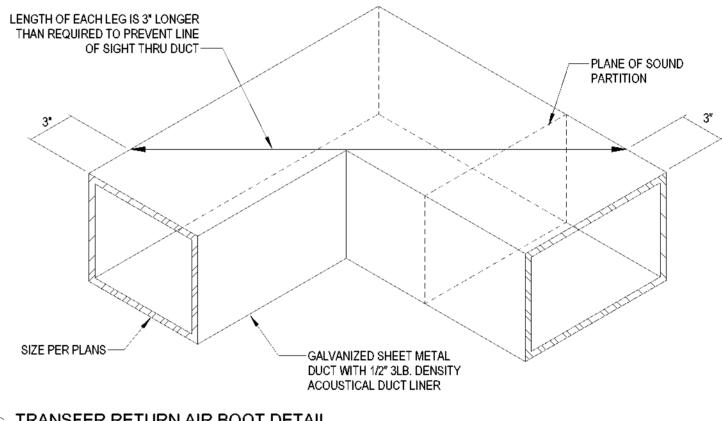

6 TRANSFER RETURN AIR BOOT DETAIL
12" = 1'-0"

SILHOUETTE

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1	60% SUBMITTAL	06/23/2023

SPACE: A, B, AND C

# MECHANICAL DETAILS

 Project number
 2023-019

 Date
 06-23-2023

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M500

Scale 12" = 1'-0"

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	BLOWER COIL SCHEDULE (BC)																		
TAG	MANUFACTURER	MODEL	DESIGN AIR	MAXIMUM WIDE	MOTOR	FAN RPM			HOT W	ATER COIL					CHILLED	WATER CO	) L		NOTES
			FLOW RATE (CFM)	OPEN PRESSURE DROP (IN W.C.)	HORSEPOWER		LAT (°F DB)	HEATING CAPACITY MBH	WATER FLOW (GPM)	ROWS	ENTERING WATER TEMP (°F DB)		LAT (°F DB)	COOLING CAPACITY MBH	WATER FLOW (GPM)	ROWS	ENTERING WATER TEMP (°F DB)	LEAVING WATER TEMP (°F DB)	
BCAHU-17	TRANE	BCHD072		0.5	3					2	150					4	44		1
BCAHU-18	TRANE	BCHD072		0.5	3					2	150					4	44		1
TOTAL	-	-	0	-	-		-	0.0	0.0	-	-	-	-	0.0	0.0	-	-	-	
NOTES: 1. UNIT IS EXIS	STING TO REMAIN. REB	ALANCE AIRFLO	W AND HYDRON	NIC FLOW AS NOTED	<b>)</b> .														

EXHAUST FAN SCHEDULE										
TAG	MANUFACTURER	MODEL	TYPE	СҒМ	ESTIMATED ESP (IN W.G.)	E	LECTRICAL		RPM	NOTES
					17.0.,	VOLTAGE	PHASE	HP		
EF-1	COOK	ACRUD 101R15D	ROOF UPBLAST	650	0.250	120	1	1/8	1550	1,2,3,4
2. PROVIDE										

SUMMER	INSIDE TEMPERATURE/HUMIDITY	74°F DB/50% RH
SUMIMER	OUTSIDE TEMPERATURE	92°F DB/76°F WB*
WINTER	INSIDE TEMPERATURE	70°F DB
VVINTER	OUTSIDE TEMPERATURE	26°F DB *
	WALL U-VALUE	0.078 BTU/(hxFT.SQ.x°F)
	WINDOW U-VALUE	0.5 BTU/(hxFT.SQ.x°F)*
	ROOF U-VALUE	0.040 BTU/(hxFT.SQ.x°F)
	SHADING COEFFICENT	0.29*1

TAG	MANUFACTURER	MODEL	TYPE	FACE SIZE	NOTES
Α	TITUS	PAS	PERFORATED SUPPLY DIFFUSER	24×24	1,2
B1	TITUS	PAR	CEILING PERFORATED RETURN GRILLE	24x24	1
B2	TITUS	PAR	CEILING PERFORATED RETURN GRILLE	12x24	1
С	TITUS	300RL	WALL-MOUNTED SUPPLY GRILLE	(SEE DWGS)	1,3
D	TITUS	350RL	WALL-MOUNTED RETURN GRILLE	(SEE DWGS)	1,3
TES					

4. PROVIDE WITH BACKDRAFT DAMPER AND BIRD SCREEN.

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# **MECHANICAL** SCHEDULES


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Date	06-23-2023
Drawn by	Author
Checked by	LU

Scale

M600

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WILMINGTON INTERNATIONAL AIRPORT 1740 AIRPORT BLVD, WILMINGTON, NC, 28405 BOARDING LEVEL, ZONE 1 SPACE: A, B, AND C

No.	Description	Date
1	60% SUBMITTAL	06/23/2023
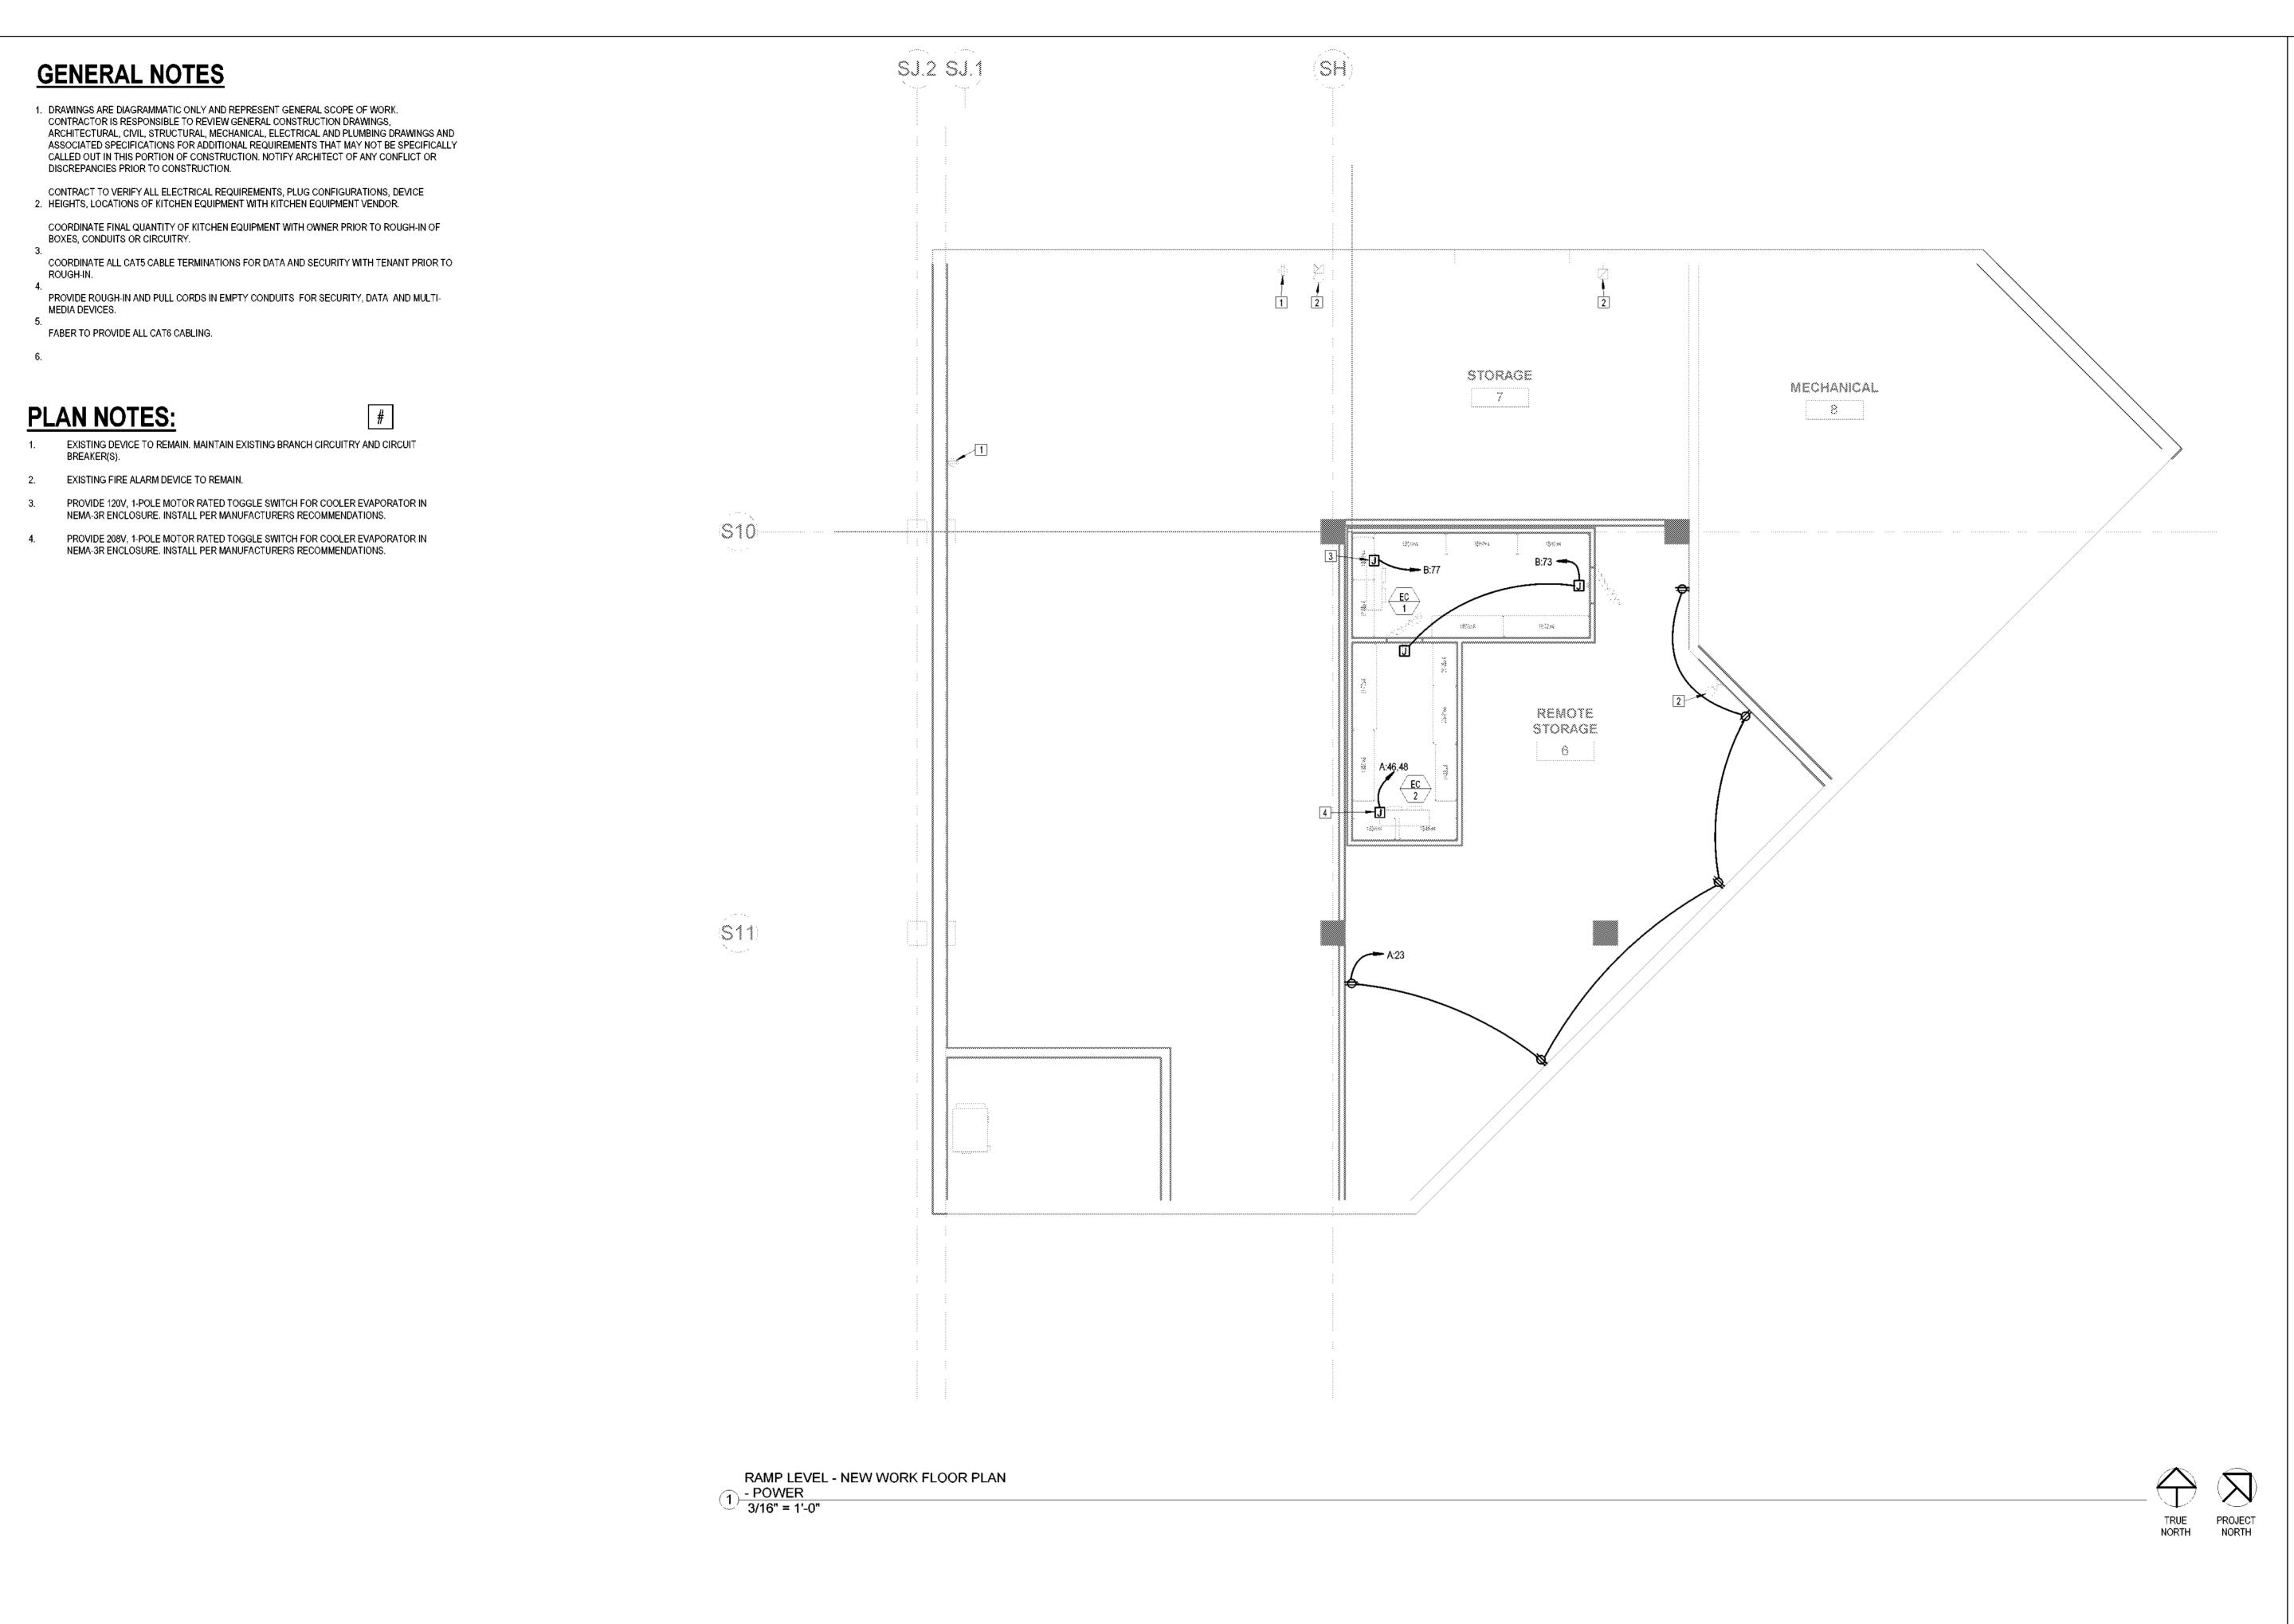
# POWER FLOOR PLAN - RAMP LEVEL

 Project number
 2023-019

 Date
 06-23-2023


 Drawn by
 Author

 Checked by
 LU

E100

Scale

As indicated

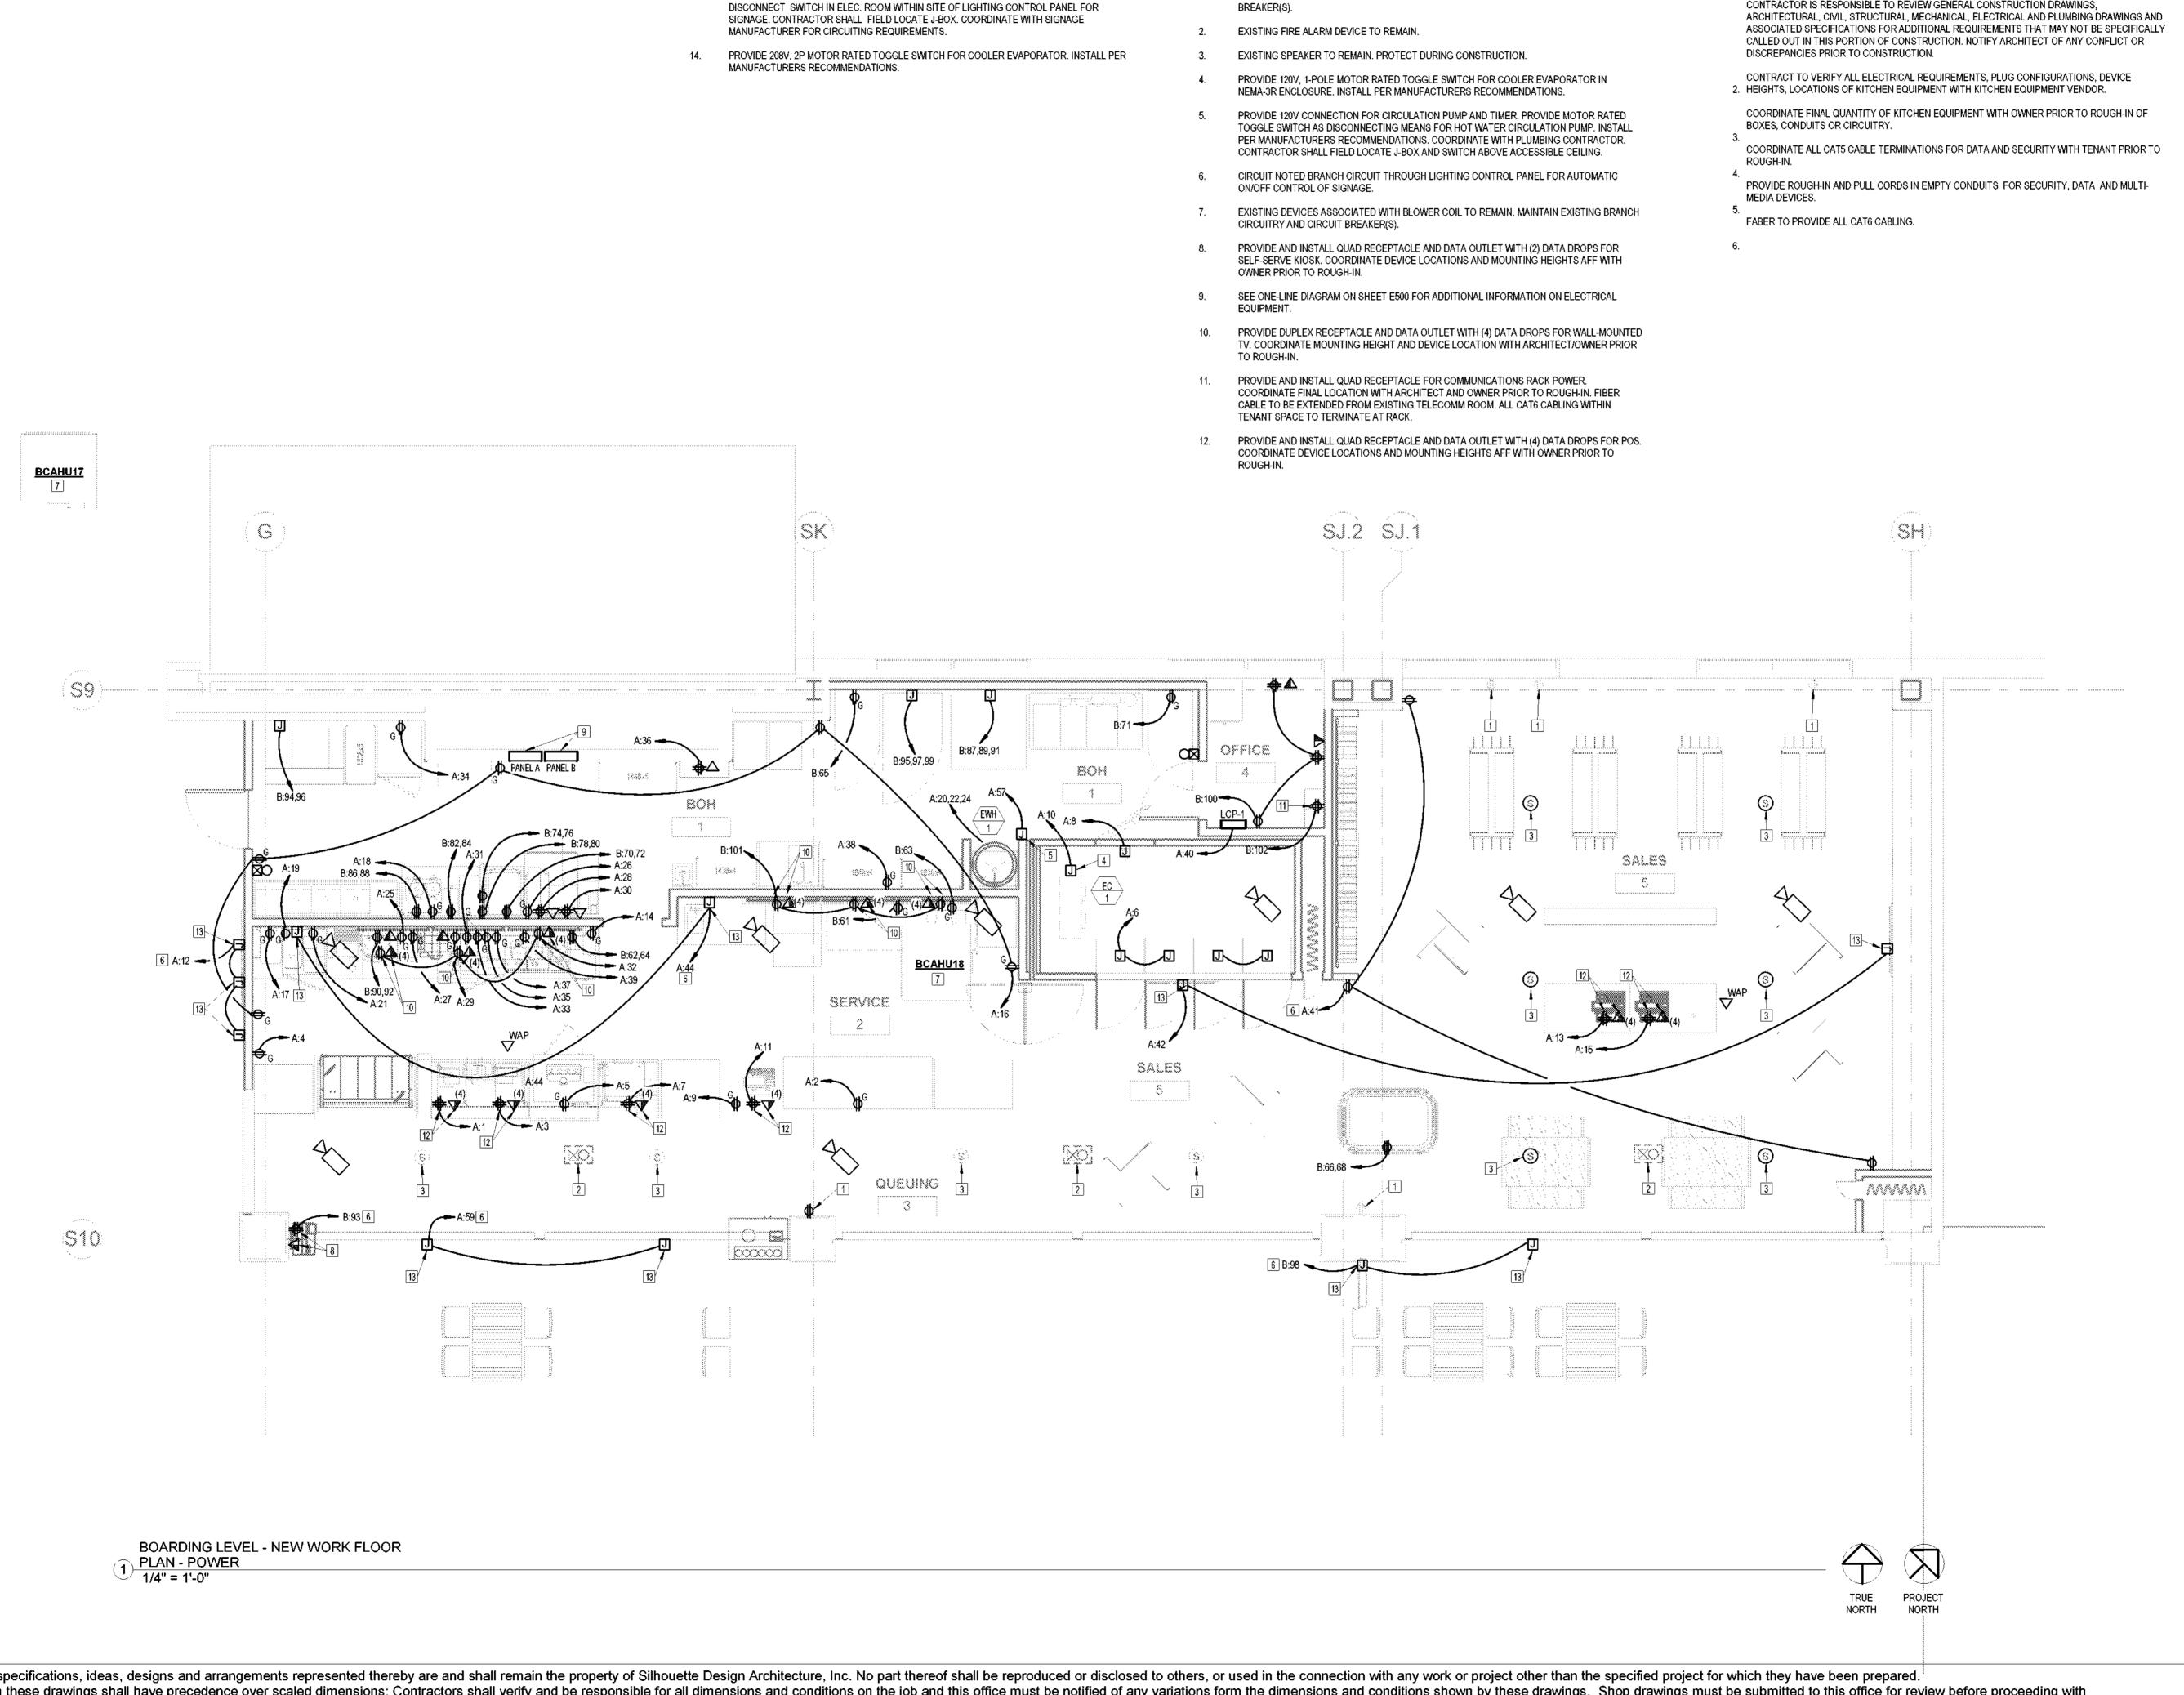

**PLAN NOTES:** 

EXISTING DEVICE TO REMAIN. MAINTAIN EXISTING BRANCH CIRCUITRY AND CIRCUIT

**PLAN NOTES:** 

PROVIDE J-BOX IN CONCEALED LOCATION AND PROVIDE CONNECTION TO LOCKABLE

#### **GENERAL NOTES**

1. DRAWINGS ARE DIAGRAMMATIC ONLY AND REPRESENT GENERAL SCOPE OF WORK. CONTRACTOR IS RESPONSIBLE TO REVIEW GENERAL CONSTRUCTION DRAWINGS, ARCHITECTURAL, CIVIL, STRUCTURAL, MECHANICAL, ELECTRICAL AND PLUMBING DRAWINGS AND

> DANS AR Faber, Coe & Gregg of Florida, Inc. 550 Meadowlands Parkway Secaucus, New Jersey 07094

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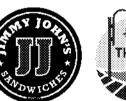
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WILMINGTON INTERNATIONAL AIRPORT 1740 AIRPORT BLVD, WILMINGTON, NC, 28405 BOARDING LEVEL, ZONE 1 SPACE: A, B, AND C

1 60% SUBMITTAL 06/23	No.	Description	Date
	1	60% SUBMITTAL	06/23/2023

#### POWER FLOOR PLAN - BOARDING **LEVEL**


2023-019 Project number 06-23-2023 Drawn by

E101

1/4" = 1'-0"

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	CONDUCTOR SCHEDULE										
TAG	MAX OCP	<u>SETS</u>	PHASE CONDUCTORS	GROUND CONDUCTOR	CONDUIT	<u>NOTES</u>					
400-4	?	?	?	?	?						
200-3	?	?	?	?	?						

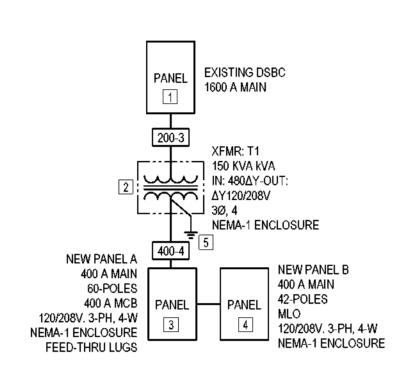

1 ELECTRICAL ONE-LINE 12" = 1'-0"

#### **PLAN NOTES:**

#

- NEW 400-AMP, 3-POLE BREAKER TO BE PROVIDED AND INSTALLED IN EXISTING PANELBOARD DSBC BY ELECTRICAL CONTRACTOR.
- PROVIDE NEW 150KVA DRY-TYPE TRANSFORMER IN NEMA-1 ENCLOSURE. INSTALL SUSPENDED OR PAD-MOUNTED IN SOURCE ELECTRICAL ROOM.
- PROVIDE 400 AMP, 60-POLE, 120/208V, 3-PHASE, 4-WIRE PANELBOARD WITH 400 AMP MAIN CIRCUIT BREAKER AND FEED-THRU LUGS. PROVIDE PANELBOARD WITH SOLID NEUTRAL. SEE PANELBOARD SCHEDULE ON SHEET E600 FOR ADDITIONAL INFORMATION.
- PROVIDE 400 AMP, 42-POLE, 120/208V, 3-PHASE, 4-WIRE PANELBOARD WITH MAIN LUGS ONLY. PROVIDE PANELBOARD WITH SOLID NEUTRAL. SEE PANELBOARD SCHEDULE ON SHEET E600 FOR ADDITIONAL INFORMATION.
- 5. PROVIDE #4 AWG CU GROUND AND CONNECT TO EXISTING MAIN GROUND BAR.

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BOARDING LEVEL, ZONE 1 SPACE: A, B, AND C

## ELECTRICAL **DETAILS**

2023-019 Project number 06-23-2023 Author Drawn by Checked by

E500

12" = 1'-0" Scale

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#### **Branch Panel: A**

Location: Supply From: Mounting: Surface Enclosure: Type 1

Volts: 120/208 (3Ø-4W) Phases: 3 Wires: 4

A.I.C. Rating: Mains Type: MCB Mains Rating: 225 A MCB Rating: 100 A

CKT	Circuit Description	Trip	Poles	/	A	В		(		Poles	Trip	Circuit Description	СКТ	
1	POS SYSTEM	20 A	1	360 VA	1596					1	20 A	REFRIGERATRED PREP TABLE	2	
3	POS SYSTEM	20 A	1			360 VA 4	80 VA			1	20 A	GRAB N GO	4	
5	REFRIGERATOR	20 A	1					780 VA	160 VA	1	20 A	WALK IN COOLER LTG.	6	
7	VDU	20 A	1	360 VA	500 VA					1	20 A	WALK IN COOLER	8	1
9	GRAB N GO	20 A	1			480 VA 1	00 VA			1	15 A	WALK IN COOLER EVAP. COIL	10	1
11	POS SYSTEM	20 A	1					360 VA	900 VA	1	20 A	SIGNAGE	12	2
13	POS SYSTEM	20 A	1	360 VA	1320					1	20 A	MULTI HOPPER GRINDER	14	
15	POS SYSTEM	20 A	1			360 VA 1	1080			1	20 A	CONVENIENCE RECEPT.	16	
17	HOT CHOCOLATE DISPENSER	20 A	1					1215	216 VA	1	20 A	DAIRY DISPENSER	18	
19	FROZEN BEVERAGE DISPENSER	20 A	1	1215	6000								20	
21	TOP REFRIGERATOR	20 A	1			504 VA 6	3000			3	70 A	ELECTRIC WATER HEATER EWH-1	22	1
23	REMOTE STORAGE RECEPT.	20 A	1					900 VA	6000				24	1
25	VDU	20 A	1	40 VA	996 VA					1	20 A	PRODUCT HOLDING UNIT	26	
27	DAIRY DISPENSER	20 A	1			220 VA 3	60 VA			1	20 A	VDU	28	
29	PRINTER	20 A	1					2400	360 VA	1	20 A	PRINTER	30	
31	SUGAR DISPENSER	20 A	1	60 VA	540 VA					1	20 A	DUNKING MENU SCREENS	32	
33	DAIRY DISPENSER	20 A	1			220 VA 5	04 VA			1	20 A	REFRIGERATOR	34	
35	UNDERCOUNTER REFRIGERATOR	20 A	1					480 VA	360 VA	1	20 A	PHONE BOARD	36	
37	COFFEE / TEA BREWER	20 A	1	1220	220 VA					1	20 A	FUTURE SLICER	38	
39	BEVERAGE DISPENSER	20 A	1			220 VA 5	00 VA			1	20 A	LIGHTING CONTROL PANEL LCP-1	40	
41	CONVENIENCE RECEPT.	20 A	1					540 VA	600 VA	1	20 A	SIGNAGE	42	2
43	EXHAUST FAN EF-1	20 A	1	0 VA	600 VA					1	20 A	SIGNAGE	44	_
45	WALK IN COOLED CONDENSED WOLLS	20.4				1830 5	58 VA			_	20.4	EREZER EMARORATOR EG O	46	
47	WALK-IN COOLER CONDENSER WCU-3	30 A	2					1830	58 VA	2	20 A	FREEZER EVAPORATOR EC-2	48	11
49	MALK IN CONDENSED MOULA	20.4		1571									50	1
51	WALK-IN CONDENSER WCU-1	20 A	2			1571							52	1
53	MALK IN COMPENCED WOLLS	20.4	_					1831					54	1
55	WALK-IN CONDENSER WCU-2	30 A	2	1831									56	
57	HOT WATER RECIRC. PUMP HWP-1	20 A	1			150 VA							58	1
59	SIGNAGE	20 A	1					0 VA					60	1
		4459	7 VA	36166	VA	4336	6 VA							

Load Classification	Connected Load	Demand Factor	Estimated Demand	Panel	Totals
Other	39977 VA	100.00%	39977 VA		
LIGHTING	660 VA	125.00%	825 VA	Total Conn. Load:	123629 VA
MOTORS	10612 VA	100.00%	10612 VA	Total Est. Demand:	101856 VA
KITCHEN - COMMERCIAL	62681 VA	65.00%	40743 VA	Total Conn.:	343 A
RECEPTACLE	4680 VA	100.00%	4680 VA	Total Est. Demand:	283 A
KIT	2704 VA	100.00%	2704 VA		
MISC EQUIP	2100 VA	100.00%	2100 VA		

# **GENERAL NOTES**

*PANEL SHALL HAVE LOCKABLE HINGED DOOR

1. PROVIDE TYPE WRITTEN PANEL DIRECTORIES AND INSERT IN CLEAR PLASTIC COVER ON INSIDE

**CIRCUIT BREAKERS USED FOR PROTECTION OF HVAC EQUIPMENT SHALL BE HACR TYPE BREAKERS.

***PROVIDE UP TO 65,000 RMS SYMMETRICAL AMPS. COORDINATE WITH LOCAL UTILITY COMPANY FOR AVAILABLE RMS SYMMETRICAL AMPS.

#### PANELBOARD SCHEDULE NOTES

- 1 PROVIDE LOCK-ON TYPE BREAKER.
- 2 ROUTE BRANCH CIRCUIT THROUGH LIGHTING CONTROL PANEL FOR AUTOMATIC ON/OFF
- 3 PROVIDE GFCI TYPE BREAKER.

#### **Branch Panel: B** Location:

Supply From: A Phases: 3 Mounting: Surface Wires: 4 Enclosure: Type 1

Volts: 120/208 (3Ø-4W)

A.I.C. Rating: Mains Type: MCB Mains Rating: 225 A MCB Rating: 100 A

СКТ	Circuit Description	Trip	Poles	/	4	В	3	_ c	;	Poles	Trip	Circuit Description	СКТ
61	REFRIGERATED PREP TABLE	20 A	1	1596	1008					,	30 A	COFFEE PREMER*	62
63	SLICER	20 A	1			552 VA	1008			2	30 A	COFFEE BREWER*	64
65	REACH IN REFRIGERATOR	20 A	1					516 VA	3120	2	20 A	KITCHEN - COMMERCIAL	66
67					3120					4	20 A	KITCHEN - COWINERCIAL	68
69							1352			2	20 A	TOASTER*	70
71	RECEPTACLE	20 A	1					504 VA	1352		20 A	IOASTER	72
73	WALK IN COOLER / FREEZER LTG.	20 A	1	0 VA	2995					2	40 A	RAPID COOK OVEN*	74
75							2995			_	40 A	RAPID COOK OVEN	76
77	COOLER EVAP. COIL	20 A	1					100 VA	2995	2	40 A	RAPID COOK OVEN*	78
79	BOH LIGHTING	20 A	1	273 VA	2995						40 A	KAPID COOK OVEN	80
81	SERVICE LIGHTING	20 A	1			70 VA	2059			2	30 A	ICED COFFEE BREWER*	82
83	QUEUING / SALES LIGHTING	20 A	1					0 VA	2059		30 A	ICED COFFEE BREWER	84
85	REMOTE STORAGE LIGHTING	20 A	1	300 VA	1747					2	30 A	COFFEE BREWER*	86
87						4988	1747			4	30 A	COFFEE BREVVER	88
89	VENTLESS CONVECTION OVEN	30 A	3					4988	2704	2	40 A	ESPRESSO MACHINE*	90
91	1			4988	2704					4	40 A	ESPRESSO MACHINE	92
93	KIOSK	20 A	1			360 VA	1056			_	20.4	ICE MAKED*	94
95								4083	1056	2	20 A	ICE MAKER*	96
97	OVEN / BREAD PROOFER	40 A	3	4083	0 VA					1	20 A	SIGNAGE	98
99	1					4083	900 VA			1	20 A	OFFICE RECEPT.	100
101	JIMMY JOHNS MENU SCREENS	20 A	1					540 VA	360 VA	1	20 A	DATA RACK	102
		Tota	al Load:	2580	9 VA	21170	0 VA	2437	7 VA				
		Tota	l Amps:	219	9 A	176	6 A	207	7 A	,			

Load Classification	Connected Load	Demand Factor	Estimated Demand	Panel	Totals
Other	4531 VA	100.00%	4531 VA		
KITCHEN - COMMERCIAL	62581 VA	65.00%	40678 VA	Total Conn. Load:	71356 VA
RECEPTACLE	1440 VA	100.00%	1440 VA	Total Est. Demand:	49453 VA
KIT	2704 VA	100.00%	2704 VA	Total Conn.:	198 A
				Total Est. Demand:	137 A

*PANEL SHALL HAVE LOCKABLE HINGED DOOR **CIRCUIT BREAKERS USED FOR PROTECTION OF HVAC EQUIPMENT SHALL BE HACR TYPE BREAKERS.

Circuit		3 Pt	nase W/ N	eutral				3 Phase			1 Phase					
Breaker			3 Pole			3 Pole					2 F	Pole or 1 F	ole			
Size (Amps)	No. of Cond.	Hot	No. of Cond.	Ground	Conduit (Inches)	No. of Cond.	Hot	No. of Cond.	Ground	Conduit (Inches)	No. of Cond.	Hot	No. of Cond.	Ground	Conduit (Inches)	
15	4	12	1	12	1/2	3	12	1	12	1/2	2	12	1	12	1/2	
20	4	12	1	12	1/2	3	12	1	21	1/2	2	12	1	12	1/2	
25	4	10	1	10	1/2	3	10	1	10	1/2	2	10	1	10	1/2	
30	4	10	1	10	1/2	3	10	1	10	1/2	2	10	1	10	1/2	
40	4	8	1	10	3/4	3	8	1	10	1/2	2	8	1	10	1/2	
50	4	6	1	10	3/4	3	6	1	10	3/4	2	6	1	10	3/4	
60	4	4	1	10	1	3	4	1	10	1	2	4	1	10	3/4	
70	4	4	1	8	1	3	4	1	8	1	2	4	1	8	3/4	
80	4	3	1	8	1-1/4	3	3	1	8	1	2	3	1	8	1	
90	4	2	1	8	1-1/4	3	2	1	8	1	2	2	1	8	1	
100	4	1	1	8	1-1/4	3	2	1	8	1-1/4	2	2	1	8	1-1/4	
110	4	1	1	6	1-1/4	3	1	1	7	1-1/4	2	1	1	6	1-1/4	
125	4	1	1	6	1-1/4	3	1	1	6	1-1/4	2	1	1	6	1-1/4	
130	4	1	1	6	1-1/4	3	1	1	6	1-1/2	2	1	1	6	1-1/4	
140	4	1/0	1	6	1-1/2	3	1/0	1	6	1-1/4	2	1/0	1	6	1-1/4	
150	4	1/0	1	6	1-1/2	3	1/0	1	6	1-1/4	2	1/0	1	6	1-1/4	
160	4	2/0	1	6	2	3	2/0	1	6	1-1/4	2	2/0	1	6	1-1/4	
170	4	2/0	1	6	2	3	2/0	1	6	1-1/2	2	2/0	1	6	1-1/4	
180	4	3/0	1	6	2	3	3/0	1	6	1-1/2	2	3/0	1	6	1-1/2	
190	4	3/0	1	6	2	3	3/0	1	6	1-1/2	2	3/0	1	6	1-1/2	
200	4	3/0	1	6	2	3	3/0	1	6	1-1/2	2	3/0	1	6	1-1/2	

***PROVIDE UP TO 65,000 RMS SYMMETRICAL AMPS. COORDINATE WITH LOCAL UTILITY COMPANY FOR AVAILABLE RMS SYMMETRICAL AMPS.

- 1 FOR EACH CIRCUIT, SIZE THE WIRE BASED ON CIRCUIT BREAKER SIZE SHOWN IN THE PANELBOARD SCHEDULES AS INDICATED ABOVE (UNLESS NOTED
- 2 HOT AND NEUTRAL CONDUCTOR SIZING IS BASED ON TABLE 310.16, COPPER CONDUCTORS. 3 GROUND CONDUCTOR SIZING IS BASED ON TABLE 250.122, COPPER GROUND CONDUCTOR.
- 4 CONDUIT SIZING IS BASED ON (EMT) WITH TYPE THHN/THWN CONDUCTOR INSULATION.

	LIGHT FIXTURE SCHEDULE										
TYPE	MANUEL OTHER	MODEL MUMBER	\\\\\\\\\\\\\\\\\\\\\\\\\\\\\\\\\\\\\\	LAMP	VOLTA OF	EINIOLI	4401/1/1710	DECORURTION			
MARK	MANUFACTURER	MODEL NUMBER	WATTAGE	TYPE	VOLTAGE	FINISH	MOUNTING	DESCRIPTION			
Α	TCP	2X4 TROFFER, 39W, 3000K, COLOR: WHITE, TCP-DTF4UZD3930K	39.0 VA	LED	120V	WHITE	RECESSED	2' X 4' TROFFER PANEL			
A1	GREEN CREATIVE	3000K, SUSPENDED LIGHT, ORDER WITH SUSPCABLE24 ACCESSORY	30.0 VA	LED	120V	WHIYTE	SUSPENDED	2'x4' SUSPENDED PANEL			
В	NORA LIGHTING	NIO-4RNDC-30X (3000K)-WW WHITE/WHITE / 10 / 14W, NEW CONSTRUCTION	14.0 VA	LED	120V	WHITE	RECESSED	4" ROUND DOWNLIGHT			
С	PINNACLE ARCHITECTURAL LIGHTING	EDGE EX3, 3" SUSPENDED DIRECT LINEAR 96" LENGTH, 80 CRI 830 HE, 3000K. FINISH: RAL 2003	0.0 VA	LED	120V	RAL 2003	SUSPENDED	8' SUSPENDED LINEAR LED FIXTURE.			
C1	PINNACLE ARCHITECTURAL LIGHTING	EDGE EX3, 3" SUSPENDED DIRECT LINEAR 96" LENGTH, 80 CRI 830 HE, 3000K. FINISH: RAL 9004	0.0 VA	LED	120V	RAL 9004	SUSPENDED	8' SUSPENDED LINEAR LED FIXTURE.			
Х	COOPER LIGHTING	ESR6170RC	3.9 VA	LED	120V	ANODIZED ALUMINUM	WALL/CEILING	EXIT LIGHT			

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SPACE: A, B, AND C



No.	Description	Date
1	60% SUBMITTAL	06/23/202

## ELECTRIAL SCHEDULES

2023-019 Project number 06-23-2023 Drawn by Checked by

E600

1/4" = 1'-0" Scale

#### LIGHTING CONTROL PANEL SCHEDULE

LCP NAME:		LCP-1		
LOCATION:		OFFICE 4	<u>1</u>	
SURFACE/FLUSH:		SURFACE		
POWER CIRCUIT:		<u>A:40</u>		
RELAY#	CIRCUIT	DESCRIPTION	LV SWITCH/SENSOR	CHANNEL
1	B:79	KITCHEN LIGHTING		Н
2	B:81	SERVICE LIGHTING		Н
3	B:83	QUEUING/RETAIL LIGHTING		Н
4	A:59	SIGNAGE		Н
5	B:98	SIGNAGE		Н
6	A:41	SIGNAGE		Н
7	A:44	SIGNAGE		Н
8		SPARE		

		LCP CHANNEL AUTOMATION SCHEDULE		
CHANNEL	SCENARIO	SCENARIO TIMES	BLINK	TIME DELAY
Α	1	OFF 11:00PM		
В	2	10:00AM - 10:00PM		2 HOURS
С	5	*		2 HOURS
D	6	DUSK - 12:00AM		
E	6	DUSK - DAWN		
F	7	6:00AM - 6:00PM		
G	8	TBD - ON 24/7/365 INITIALLY		
Н	1	OWNER DETERMINED		

#### NOTE TO ELECTRICAL CONTRACTOR ON PROGRAM SCHEDULING:

FINAL TIME SCHEDULES SHALL BE VERIFIED WITH OWNER'S REPRESENTATIVE NOT TO EXCEED 30-MIN BEFORE OPENING OR 30-MIN AFTER CLOSING SCHEDULE TO MEET IECC MANDATORY CONTROL MEASURES.

SCENARIO LISTING:

(1) MANUAL ON/SCHEDULE OFF

(2) SCHEDULE ON/OFF
(3) MANUAL ON/AS SWITCH OFF (FOR USE WITH AS-100...

(4) PHOTOCELL ON/OFF

(5) PHOTO & SCHEDULE ON/OFF

(6) ASTRONOMIC ON/OFF

LIGHTING CONTROL PANEL SPECIFICATIONS:

PROVIDE A SINGLE RELAY PANEL WITH UP TO 8 RELAYS. EACH RELAY TO BE INDIVIDUALLY SCHEDULED THROUGH AN EASY TO USE INTEGRAL CLOCK WITH A BACKLIT 8-LINE LCD DISPLAY. RELAYS ARE TO BE SPST 20 AMP RATED, MECHANICALLY HELD CONTACTORS CAPABLE OF SWITCHING EITHER 120 OR 277VAC LOADS. MOUNTED NEXT TO EACH RELAY SHOULD BE A LED TO ANNUNCIATE STATUS AND A PUSHBUTTON TO TOGGLE THE RELAY'S STATE. PANEL SHALL HAVE A MULTITAP TRANSFORMER AND ACCEPT EITHER 120V OR 277V FOR POWER.

PANEL ENCLOSURE TO BE NEMA 1, RATED FOR ENVIRONMENTS FROM 32 - 112 DEGREES FAHRENHEIT, 10 - 90% RELATIVE HUMIDITY NON-CONDENSING. PANEL TO COME WITH A SPLIT COVER HINGED IN THE CENTER SUCH THAT THE HIGH VOLTAGE SIDE MUST BE UNSCREWED TO ACCESS THE RELAYS, BUT THE LOW VOLTAGE SIDE CAN BE OPENED VIA A LOCKING LATCH. SURFACE OR FLUSH COVERS SHALL BE AVAILABLE.

EACH RELAY CAN BE CONTROLLED REMOTELY BY EXTERNAL SWITCHES OR MOTION DETECTORS. SWITCHES CAN BE 2- OR 3-WIRE, MOMENTARY OR MAINTAINED LOW VOLTAGE DEVICES. MOTION DETECTORS MUST PROVIDE A 24VDC PILOT SIGNALTO CONTROL THE RELAYS. PANEL MUST BE ABLE TO INTERLOCK TIME BASED SCHEDULES WITH THE OCCUPANCY SENSOR INPUT, SO THAT LIGHTS SCHEDULED ON DURING THE DAY ARE NOT AFFECTED BY THE MOTION DETECTOR, BUT AFTER HOURS THE OCCUPANCY SENSOR HAS CONTROL OF THE RELAY. PANEL SHALL BE CAPABLE OF BLINK WARNING BEFORE "OFF" AND TRUE AFTER HOURS TIME DELAY.

ALL PROGRAMMING TO BE ENTERED VIA A SIMPLE KEYPAD. EACH RELAY CAN BE PROGRAMMED INDEPENDENTLY, OR RELAYS CAN BE GROUPED TOGETHER IN FIRMWARE TO FOLLOW THE SAME CHANNEL SCHEDULE. ON A DAILY 7-DAY REPEATING BASIS, RELAYS CAN BE ASSIGNED TO FOLLOW ANY OF THE FOLLOWIN...

(1) MANUAL ON/SCHEDULE OFF (2) SCHEDULE ON/OFF

(3) MANUAL ON/AS SWITCH OFF (FOR USE WITH AS-100 SWITCHES)

(4) PHOTOCELL ON/OFF

(5) PHOTO & SCHEDULE ON/OFF (6) ASTRONOMIC ON/OFF

(7) ASTRONOMIC AND SCHEDULE ON/OFF

THE LCD SCREEN SHOULD NORMALLY SHOW THE CURRENT TIME AND DATE, AS WELL AS SUNRISE AND SUNSET TIMES FOR THAT DAY. RELAY CHANNELS CAN ALSO BE MONITORED FROM THE DISPLAY TO SEE THEIR STATUS. EITHER ON, OFF, OR MIXED. ADDITIONALLY, THE RELAY GROUPS CAN BE OVERRIDDEN FROM THE SCREEN. CONTEXT SENSITIVE HELP SHALL BE AVAILABLE FOR EACH SCREEN.

PANEL TO BE WATTSTOPPER'S LP8 PEANUT PANEL (OR APPROVED EQUAL) AND MUST BE UL LISTED 916, MEET LOCAL ENERGY CODES (IECC 2012) AND HAVE A 5 YEAR LIMITED WARRANTY.

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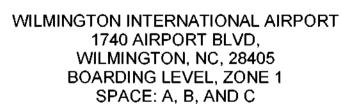
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# ELECTRICAL SCHEDULES

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Scale

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