


EXTERIOR

BRICK VENEER
 AIR SPACE (1" MIN.)
 R-7.5 EXTRUDED POLYSTYRENE INSULATION
 AIR BARRIER MEMBRANE
 5/8" EXTERIOR SHEATHING
 6" METAL STUD
 R-19 MIN BATT INSULATION
 5/8" GYPSUM BOARD
 MASONRY ANCHOR @ 16" O.C. VERT AND 24" HORIZ.

1'-2 5/8"
 8" MAX (TYP)
 6 5/8"
 REF
 FACE OF BRICK
 FACE OF STUD
 FACE OF GWS

F	METAL STUD FURRED - ONE LAYER
----------	--------------------------------------


3A	3 5/8" METAL STUD, NON-RATED, GWB 6" ABOVE CLG W/SOUND ATTENUATION BLANKET
3AS	3 5/8" METAL STUD, NON-RATED, EXTEND TO DECK W/SOUND ATTENUATION BLANKET

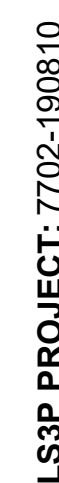

Design No. U419

August 05, 2020

Nonbearing Wall Ratings — 1, 2, 3 or 4 Hr (See Items 4 & 5 through 5K)
Indicates such products shall bear the UL or cUL Certification Mark for jurisdictions employing the UL or cUL Certification (such as Canada), respectively.

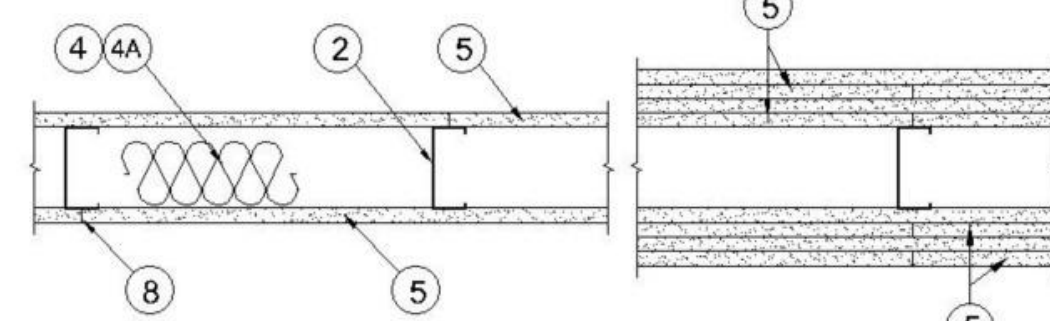

1. Floor and Ceiling Runners — (Not Shown) — For use with Item 2 — Channel shaped, fabricated from min 25 MSG corrosion-protected steel, min depth to accommodate stud size, with min 1-1/4 in. long legs, attached to floor and ceiling with fasteners 24 in. OC max.

1A. Framing Members* — Floor and Ceiling Runner — Not Shown — In lieu of Item 1 — For use with Item 2B, proprietary channel shaped runners, 3-5/8 in. deep attached to floor and ceiling with fasteners 24 in. OC max.
CALIFORNIA EXPANDED METAL PRODUCTS CO — Viper25™ Track
CRACO MFG INC — SmartStud25™
MARNOWARE, DIV OF WARE INDUSTRIES INC — Viper25™ Track
FUSION BUILDING PRODUCTS — Viper25™ Track
IMPERIAL MANUFACTURING GROUP INC — Viper25™ Track

1B. Framing Members* — Floor and Ceiling Runner — Not Shown — In lieu of Item 1 — For use with Item 2C, proprietary channel shaped runners, 3-5/8 in. deep attached to floor and ceiling with fasteners 24 in. OC max.
CALIFORNIA EXPANDED METAL PRODUCTS CO — Viper20™ Track
MARNOWARE, DIV OF WARE INDUSTRIES INC — Viper20™ Track
FUSION BUILDING PRODUCTS — Viper20™ Track
IMPERIAL MANUFACTURING GROUP INC — Viper20™ Track

1C. Framing Members* — Floor and Ceiling Runners — (Not Shown) — In lieu of Item 1 — Channel shaped, attached to floor and ceiling with fasteners 24 in. OC max.
ALLSTEEL & GYPSUM PRODUCTS INC — Type SUPREME D24/30EQD and Type SUPREME D20
CONSOLIDATED FABRICATORS CORP, BUILDING PRODUCTS DIV — Type SUPREME D24/30EQD and Type SUPREME D20
QUAIL RUN BUILDING MATERIALS INC — Type SUPREME D24/30EQD and Type SUPREME D20
SCAFCO STEEL STUD MANUFACTURING CO — Type SUPREME D24/30EQD and Type SUPREME D20
STEEL CONSTRUCTION SYSTEMS INC — Type SUPREME D24/30EQD and Type SUPREME D20
UNITED METAL PRODUCTS INC — Type SUPREME D24/30EQD and Type SUPREME D20

1D. Floor and Ceiling Runners — (Not Shown) — For use with Item 2A — Channel shaped, fabricated from min 25 MSG corrosion-protected or galv steel, min depth to accommodate stud size, with min 1 in. long legs, attached to floor and ceiling with fasteners spaced max 24 in. OC.

1E. Framing Members* — Floor and Ceiling Runners — (Not Shown, As an alternate to Item 1) — For use with Items 2E, 5F or 5G or 5I only, channel shaped, fabricated from min. 0.015 in. (min bare metal thickness) galvanized steel, attached to floor and ceiling with fasteners 24 in. OC max.
CLARKDIETRICH BUILDING SYSTEMS — CD ProTRAK
DMFCWBS LLC — ProTRAK
MBA METAL FRAMING — ProTRAK
RAM SALES LLC — Ram ProTRAK
STEEL STRUCTURAL PRODUCTS LLC — Tri-S ProTRAK

1F. Framing Members* — Floor and Ceiling Runner — Not Shown — In lieu of Item 1 — For use with Item 2F, proprietary channel shaped runners, minimum width to accommodate stud size, with 1-1/8 in. long legs fabricated from min 25 MSG (0.016 in. min. bare metal thickness) galv steel, attached to floor and ceiling with fasteners spaced 24 in. OC max.
SUPER STUD BUILDING PRODUCTS — The Edge

1G. Framing Members* — Floor and Ceiling Runner — For use with Item 2G, proprietary channel shaped runners, minimum width to accommodate stud size attached to floor and ceiling with fasteners 24 in. OC max.
STUDDO BUILDING SYSTEMS — CROGSTUD

1H. Floor and Ceiling Runners — (Not Shown) — Channel shaped, fabricated from min 0.02 in. galv steel, min width to accommodate stud size, with min 1 in. long legs, for use with studs specified below and fabricated from min 0.018 in. galv steel or thicker, attached to floor and ceiling with fasteners spaced max 24 in. OC.
MARNOWARE, DIV OF WARE INDUSTRIES INC — Viper20™ Track VT100
FUSION BUILDING PRODUCTS — Viper20™ Track VT100
IMPERIAL MANUFACTURING GROUP INC — Viper20™ Track VT100

1I. Framing Members* — Floor and Ceiling Runners — (Not Shown, As an alternate to Item 1) — For use with Items 2H, channel shaped, fabricated from min. 0.015 in. (min bare metal thickness) galvanized steel, attached to floor and ceiling with fasteners 24 in. OC max.
TELLING INDUSTRIES LLC — TRUE-TRUST™

1J. Framing Members* — Floor and Ceiling Runner — Not Shown — In lieu of Item 1 — For use with Item 2I, proprietary channel shaped runners, 3-5/8 in. deep attached to floor and ceiling with fasteners 24 in. OC max.
TELLING INDUSTRIES LLC — Viper25™ Track

1K. Framing Members* — Floor and Ceiling Runner — Not Shown — In lieu of Item 1 — For use with Item 2J, proprietary channel shaped runners, 1-1/4 in. wide by 3-5/8 in. deep, fabricated from min 0.018 in. thick galv steel, attached to floor and ceiling with fasteners spaced 24 in. OC max.
RESCUE METAL FRAMING, LLC — AlphaTRAK

1L. Framing Members* — Floor and Ceiling Runner — Not Shown — In lieu of Item 1 — For use with Item 2K, proprietary channel shaped runners, 1-1/4 in. wide by 3-1/2 in. deep, fabricated from min 0.018 in. thick galv steel, attached to floor and ceiling with fasteners spaced 24 in. OC max.
RESCUE METAL FRAMING, LLC — AlphaTRAK

1M. Framing Members* — Floor and Ceiling Runners — Not Shown — As an alternate to Item 1 — For use with Item 2O, proprietary channel shaped runners, min width to accommodate stud size, galv steel, attached to floor and ceiling with fasteners spaced 24 in. OC max.
RONDO BUILDING SERVICES PTY LTD — Rondo Wall Track

1N. Framing Members* — Floor and Ceiling Runners — Not Shown — As an alternate to Item 1 — For use with Item 2P, proprietary channel shaped runners, min width to accommodate stud size, galv steel, attached to floor and ceiling with fasteners spaced 24 in. OC max.
OEG BUILDING MATERIALS — OEG Track

1O. Framing Members* — Floor and Ceiling Runner — Not Shown — In lieu of Item 1 — For use with Item 2Q, proprietary channel shaped runners, min width to accommodate stud size, fabricated from min. 25 MSG (0.018 in. min. bare metal thickness), attached to floor and ceiling with fasteners spaced 24 in. OC max.
CALIFORNIA EXPANDED METAL PRODUCTS CO — Viper X Track

2. Steel Studs — Channel shaped, fabricated from min 25 MSG corrosion-protected steel, min depth as indicated under Item 5, spaced a max of 24 in. OC. Studs to be cut 3/8 to 3/4 in. less than assembly height.

2A. Steel Studs — (As an alternate to Item 2, For use with Items 5B, 5E, 5H, 5I or Type ULIX) — Channel shaped, fabricated from min 20 MSG corrosion-protected or galv steel, 3-1/2 in. min depth, spaced a max of 16 in. OC. Studs friction-fit into floor and ceiling runners. Studs to be cut 5/8 to 3/4 in. less than assembly height.

2B. Framing Members* — Steel Studs — (As an alternate to Item 2, For use with Items 5C, 5I or Type ULIX) — Proprietary channel shaped studs, 3-5/8 in. deep spaced a max of 24 in. OC. Studs to be cut 3/4 in less than the assembly height and installed with a 1/2 in. gap between the end of the stud and track at the bottom of the wall. For direct attachment of gypsum board only.
CALIFORNIA EXPANDED METAL PRODUCTS CO — Viper25™
CRACO MFG INC — SmartStud25™
MARNOWARE, DIV OF WARE INDUSTRIES INC — Viper25™
FUSION BUILDING PRODUCTS — Viper25™
IMPERIAL MANUFACTURING GROUP INC — Viper25™

2C. Framing Members* — Steel Studs — Not Shown — In lieu of Item 2 — Proprietary channel shaped steel studs, min depth as indicated under Item 5, spaced a max if 24 in. OC, fabricated from min 0.018 in. thick galv steel. Studs cut 3/8 in. to 3/4 in. less in lengths than assembly heights.
CALIFORNIA EXPANDED METAL PRODUCTS CO — Viper20™
MARNOWARE, DIV OF WARE INDUSTRIES INC — Viper20™
FUSION BUILDING PRODUCTS — Viper20™
IMPERIAL MANUFACTURING GROUP INC — Viper20™

2D. Framing Members* — Steel Studs — In lieu of Item 2 — Channel shaped studs, min depth as indicated under Item 5, spaced a max of 24 in. OC. Studs to be cut 3/4 in. less than assembly height.
ALLSTEEL & GYPSUM PRODUCTS INC — Type SUPREME D24/30EQD and Type SUPREME D20
CONSOLIDATED FABRICATORS CORP, BUILDING PRODUCTS DIV — Type SUPREME D24/30EQD and Type SUPREME D20
QUAIL RUN BUILDING MATERIALS INC — Type SUPREME D24/30EQD and Type SUPREME D20
SCAFCO STEEL STUD MANUFACTURING CO — Type SUPREME D24/30EQD and Type SUPREME D20
STEEL CONSTRUCTION SYSTEMS INC — Type SUPREME D24/30EQD and Type SUPREME D20
UNITED METAL PRODUCTS INC — Type SUPREME D24/30EQD and Type SUPREME D20

2E. Framing Members* — Steel Studs — (Not Shown, As an alternate to Item 2) — For use with Items 5F or 5G or 5I or Type ULIX only, channel shaped studs, min depth as indicated under Item 5F, 5G or 5I, fabricated from min. 0.015 in. (min bare metal thickness) galvanized steel, spaced a max of 24 in. OC. Studs to be cut 3/4 in. less than assembly height.
CLARKDIETRICH BUILDING SYSTEMS — CD ProSTUD
DMFCWBS LLC — ProSTUD
MBA METAL FRAMING — ProSTUD
RAM SALES LLC — Ram ProSTUD
STEEL STRUCTURAL PRODUCTS LLC — Tri-S ProSTUD

2F. Framing Members* — Steel Studs — Not Shown — In lieu of Item 2 — Proprietary channel shaped steel studs, minimum width indicated under Item 5, 1-1/4 in. deep fabricated from min 0.015 in. (min bare metal thickness) galvanized steel. Studs 3/8 in. to 3/4 in. less in lengths than assembly heights.
SUPER STUD BUILDING PRODUCTS — The Edge

2G. Framing Members* — Steel Studs — Not Shown — In lieu of Item 2 — Proprietary channel shaped steel studs, min width indicated under Item 5, Studs to be cut 3/8 to 3/4 in less than the assembly height.
STUDDO BUILDING SYSTEMS — CROGSTUD

2H. Framing Members* — Steel Studs — (Not Shown, As an alternate to Item 2) — Fabricated from min. 0.015 in. (min bare metal thickness) galvanized steel, spaced a max of 24 in. OC. Studs to be cut 3/4 in. less than assembly height.
TELLING INDUSTRIES LLC — TRUE-STUD™

2I. Framing Members* — Steel Studs — (As an alternate to Item 2, For use with Items 5G or 5I or 5K) — Proprietary channel shaped studs, 3-5/8 in. deep spaced a max of 24 in. OC. Studs to be cut 3/4 in less than the assembly height and installed with a 1/2 in. gap between the end of the stud and track at the bottom of the wall. For direct attachment of gypsum board only.
TELLING INDUSTRIES LLC — Viper25™

2J. Framing Members* — Metal Studs — Not Shown — In lieu of Item 2 — Proprietary channel shaped steel studs, min depth as indicated under Item 5, spaced a max of 24 in. OC, fabricated from min 0.018 in. thick galv steel. Studs cut 3/8 in. to 3/4 in. less in lengths than assembly heights.
TELLING INDUSTRIES LLC — Viper20™

2K. Framing Members* — Steel Studs — (As an alternate to Item 2 — For use with Item 1, channel shaped studs, fabricated from min 25 MSG corrosion-protected steel, min depth as indicated under Item 5, spaced a max of 24 in. OC. Studs to be cut 3/8 to 3/4 in. less than assembly height.
EB METAL INC — NITROSTUD

2L. Framing Members* — Steel Studs — (As an alternate to Item 2 — For use with Item 1, channel shaped studs, fabricated from min 25 MSG corrosion-protected steel, min depth as indicated under Item 5, spaced a max of 24 in. OC. Studs to be cut 3/8 to 3/4 in. less than assembly height.
OLMAR SUPPLY INC — PRIMESTUD

2M. Framing Members* — Steel Studs — (As an alternate to Item 2 — For use with Item 1, channel shaped studs, fabricated from min 25 MSG corrosion-protected steel, min depth as indicated under Item 5, spaced a max of 24 in. OC. Studs to be cut 3/8 to 3/4 in. less than assembly height.
MARNOWARE, DIV OF WARE INDUSTRIES INC — StudRite™

2N. Framing Members* — Steel Studs — As an alternate to Item 2 — Proprietary channel shaped steel studs, min depth 3-1/2 in. and as indicated under Item 5, spaced a max of 24 in. OC, fabricated from min 0.018 in. thick galv steel. Studs cut 3/8 in. to 3/4 in. less in length than assembly height.
RESCUE METAL FRAMING, LLC — AlphaSTUD

2O. Framing Members* — Steel Studs — (As an alternate to Item 2 — Proprietary channel shaped steel studs, min width as indicated under Item 5, galv steel. Studs to be cut 3/8 to 3/4 in. less in lengths than assembly height. Spaced 24 in. OC max.
RONDO BUILDING SERVICES PTY LTD — Rondo Lipped Wall Stud

2P. Framing Members* — Steel Studs — (As an alternate to Item 2 — Proprietary channel shaped steel studs, min width as indicated under Item 5, min 25 MSG galv steel. Studs to be cut 3/8 to 3/4 in. less in lengths than assembly height. Spaced 24 in. OC max.
OEG BUILDING MATERIALS — OEG Stud

2Q. Framing Members* — Steel Studs — Not Shown — In lieu of Item 2 — For use with Item 10, proprietary channel shaped steel studs, min depth as indicated under Item 5, need backing by steel framing. Horizontal edge joints and horizontal butt joints on opposite sides of studs need not be staggered. Horizontal edge joints and horizontal butt joints in adjacent layers (multilayer systems) staggered a min of 12 in. The thickness and number of layers for the 1 hr, 2 hr, 3 hr and 4 hr ratings are as follows:

Gypsum Board Protection on Each Side of Wall			
RATING, Hr	Min Stud Depth, in. Items 2, 2C, 2D, 2F, 2G, 2O	No. of Layers & Thkns of Panel	Min Thkns of Insulation (Item 4)
2	1-5/8	2 Layers, 1/2 in. thick	Optional
2	1-5/8	2 Layers, 5/8 in. thick	Optional
3	1-5/8	3 Layers, 1/2 in. thick	Optional
3	1-5/8	3 Layers, 5/8 in. thick	Optional
4	1-5/8	4 Layers, 5/8 in. thick	Optional
4	1-5/8	4 Layers, 1/2 in. thick	Optional

4. Batts and Blankets* — (Required as indicated under Item 5) — Mineral wool batts, friction fitted between studs in thickness as indicated under Item 5.
See Batts and Blankets (BKNV or BZJZ) Categories for names of Classified companies.

4A. Batts and Blankets* — (Optional) — Placed in stud cavities, any glass fiber or mineral wool insulation bearing the UL Classification Marking as to Surface Burning Characteristics and/or Fire Resistance.
See Batts and Blankets (BKNV or BZJZ) Categories for names of Classified companies.

4B. Fiber, Sprayed* — (Optional, for use with Type ULIX) Where insulation is required - Spray applied granulated mineral fiber material. The fiber is applied with adhesive at a minimum density of 4.0 pcf to completely fill the wall cavity in accordance with the application instructions supplied with the product. See Fiber, Sprayed (CCAZ).

AMERICAN ROCKWOOL MANUFACTURING, LLC — Type Rockwool Premium Plus

5. Gypsum Board* — Gypsum panels with beveled, square or tapered edges, applied vertically or horizontally. Vertical joints centered over studs and staggered one stud cavity on opposite sides of studs. Vertical joints in adjacent layers (multilayer systems) staggered one stud cavity. Horizontal joints need not be backed by steel framing. Horizontal edge joints and horizontal butt joints on opposite sides of studs need not be staggered. Horizontal edge joints and horizontal butt joints in adjacent layers (multilayer systems) staggered a min of 12 in. The thickness and number of layers for the 1 hr, 2 hr, 3 hr and 4 hr ratings are as follows:

Gypsum Board Protection on Each Side of Wall			
RATING, Hr	Min Stud Depth, in. Items 2, 2C, 2D, 2F, 2G, 2O	No. of Layers & Thkns of Panel	Min Thkns of Insulation (Item 4)
1	3-1/2	1 Layer, 5/8 in. thick	Optional
1	2-1/2	1 Layer, 1/2 in. thick	1-1/2 in.
1	1-5/8	1 Layer, 3/4 in. thick	Optional
2	1-5/8	2 Layers, 1/2 in. thick	Optional
2	1-5/8	2 Layers, 5/8 in. thick	Optional
2	3-1/2	1 Layer, 3/4 in. thick	3 in.
3	1-5/8	3 Layers, 1/2 in. thick	Optional
3	1-5/8	3 Layers, 3/4 in. thick	Optional
3	1-5/8	3 Layers, 5/8 in. thick	Optional
4	1-5/8	4 Layers, 5/8 in. thick	Optional
4	1-5/8	4 Layers, 1/2 in. thick	Optional
4	2-1/2	2 Layers, 3/4 in. thick	2 in.

CGC INC — 1/2 in. thick Type C, IP-X2 or IPC-AR, 5/8 in. thick Type AR, C, IP-AR, IP-X1, IP-X2, IPC-AR, SCX, SHX, ULIX, WRX or WRC; 3/4 in. thick Types IP-X3 or ULTRACODE
THE SIAM GYPSUM INDUSTRY (SONGKHLA) CO — 1/2 in. thick Type C and 5/8 in. thick Type SCX
UNITED STATES GYPSUM CO — 1/2 in. thick Type C, IP-X2, IPC-AR or WRC; 5/8 in. thick Type SCX, SHX, ULIX, WRX, IP-X1, AR, C, WRC, FRX-G, IP-AR, IP-X2, IPC-AR, 3/4 in. thick Types IP-X3 or ULTRACODE
USG BORAL DRYWALL SFZ LLC — 1/2 in. Type C, 5/8 in. Types C, SCX, SGX, ULTRACODE

USG MEXICO S A DE CV — 1/2 in. thick Type C, IP-X2, IPC-AR or WRC; 5/8 in. thick Type AR, C, IP-AR, IP-X1, IP-X2, IPC-AR, SCX, SHX, WRX, WRC or; 3/4 in. thick Types IP-X3 or ULTRACODE
When Item 7B, Steel Framing Members*, is used, Nonbearing Wall Rating is limited to 1 Hr. Min. stud depth is 3-1/2 in. min. thickness of insulation (Item 4) is 3 in., and two layers of gypsum board panels (12 in. or 5/8 in. thick) shall be attached to furring channels as described in Item 6. One layer of gypsum board panels (12 in. or 5/8 in. thick) attached to opposite side of stud without furring channels as described in Item 6.

5A. Gypsum Board* — (As an alternate to Item 5) — 5/8 in. thick, 24 to 54 in. wide, applied horizontally as the top layer to one side of the assembly. Secured as described in Item 6.
CGC INC — Type SHX
UNITED STATES GYPSUM CO — Type FRX-G, SHX
USG MEXICO S A DE CV — Type SHX

5B. Gypsum Board* — (Not Shown) — As an alternate to Item 5 when used as the base layer on one or both sides of wall when 5/8 in or 3/4 in. thick products are specified. For direct attachment only to steel studs Item 2A, (not to be used with Item 3) — Nom 5/8 in. or 3/4 in., may be used as alternate to all 5/8 in. or 3/4 in. shown in Item 5, Wallboard Protection on Each Side of Wall table. Nom 5/8 in. or 3/4 in. thick lead backed gypsum panels with beveled, square or tapered edges, applied vertically. Vertical joints centered over studs and staggered min 1 stud cavity on opposite sides of studs. Gypsum board secured to 20 MSG steel studs Item 2A with 1-1/4 in. long Type S-12 steel screws spaced 8 in. OC at perimeter and 12 in. OC in the field. To be used with Lead Batten Strips (see item 11) or Lead Discs or Tabs (see Item 12).

5C. Gypsum Board* — (For Use With Item 2B) — Rating Limited to 1 Hour, 5/8 in. thick, 48 in. wide, Gypsum panels with beveled, square or tapered edges, applied vertically or horizontally. (Vertical Application) — The gypsum board is to be installed on each side of the studs with 1 in. long Type S coated steel screws spaced 8 in. OC starting 4 in. from the edge of the board at the vertical edges and 12 in. OC starting 6 in. from the edge of the board at the center of each board. Gypsum boards are to be secured to the top and bottom track with screws spaced 8 in. OC starting 4 in. from the board edge. Fasteners shall not penetrate through both the stud and the track at the same time. All horizontal joints are to be backed as outlined under section VI of Volume 1 in the Fire Resistive Directory.

CGC INC — Type SCX, ULIX
THE SIAM GYPSUM INDUSTRY (SONGKHLA) CO — Type SCX
UNITED STATES GYPSUM CO — Type SCX, SGX, ULIX
USG BORAL DRYWALL SFZ LLC — Type SCX
USG MEXICO S A DE CV — Type SCX

5D. Gypsum Board* — (As an alternate to Item 5) — 5/8 in. thick, 48 in. wide, applied vertically or horizontally. Secured as described in Item 6. For use with Items 1 and 2 only.
CGC INC — Type USGX
UNITED STATES GYPSUM CO — Type USGX
USG BORAL DRYWALL SFZ LLC — Type USGX
USG MEXICO S A DE CV — Type USGX

5E. Gypsum Board* — (Not Shown) — (As an alternate to Item 5 when used as the base layer on one or both sides of wall when 1/2 in. or 5/8 in thick products are specified. For direct attachment only to steel studs Item 2A, (not to be used with Item 3). Nominal 5/8 in. thick lead backed gypsum panels with beveled, square or tapered edges, applied vertically. Vertical joints centered over studs and staggered min 1 stud cavity on opposite sides of studs. Wallboard secured to studs with 1-1/4 in. long Type S-12 (No. 6 by 1-1/4 in. long bugle head fire drilled) steel screws spaced 8 in. OC at perimeter and 12 in. OC in the field.
NEW ENGLAND LEAD BURNING CO INC, DBA NELCO — Nelco

5F. Gypsum Board* — (As an alternate to Item 5) — For use with Items 1E and 2E and limited to 1 Hour Rating only, Gypsum panels with beveled, square or tapered edges, applied vertically and fastened to the steel studs with 1 in. long Type S screws spaced 8 in. OC along vertical and bottom edges and 12 in. OC in the field. Vertical joints centered over studs and staggered one stud cavity on opposite sides of studs. Steel stud depth shall be a minimum 3-5/8 in.

THE SIAM GYPSUM INDUSTRY (SONGKHLA) CO — Type SCX
UNITED STATES GYPSUM CO — 5/8 in. thick Type SCX, SGX, ULIX
USG BORAL DRYWALL SFZ LLC — 5/8 in. thick Type SCX, SGX, ULIX
USG MEXICO S A DE CV — Type SCX

5G. Gypsum Board* — (As an alternate to Item 5) — For use with Items 1E and 2E only, Gypsum panels with beveled, square or tapered edges, applied vertically or horizontally, as specified in the table below and fastened to the steel studs as described in Item 6. Vertical joints centered over studs and staggered one stud cavity on opposite sides of studs. Vertical joints in adjacent layers (multilayer systems) staggered one stud cavity. Horizontal joints need not be backed by steel framing. Horizontal edge joints and horizontal butt joints on opposite sides of studs need not be staggered. Horizontal edge joints and horizontal butt joints in adjacent layers (multilayer systems) staggered a min of 12 in. The thickness and number of layers for the 2 hr, 3 hr and 4 hr ratings are as follows:

Gypsum Board Protection on Each Side of Wall			
RATING, Hr	Min Stud Depth, in. Items 2E	No. of Layers & Thkns of Panel	Min Thkns of Insulation (Item 4)
2	1-5/8	2 Layers, 1/2 in. thick	Optional
2	1-5/8	2 Layers, 5/8 in. thick	Optional
3	1-5/8	3 Layers, 1/2 in. thick	Optional
3	1-5/8	3 Layers, 5/8 in. thick	Optional
4	1-5/8	4 Layers, 5/8 in. thick	Optional
4	1-5/8	4 Layers, 1/2 in. thick	Optional

CGC INC — 1/2 in. thick Type C, IP-X2 or IPC-AR, 5/8 in. thick Type AR, C, IP-AR, IP-X1, IP-X2, IPC-AR, SCX, SHX, ULIX or 3/4 in. thick Types IP-X3 or ULTRACODE
THE SIAM GYPSUM INDUSTRY (SONGKHLA) CO — 1/2 in. thick Type C and 5/8 in. thick Type SCX
UNITED STATES GYPSUM CO — 1/2 in. thick Type C, IP-X2, IPC-AR or 5/8 in. thick Type SCX, SGX, SHX, IP-X1, AR, C, FRX-G, IP-AR, IP-X2, IPC-AR, ULIX, 3/4 in. thick Types IP-X3 or ULTRACODE
USG BORAL DRYWALL SFZ LLC — 1/2 in. Type C, 5/8 in. Types C, SCX, SGX, ULTRACODE

USG MEXICO S A DE CV — 1/2 in. thick Type C, IP-X2, IPC-AR or 5/8 in. thick Type AR, C, IP-AR, IP-X1, IP-X2, IPC-AR, SCX, SHX, or 3/4 in. thick Types IP-X3 or ULTRACODE

5H. Gypsum Board* — (Not Shown) — (As an alternate to Item 5 when used as the base layer on one or both sides of wall when 5/8 or 3/4 in thick products are specified. For direct attachment only to steel studs Item 2A, (not to be used with Item 3) — Nom 5/8 in. or 3/4 in., may be used as alternate to all 5/8 or 3/4 in. shown in Item 5, Wallboard Protection on Each Side of Wall table. Nom 5/8 or 3/4 in. thick lead backed gypsum panels with beveled, square or tapered edges, applied vertically. Vertical joints centered over 20 MSG steel studs and staggered min 1 stud cavity on opposite sides of studs. Wallboard secured to studs with 1-1/4 in. long Type S-12 steel screws spaced 8 in. OC at perimeter and 12 in. OC in the field. For Joint Compound see Item 5. To be used with Lead Batten Strips (see item 11A) or Lead Discs (see item 12A).

5I. Gypsum Board* — (As an alternate to Item 5) — Nom. 5/8 in. thick gypsum panels with beveled, square or tapered edges installed as described in Item 5. Steel stud minimum depth shall be as indicated in Item 5.
CGC INC — Type ULIX, ULX
UNITED STATES GYPSUM CO — Type ULIX, ULX
USG MEXICO S A DE CV — Type ULX


5J. Gypsum Board* — (Not Shown) — (As an alternate to Item 5 when used as the base layer on one or both sides of wall when 1/2 in. or 5/8 in thick products are specified. For direct attachment only to steel studs Item 2A, (not to be used with Item 3). Nom 5/8 in. thick lead backed gypsum panels with beveled, square or tapered edges, applied vertically. Vertical joints centered over studs and staggered min 1 stud cavity on opposite sides of studs. Wallboard secured to studs with 1-1/4 in. long Type S-12 steel screws gypsum panel steel screws spaced 8 in. OC at perimeter and 12 in. OC in the field. Lead batten strips required behind vertical joints of lead backed gypsum wallboard and optional at remaining stud locations. Lead batten strips, min 2 in. wide, max 8 ft long with a max thickness of 0.14 in. placed on the face of studs and attached to the stud with construction adhesive and two 1 in. long Type S-12 pan head steel screws, one at the top of the strip and one at the bottom of the strip. Lead discs, nominal 3/8 in. diam by max 0.025 in. thick. Compression fitted or adhered over the screw heads. Lead batten strips and discs to have a purity of 99.9% meeting the Federal specification QQ-L-2011, Grade "C".

5K. Gypsum Board* — (Not Shown) — (As an alternate to Item 5 when used as the base layer on one or both sides of wall when 5/8 or 3/4 in thick products are specified. For direct attachment only to steel studs Item 2A, (not to be used with Item 3). Nom 5/8 in. thick lead backed gypsum panels with beveled, square or tapered edges, applied vertically. Vertical joints centered over studs and staggered min 1 stud cavity on opposite sides of studs. Wallboard secured to studs with 1-1/4 in. long Type S-12 steel screws gypsum panel steel screws spaced 8 in. OC at perimeter and 12 in. OC in the field. Lead batten strips required behind vertical joints of lead backed gypsum wallboard and optional at remaining stud locations. Lead batten strips, min 2 in. wide, max 8 ft long with a max thickness of 0.14 in. placed on the face of studs and attached to the stud with construction adhesive and two 1 in. long Type S-12 pan head steel screws, one at the top of the strip and one at the bottom of the strip. Lead discs, nominal 3/8 in. diam by max 0.025 in. thick. Compression fitted or adhered over the screw heads. Lead batten strips and discs to have a purity of 99.9% meeting the Federal specification QQ-L-2011, Grade "C".

5L. Gypsum Board* — (Not Shown) — (As an alternate to Item 5 when used as the base layer on one or both sides of wall when 5/8 or 3/4 in thick products are specified. For direct attachment only to steel studs Item 2A, (not to be used with Item 3). Nom 5/8 in. thick lead backed gypsum panels with beveled, square or tapered edges, applied vertically. Vertical joints centered over studs and staggered min 1 stud cavity on opposite sides of studs. Wallboard secured to studs with 1-1/4 in. long Type S-12 steel screws gypsum panel steel screws spaced 8 in. OC at perimeter and 12 in. OC in the field. Lead batten strips required behind vertical joints of lead backed gypsum wallboard and optional at remaining stud locations. Lead batten strips, min 2 in. wide, max 8 ft long with a max thickness of 0.14 in. placed on the face of studs and attached to the stud with construction adhesive and two 1 in. long Type S-12 pan head steel screws, one at the top of the strip and one at the bottom of the strip. Lead discs, nominal 3/8 in. diam by max 0.025 in. thick. Compression fitted or adhered over the screw heads. Lead batten strips and discs to have a purity of 99.9% meeting the Federal specification QQ-L-2011, Grade "C".

5M. Gypsum Board* — (Not Shown) — (As an alternate to Item 5 when used as the base layer on one or both sides of wall when 5/8 or 3/4 in thick products are specified. For direct attachment only to steel studs Item 2A, (not to be used with Item 3). Nom 5/8 in. thick lead backed gypsum panels with beveled, square or tapered edges, applied vertically. Vertical joints centered over studs and staggered min 1 stud cavity on opposite sides of studs. Wallboard secured to studs with 1-1/4 in. long Type S-12 steel screws gypsum panel steel screws spaced 8 in. OC at perimeter and 12 in. OC in the field. Lead batten strips required behind vertical joints of lead backed gypsum wallboard and optional at remaining stud locations. Lead batten strips, min 2 in. wide, max 8 ft long with a max thickness of 0.14 in. placed on the face of studs and attached to the stud with construction adhesive and two 1 in. long Type S-12 pan head steel screws, one at the top of the strip and one at the bottom of the strip. Lead discs, nominal 3/8 in. diam by max 0.025 in. thick. Compression fitted or adhered over the screw heads. Lead batten strips and discs to have a purity of 99.9% meeting the Federal specification QQ-L-2011, Grade "C".

5N. Gypsum Board* — (Not Shown) — (As an alternate to Item 5 when used as the base layer on one or both sides of wall when 5/8 or 3/4 in thick products are specified. For direct attachment only to steel studs Item 2A, (not to be used with Item 3). Nom 5/8 in. thick lead backed gypsum panels with beveled, square or tapered edges, applied vertically. Vertical joints centered over studs and staggered min 1 stud cavity on opposite sides of studs. Wallboard secured to studs with 1-1/4 in. long Type S-12 steel screws gypsum panel steel screws spaced 8 in. OC at perimeter and 12 in. OC in the field. Lead batten strips required behind vertical joints of lead backed gypsum wallboard and optional at remaining stud locations. Lead batten strips, min 2 in. wide, max 8 ft long with a max thickness of 0.14 in. placed on the face of studs and attached to the stud with construction adhesive and two 1 in. long Type S-12 pan head steel screws, one at the top of the strip and one at the bottom of the strip. Lead discs, nominal 3/8 in. diam by max 0.025 in. thick. Compression fitted or adhered over the screw heads. Lead batten strips and discs to have a purity of 99.9% meeting the Federal specification QQ-L-2011, Grade "C".

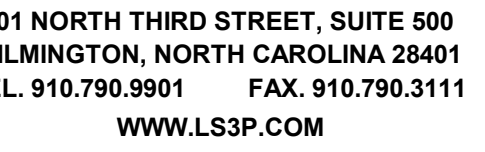

2023.04.04 11:59:05 04707

COPYRIGHT 2023 ALL RIGHTS RESERVED. PRINTED OR
ELECTRONIC DRAWINGS AND DOCUMENTATION MAY
NOT BE REPRODUCED IN ANY FORM WITHOUT WRITTEN
PERMISSION FROM LS3P ASSOCIATES LTD.

New Hanover County Board of Elections

Wilmington, NC 24803

LS3P PROJECT: 7702-190810


[illegible]

SHEET NAME:
ARCHITECTURAL
SITE PLAN

RIG 2023.04.03
SUBMISSION:


HEET: **A-100**

ERMIT SET

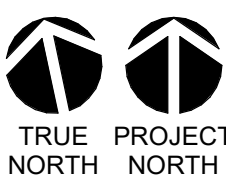


A

1

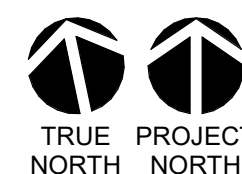

D5 ENLARGED ROOF PLAN @ GUTTER
1 1/2" = 1'-0"

1. LOCATIONS AND SIZES OF MECHANICAL EQUIPMENT ARE APPROXIMATE. COORDINATE WITH STRUCTURAL, MECHANICAL PLAN AND EQUIPMENT SHOP DRAWINGS.
2. SEE PLUMBING DRAWINGS FOR VENTS THROUGH ROOF LOCATIONS.
3. SEE STRUCTURAL DRAWINGS FOR DESIGN LOAD REQUIREMENTS
4. LOW SLOPE ROOFS SHALL BE 1/2" PER 100' FOOT. ALL ROOF DRAINS TO BE INSTALLED IN 3" X 3" O.D. SUMP TYPICAL.
5. SLOPE ALL COPINGS BACK TO ROOF.
6. ALL CORNER FLASHINGS SHALL BE PRESERVATIVE TREATED. USE FASTENERS COMPATIBLE WITH PRESERVATIVE TREATED WOOD.
7. EXTEND ALL PENETRATIONS, CURBS, AND COMPONENTS A MINIMUM OF 6" ABOVE THE ROOF FINISH. PROVIDE FLASHING TO BE KEPT ABOVE PENETRATIONS AND TO ANY VERTICAL SURFACE.
8. FOR DETAILED REQUIREMENTS FOR ROOF DETAIL CONDITIONS OF (CURRENT EDITIONS) STANDARDS FOR ROOF DETAIL CONDITIONS.

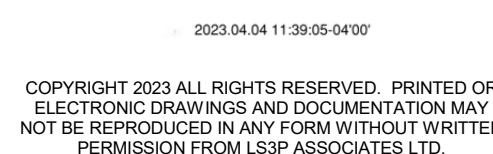

US3P PROJECT: 7702-190810

[illegible]

SHEET NAME:
ROOF PLAN

ORIG 2023.04.03
SUBMISSION:

SHEET: **A-102**

PERMIT SET

THE LINE DRAWN ABOVE IS EXACTLY ONE FOOT AND ONE INCH LONG AND ONE INCH WIDE

E


D

C


B

A

4/4/2023 11:12:44 AM

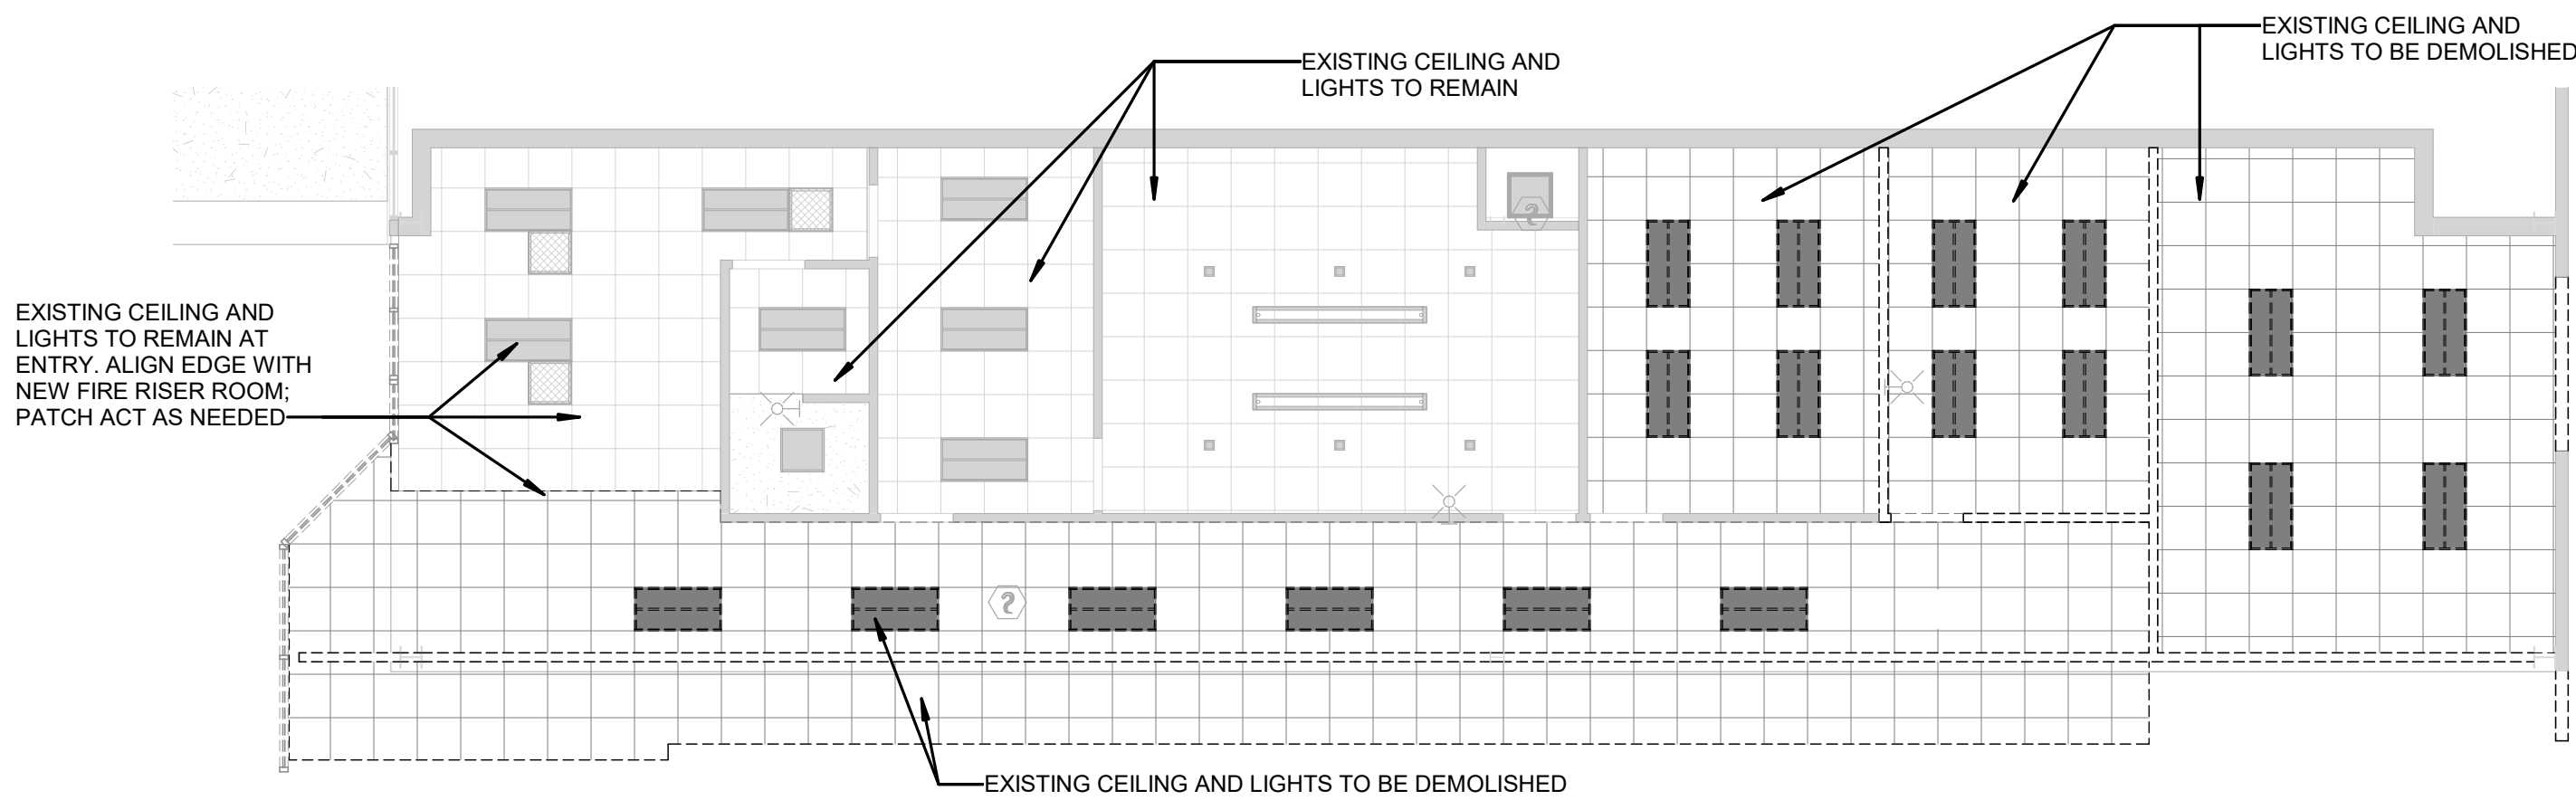

D1 DEMOLITION- REFLECTED CEILING PLAN
1/8" = 1'-0"

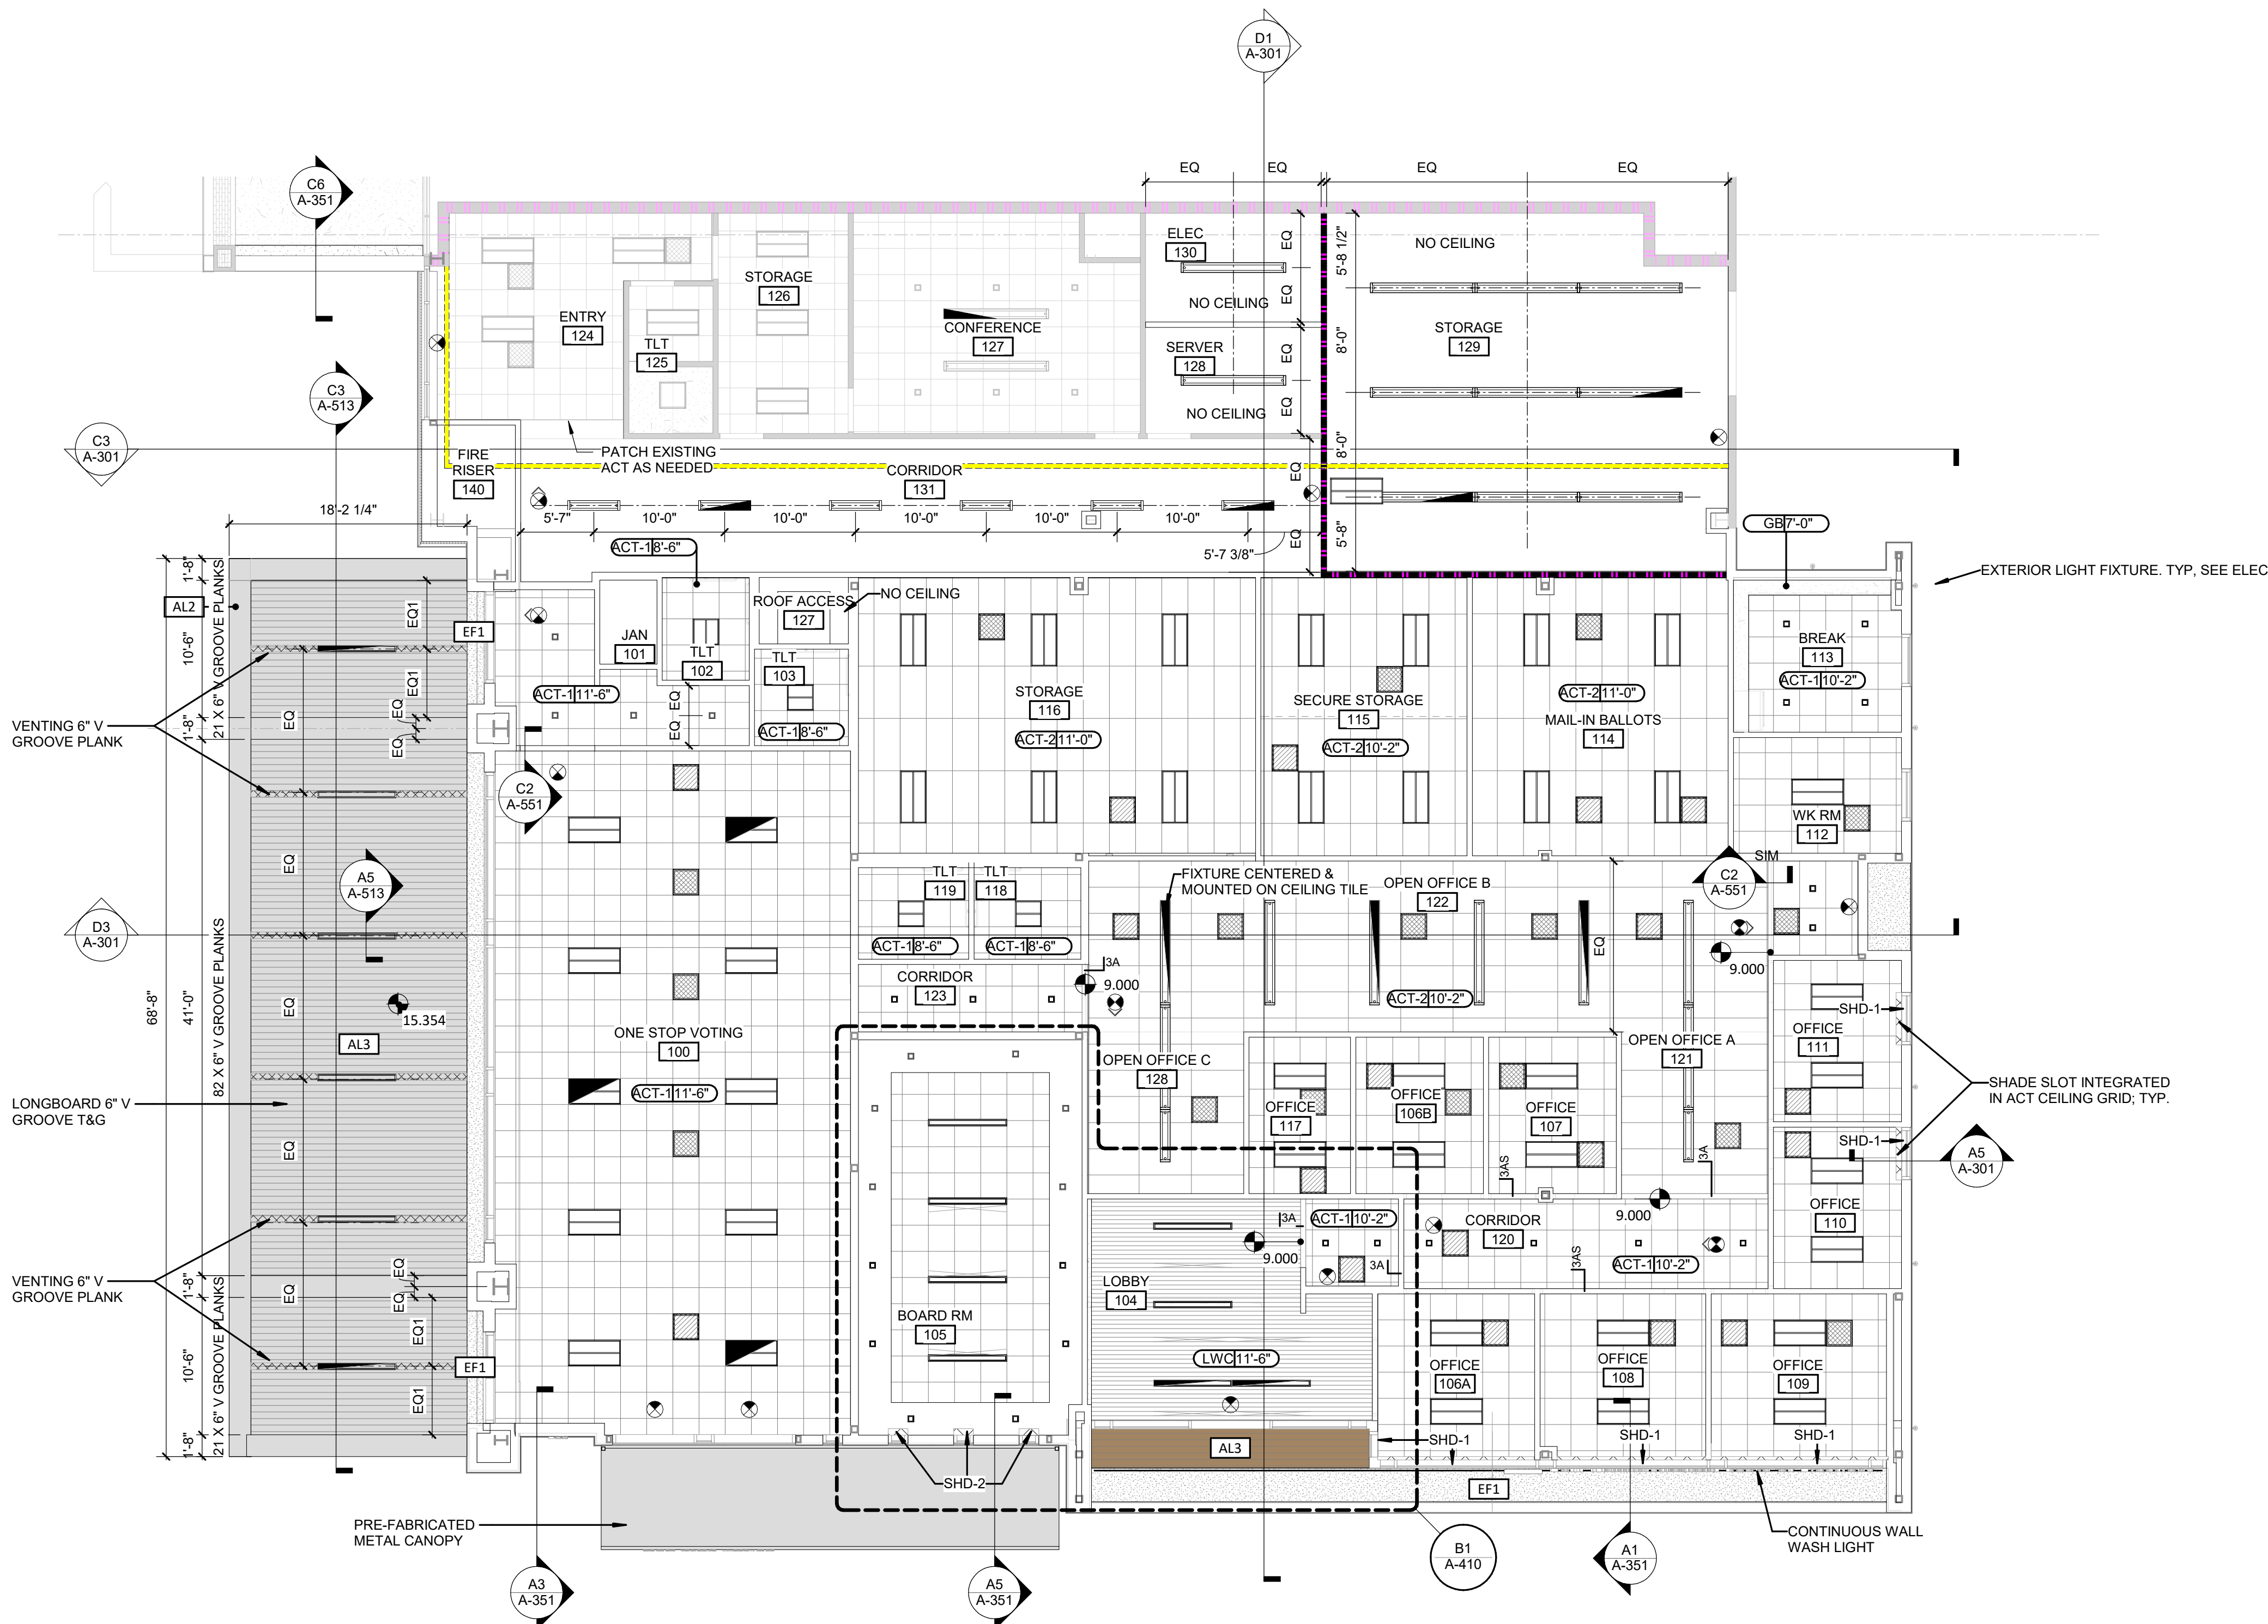


A1 REFLECTED CEILING PLAN
1/8" = 1'-0"

REFLECTED CEILING PLAN SHEET NOTES

1. PROVIDE SEISMIC RESTRAINT OF SUSPENDED CEILING SYSTEMS IN SITE CLASSIFICATIONS C, D, E & F.
2. INTERIOR DIMENSIONS INDICATED ARE TO FACE OF STUD, FACE OF MASONRY AND CENTERLINES OF COLUMNS, UNO.
3. CEILING GRID/TILES TO BE CENTERED IN ALL ROOMS UNLESS NOTED OTHERWISE. PARTIAL TILES AT ROOM PERIMETERS SHALL NOT BE LESS THAN 6" IN EITHER DIMENSION. OVERSIZED TILES SHALL BE INSTALLED WHERE TILES UNDER 6" OCCUR.
4. ALL CEILINGS TO BE 10'-2" AFF. UNO. CEILING HEIGHTS SHOWN ON THE REFLECTED CEILING PLANS ARE NON-TYPICAL AND SPECIFIC TO THE AREA INDICATED. REFER TO INTERIOR ELEVATIONS FOR THE HEIGHTS OF SOFFITS ABOVE CASEWORK.
5. SEE ELECTRICAL, FIRE ALARM AND FIRE PROTECTION DRAWINGS FOR SPECIAL SYSTEMS, SMOKE DETECTORS, LIGHTING AND WALL MOUNTED FIXTURES NOT SHOWN ON THIS SHEET. COORDINATE LOCATIONS OF ALL FIXTURES NOT INDICATED WITH LAYOUT INDICATED ON THIS SHEET.
6. LIGHT FIXTURES AND MECHANICAL DIFFUSERS ARE SHOWN FOR POSITIONING IN FINISH CEILING SYSTEM. COORDINATE WITH MECHANICAL AND ELECTRICAL DRAWINGS FOR FIXTURE TYPES, MECHANICAL DIFFUSERS, WALL MOUNTED FIXTURES AND INSTALLATION OF FIXTURES IN SPACES WITHOUT CEILINGS. (LIGHTING AND HVAC DIFFUSERS ARE SHOWN FOR COORDINATION ONLY - SEE MECHANICAL AND ELECTRICAL DRAWINGS FOR SPECIFIC INFORMATION).
7. CENTER LIGHTS, DIFFUSERS, EXIT SIGNS, SMOKE DETECTORS, SPRINKLER HEADS, SPEAKERS, FIRE ALARM HORN/SISTROBES & MISC DEVICES IN CEILING TILES WHERE THEY ARE LOCATED. ALIGN SIMILAR ITEMS ALONG A COMMON AXIS.
8. LOCATE MECHANICAL GRILLES AND DIFFUSERS SHOWN IN CORNERS OR NEAR WALL TO 12" OFF WALLS, UNO.
9. PROVIDE AND INSTALL CEILING ACCESS PANEL IN GYPSUM BOARD CEILINGS AT DEVICES REQUIRING ACCESS INCLUDING BUT NOT LIMITED TO BALANCING DAMPERS, SMOKE DETECTORS, VAV CONTROLS, PLUMBING VALVES, ELECTRICAL JUNCTION BOXES, ETC. MINIMIZE ACCESS DOORS WHERE POSSIBLE.
10. HEIGHT OF GYPSUM BOARD SOFFITS SHALL BE 1" BELOW HEIGHT OF ADJACENT CEILING (TYP) UNLESS NOTED OTHERWISE.
11. TOUCH-UP PAINT EXPOSED EDGES OF CUT ACOUSTICAL CEILING TILE TO MATCH SURFACE (TYP).
12. INDIVIDUAL TRADE COMPONENTS, INCLUDING BUT NOT LIMITED TO LIGHT FIXTURE WHIPS, FLEXIBLE FIRE PROTECTION PIPING, LOW VOLTAGE WIRING, ETC. SHALL NOT BE SUPPORTED BY ACOUSTICAL CEILING SYSTEM.

RCP LEGEND

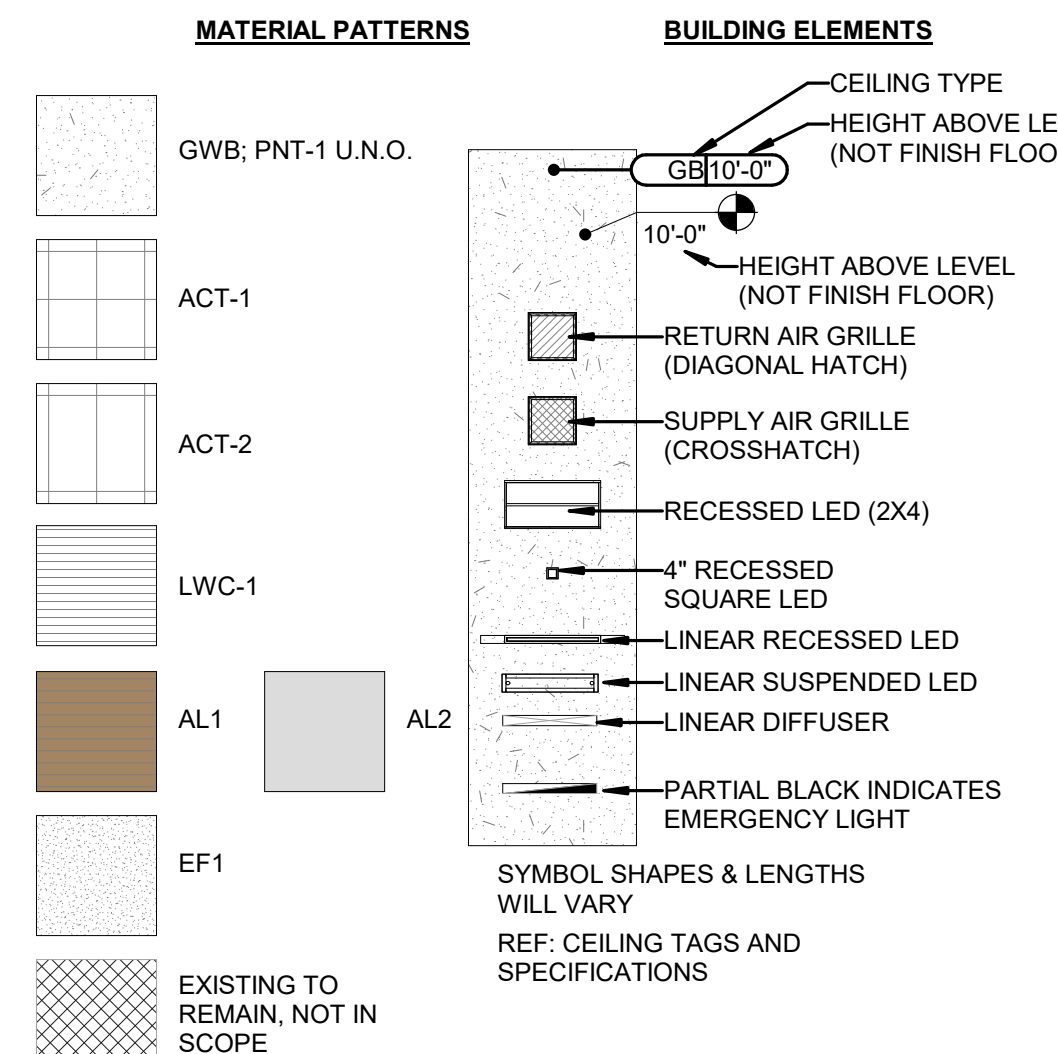

NHC BOARD OF ELECTIONS



101 NORTH THIRD STREET, SUITE 500
WILMINGTON, NORTH CAROLINA 28401
TEL. 910.790.9901 FAX. 910.790.3111
WWW.LS3P.COM



2023.04.04 11:30:09 0407
COPYRIGHT 2023 ALL RIGHTS RESERVED. PRINTED OR ELECTRONIC DRAWINGS AND DOCUMENTATION MAY NOT BE REPRODUCED IN ANY FORM WITHOUT WRITTEN PERMISSION FROM LS3P ASSOCIATES LTD.

**New Hanover County
Board of Elections**
230 Government Center Drive
Wilmington, NC 28403
LS3P PROJECT: 7702- 90810

DATE	DESCRIPTION
0 2023.04.03	PERMIT SET

SHEET NAME:
REFLECTED
CEILING PLAN

ORIG SUBMISSION: 2023.04.03

SHEET:
A-121

PERMIT SET

Wilmington, NC 24803

PROJECT: 7702-190010

[illegible]

HEET NAME:
EXTERIOR
ELEVATIONS

ORIGINAL SUBMISSION: 2023.04.03

HEET: **A-201**

PERMIT SET



PERMIT SET



New Hanover County Board of Elections

230 Government Center Drive

1 S3B PBO IECT: 7703 100910

[illegible]


SHEET NAME:
WALL SECTIONS

ORIG 2023.04.03
SUBMISSION:


SHEET:

A-351


PERMIT SET

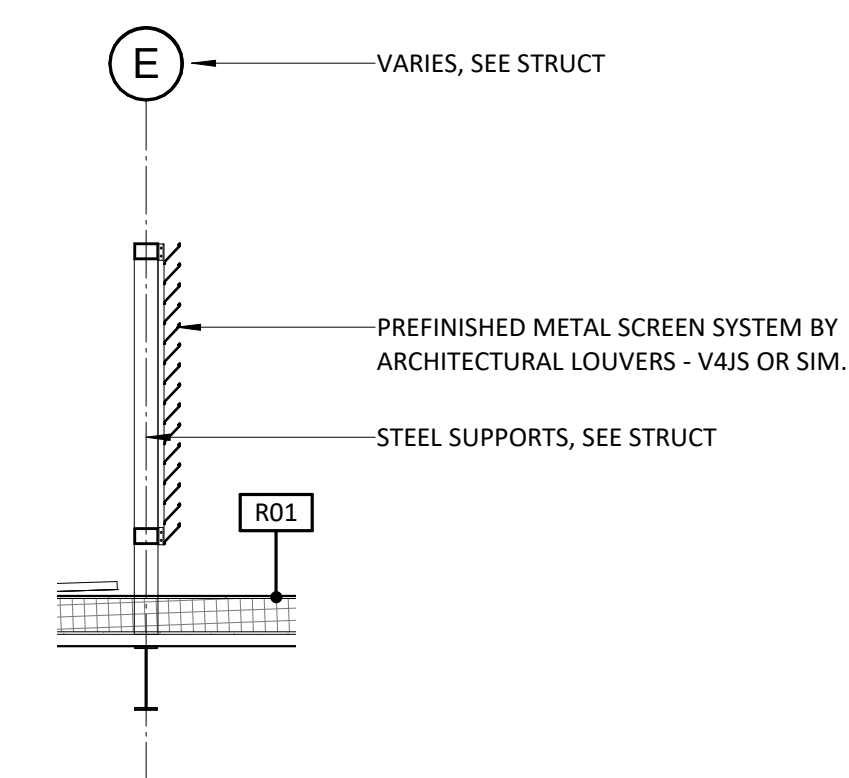


D6 WALL SECTION - LOUVERED EQUIP. ENCL.

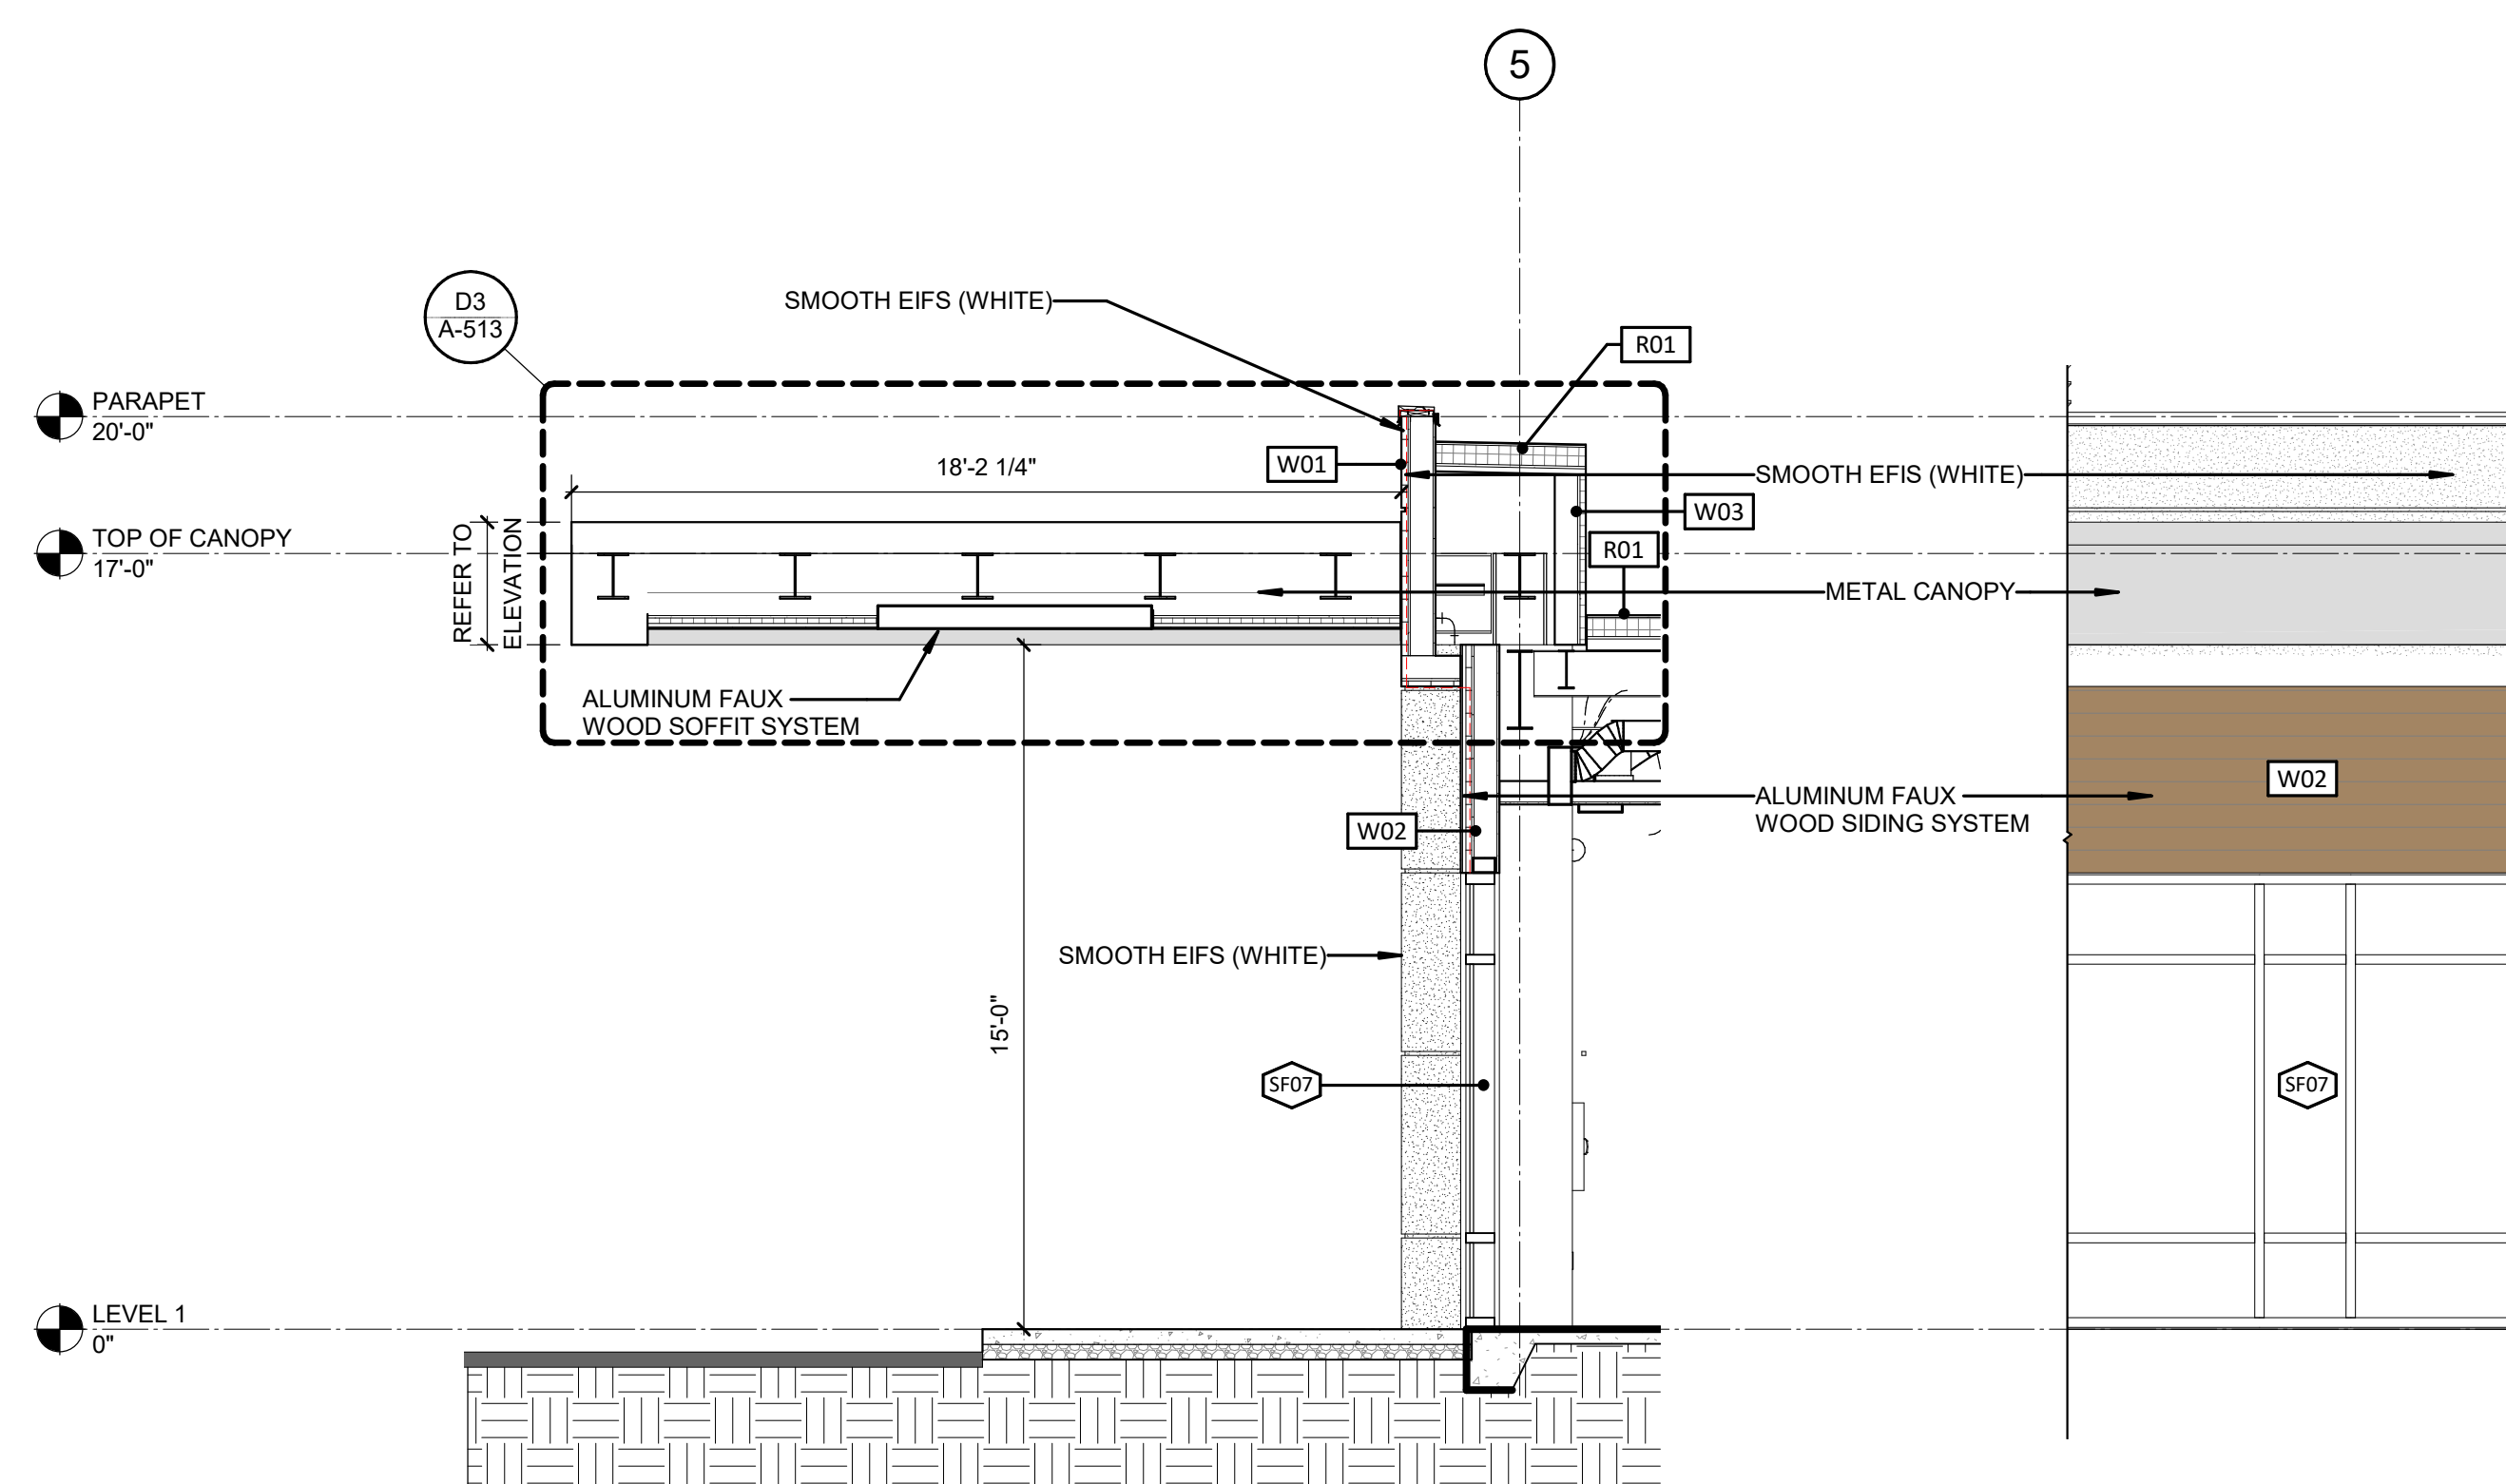


C1 WALL SECTION - TYP. CURBSIDE VOTING CANOPY

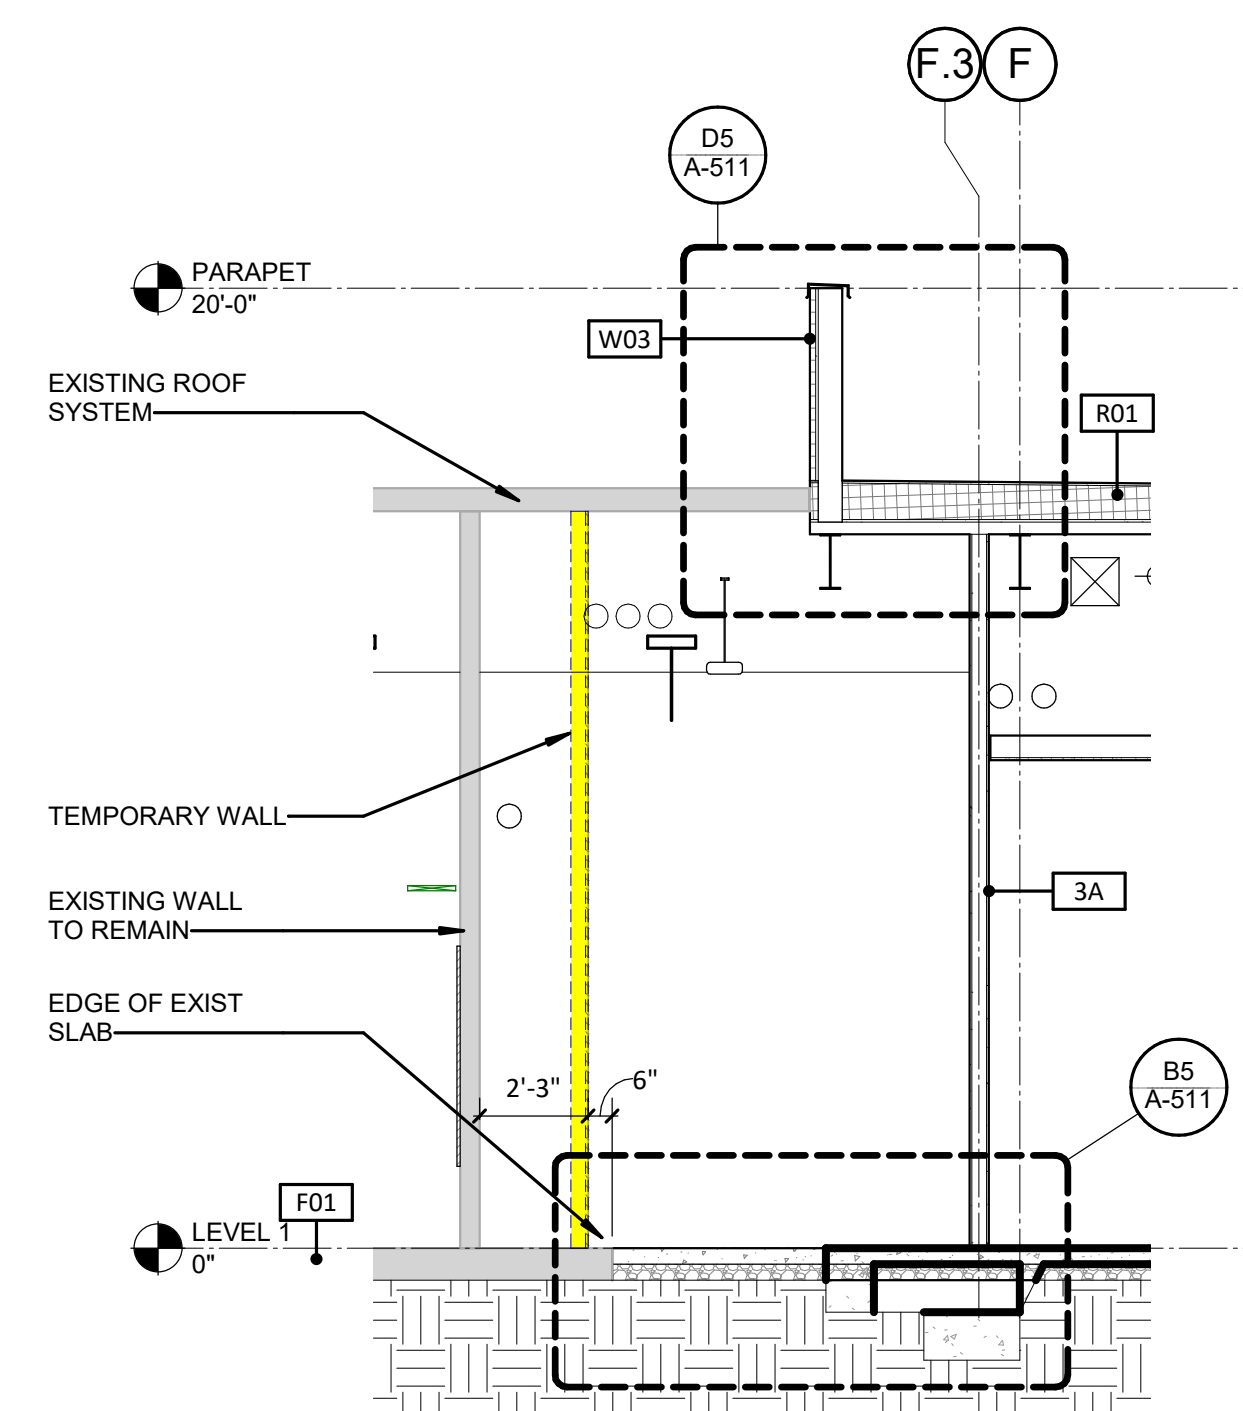


C4 WALL SECTION - @ EXISTING

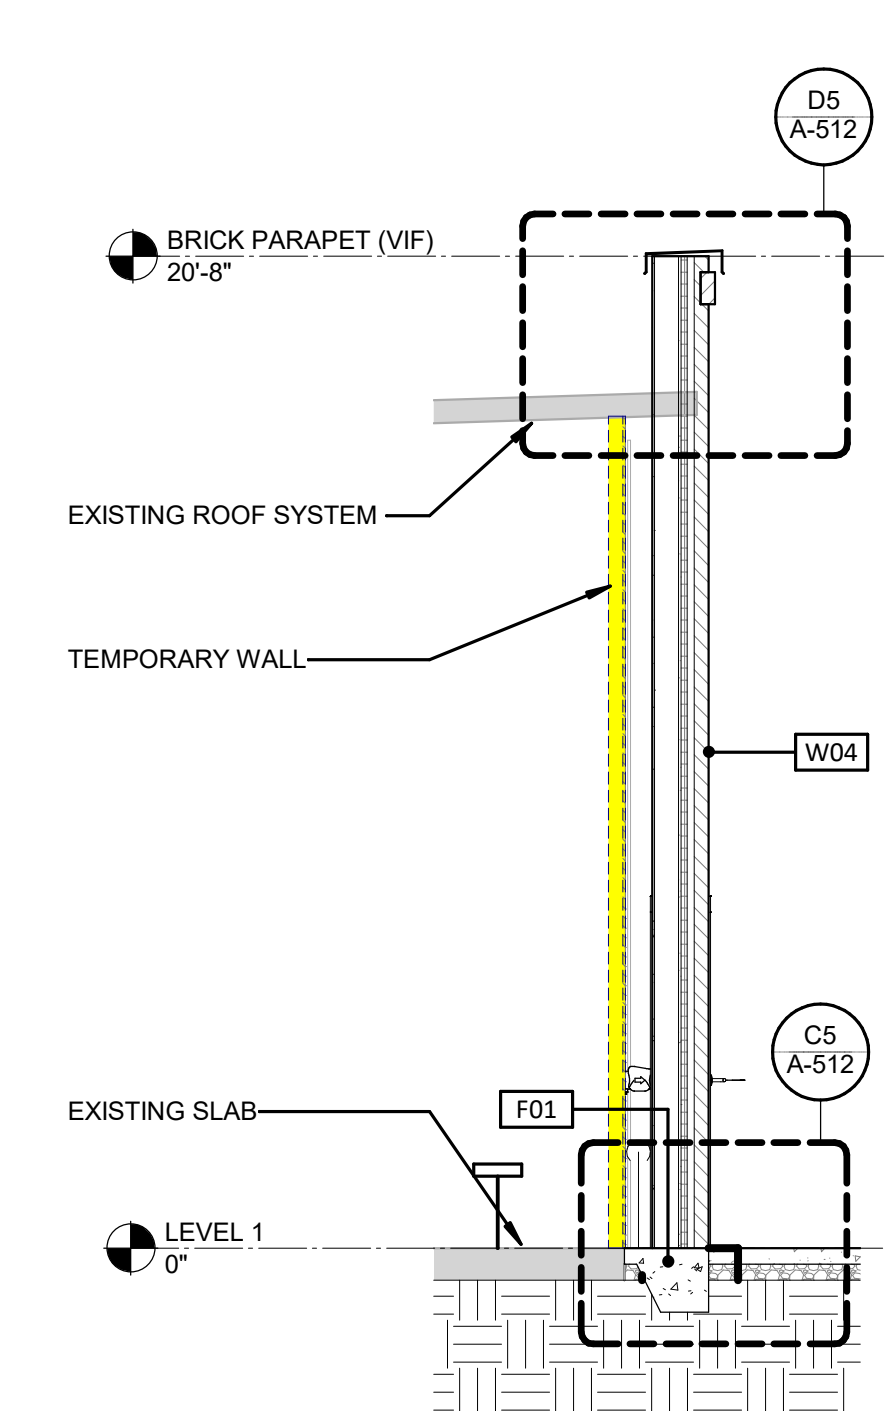


C5 WALL SECTION - (BRICK)

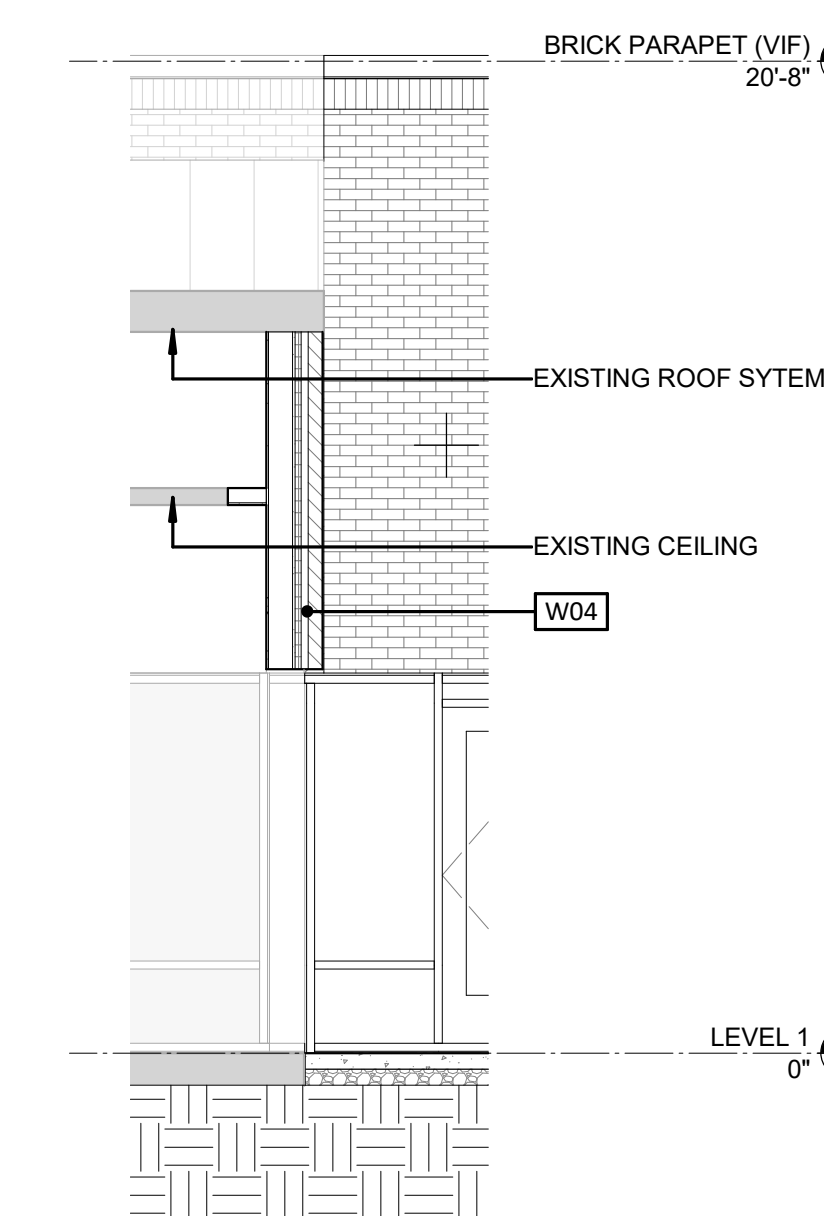


C6 WALL SECTION - END WALL

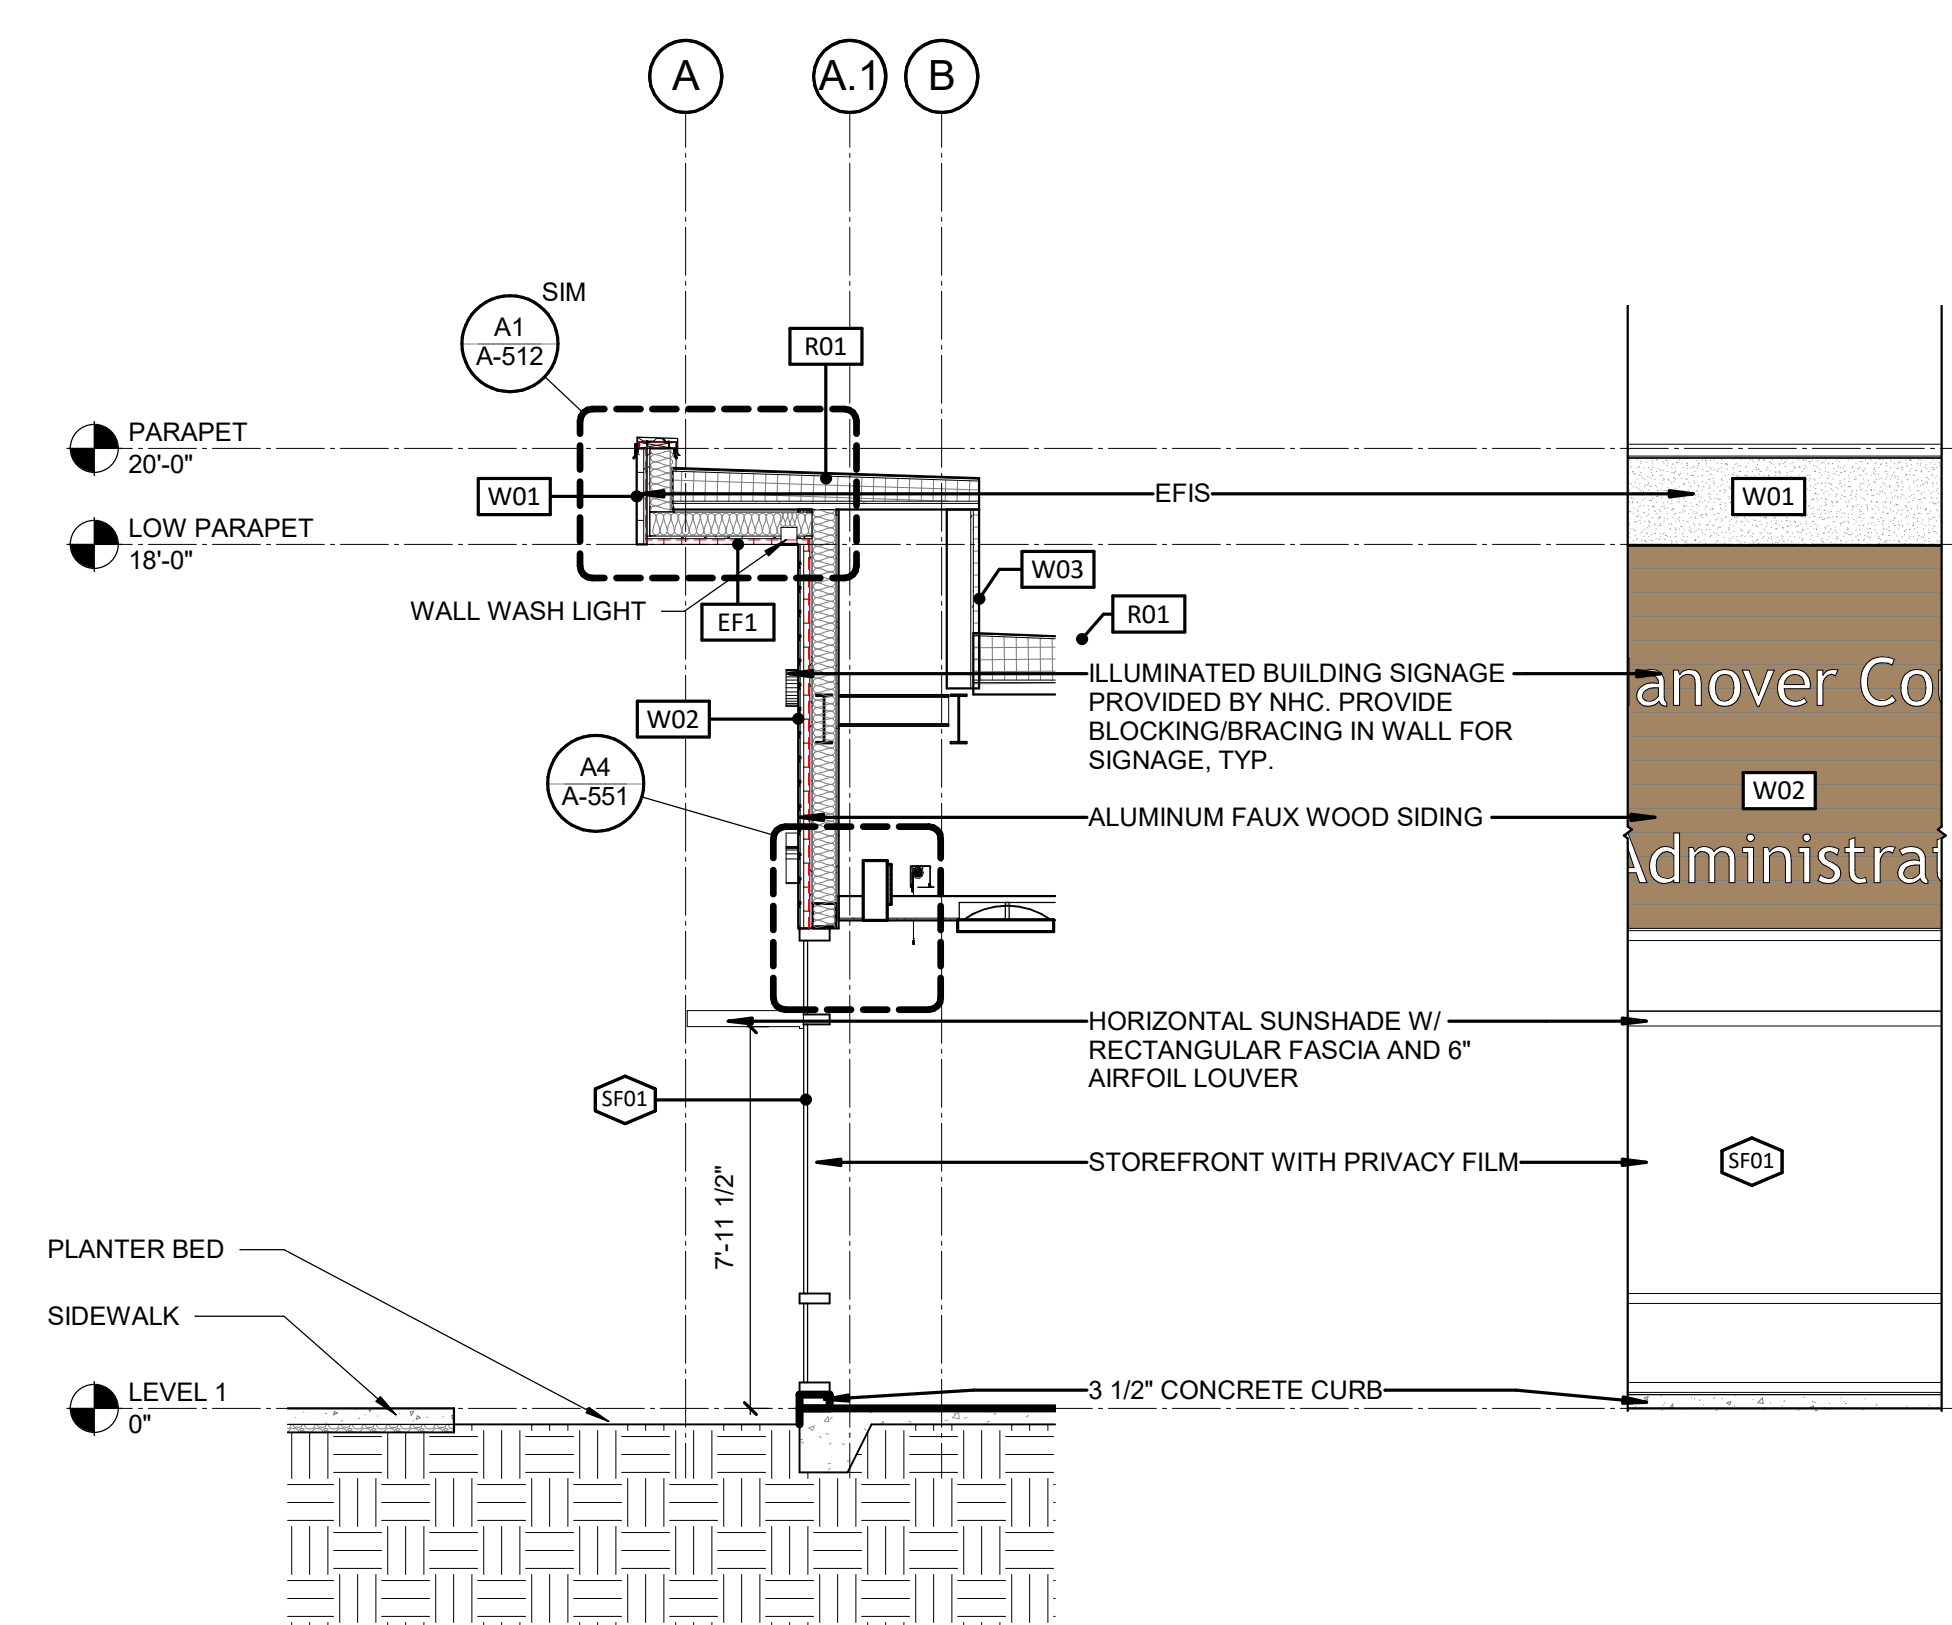

A1 WALL SECTION - STOREFRONT SUNSHADE

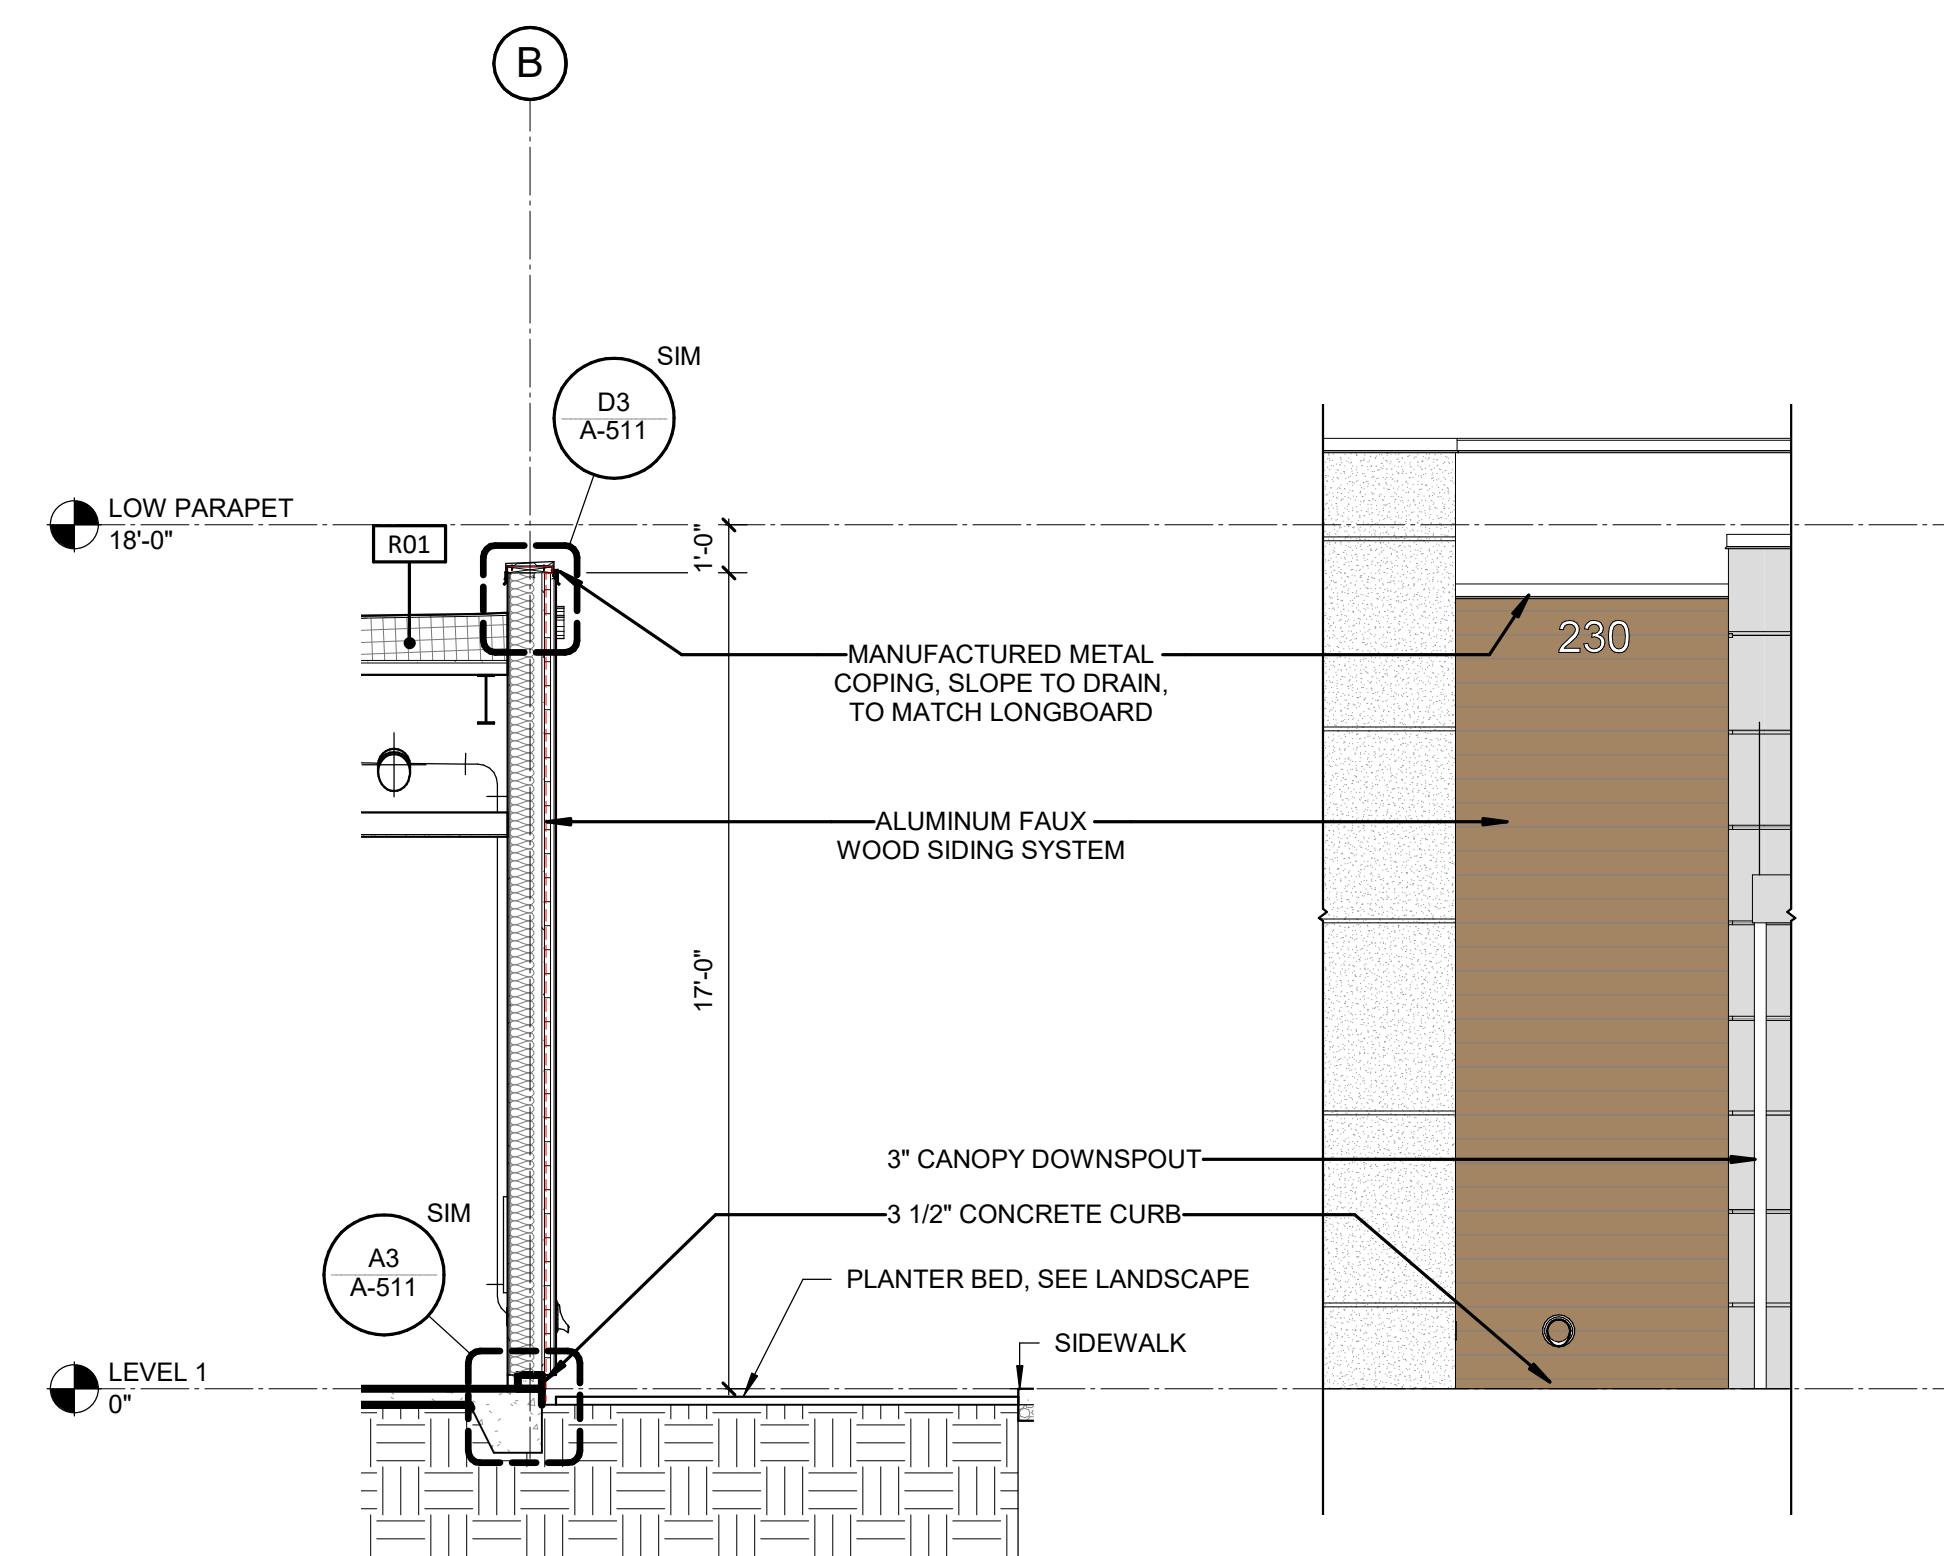


A3 WALL SECTION - (WOOD)

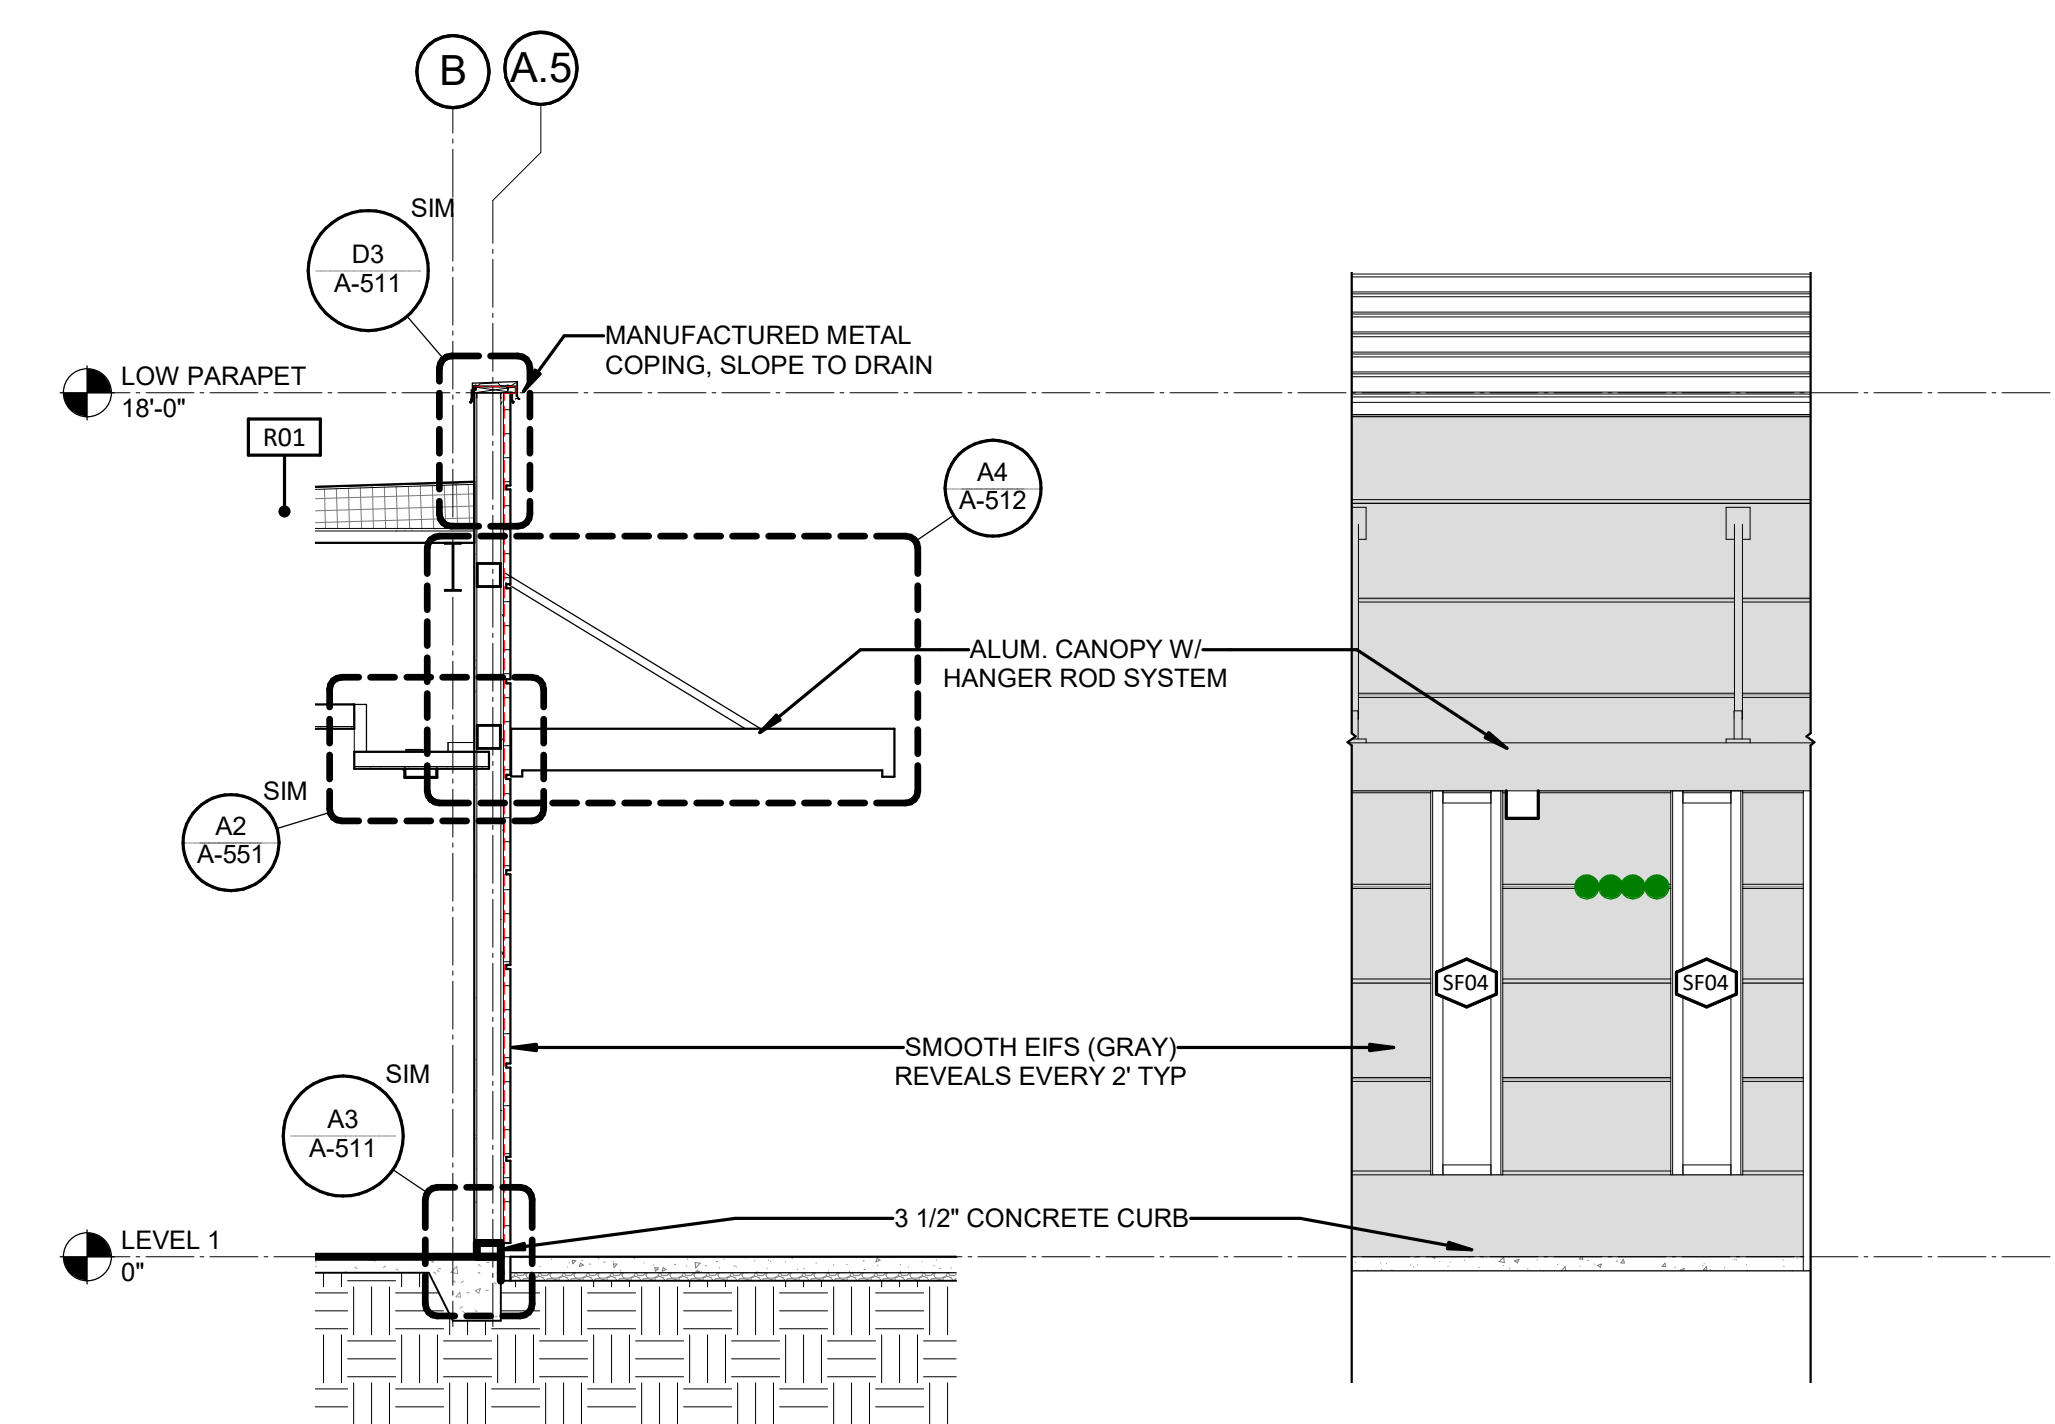


A5 WALL SECTION - SOUTH WALL (EIFS)

THE LINE SHOWN ABOVE IS EXACTLY ONE FOOT IN REALITY. DIMENSIONS ARE IN FEET AND INCHES.


E

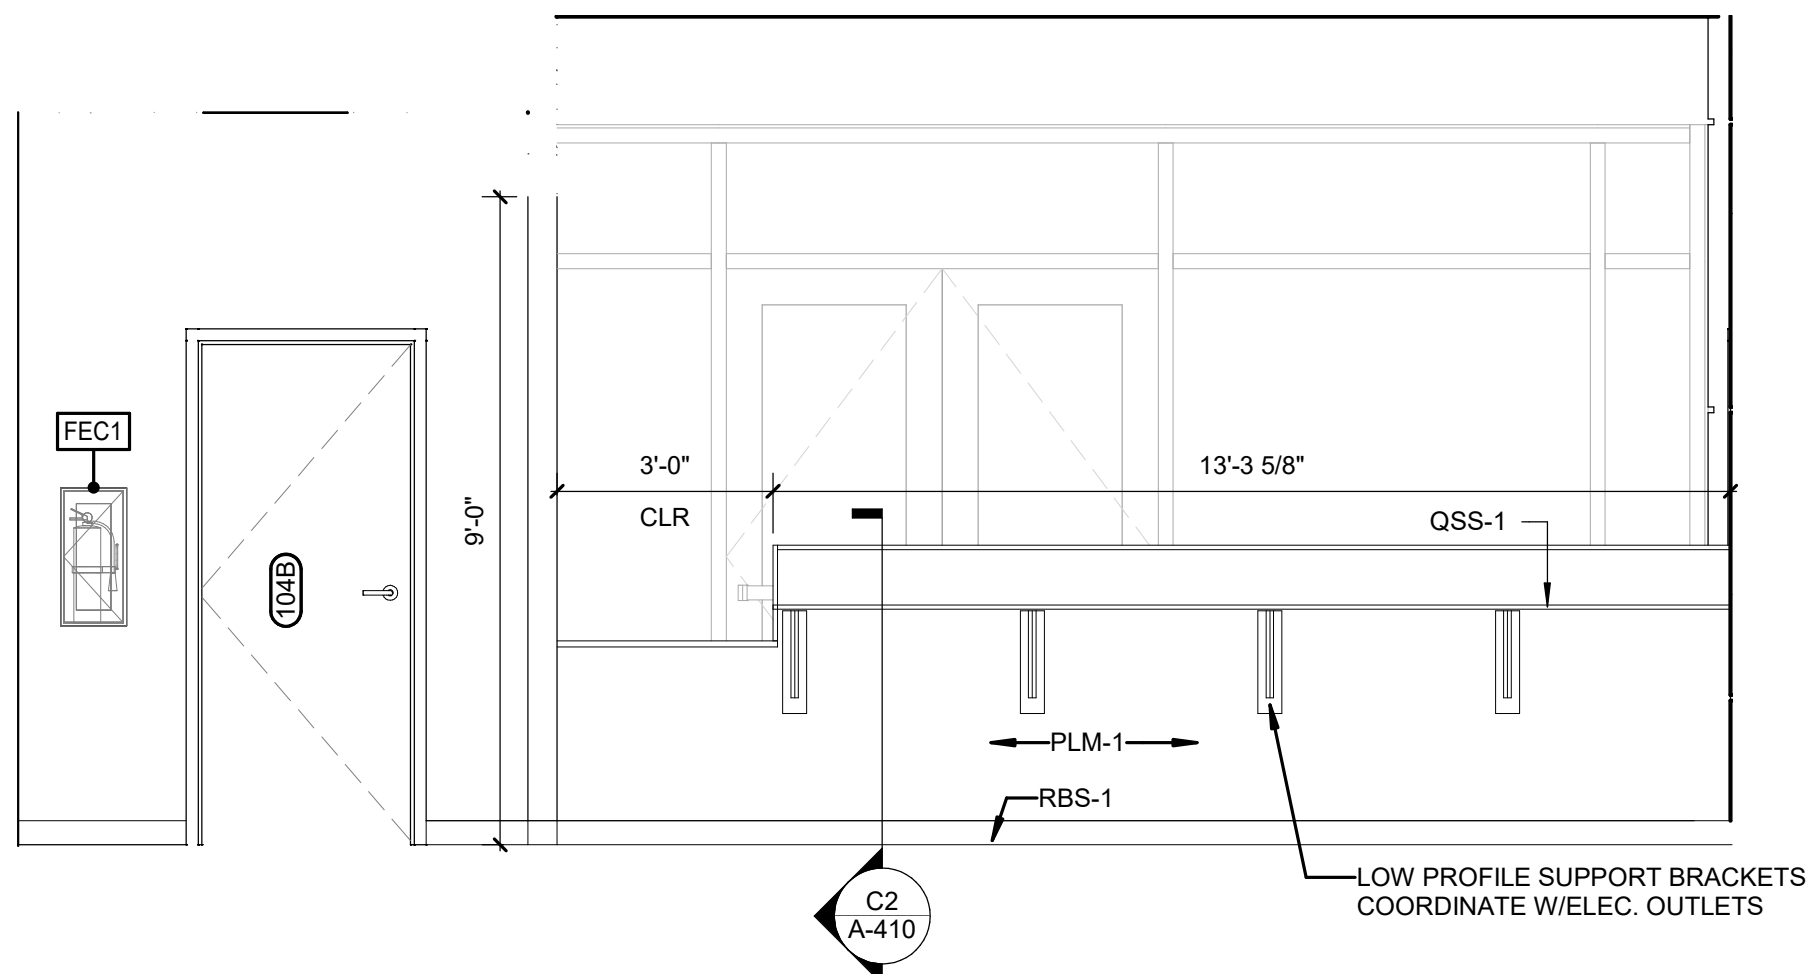


E1 INT. ELEV. - LOBBY 105 SOUTH
3/8" = 1'-0"

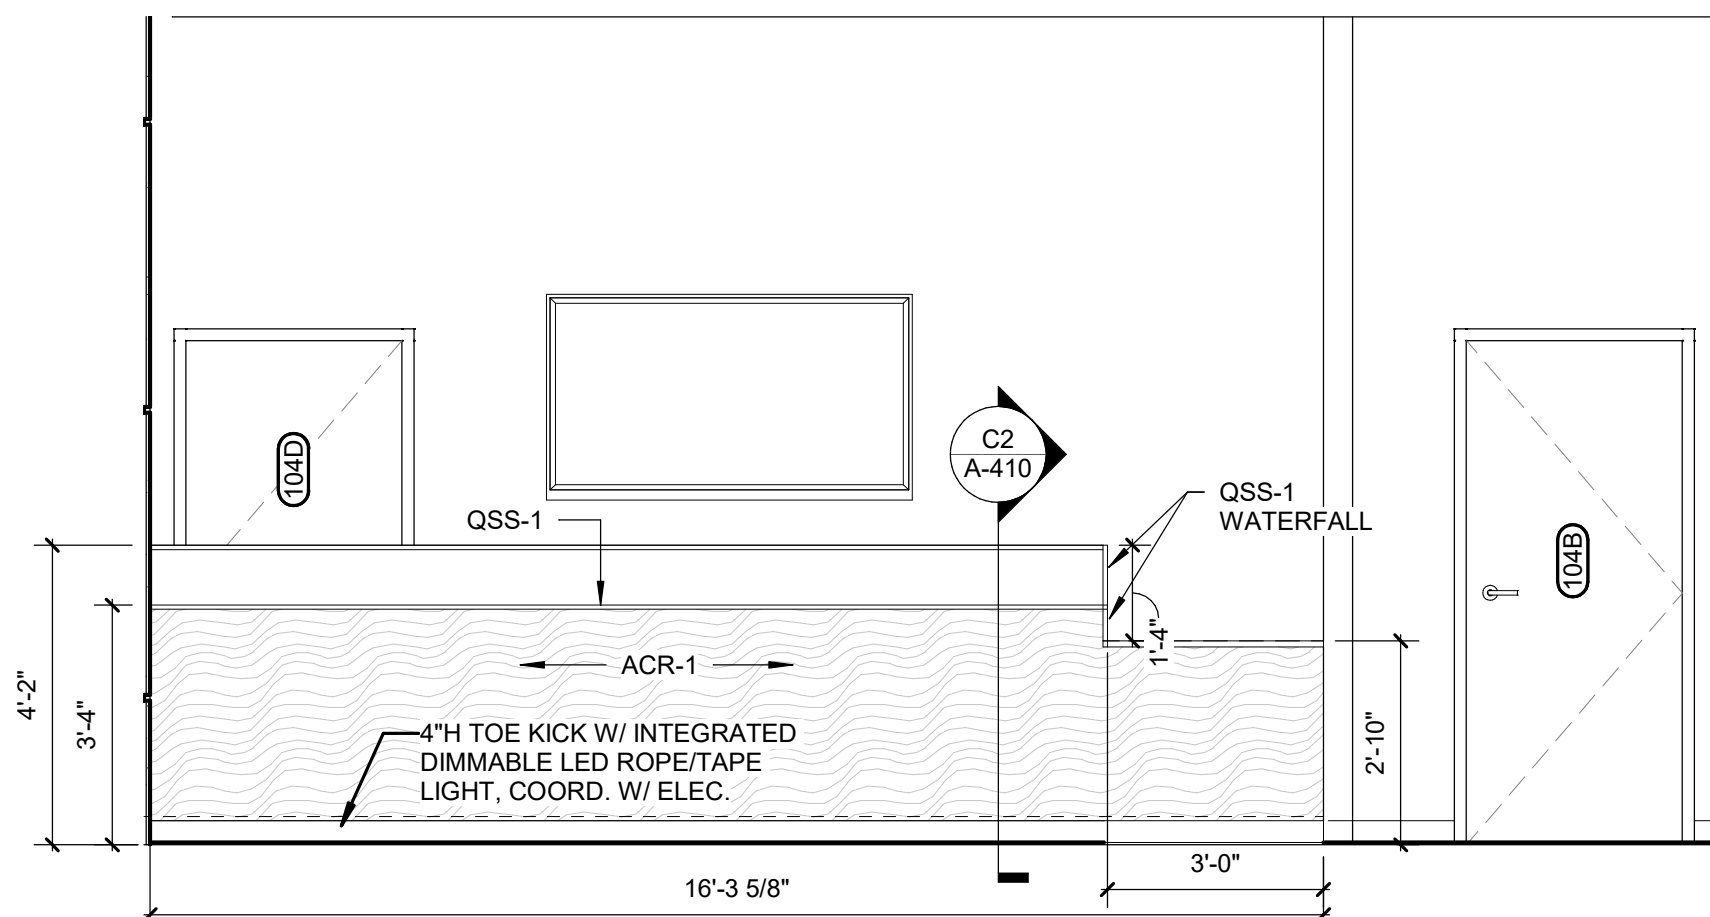

E2 INT. ELEV. - LOBBY 105 NORTH
3/8" = 1'-0"

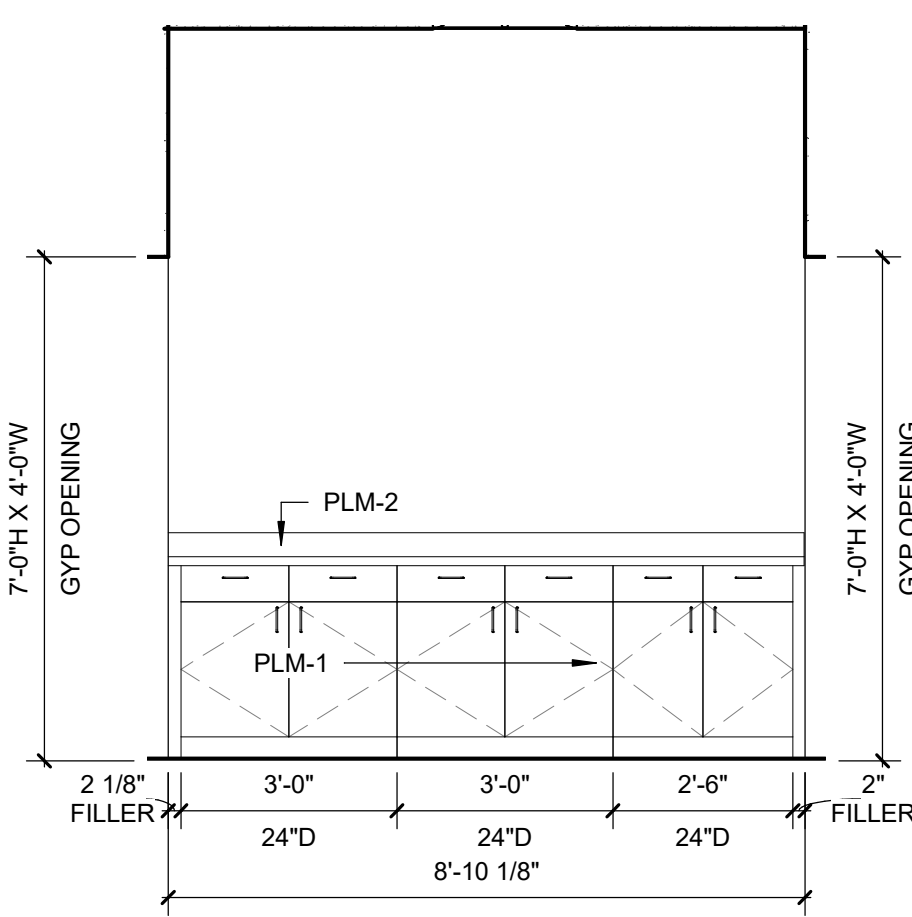


E4 INT. ELEV. - WK RM 114 WEST
3/8" = 1'-0"

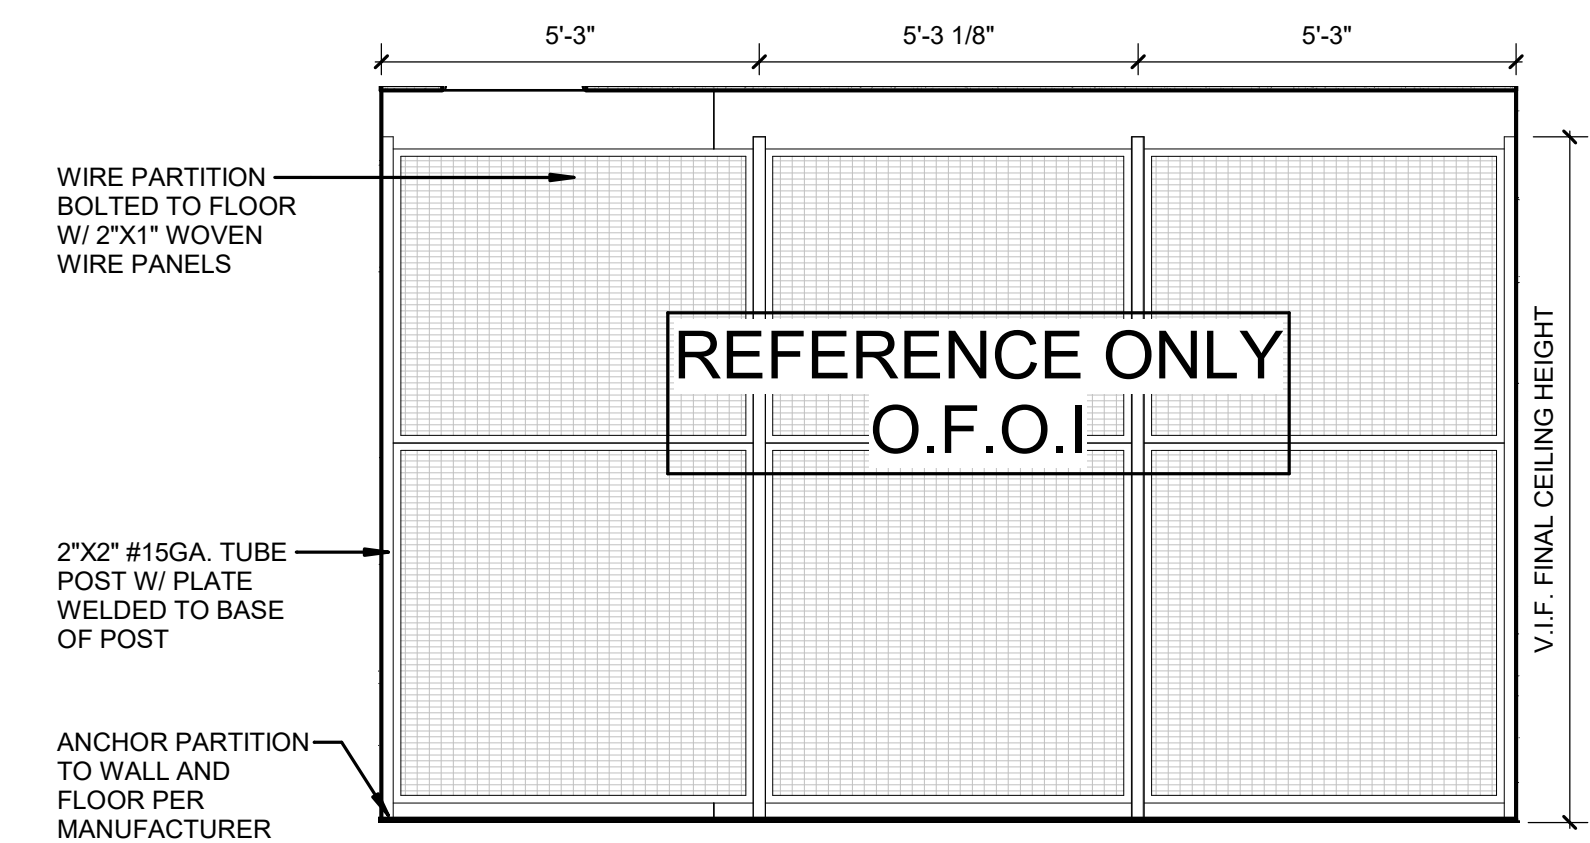


E5 WIRE PARTITION ELEVATION
3/8" = 1'-0"


D

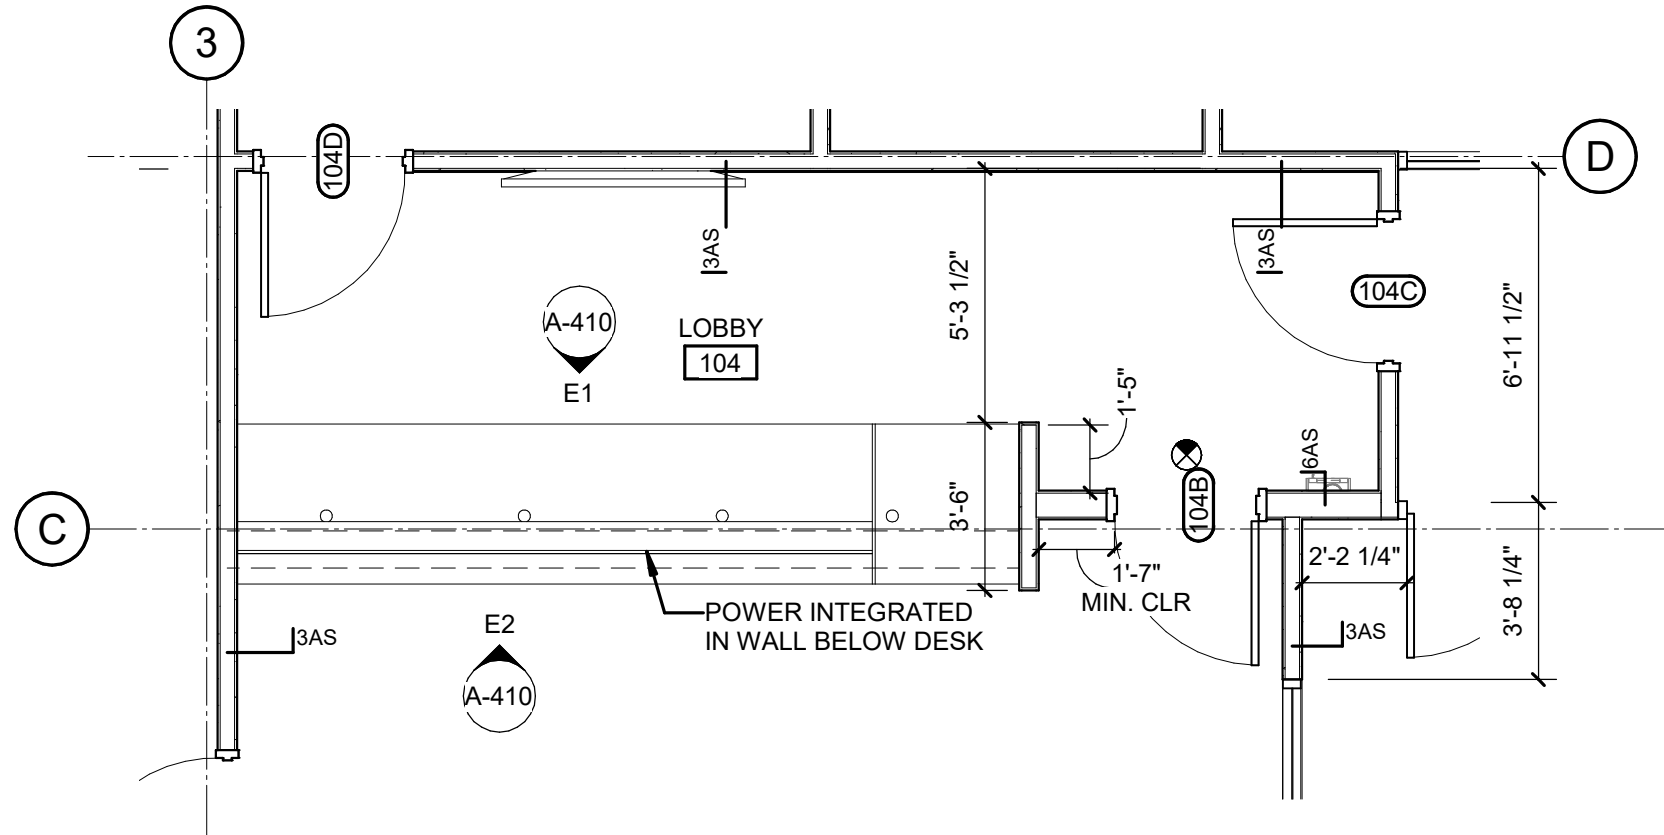


D1 ENL. PLAN - LOBBY 105
1/4" = 1'-0"

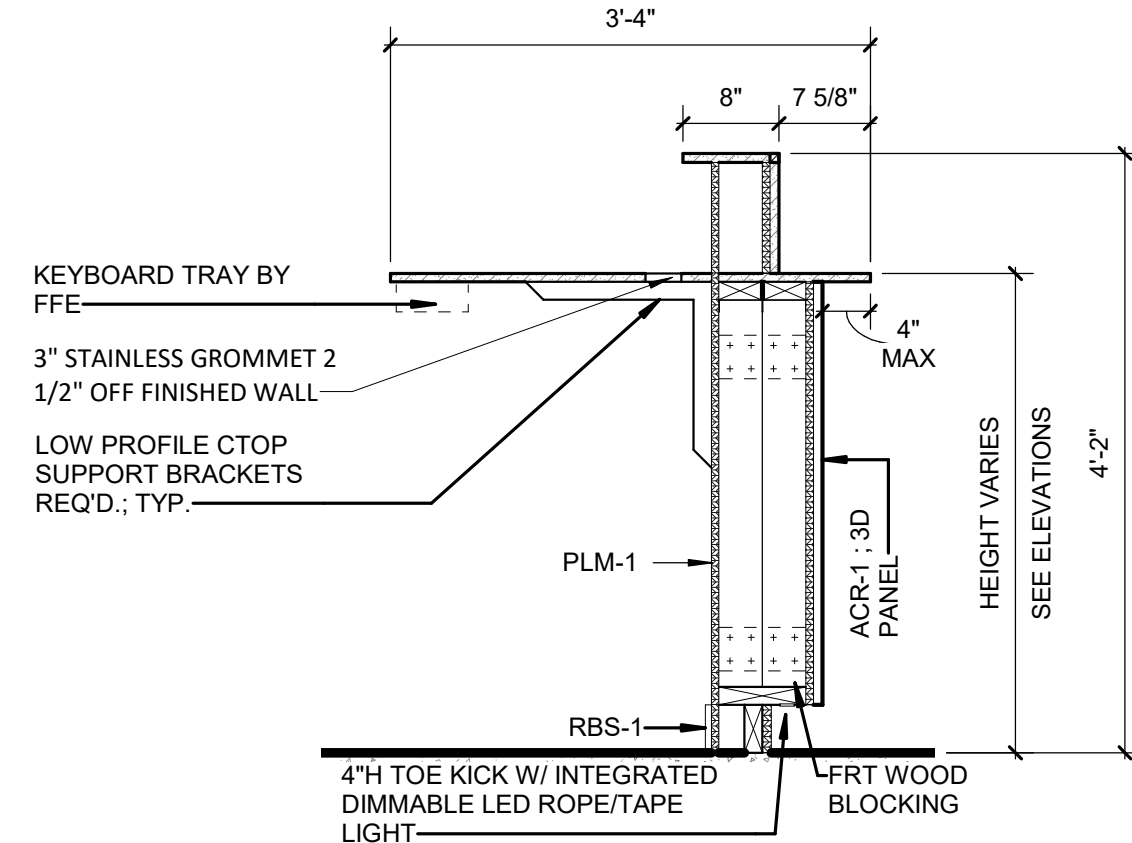


C2 SECTION- 105 LOBBY DESK
3/4" = 1'-0"

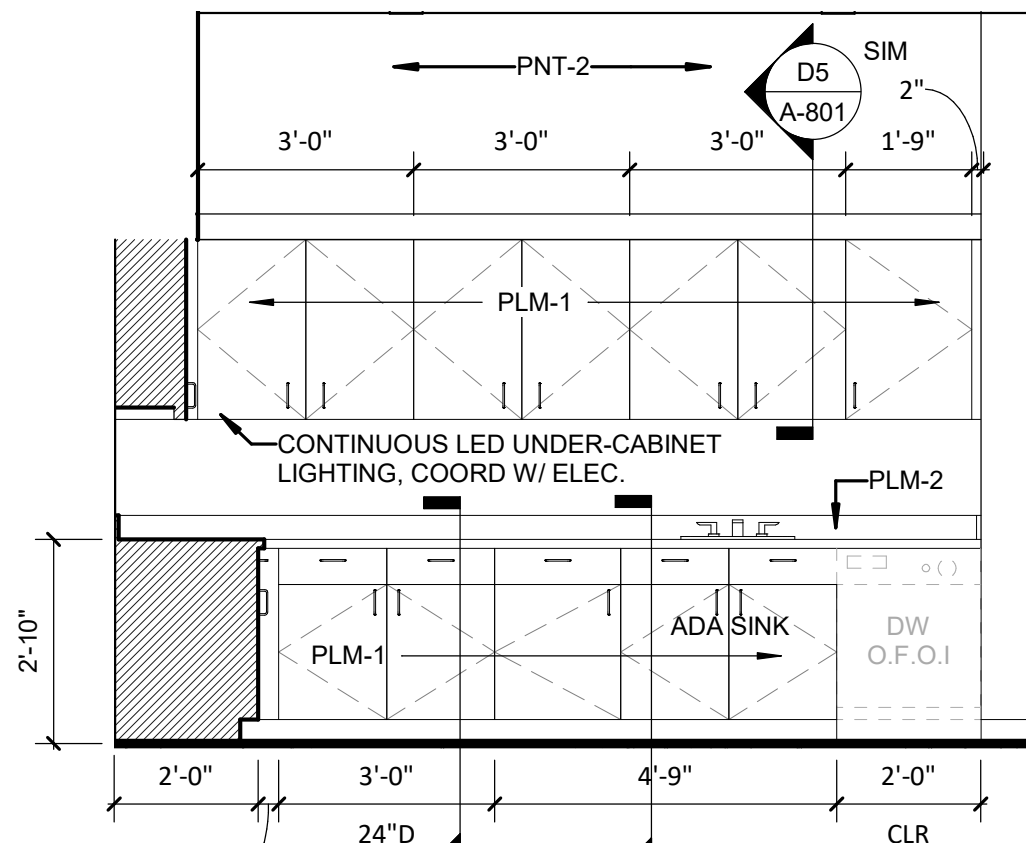

C3 INT. ELEV. - BREAK 115 SOUTH
3/8" = 1'-0"

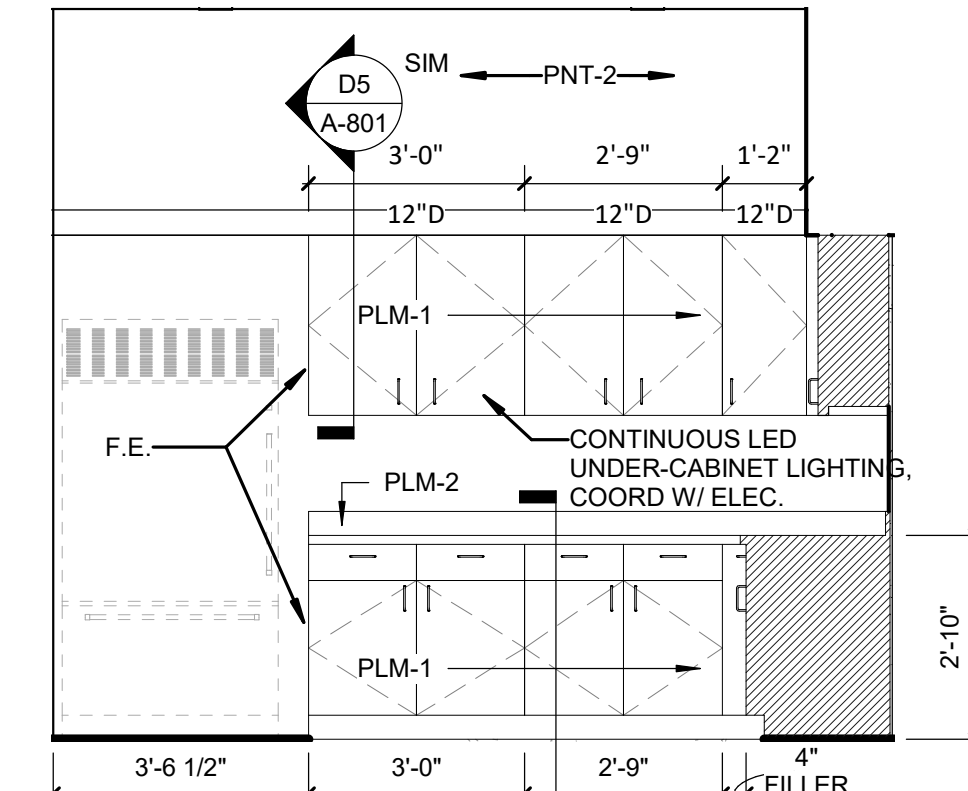


C4 INT. ELEV. - BREAK 115 WEST
3/8" = 1'-0"

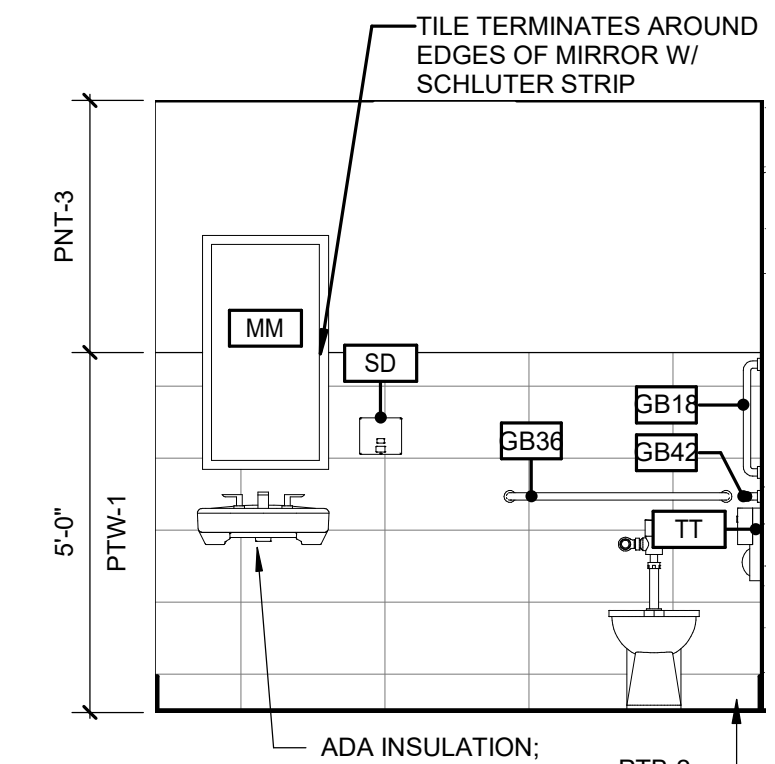


C5 INT. ELEV. - TLT TYP
3/8" = 1'-0"


C

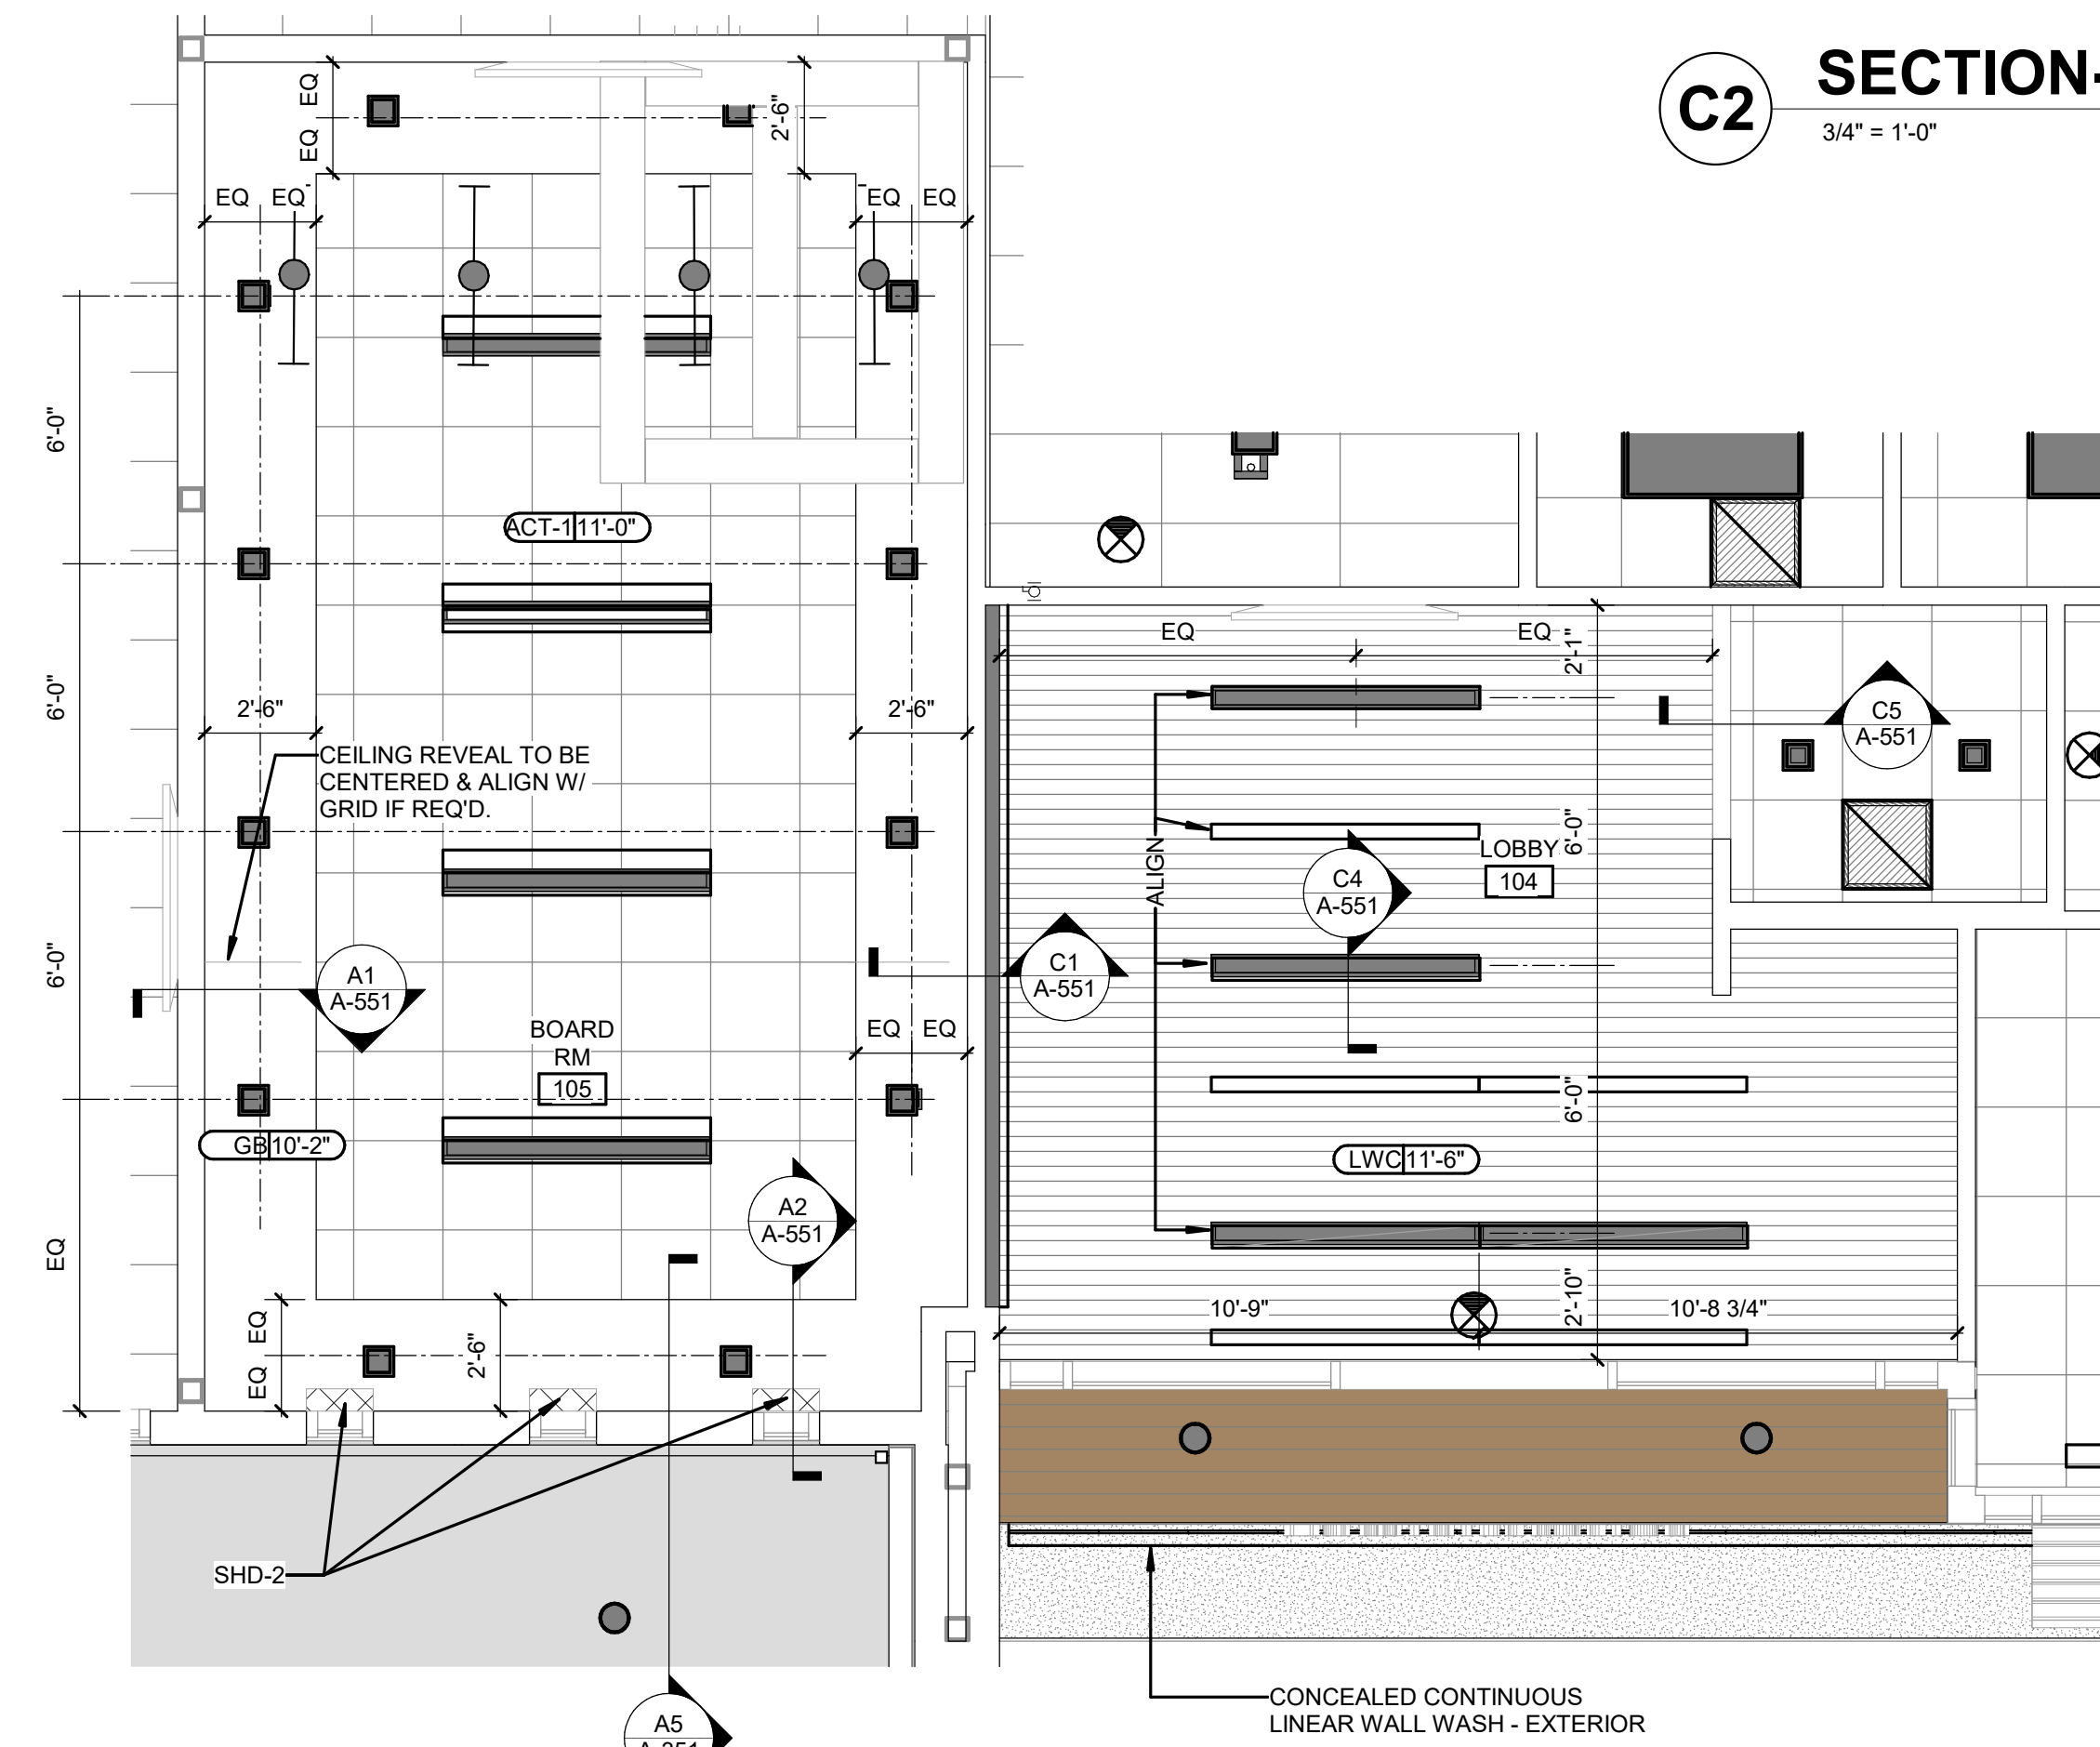


B1 ENLARGED RCP - LOBBY & BOARD RM
1/4" = 1'-0"

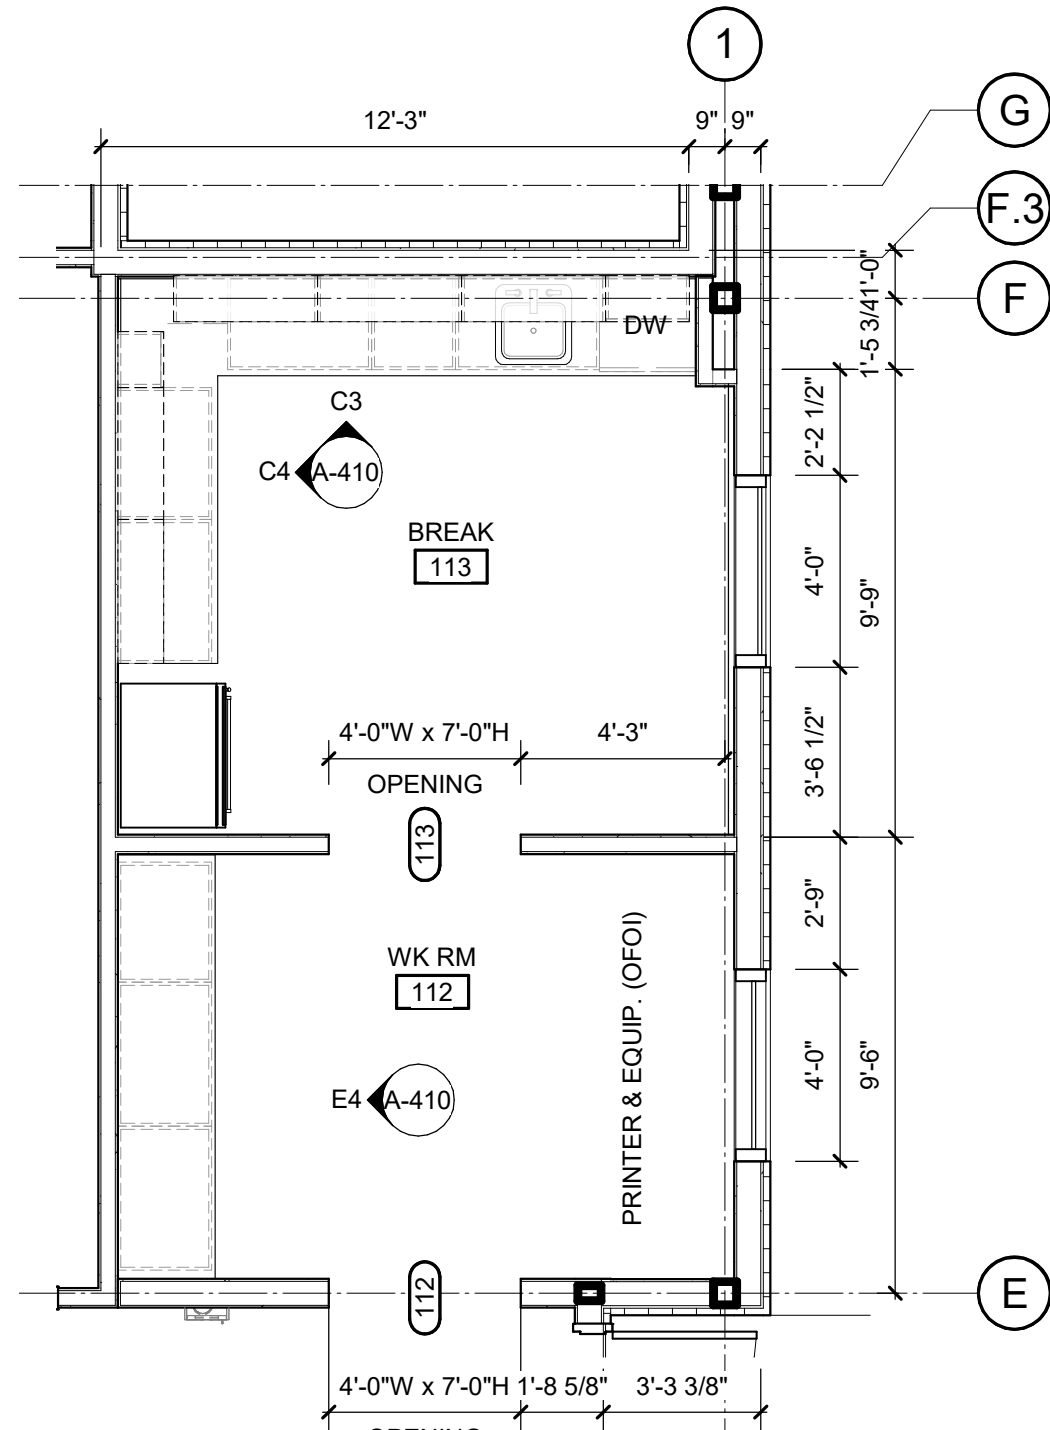

B2 ENL. PLAN - 114 & 115
1/4" = 1'-0"

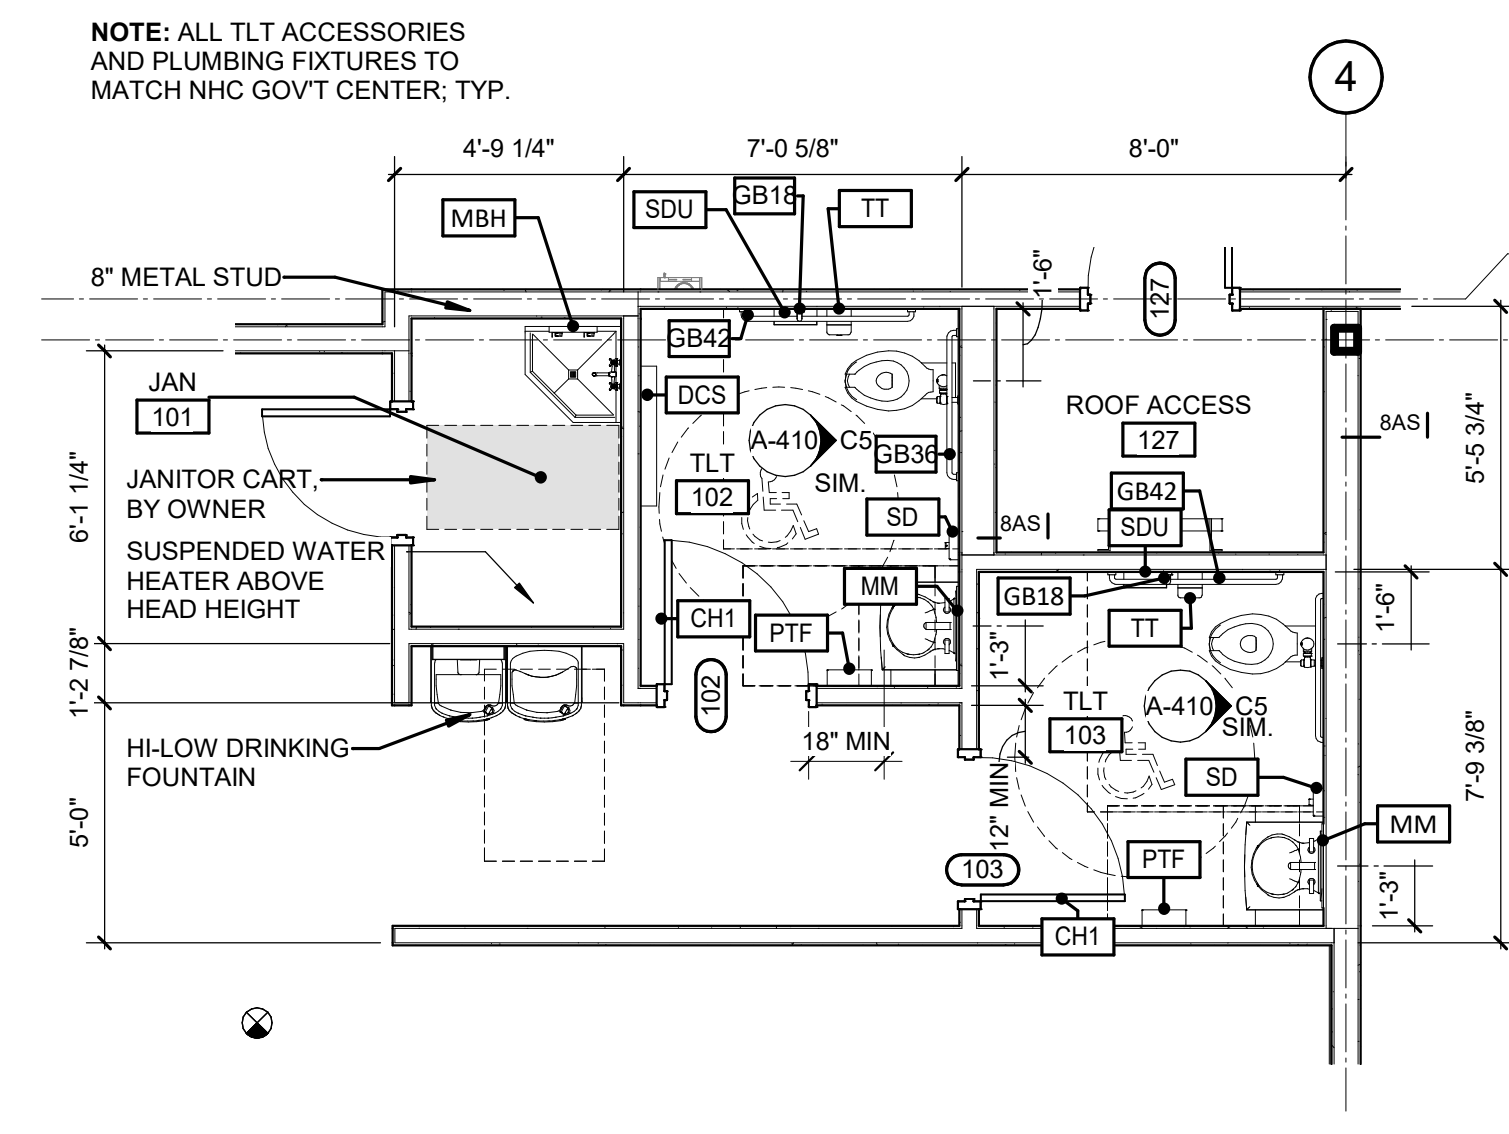


B4 ENL. PLAN - TLT 101, TLT 102, AND STO 103
1/4" = 1'-0"

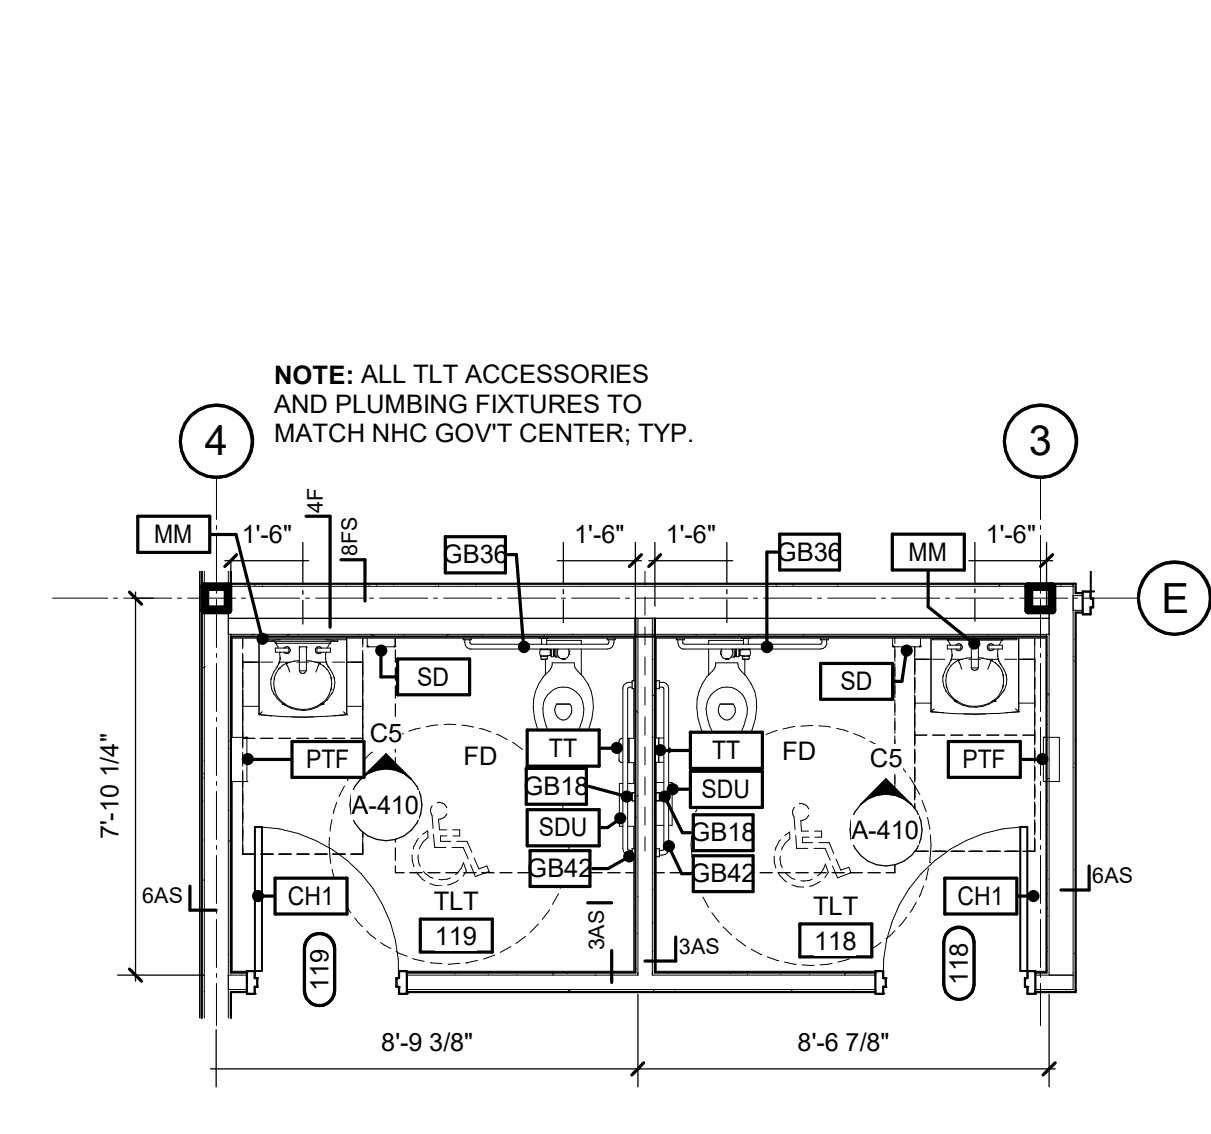

B5 ENL. PLAN - TLT 121 & 123
1/4" = 1'-0"

TYPICAL MOUNTING HEIGHTS

A

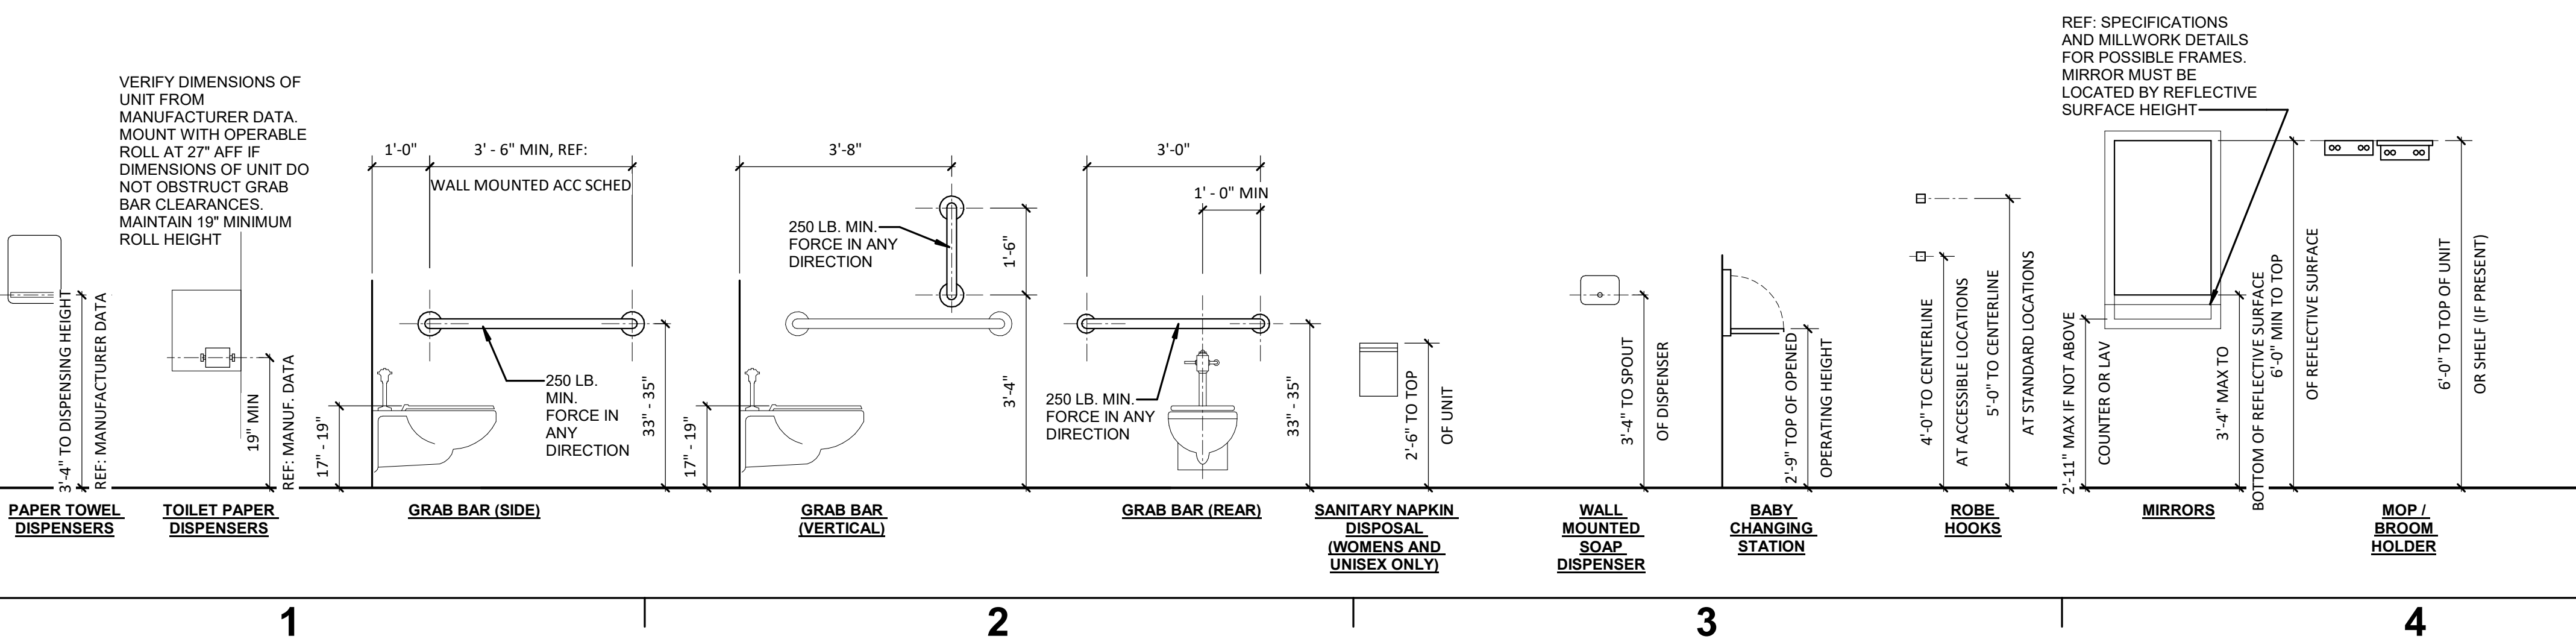

REF: SPECIFICATIONS AND MILLWORK DETAILS FOR POSSIBLE FRAMES. MIRROR MUST BE LOCATED BY REFLECTIVE SURFACE HEIGHT.

SEE SPECS FOR TOILET ACCESSORIES INFORMATION

RESTROOM ACCESSORIES		
TAG	DESCRIPTION	ITEM # & INSTALL
CH1	COAT HOOK	ASI 7308
DCS	DIAPER CHANGING STATION	ASI 9013-9 ROVAL, CFCI
GB18	GRAB BAR- VERTICAL- 18"	ASI 3800, CFCI
GB36	GRAB BAR- HORIZONTAL- 36"	ASI 3800, CFCI
GB42	GRAB BAR- HORIZONTAL- 42"	ASI 3800, CFCI
MBH	MOP AND BROOM HOLDER	MOP/ BROOM HOLDER
MM	MIRROR	ASI 0600 SERIES, CFCI
PTF	PAPER TOWER DISPENSER	OF CI
SD	SOAP DISPENSER	OF CI
SDU	SANITARY NAPKIN DISPOSAL UNIT	ASI 0852, CFCI
TT	TP DISPENSER	OF CI

PROVIDE BLOCKING IN WALL FOR ALL RESTROOM ACCESSORIES



NHC BOARD OF ELECTIONS



101 NORTH THIRD STREET, SUITE 500
WILMINGTON, NORTH CAROLINA 28401
TEL. 910.790.9901 FAX. 910.790.3111
WWW.LS3P.COM



COPYRIGHT 2023 ALL RIGHTS RESERVED. PRINTED OR ELECTRONIC DRAWINGS AND DOCUMENTATION MAY NOT BE REPRODUCED IN ANY FORM WITHOUT WRITTEN PERMISSION FROM LS3P ASSOCIATES LTD.

New Hanover County
Board of Elections
230 Government Center Drive
Wilmington, NC 28403
LSP PROJECT: 7702- 90810

DATE	DESCRIPTION
0 2023.04.03	PERMIT SET

SHEET NAME:
ENLARGED PLANS
AND INTERIOR
ELEVATIONS

ORIG SUBMISSION: 2023.04.03

SHEET:


A-410

PERMIT SET


[illegible]




1. ALL COPING TO MATCH COLOR OF EXTERIOR VENEER MATERIAL.
2. ALL EXPOSED WATERPROOFING MEMBRANE AT FOUNDATIONS TO MATCH COLOR OF CONCRETE
3. GASKET SEALER UNDER BOTTOM PLATE OF STUD, TYP.

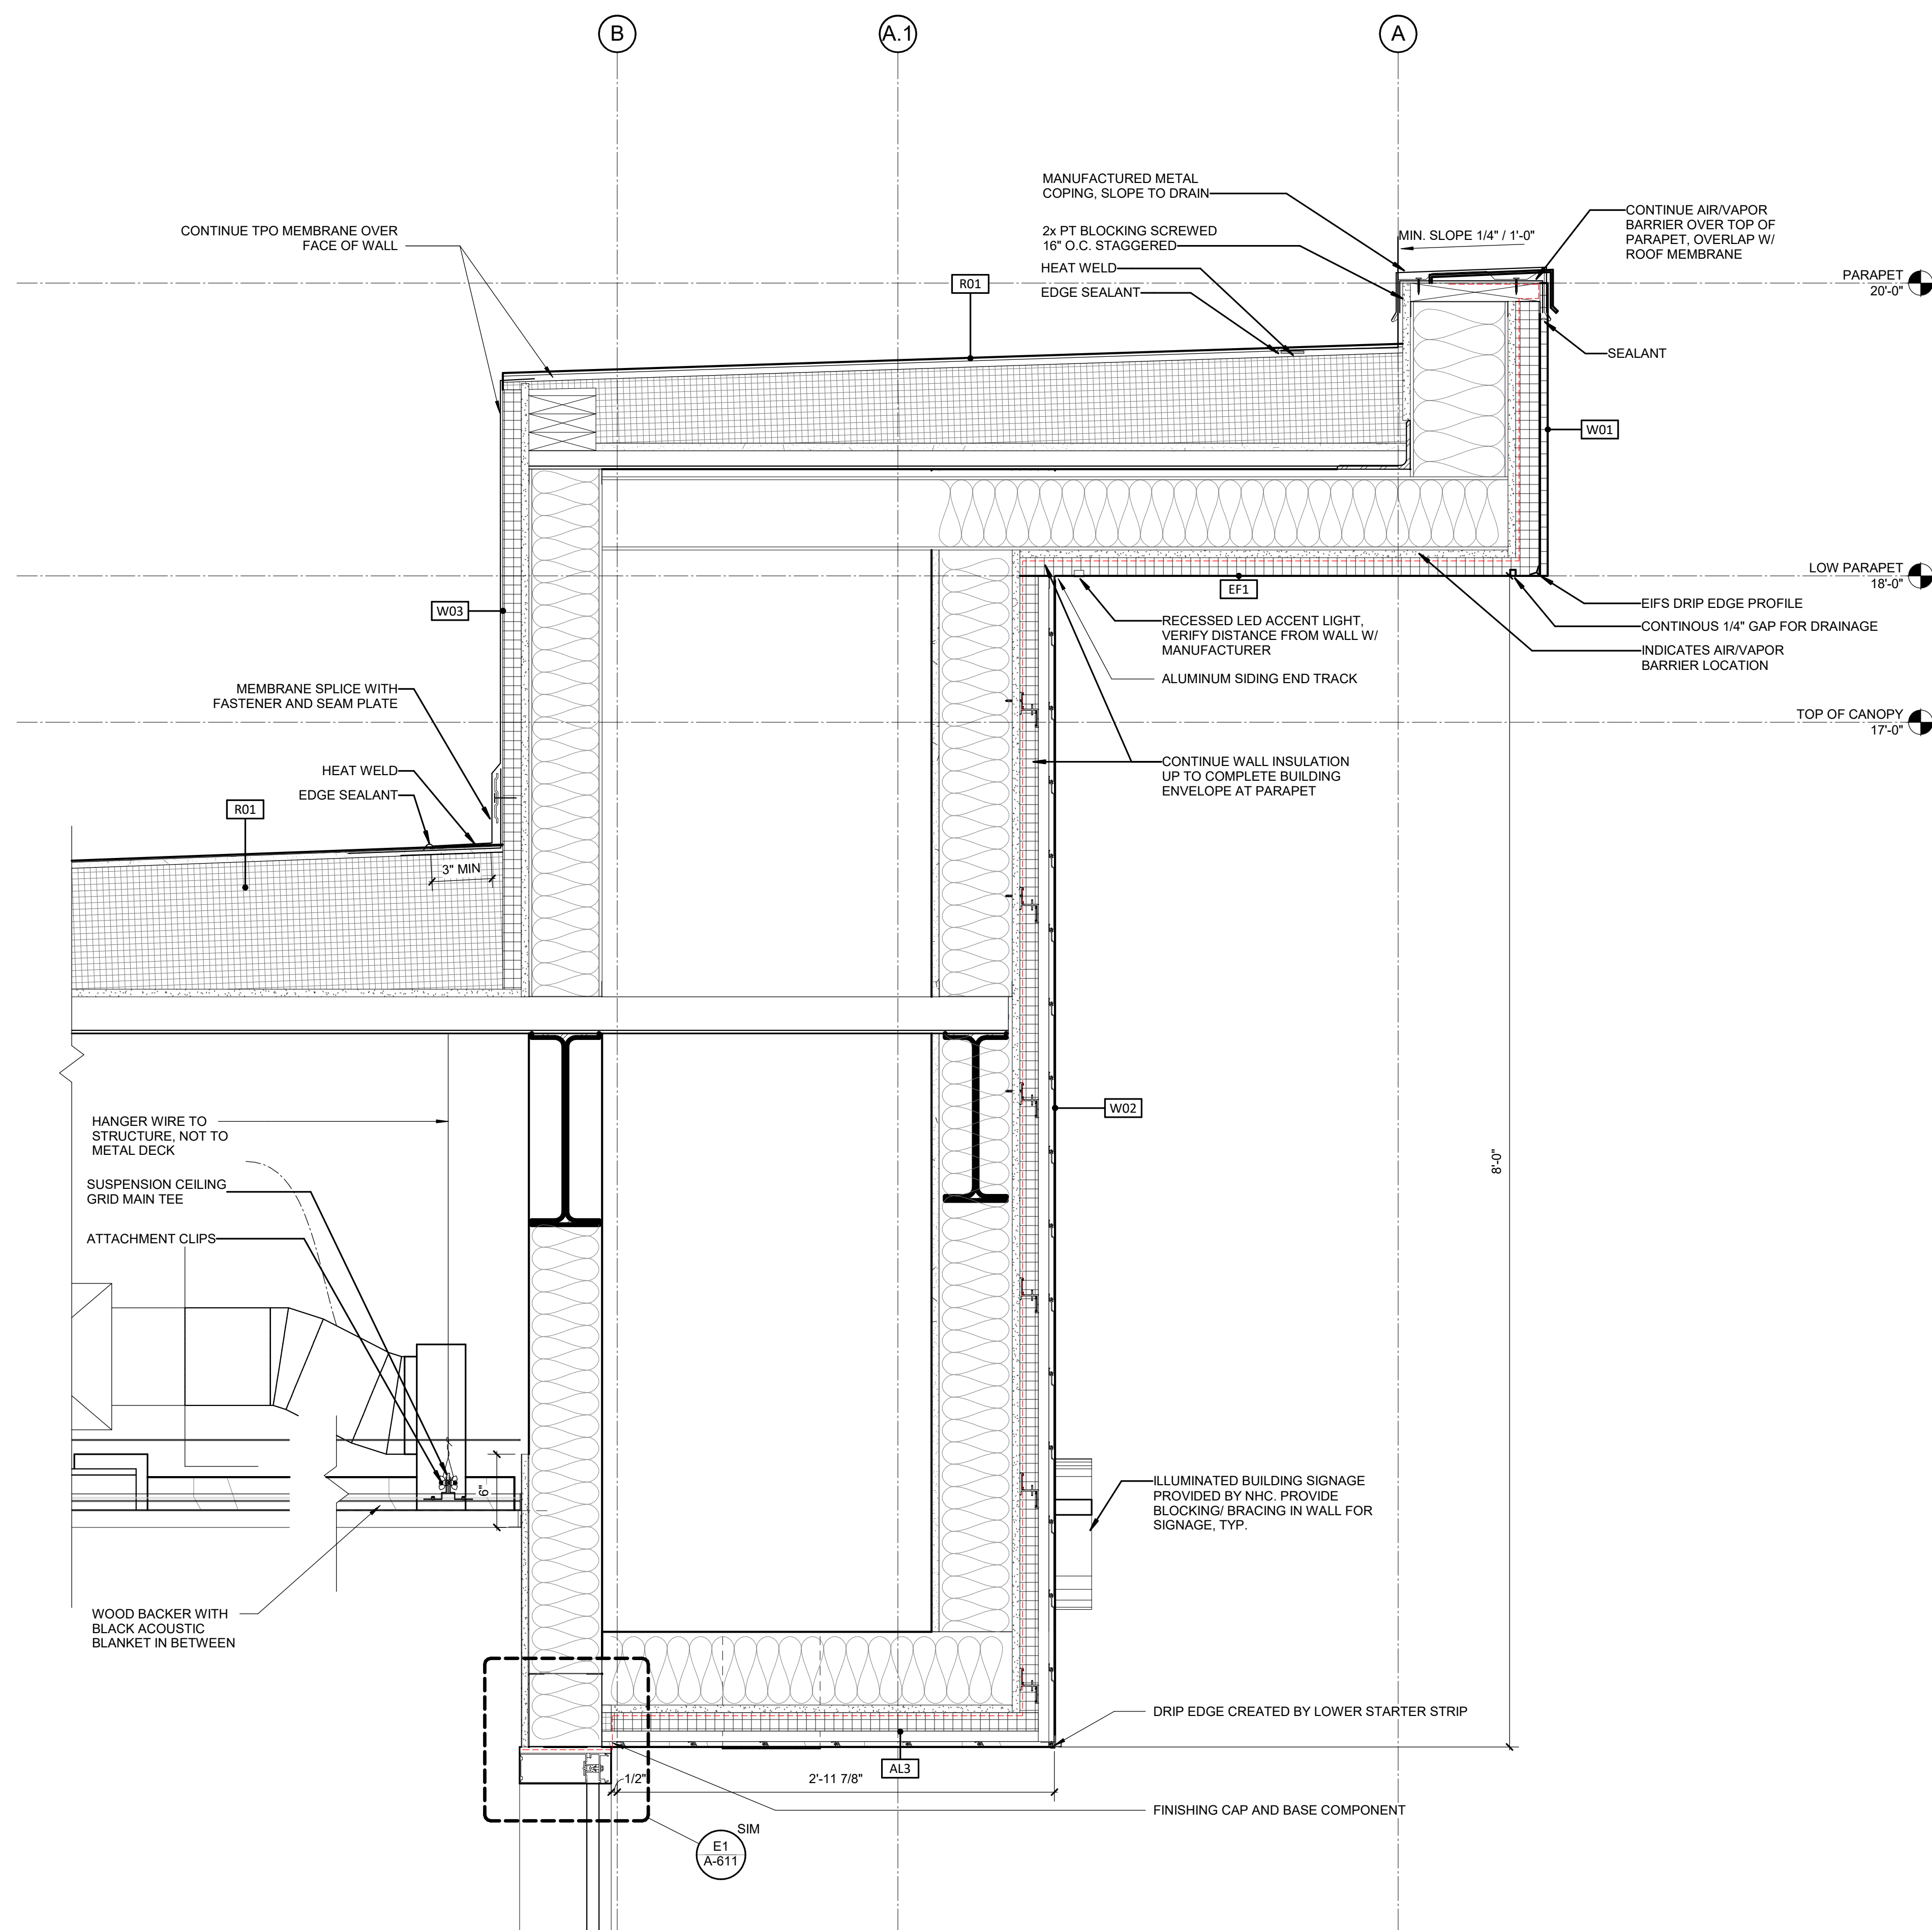


A1 SECTION DETAIL 1
1 1/2" = 1'-0"

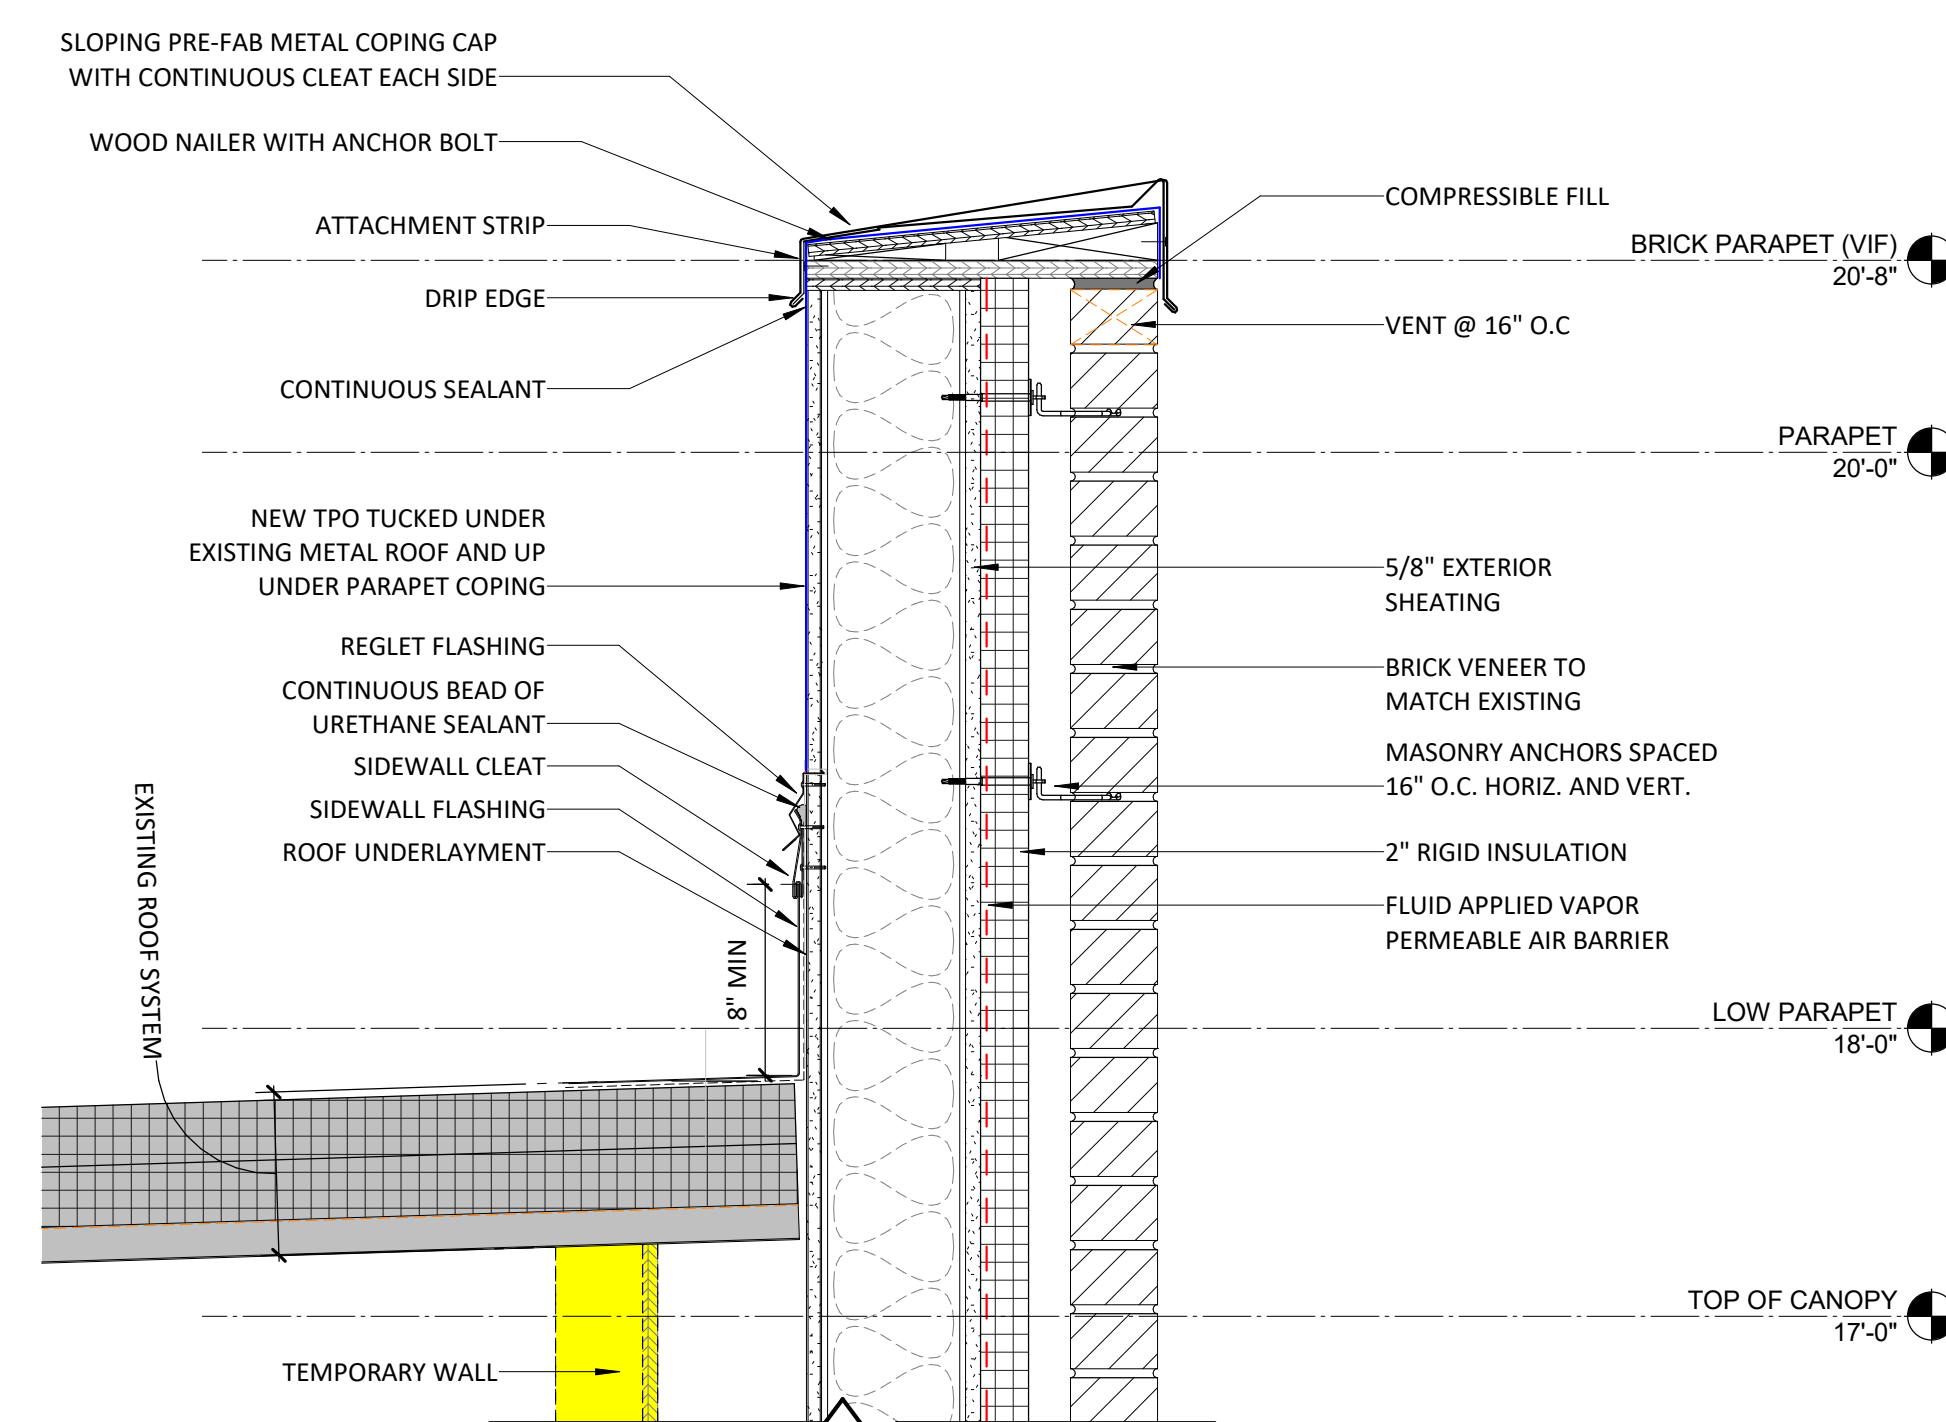

D5 SECTION DETAIL - BRICK @ PARAPET
1 1/2" = 1'-0"

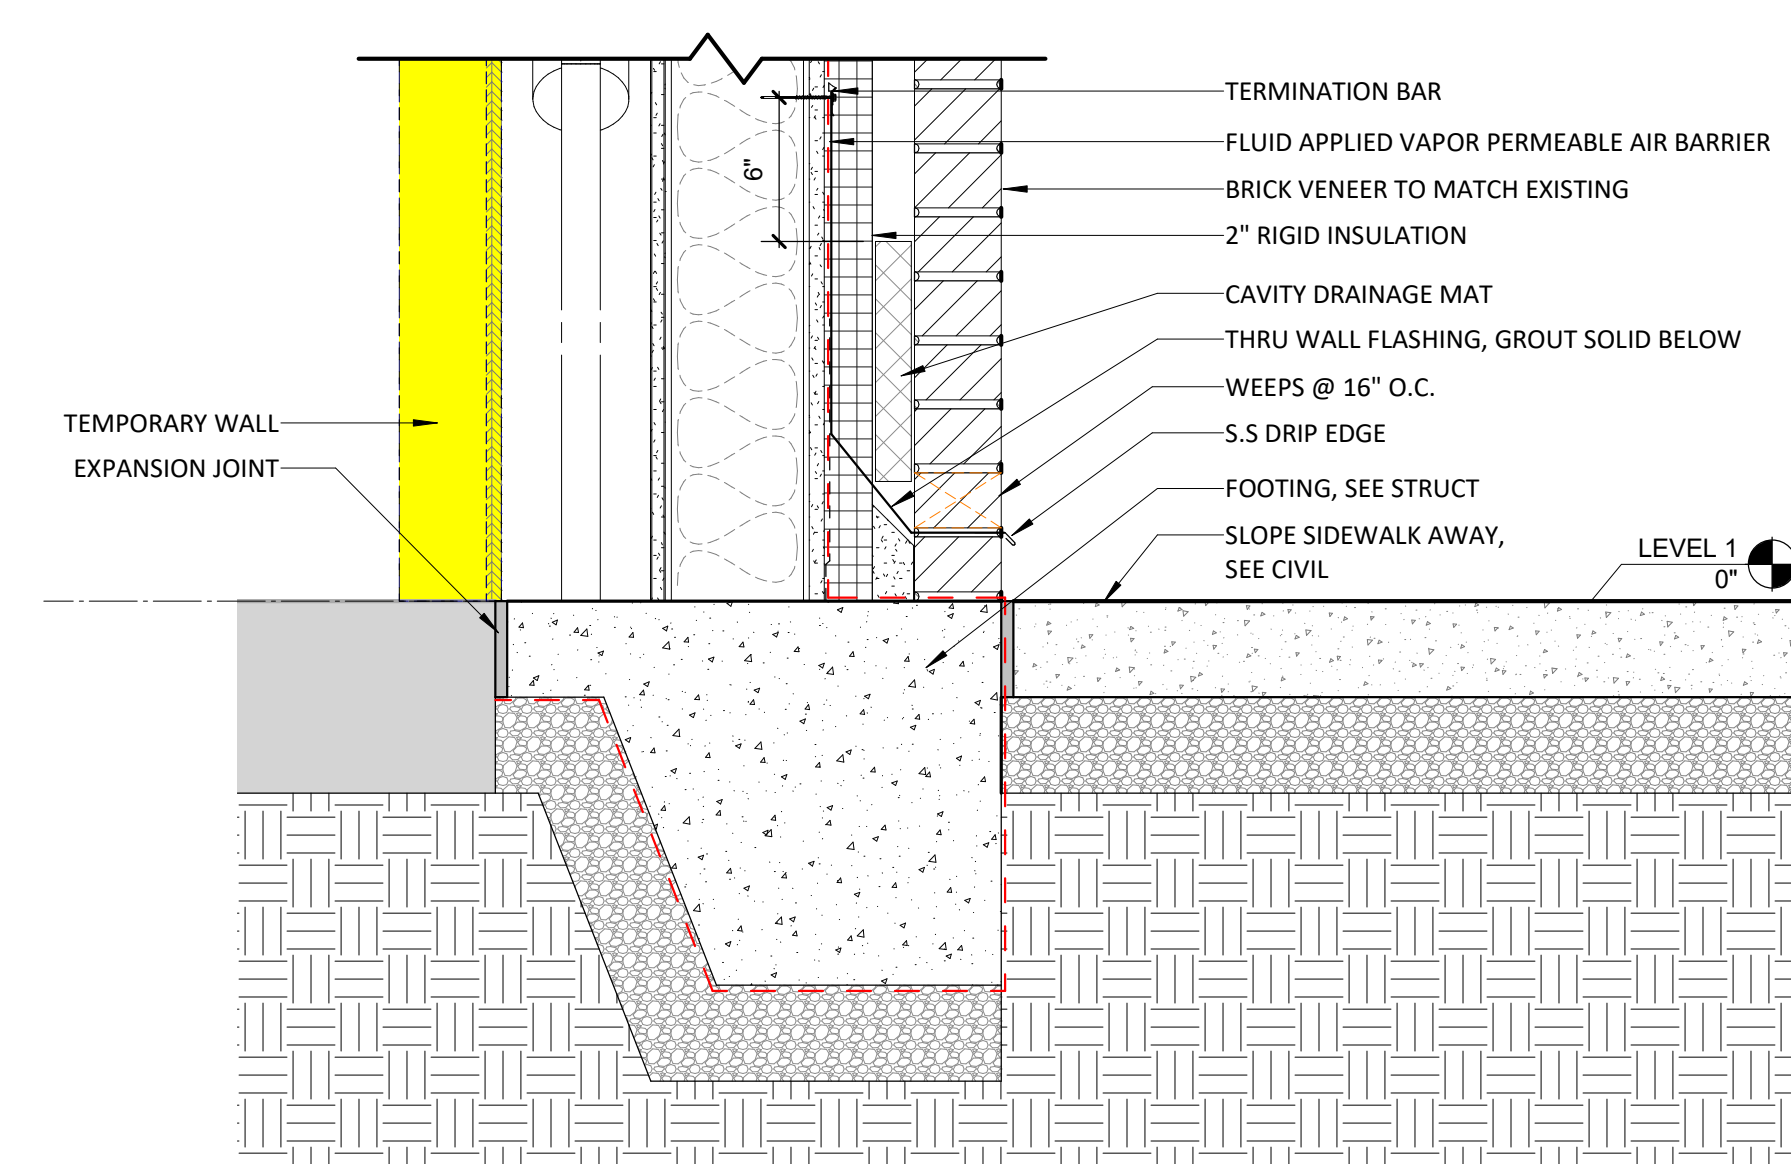

C5 SECTION DETAIL - BRICK @ SLAB
1 1/2" = 1'-0"

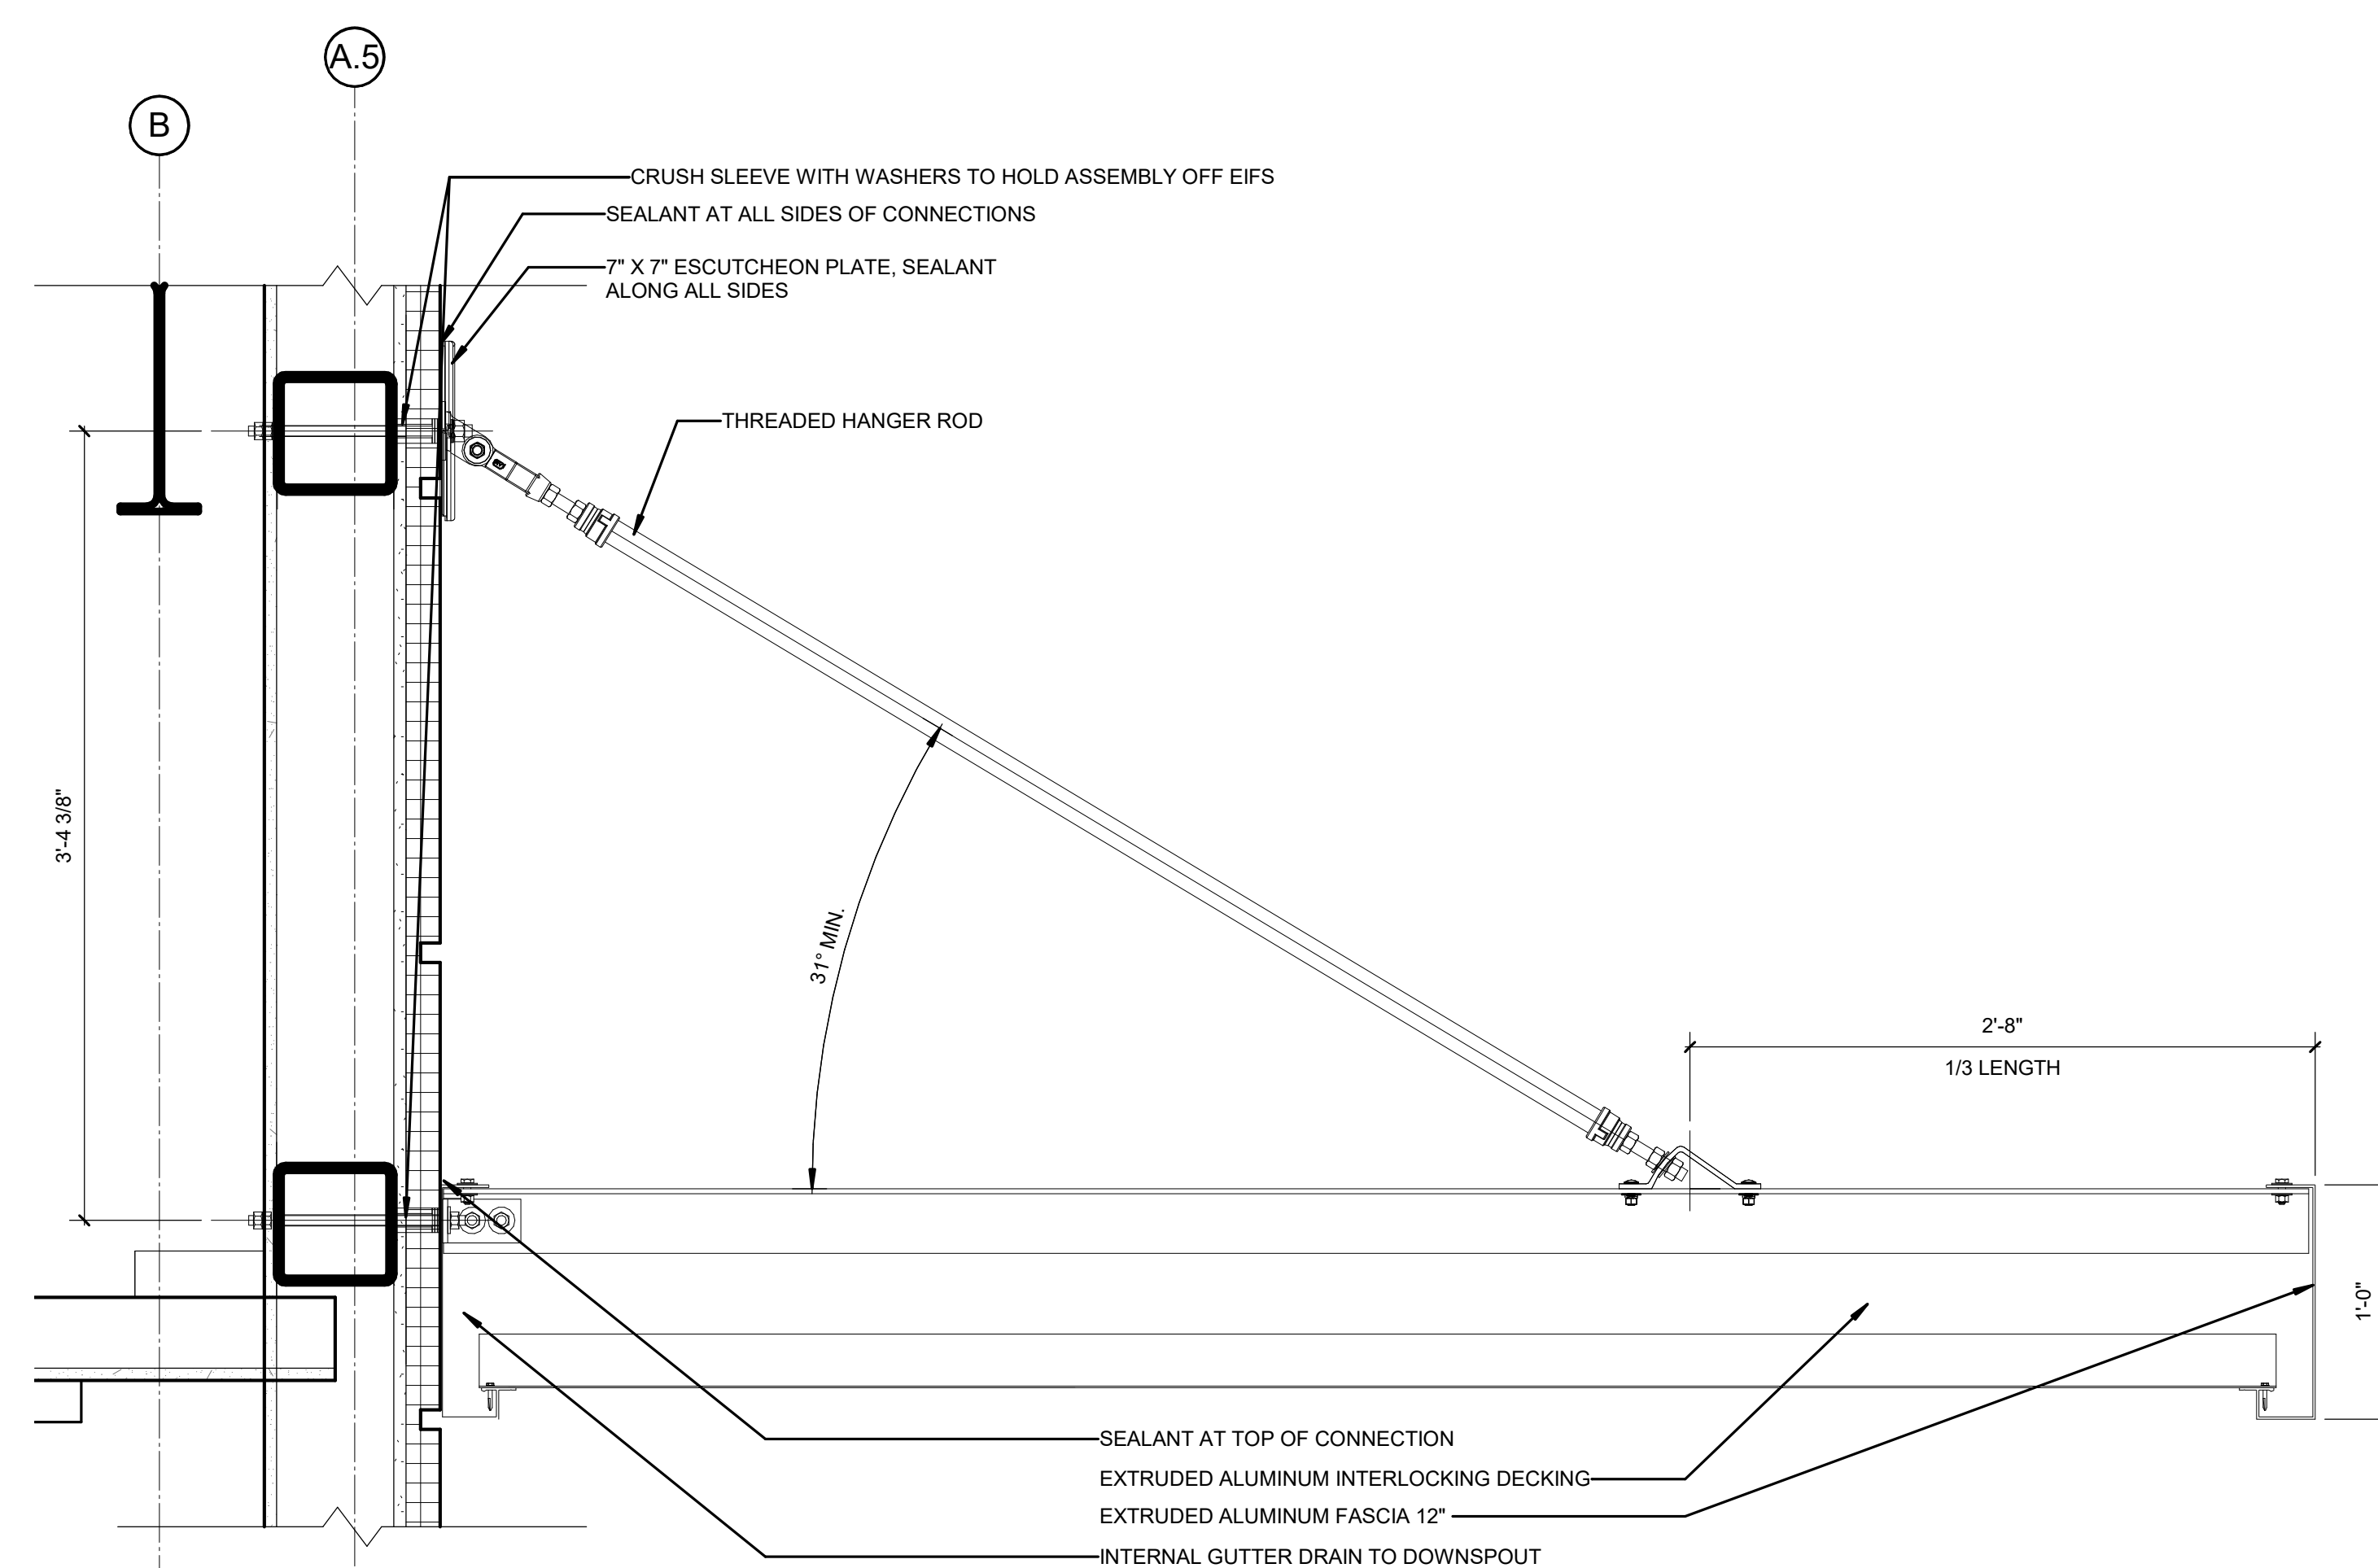

A4 **PREFAB CANOPY SECTION**
1 1/2" = 1'-0"



NHC BOARD OF ELECTIONS

LS3P

101 NORTH THIRD STREET, SUITE 500
WILMINGTON, NORTH CAROLINA 28401
TEL. 910.790.9901 FAX. 910.790.3111
WWW.LS3P.COM



2023.04.04 11:39:05.04

COPYRIGHT 2023 ALL RIGHTS RESERVED. PRINTED OR
ELECTRONIC DRAWINGS AND DOCUMENTATION MAY
NOT BE REPRODUCED IN ANY FORM WITHOUT WRITTEN
PERMISSION FROM LS3P ASSOCIATES LTD.

New Hanover County Board of Elections

2230 Government Center Drive
Wilmington, NC 24803

LS3P PROJECT: 7702-190810

[illegible]

SHEET NAME:
EXTERIOR
SECTION DETAILS

ORIG 2023.04.03
SUBMISSION:

SHEET:

A-512

PERMIT SET



COPYRIGHT 2023 ALL RIGHTS RESERVED. PRINTED OR
 ELECTRONIC DRAWINGS AND DOCUMENTATION MAY
 NOT BE REPRODUCED IN ANY FORM WITHOUT WRITTEN
 PERMISSION FROM LS3P ASSOCIATES LTD.


[illegible]

HEET NAME:
VOTING CANOPY
SECTION DETAILS

RIG 2023.04.0
SUBMISSION:

HEET: **A-513**

PERMIT SE

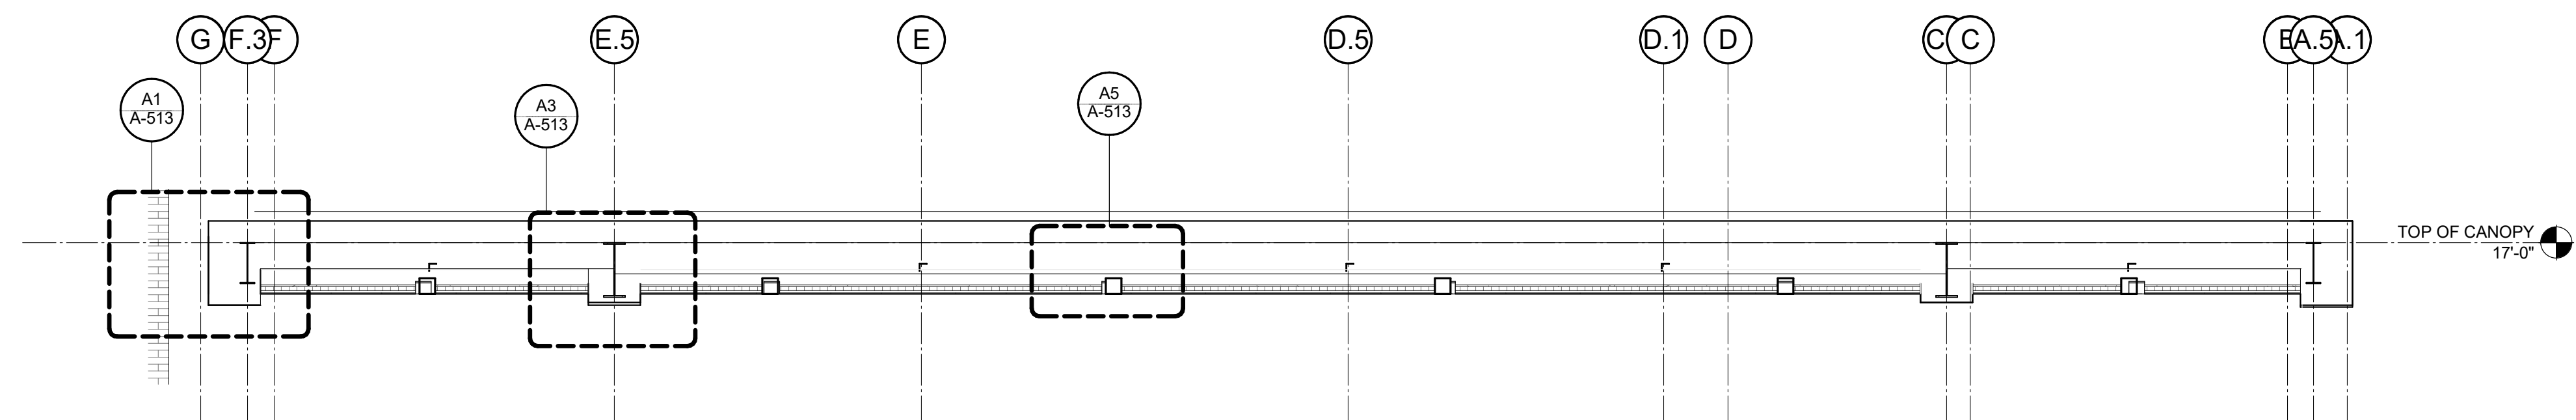




C3 LONGITUDINAL SECTION @ CANOPY
1/4" = 1'-0"




4/4/2023 11:13:28 AM




12' = 1'-0"

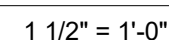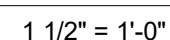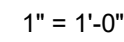


44 ROLLER SHADE POCKET @ ACT

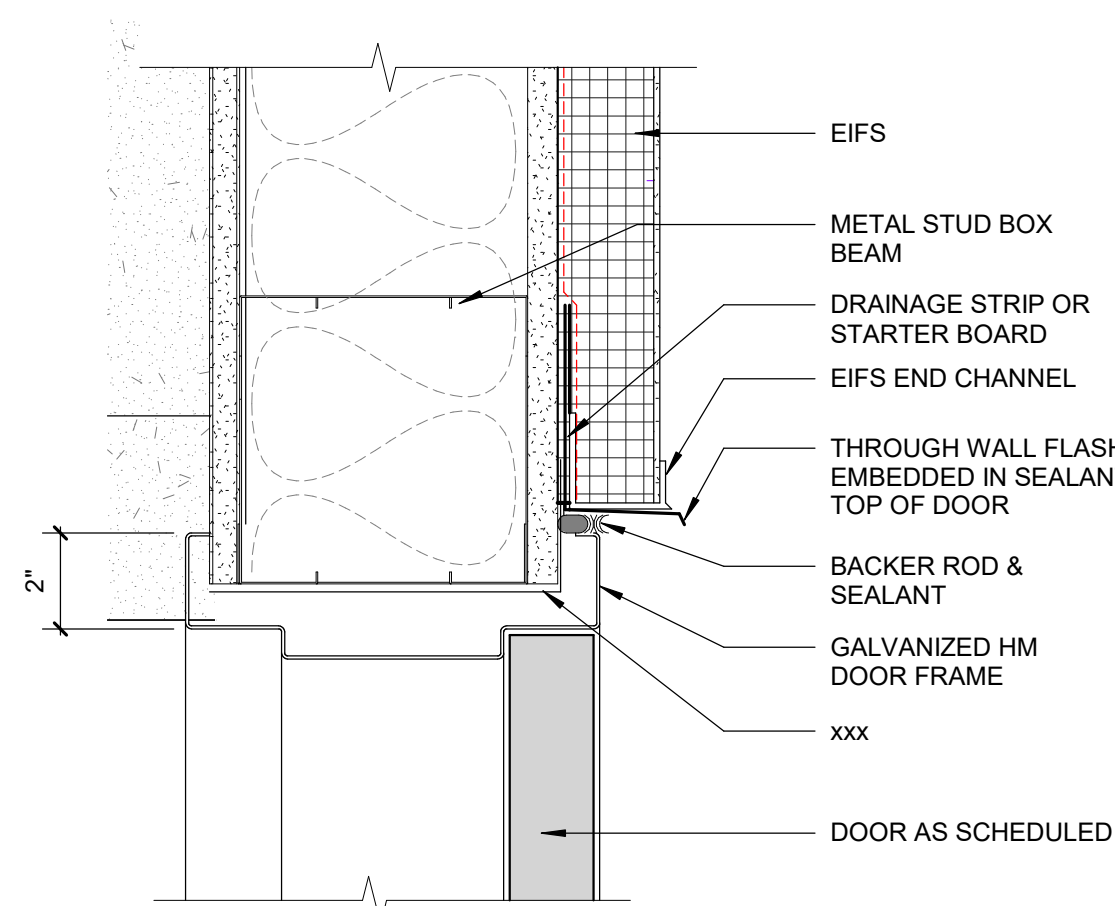


E3 HM DOOR @ EIFS HEAD

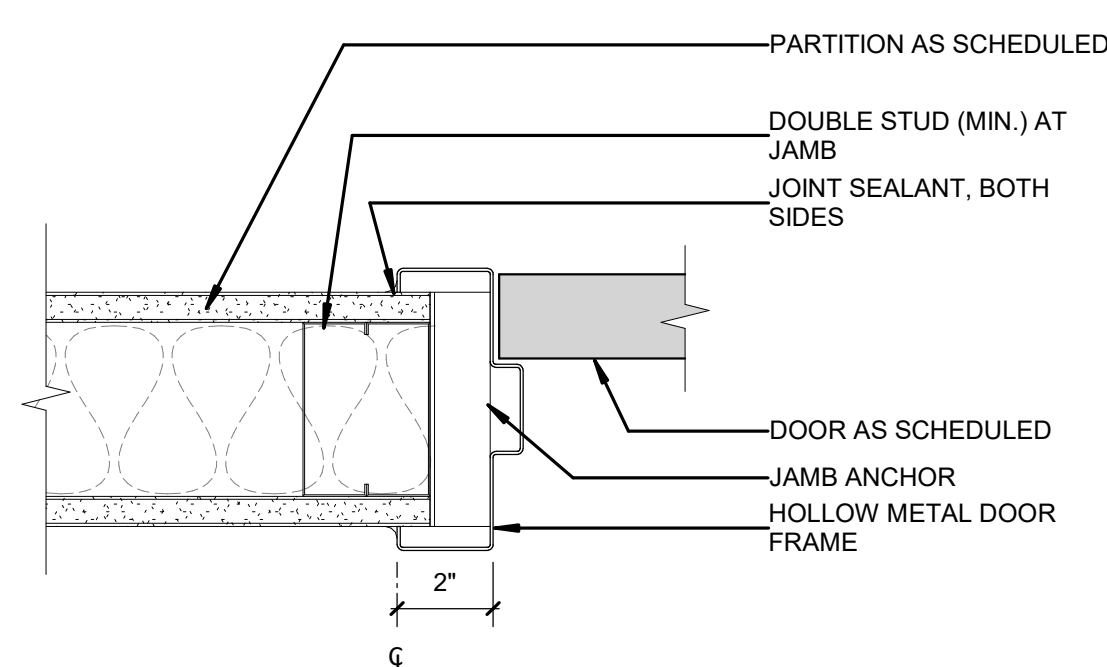


C1 HM DOOR & FRAME-METAL STUD-JAMB

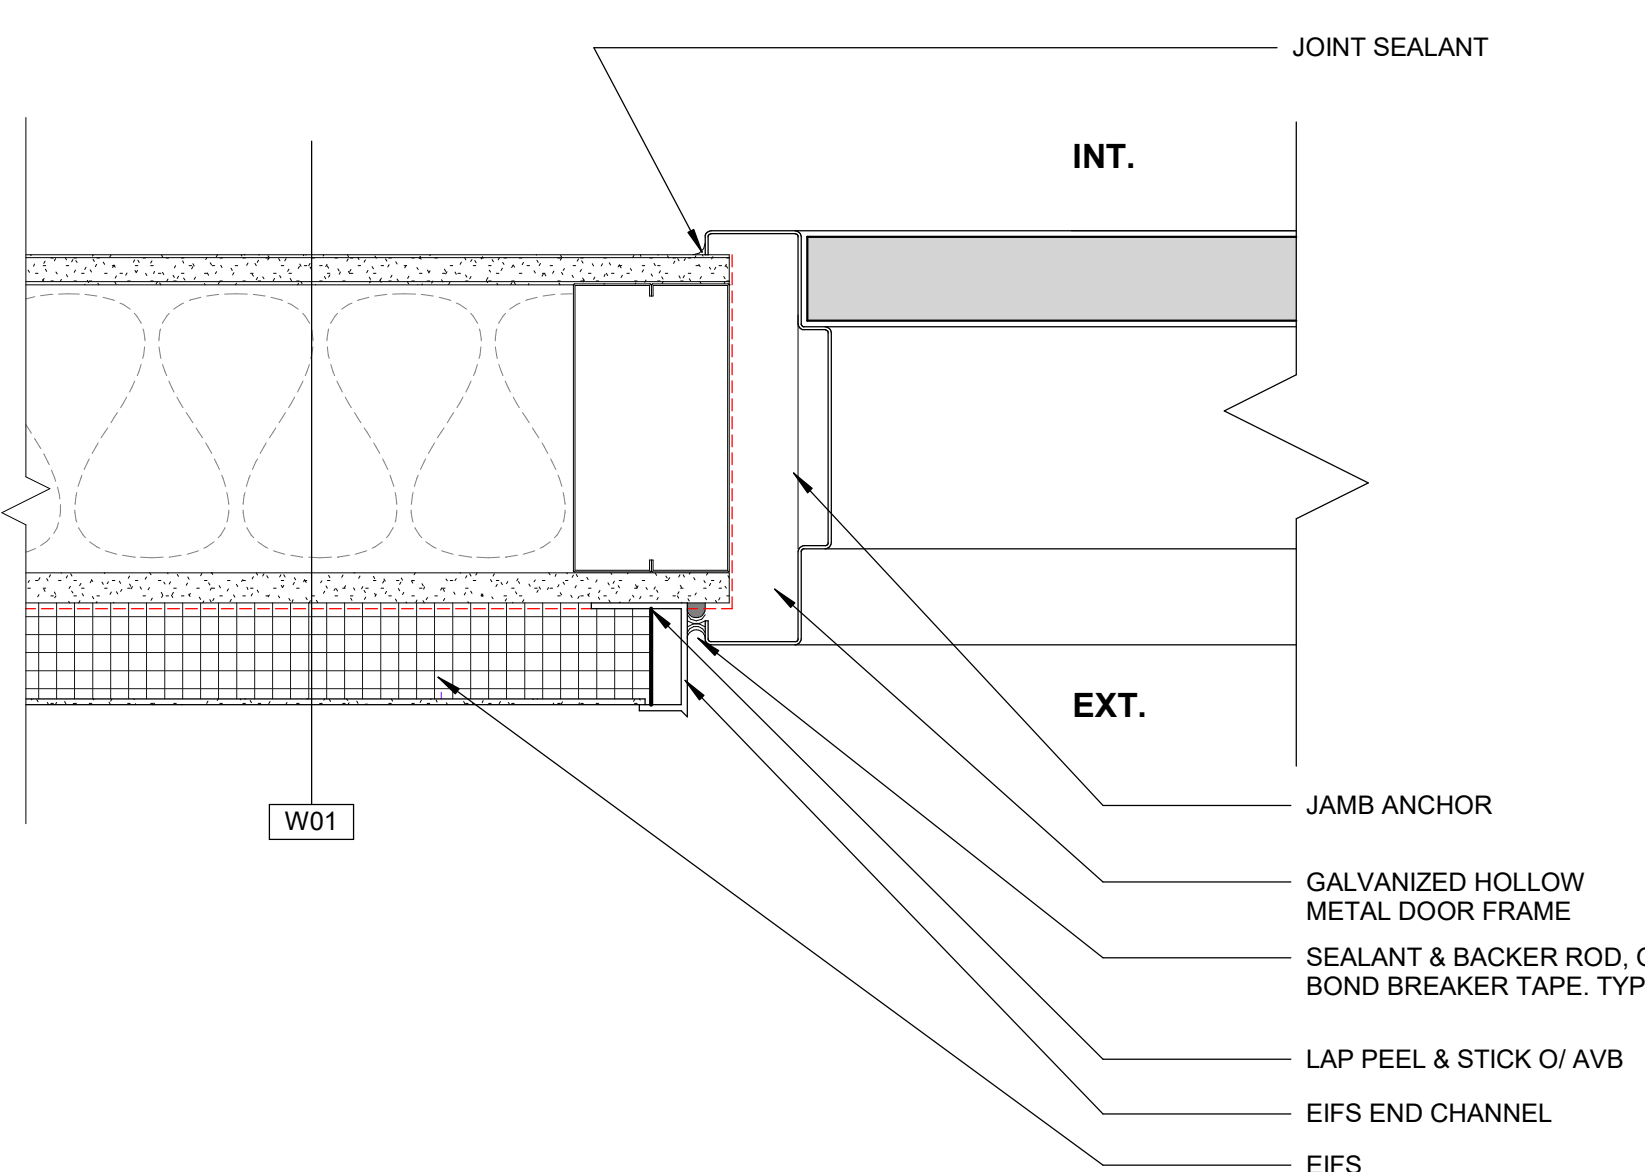

C2 EXT. HM- JAMB DETAIL @ EIFS

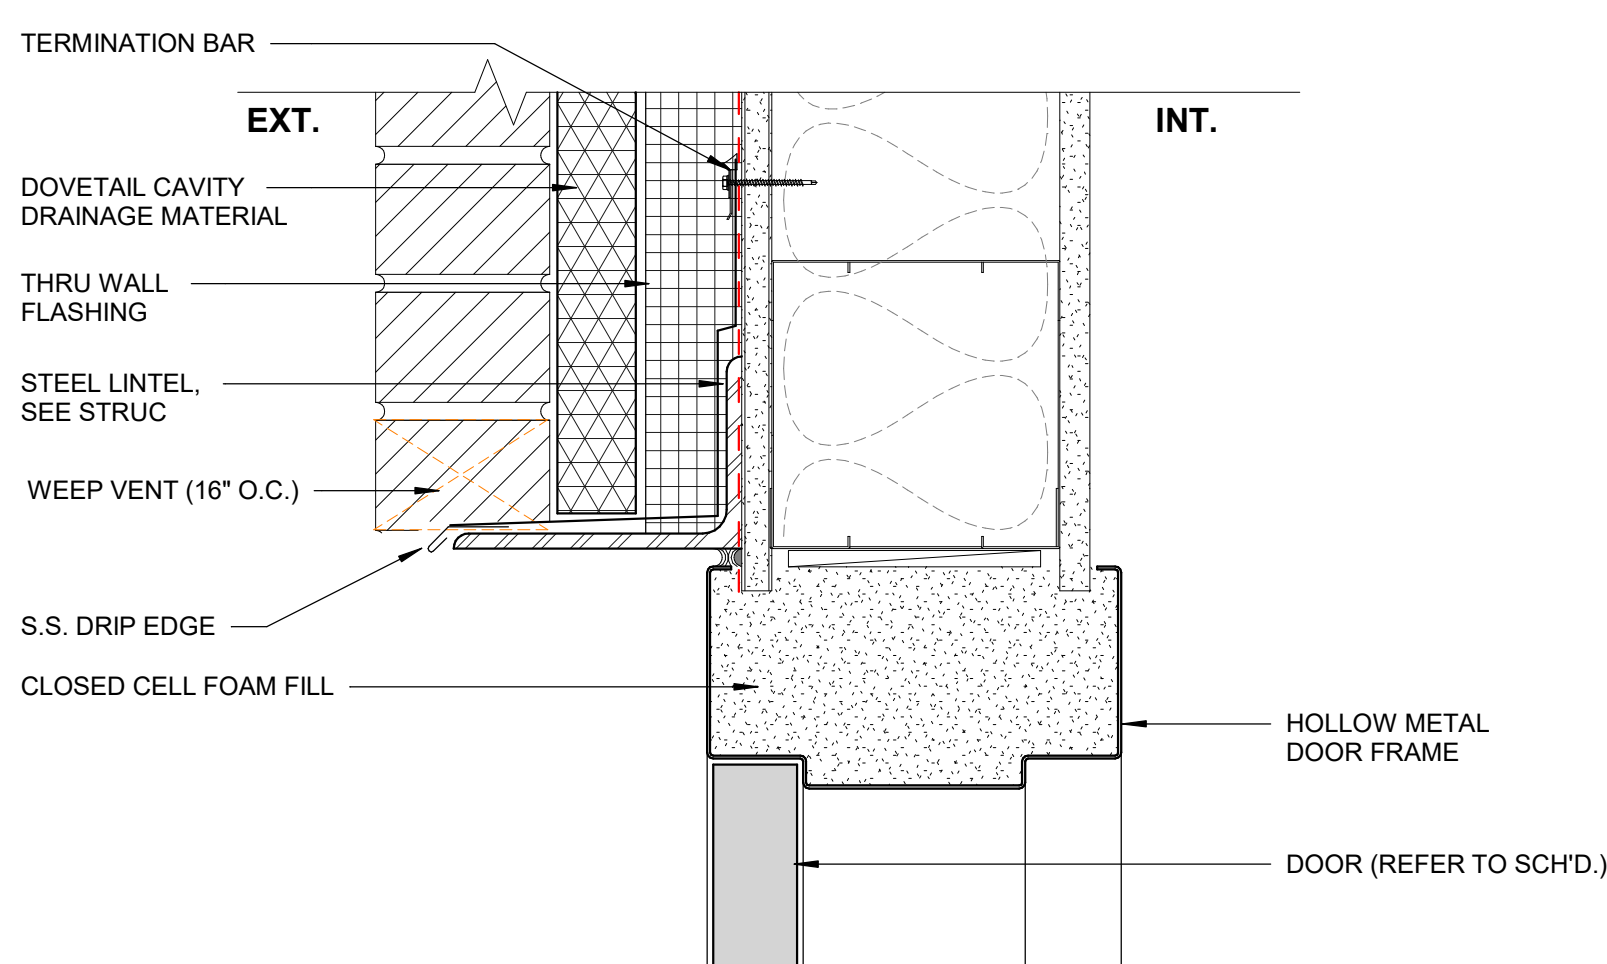


B1 HM DOOR @ BRICK VENEER

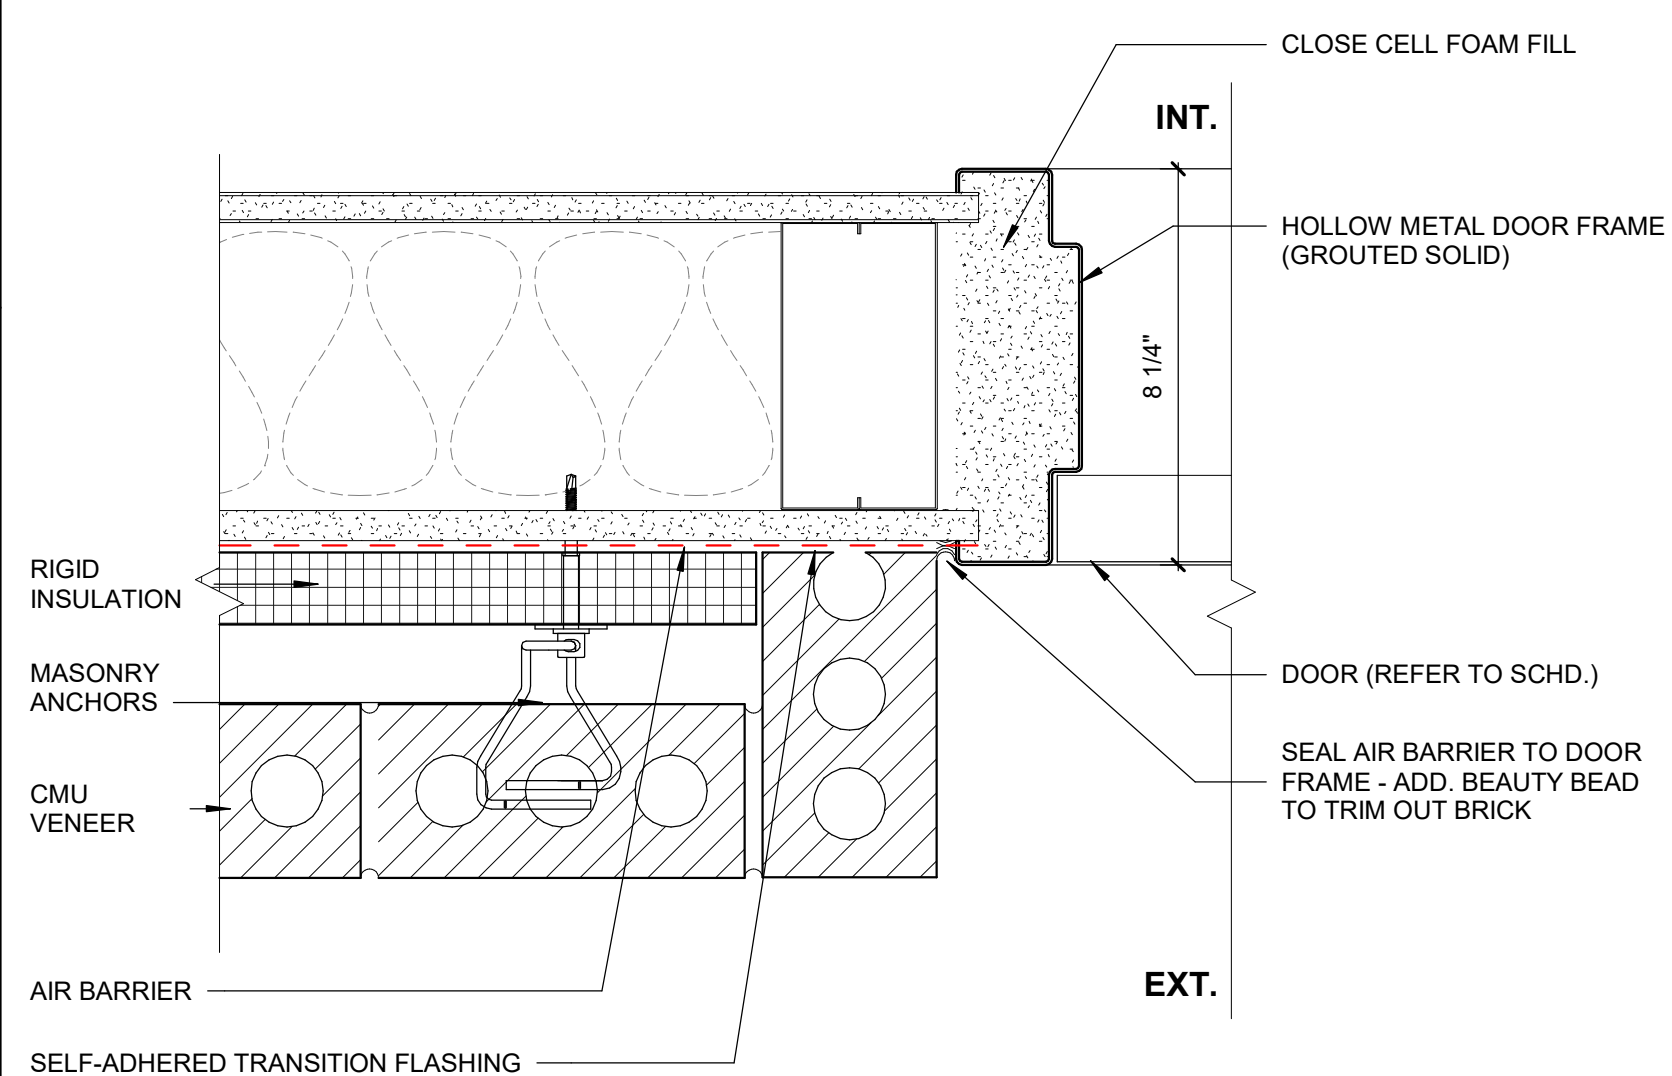


A1 HM JAMB @ CMU VENEER


SIGNAGE (BASIS OF DESIGN)					
TYPE	MANUFACTURER	COLLECTION	PRODUCT TYPE	FINISH	COMMENTS
E.1	PRECISION	MATCH GOV'T CENTER	FAMILY RESTROOM ID	LAMINATE	
E.2	PRECISION	MATCH GOV'T CENTER	RESTROOM ID	LAMINATE	
G	PRECISION	MATCH GOV'T CENTER	ROOM ID, SINGLE LINE	LAMINATE	ADD ROOM NUMBER AND NAME
G.2	PRECISION	MATCH GOV'T CENTER	ROOM ID, DOUBLE LINE	LAMINATE	ADD ROOM NUMBER AND NAME
H	PRECISION	MATCH GOV'T CENTER	OFFICE ID (W/ INSERT)	LAMINATE	ADD ROOM NUMBER

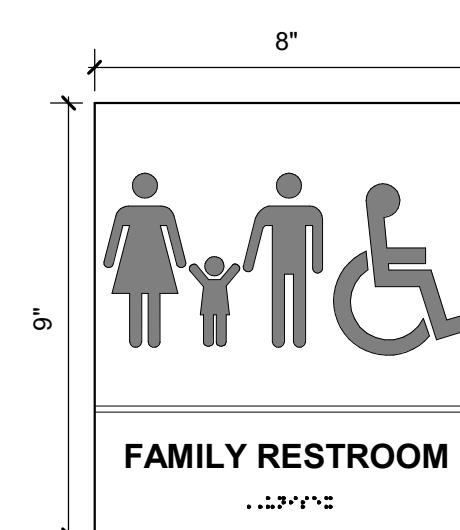


E.1

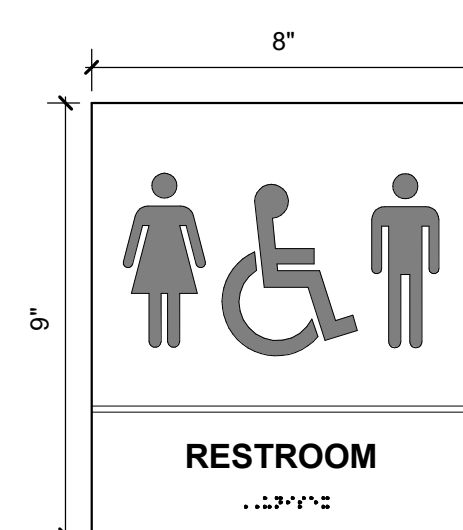


E.2

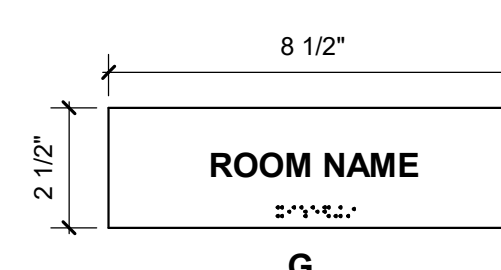

G

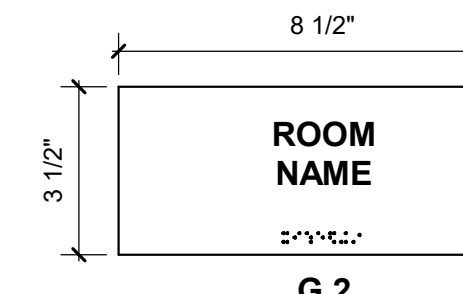

G.2

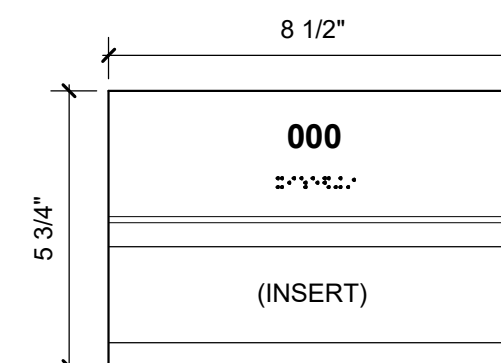

H
* BACKER REQ'D AT ALL
STOREFRONT LOCATIONS

**ADDITIONAL EXISTING
ECC SIGNAGE NEEDED**

125 TLT = TYPE E.2
100 STORAGE = TYPE C

127 CONFERENCE = TYPE


128 SERVER = TYPE G

* BACKER REQ'D AT ALL
STOREFRONT LOCATIONS

D4 SIGN TYPES

ARCH- DOOR SCHEDULE																			
DOOR		DOOR PANELS			DOOR DIMENSIONS				DOOR FRAME		DOOR FRAME			HYD SET	PANIC HOWE	SIGNAGE	COMMENTS		
NUMBER	DOOR FIRE RATING MINUTES	PANEL TYPE		PANEL FINISH (INSTANCE)	PANEL DIMENSIONS WIDTH			THICKNESS	TYPE	FRAME FINISH	FACE DIMENSIONS								
		PANEL 1	PANEL 2		PANEL 1	PANEL 2	HEIGHT				JAMB WIDTH	HEAD HEIGHT	DEPTH						
LEVEL 1																			
1048		PNL-FG-AL	PNL-FG-AL	DARK BRONZE	3'-0"	3'-0"	8'-0"	1 3/4"	FRM-00AL(CW)	DARK BRONZE		0"	0"	4 3/4"	#17	YES	--	AUTO OPERATOR, LEFT LEAF ONLY	
1008		PNL-FG-AL	PNL-FG-AL	DARK BRONZE	3'-0"	3'-0"	8'-0"	1 3/4"	FRM-00AL(CW)	DARK BRONZE		0"	0"	4 3/4"	#17	YES	--		
100C		PNL-FG-AL		DARK BRONZE	3'-2 1/2"		8'-0"	1 3/4"	FRM-00AL(CW)	DARK BRONZE		0"	0"	4 3/4"	#17	--	--		
100D		PNL-FG-AL		DARK BRONZE	3'-2 1/2"		8'-0"	1 3/4"	FRM-00AL(CW)	DARK BRONZE		0"	0"	4 3/4"	#17	YES	--		
101		P1-F-WD		STAINED WOOD	7'-0"		7'-0"	1 3/4"	FRM-00HM1	PAINTED TO MATCH DARK BRONZE FRAME		2"	2"	5 3/4"	#08	--	G	E.1	
102		PNL-F-WD		STAINED WOOD	3'-0"		7'-0"	1 3/4"	FRM-00HM1	PAINTED TO MATCH DARK BRONZE FRAME		2"	2"	5 3/4"	#08	--	--	E.2	
103		PNL-F-WD	PNL-FG-AL	STAINED WOOD	3'-0"		7'-0"	1 3/4"	FRM-00HM1	PAINTED TO MATCH DARK BRONZE FRAME		2"	2"	5 3/4"	#08	--	--		
104		PNL-FG-AL		DARK BRONZE	3'-0"	3'-0"	8'-0"	1 3/4"	FRM-00AL(CW)	DARK BRONZE		0"	0"	4 3/4"	#17	--	--	ACCESS CONTROL, AUTO OPERATOR LEFT LEAF ONLY	
104B		PNL-F-WD		STAINED WOOD	3'-0"		7'-0"	1 3/4"	FRM-00HM1	PAINTED TO MATCH DARK BRONZE FRAME		2"	2"	8 1/8"	#03	--	--		
104C		PNL-F-WD		STAINED WOOD	3'-0"		7'-0"	1 3/4"	FRM-00HM1	PAINTED TO MATCH DARK BRONZE FRAME		2"	2"	5 3/4"	#03	--	--	ACCESS CONTROL	
104D		PNL-F-WD		STAINED WOOD	3'-0"		7'-0"	1 3/4"	FRM-00HM1	PAINTED TO MATCH DARK BRONZE FRAME		2"	2"	5 3/4"	#03	--	--	ACCESS CONTROL	
105A		PNL-F-WD		STAINED WOOD	3'-0"		7'-0"	1 3/4"	FRM-00HM1	PAINTED TO MATCH DARK BRONZE FRAME		2"	2"	5 3/4"	#03	H	--		
105B		PNL-F-WD		STAINED WOOD	3'-0"		7'-0"	1 3/4"	FRM-00HM1	PAINTED TO MATCH DARK BRONZE FRAME		2"	2"	5 3/4"	#03	H	--		
106A		PNL-F-WD		STAINED WOOD	3'-0"		7'-0"	1 3/4"	FRM-00AL(CW)	DARK BRONZE		0"	0"	4 3/4"	#02	H	--		
106B		PNL-F-WD		STAINED WOOD	3'-0"		7'-0"	1 3/4"	FRM-00AL(CW)	DARK BRONZE		0"	0"	4 3/4"	#02	H	--		
107		PNL-F-WD		STAINED WOOD	3'-0"		7'-0"	1 3/4"	FRM-00AL(CW)	DARK BRONZE		0"	0"	4 3/4"	#02	H	--		
108		PNL-F-WD		STAINED WOOD	3'-0"		7'-0"	1 3/4"	FRM-00AL(CW)	DARK BRONZE		0"	0"	4 3/4"	#02	H	--		
108		PNL-F-WD		STAINED WOOD	3'-0"		7'-0"	1 3/4"	FRM-00AL(CW)	DARK BRONZE		0"	0"	4 3/4"	#02	H	--		
109		PNL-F-WD		STAINED WOOD	3'-0"		7'-0"	1 3/4"	FRM-00AL(CW)	DARK BRONZE		0"	0"	4 3/4"	#02	H	--		
110		PNL-F-WD		STAINED WOOD	3'-0"		7'-0"	1 3/4"	FRM-00AL(CW)	DARK BRONZE		0"	0"	4 3/4"	#02	H	--		
111		PNL-F-WD		STAINED WOOD	3'-0"		7'-0"	1 3/4"	FRM-00AL(CW)	DARK BRONZE		0"	0"	4 3/4"	#02	H	--		
112		PNL-NP		--	4'-0"		7'-0"	1 3/4"	FRM-NF	--		0"	0"	5 3/4"	--	G	GYP OPENING		
113		PNL-NP		--	4'-0"		7'-0"	1 3/4"	FRM-NF	--		0"	0"	5 3/4"	--	G	GYP OPENING		
114		PNL-F-WD		STAINED WOOD	3'-0"		7'-0"	1 3/4"	FRM-00HM1	PAINTED TO MATCH DARK BRONZE FRAME		2"	2"	5 3/4"	#05	G	--		
115A		PNL-F-WD		STAINED WOOD	3'-0"		7'-0"	1 3/4"	FRM-00HM1	PAINTED TO MATCH DARK BRONZE FRAME		2"	2"	5 3/4"	#05	G	ACCESS CONTROL		
115B		PNL-F-WD		STAINED WOOD	3'-0"		7'-0"	1 3/4"	FRM-00HM1	PAINTED TO MATCH DARK BRONZE FRAME		2"	2"	5 3/4"	#05	G	ACCESS CONTROL		
116		PNL-F-WD		STAINED WOOD	3'-0"		7'-0"	1 3/4"	FRM-00HM1	PAINTED TO MATCH DARK BRONZE FRAME		2"	2"	5 3/4"	#05	G	--		
117		PNL-FG-WD		STAINED WOOD	3'-0"		7'-0"	1 3/4"	FRM-00HM1	PAINTED TO MATCH DARK BRONZE FRAME		2"	2"	5 3/4"	#08	H	--		
118		PNL-F-WD		STAINED WOOD	3'-0"		7'-0"	1 3/4"	FRM-00HM1	PAINTED TO MATCH DARK BRONZE FRAME		2"	2"	5 3/4"	#08	E.2	--		
119		PNL-F-WD		STAINED WOOD	3'-0"		7'-0"	1 3/4"	FRM-00HM1	PAINTED TO MATCH DARK BRONZE FRAME		2"	2"	5 3/4"	#08	E.2	--		
121		PNL-F-HM	PNL-F-HM	PAINTED METAL	3'-0"	3'-0"	7'-0"	1 3/4"	FRM-00HM1	PAINTED TO MATCH DARK BRONZE FRAME		2"	2"	9 7/8"	#19	--	--	ACCESS CONTROL, GALVINIZED	
123		PNL-F-WD		STAINED WOOD	3'-0"		7'-0"	1 3/4"	FRM-00HM1	PAINTED TO MATCH DARK BRONZE FRAME		2"	2"	8 1/8"	#05	--	--	ACCESS CONTROL BOTH SIDES	
124		PNL-FG-AL	PNL-FG-AL	DARK BRONZE	3'-0"	3'-0"	7'-0"	1 3/4"	FRM-00AL(CW)	DARK BRONZE		0"	0"	4 3/4"	#17	--	--	ACCESS CONTROL	
127		PNL-F-HM		PAINTED METAL	3'-0"		7'-0"	1 3/4"	FRM-00HM1	PAINTED TO MATCH DARK BRONZE FRAME		2"	2"	4 3/4"	#02	G	--		
129A	45	PNL-F-HM		PAINTED METAL	3'-0"		7'-0"	1 3/4"	FRM-00HM1	PAINTED TO MATCH DARK BRONZE FRAME		2"	2"	5 3/4"	#03	G	--		
129B		PNL-F-HM		PAINTED METAL	3'-0"		7'-0"	1 3/4"	FRM-00HM1	PAINTED TO MATCH DARK BRONZE FRAME		2"	2"	7 3/4"	#23	--	--	ACCESS CONTROL, GALVINIZED	
129C		PNL-F1-STL		PAINTED METAL	6'-0"		8'-0"	1/4"	FRM-60STL	PAINTED TO MATCH DARK BRONZE FRAME		2"	2"	6 7/8"	--	--	--	GALVINIZED	
130	45	PNL-F-HM		PAINTED METAL	3'-0"		7'-0"	1 3/4"	FRM-00HM1	PAINTED TO MATCH DARK BRONZE FRAME		2"	2"	5 3/4"	#05	G	--		
140		PNL-F-HM		PAINTED METAL	3'-0"		7'-0"	1 3/4"	FRM-00HM1	PAINTED TO MATCH DARK BRONZE FRAME		2"	4"	1 3/4"	#23	G	GALVINIZED		


PANEL TYPES

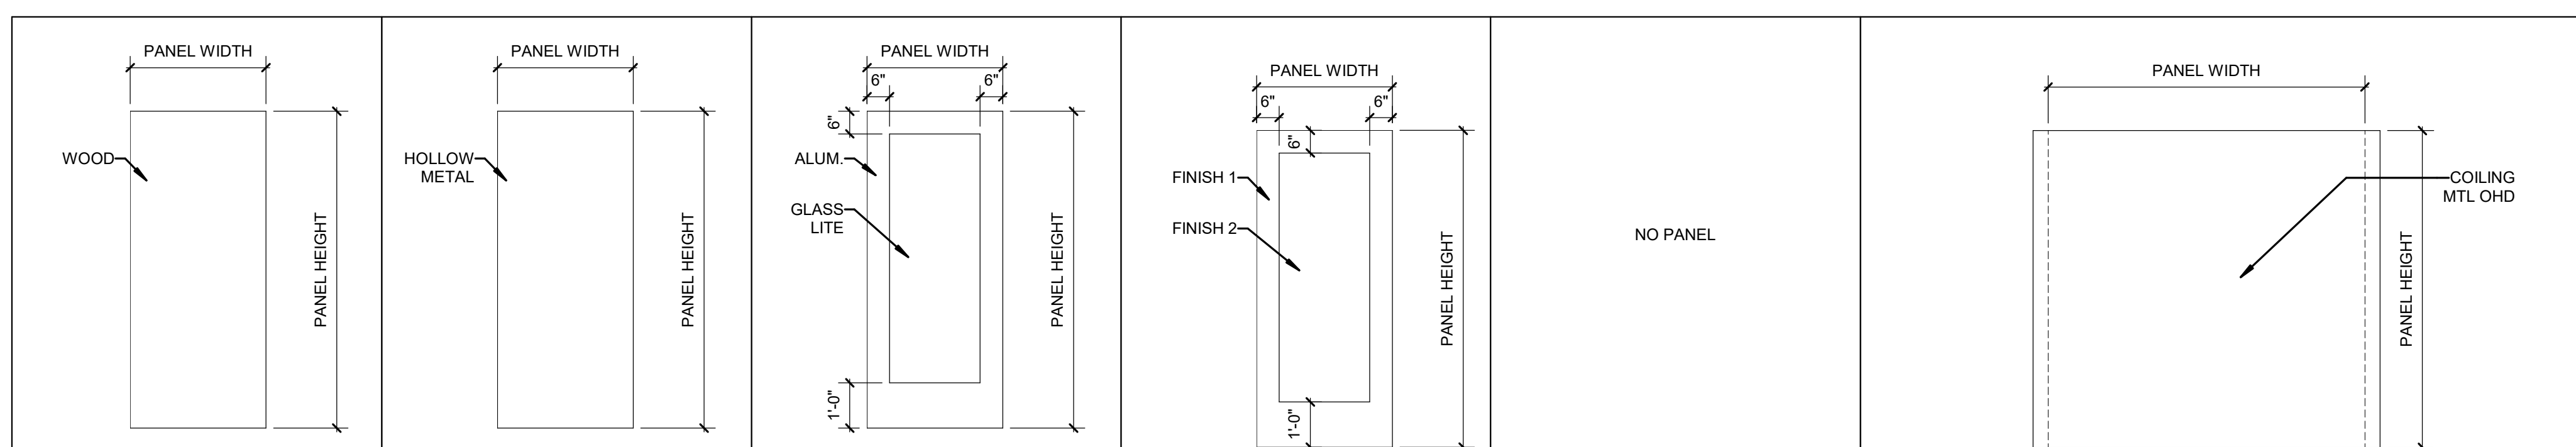


A2	PNL-F-WD	A3	PNL-F-HM	A3.5	PNL-FG-AL	A4	PNL-FG-WD	A4.5	PNL-NP	A5	PNL-F1-STL
A-601		A-601		A-601		A-601		A-601		A-601	

SIGNAGE GENERAL NOTES



- A. INSTALL ALL INTERIOR SIGN TYPES NOT AT GLASS WITH 1/32" THICK FOAM TAPE.
- B. AT ALL GLASS LOCATIONS, PROVIDE A MATCHING BACK COVERPLATE FOR OPPOSING SIDE OF GLASS.
- C. OWNER SHALL APPROVAL FINAL SCHEDULE COPY, COLOR SELECTIONS AND FINAL LOCATIONS. ALL DESIGN, COLOR, AND COPY ELEMENTS TO BE APPROVED BY OWNER PRIOR TO ORDER ENTRY. ROOM NAMES AND NUMBERS LISTED IN THESE DOCUMENTS MAY DIFFER FROM FINAL NAMES AND NUMBERS.

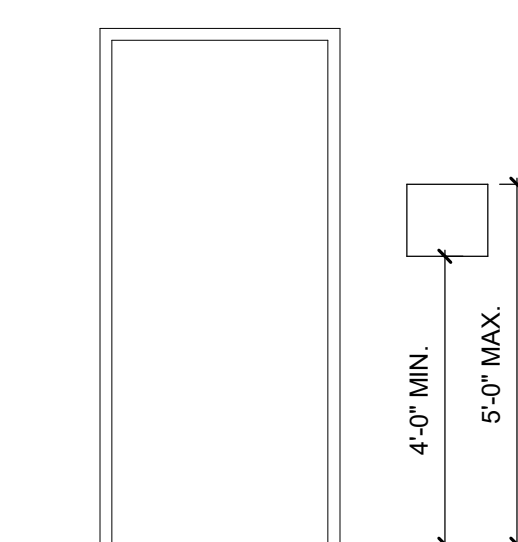

E5 SIGNAGE MOUNTING

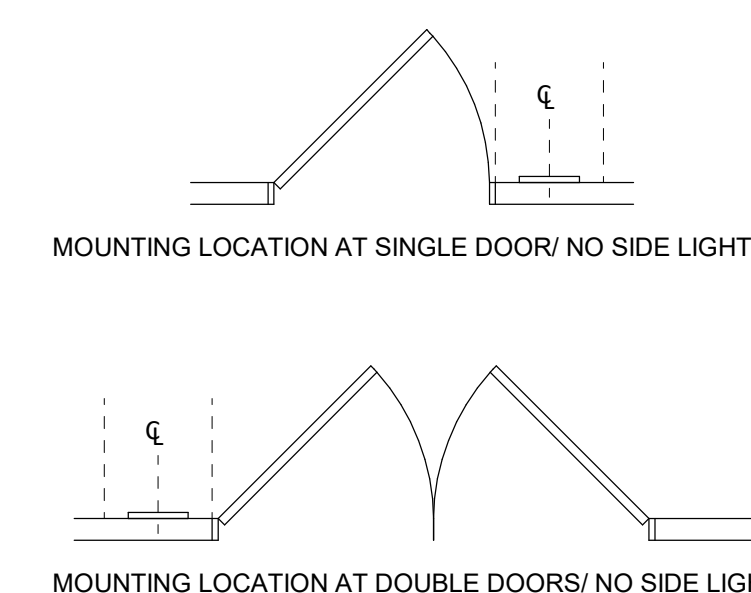

FRAME TYPES

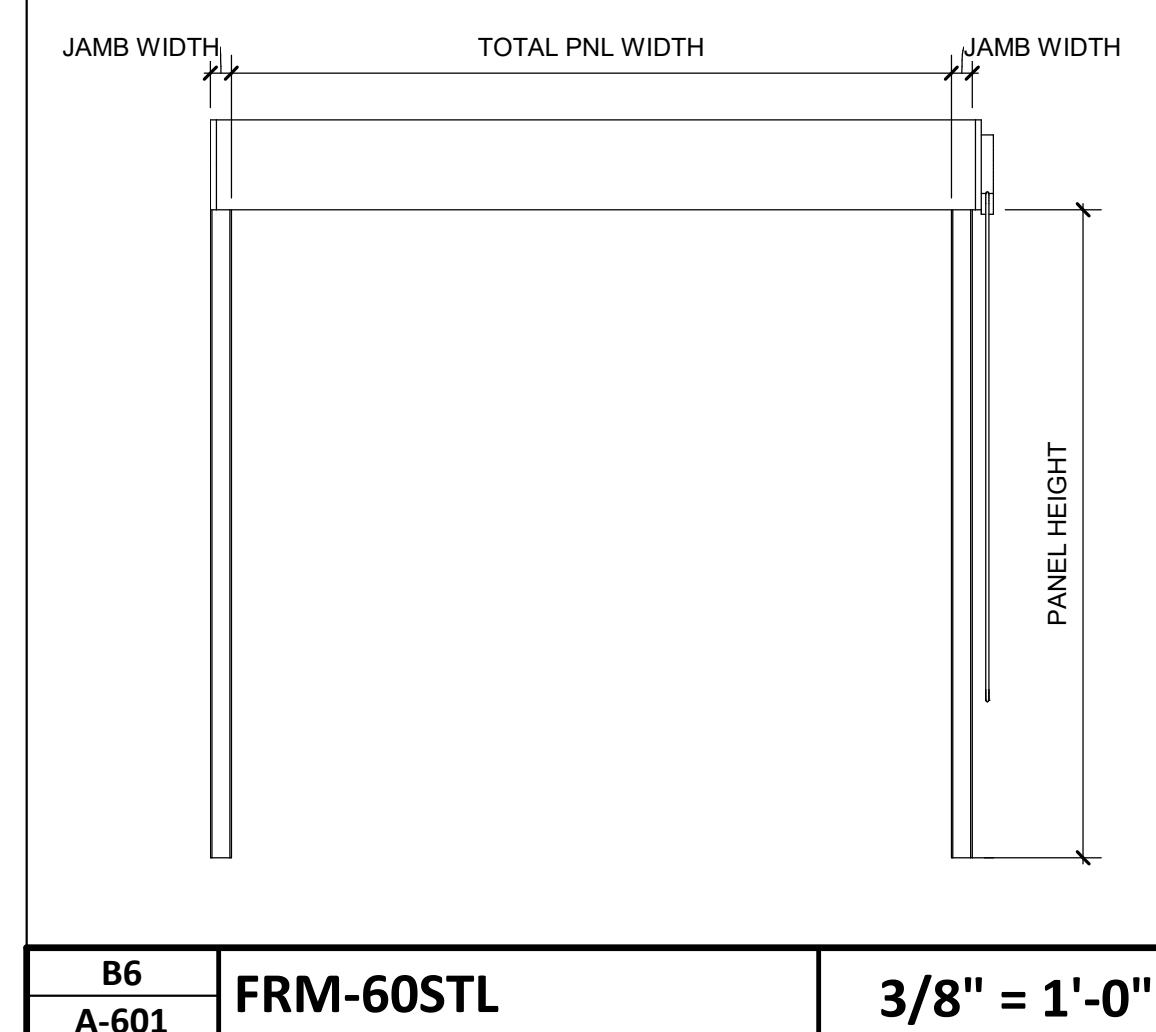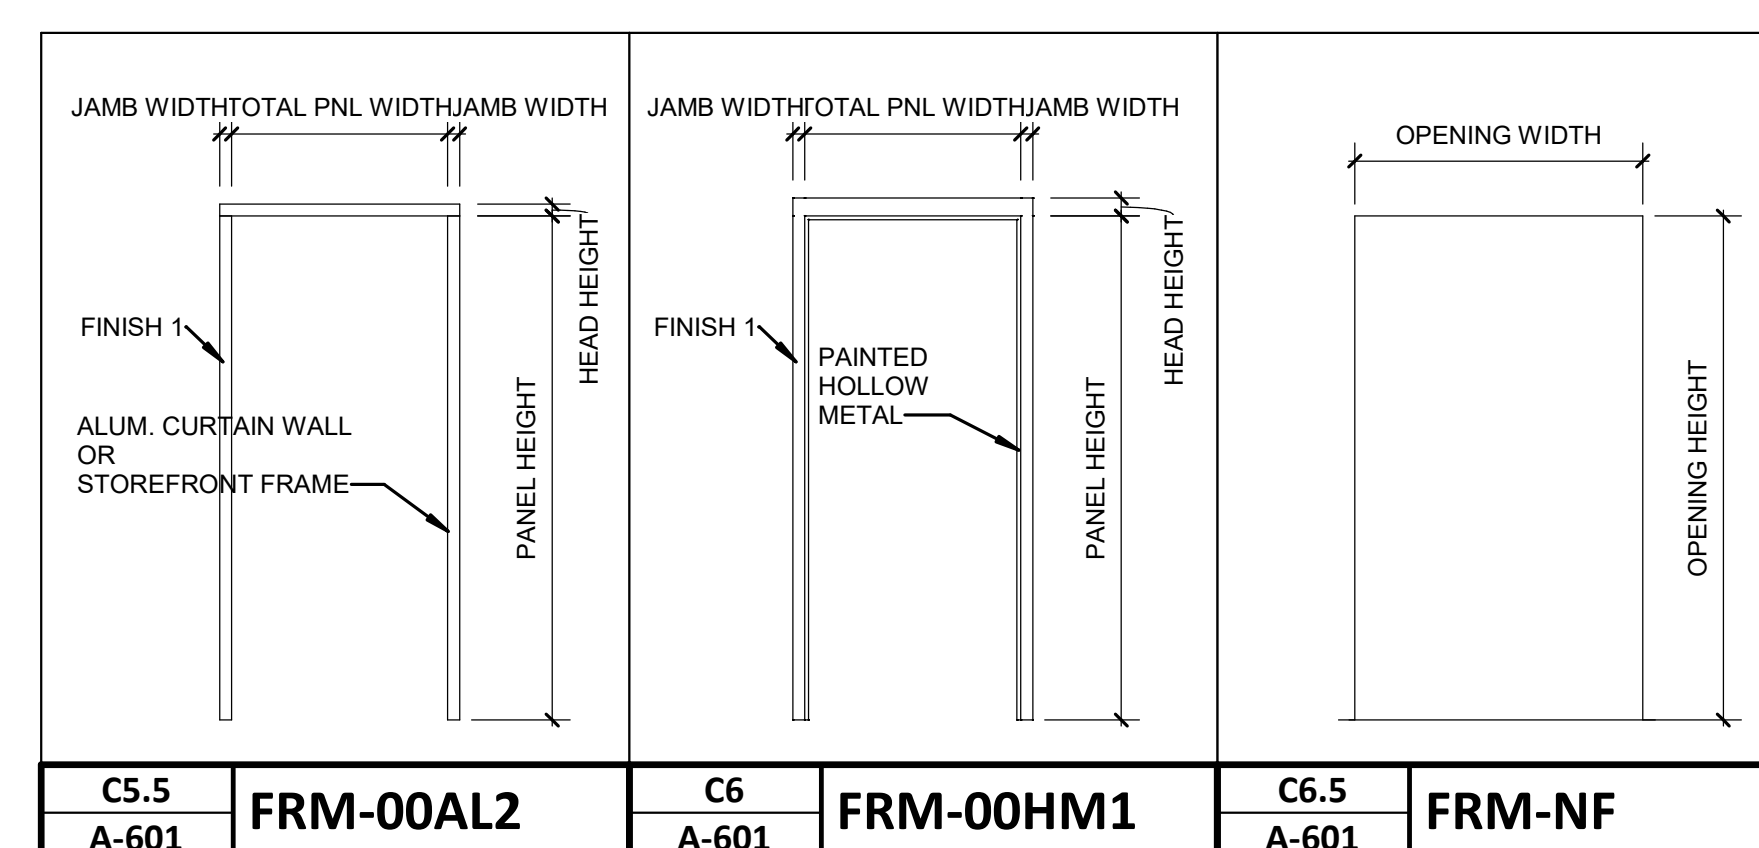

A5 SURFACE MOUNTED DISPLAY W/ RECESSED BACK BOX
3" = 1'-0"

4/4/2023 11:13:53 AM

E


D

C

B



A

INTERIOR FINISH LEGEND									
TAG	MANUFACTURER	STYLE/PATTERN	PRODUCT COLOR	PRODUCT FINISH	PRODUCT SIZE	INSTALLATION	ADDITIONAL NOTES		CONTACT
08 MILLWORK									
ACR-1	3FORM	MERIDIAN	CARBON		4' x 8' PANELS	PATTERN RUNS HORIZONTAL	FRY REGLET TRIM NEEDED AT ALL CORNERS		ASHLEY BARBOUR, ASHLEY BARBOUR@3-FORM.COM ; 919.594.8317
PLM-1	WILSONART	D321-01	BRITTANY BLUE	GLOSS			BREAK/ WORK RM CABINETS		APRIL BRICKLE, BRICKLA@WILSONART.COM ; 540.537.3431
PLM-2	FORMICA	9512-34	LAYERED WHITE SAND	SCOVATO FINISH			BREAK/ WORK RM COUNTERTOPS		SHERI REID, SHERI.REID@FORMICA.COM ; 704.534.7300
OSS-1	CORIAN	QUARTZ	COARSE CARRARA	--			LOBBY CTOP		C.H.BRIGGS CO- BARBARA DAVIS, BDAVIS@CHBRIGGS.COM ; 704.301.8078
09 BASE									
PTB-1	DELCONCA USA	TUDOR STONE	TU 05 GRAY		6"C24"	W/ SCHLUTER SCHIENE TRIM	W/ PTF-1 & PTW-1		MOSAIC TILE CO- ANN HARTLY, AHARTLEY@MOSAICTILECO.COM ; 919.602.6125
PTB-2	ATLAS CONCORDE USA	MARINE	SHORE		6X12" COVE BASE		W/ PTF-2		MOSAIC TILE CO- ANN HARTLY, AHARTLEY@MOSAICTILECO.COM ; 919.602.6125
RBS-1	TARKETT	4" TRADITIONAL RUBBER BASE	48 GREY WG		4"				LISA ELLIS, LISA.ELLIS@TARKETT.COM ; 919.606.6639
09 CEILING									
ACT-1	ARMSTRONG	ULTIMA 1912	WHITE		24" x 24"		W/ SUPRAPHINE XL 9/16" GRID		MARY HADDAD, MRHADDAD@ARMSTRONGCEILINGS.COM ; 919.349.1468
ACT-2	ARMSTRONG	ULTIMA 1915	WHITE		24" x 48"		W/ SUPRAPHINE XL 9/16" GRID		MARY HADDAD, MRHADDAD@ARMSTRONGCEILINGS.COM ; 919.349.1468
09 CEILING- WOOD									
LWC-1	CERTAINTEEED	GRILLE MODULES: SUSPENSION SYSTEM W/ 4005B1	CUSTOM STAIN TO MATCH VT INDUSTRIES SELECT WHITE MAPLE RAVINE RA18	STAINED	4005B1	WOOD BACKER SYSTEM (SUSPENDED)	W/ ACOUSTIC BLANKET ABOVE (CLG ABOVE PAINTED BLACK)		SEARS - DREW ROCHESTER.DREW@SEARS-TR.COM ; 704-661-8765
09 FLOORING- CARPET									
CPT-1	SHAW	NOBLE MATERIALS- SLAB TILE 5T133	FORGE 33518		24" x 24"	MONOLITHIC			MARI HOWARD, MARI.HOWARD@SHAWCONTRACT.COM ; 919.606.7948
CPT-2	SHAW	NOBLE MATERIALS- FORM TILE 5T136	FORGE 33518		24" x 24"	MONOLITHIC			MARI HOWARD, MARI.HOWARD@SHAWCONTRACT.COM ; 919.606.7948
CPT-3	SHAW	NOBLE MATERIALS- ALCHEMY TILE 5T135	FORGE PLATINUM 33518		24" x 24"	MONOLITHIC			MARI HOWARD, MARI.HOWARD@SHAWCONTRACT.COM ; 919.606.7948
09 FLOORING- RESILIENT									
LVT-1	PATCRAFT	NATURAL STATE 1533V	00130 HONEY WALNUT		8.42" x 58.97"	STAGGER			MEGGHAN HOYT, MEGGHAN.HOYT@PATCRAFT.COM ; 202.288.5111
VCT-1	ARMSTRONG	IMPERIAL STANDARD EXCELO	PERFECT STORM 57551		12" X 12"	MONOLITHIC			SARAH TAYLOR, SARAH.TAYLOR@AHFPRODUCTS.COM ; 803.517.4598
VCT-2	ARMSTRONG	STATIC DISSIPATIVE TILE	FOSSIL GRAY 51956		12" X 12"	MONOLITHIC			SARAH TAYLOR, SARAH.TAYLOR@AHFPRODUCTS.COM ; 803.517.4598
09 FLOORING- TILE									
PTF-1	DELCONCA USA	TUDOR STONE	TU 05 GRAY	UNPOLISHED	12" x 24"	STACK ; W/ METAL TRANSITION @ CPT/ LVT			MOSAIC TILE CO- ANN HARTLY, AHARTLEY@MOSAICTILECO.COM ; 919.602.6125
PTF-2	ATLAS CONCORDE USA	MARINE	SHORE		24"X48"	STACK ; W/ METAL TRANSITION @ CPT/ LVT			MOSAIC TILE CO- ANN HARTLY, AHARTLEY@MOSAICTILECO.COM ; 919.602.6125
09 WALLS - PAINT									
PNT-1	BENJAMIN MOORE	872	WHITE CHRISTMAS	FLAT			GWB CEILINGS, U.N.O.		CANDICE CARTER, CANDICE.CARTER@BENJAMINMOORE.COM
PNT-2	BENJAMIN MOORE	1465	NIMBUS	EGGSHELL			FIELD COLOR (EPOXY FINISH @ JAN 101A)		CANDICE CARTER, CANDICE.CARTER@BENJAMINMOORE.COM
PNT-3	SHERWIN WILLIAMS	SW-9152	LET IT RAIN	EGGSHELL			ALL TLTS		RUSS HANSEN, RUSSEL.E.HANDSEN@SHERWIN.COM ; 980.207.9410
PNT-4	BENJAMIN MOORE	CSP-600	ANDES SUMMIT	EGGSHELL			OPEN OFFICE ACCENT		CANDICE CARTER, CANDICE.CARTER@BENJAMINMOORE.COM
09 WALLS - TILE									
PTW-1	DELCONCA USA	TUDOR STONE	TU 05 GRAY		12" x 24"	TLT WALL 5'-0" ALL TLT W/ SCHLUTER SCHIENE PROFILE @ TOP OF TILE/ PROVIDE METAL CORNER PROFILE WHERE APPLICABLE			MOSAIC TILE CO- ANN HARTLY, AHARTLEY@MOSAICTILECO.COM ; 919.602.6125
T2 FURNISHINGS- SHADES									
SHD-1	DRAPER	SHEERWEARVE BY PHIFER - MANUAL	PW4850 P10 GRANITE	3% OPEN					MATT SCHULTZ, MSCHULTZ@DRAPERINC.COM ; 765.524.1443
SHD-2	DRAPER	SHEERWEARVE BY PHIFER - MOTORIZED	PW4650 P10 GRANITE	3% OPEN					MATT SCHULTZ, MSCHULTZ@DRAPERINC.COM ; 765.524.1443

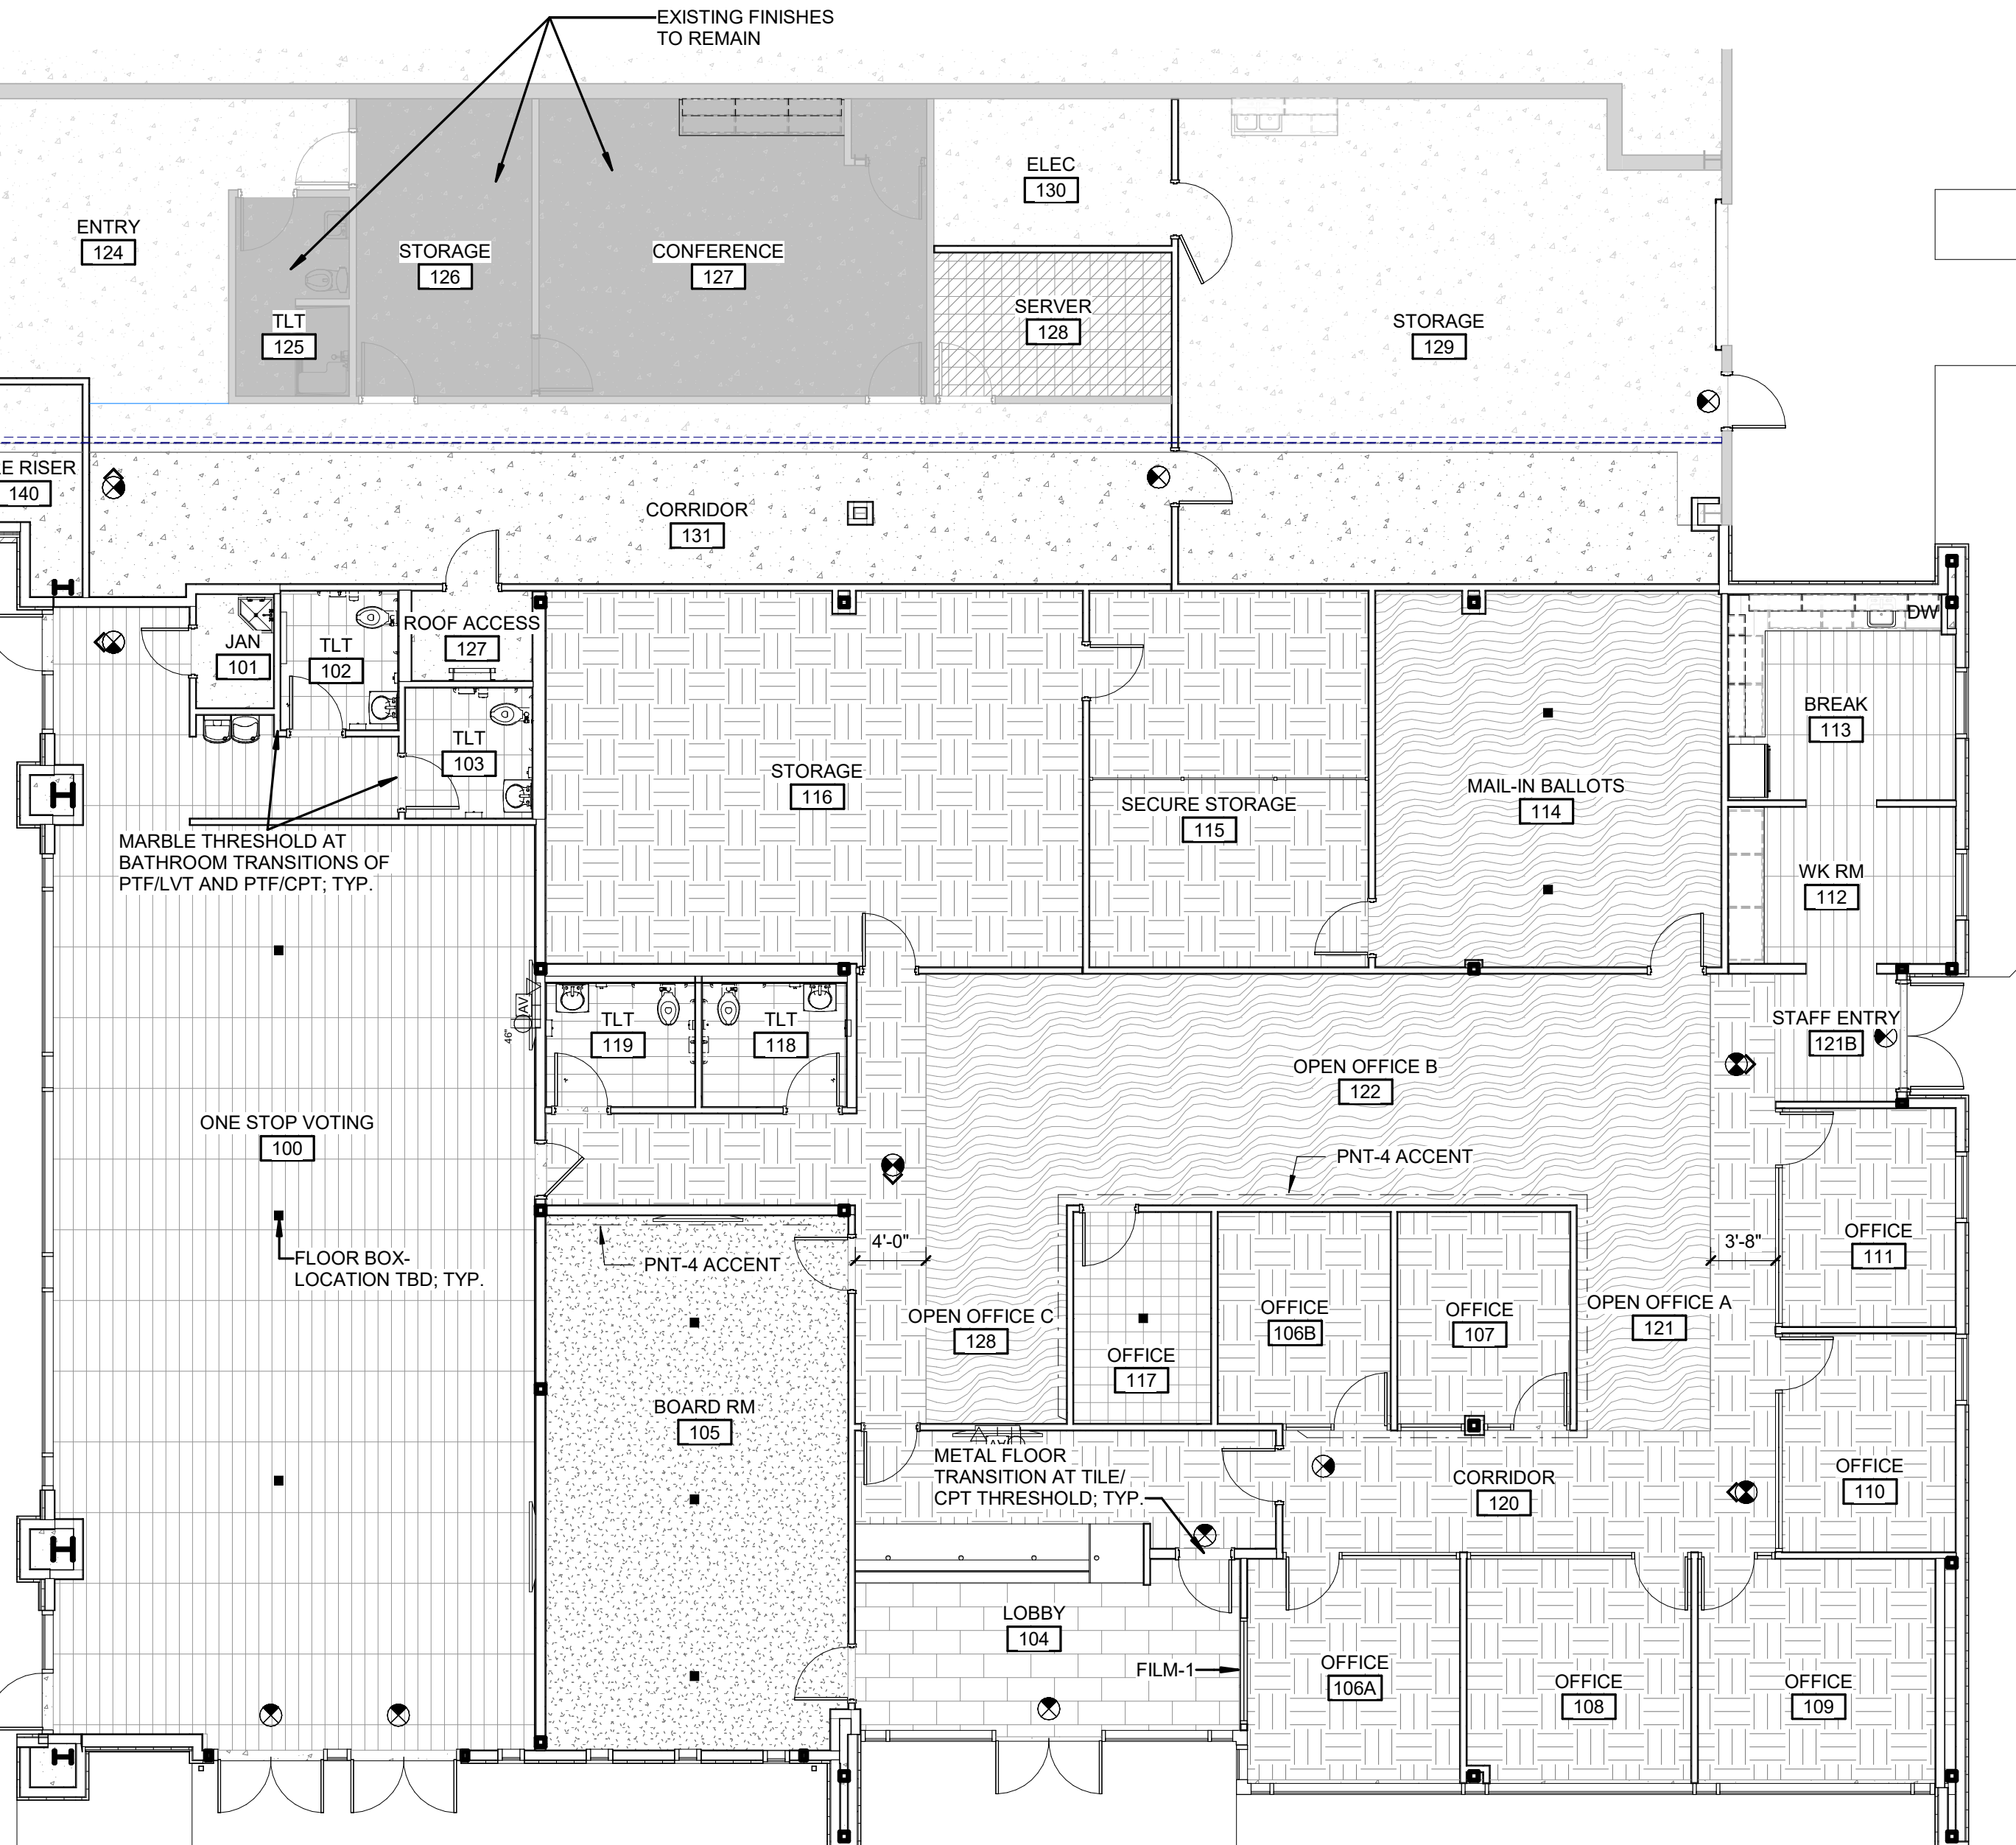


ROOM FINISH LEGEND									
NUMBER	NAME	FLOOR	BASE	WALL FINISH				CEILING	NOTES
				NORTH	EAST	SOUTH	WEST		
LEVEL 1									
100	ONE STOP VOTING	LVT-1	RBS-1	PNT-2	PNT-2	PNT-2	PNT-2	ACT-2	
101	JAN	CONC-1	RBS-1	EPOXY PNT-2	EPOXY PNT-2	EPOXY PNT-2	EPOXY PNT-2	EXPOSED	
102	TLT	PTF-1	PTB-1	PNT-3	PTW-1	PNT-3	PNT-3	ACT-1	
103	TLT	PTF-1	PTB-1	PNT-3	PTW-1	PNT-3	PNT-3	ACT-1	
104	LOBBY	PTF-2/CPT-1	PTB-2/RBS-1	PNT-2	PNT-2	PNT-2	PNT-2	LWG-1/ACT-1	
105	BOARD RM	CPT-2	RBS-1	PNT-4	PNT-2	PNT-2	PNT-2	GWB/PNT-1, ACT-1	
106A	OFFICE	CPT-1	RBS-1	PNT-2	PNT-2	PNT-2	PNT-2	ACT-1	
106B	OFFICE	CPT-1	RBS-1	PNT-2	PNT-2	PNT-2	PNT-2	ACT-1	
107	OFFICE	CPT-1	RBS-1	PNT-2	PNT-2	PNT-2	PNT-2	ACT-1	
108	OFFICE	CPT-1	RBS-1	PNT-2	PNT-2	PNT-2	PNT-2	ACT-1	
109	OFFICE	CPT-1	RBS-1	PNT-2	PNT-2	PNT-2	PNT-2	ACT-1	
110	OFFICE	CPT-1	RBS-1	PNT-2	PNT-2	PNT-2	PNT-2	ACT-1	
111	OFFICE	CPT-1	RBS-1	PNT-2	PNT-2	PNT-2	PNT-2	ACT-1	
112	WK RM	LVT-1	RBS-1	PNT-2	PNT-2	PNT-2	PNT-2	ACT-1	
113	BREAK	LVT-1	RBS-1	PNT-2	PNT-2	PNT-2	PNT-2	GWB/PNT-1	
114	MAIL-IN BALLOTS	CPT-3	RBS-1	PNT-2	PNT-2	PNT-2	PNT-2	ACT-2	
115	SECURE STORAGE	CPT-2	RBS-1	PNT-2	PNT-2	PNT-2	PNT-2	ACT-2	
116	STORAGE	CPT-2	RBS-1	PNT-2	PNT-2	PNT-2	PNT-2	ACT-2	
117	OFFICE	VCT-1	RBS-1	PNT-2	PNT-2	PNT-2	PNT-2	ACT-1	
118	TLT	PTF-1	PTB-1	PNT-3	PNT-3	PNT-3	PNT-3	ACT-1	
119	TLT	PTF-1	PTB-1	PNT-3	PNT-3	PNT-3	PNT-3	ACT-1	
120	CORRIDOR	CPT-1	RBS-1	PNT-2	PNT-2	PNT-2	PNT-2	ACT-2	
121	OPEN OFFICE A	CPT-1/CPT-3	RBS-1	PNT-2	PNT-2	PNT-2	PNT-2	ACT-2	
121B	STAFF ENTRY	LVT-1	RBS-1	PNT-2	PNT-2	PNT-2	PNT-2	ACT-1	
122	OPEN OFFICE B	CPT-1/CPT-3	RBS-1	PNT-2	PNT-2	PNT-2	PNT-2	ACT-2	
123	CORRIDOR	CPT-1	RBS-1	PNT-2	PNT-2	PNT-2	PNT-2	ACT-1	
124	ENTRY	CONC-1	RBS-1	PNT-2	PNT-2	PNT-2	PNT-2	EXISTING	
125	TLT	EXISTING	EXISTING	EXISTING	EXISTING	EXISTING	EXISTING	EXISTING	
126	STORAGE	EXISTING	EXISTING	EXISTING	EXISTING	EXISTING	EXISTING	EXISTING	
127	ROOF ACCESS	CONC-1	RBS-1	PNT-2	PNT-2	PNT-2	PNT-2	EXPOSED	
127	CONFERENCE	EXISTING	EXISTING	EXISTING	EXISTING	EXISTING	EXISTING	EXISTING	
128	SERVER	VCT-2	RBS-1	PNT-2	PNT-2	PNT-2	PNT-2	EXPOSED	
128	OPEN OFFICE C	CPT-1/CPT-3	RBS-1	PNT-2	PNT-2	PNT-2	PNT-2	ACT-2	
129	STORAGE	SEALED CONC	RBS-1	EPOXY PNT-2	EPOXY PNT-2	EPOXY PNT-2	EPOXY PNT-2	EXPOSED	
130	ELEC	CONC-1	RBS-1	PNT-2	PNT-2	PNT-2	PNT-2	EXPOSED	
131	CORRIDOR	CONC-1	RBS-1	PNT-2	PNT-2	PNT-2	PNT-2		
140	FIRE RISER	CONC-1	RBS-1	EPOXY PNT-2	EPOXY PNT-2	EPOXY PNT-2	EPOXY PNT-2	NO CEILING	


LEGEND- FLOOR FINISH PLAN

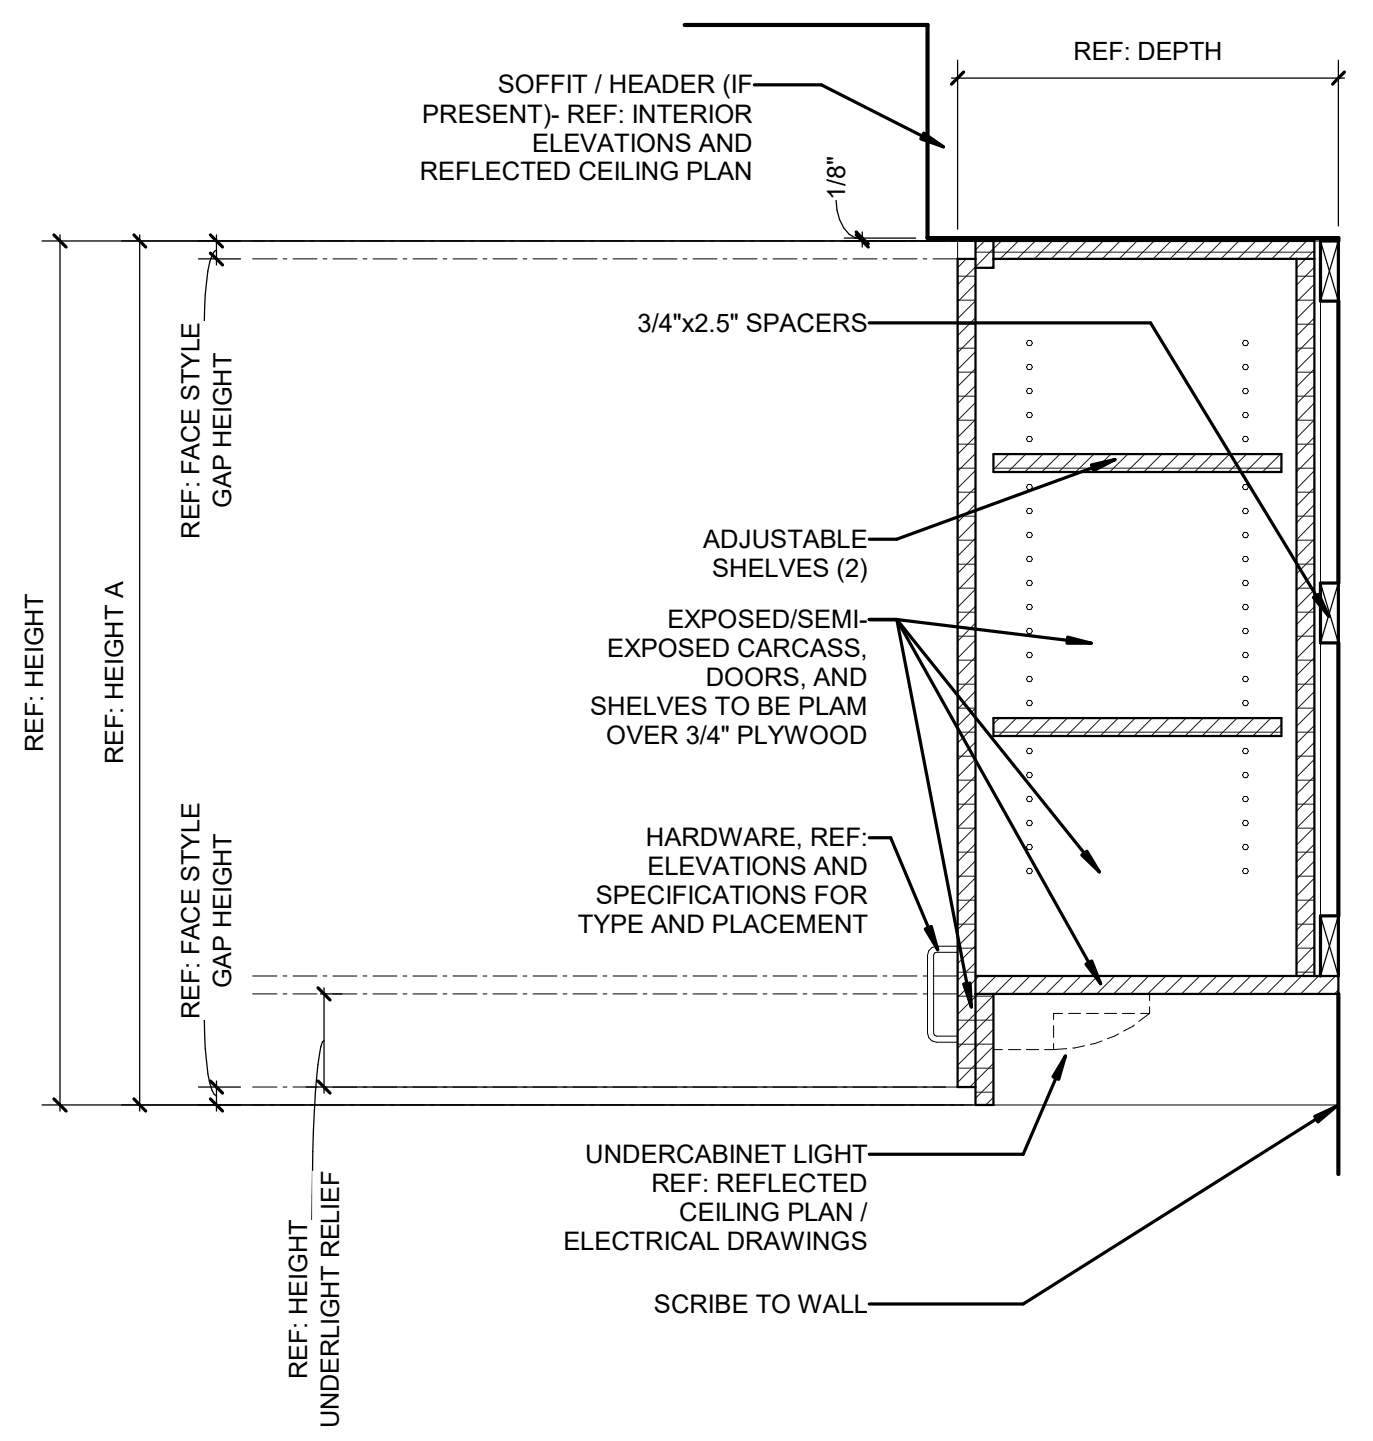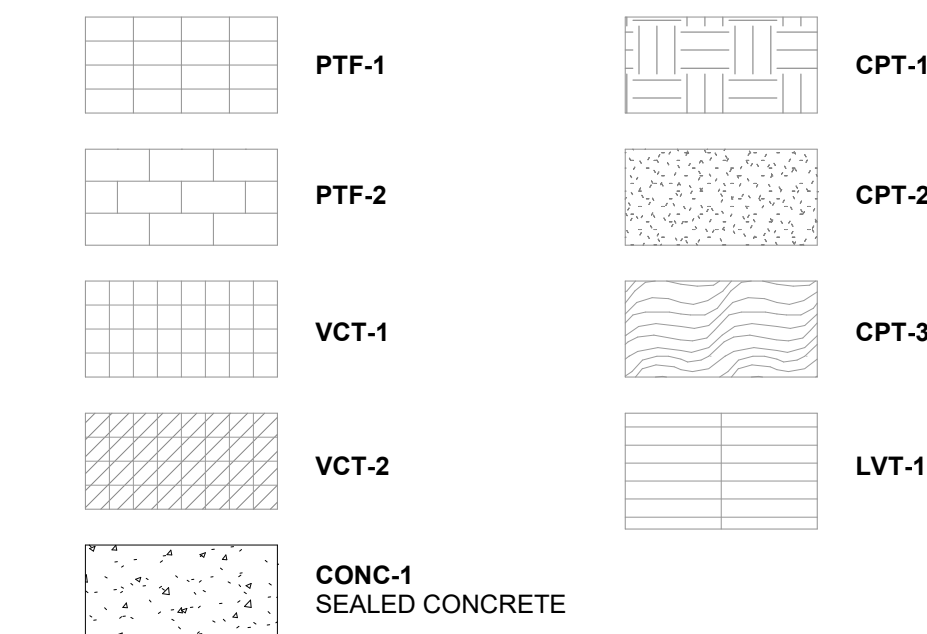

D5 SECTION - WALL CABINET
1 1/2" = 1'-0"

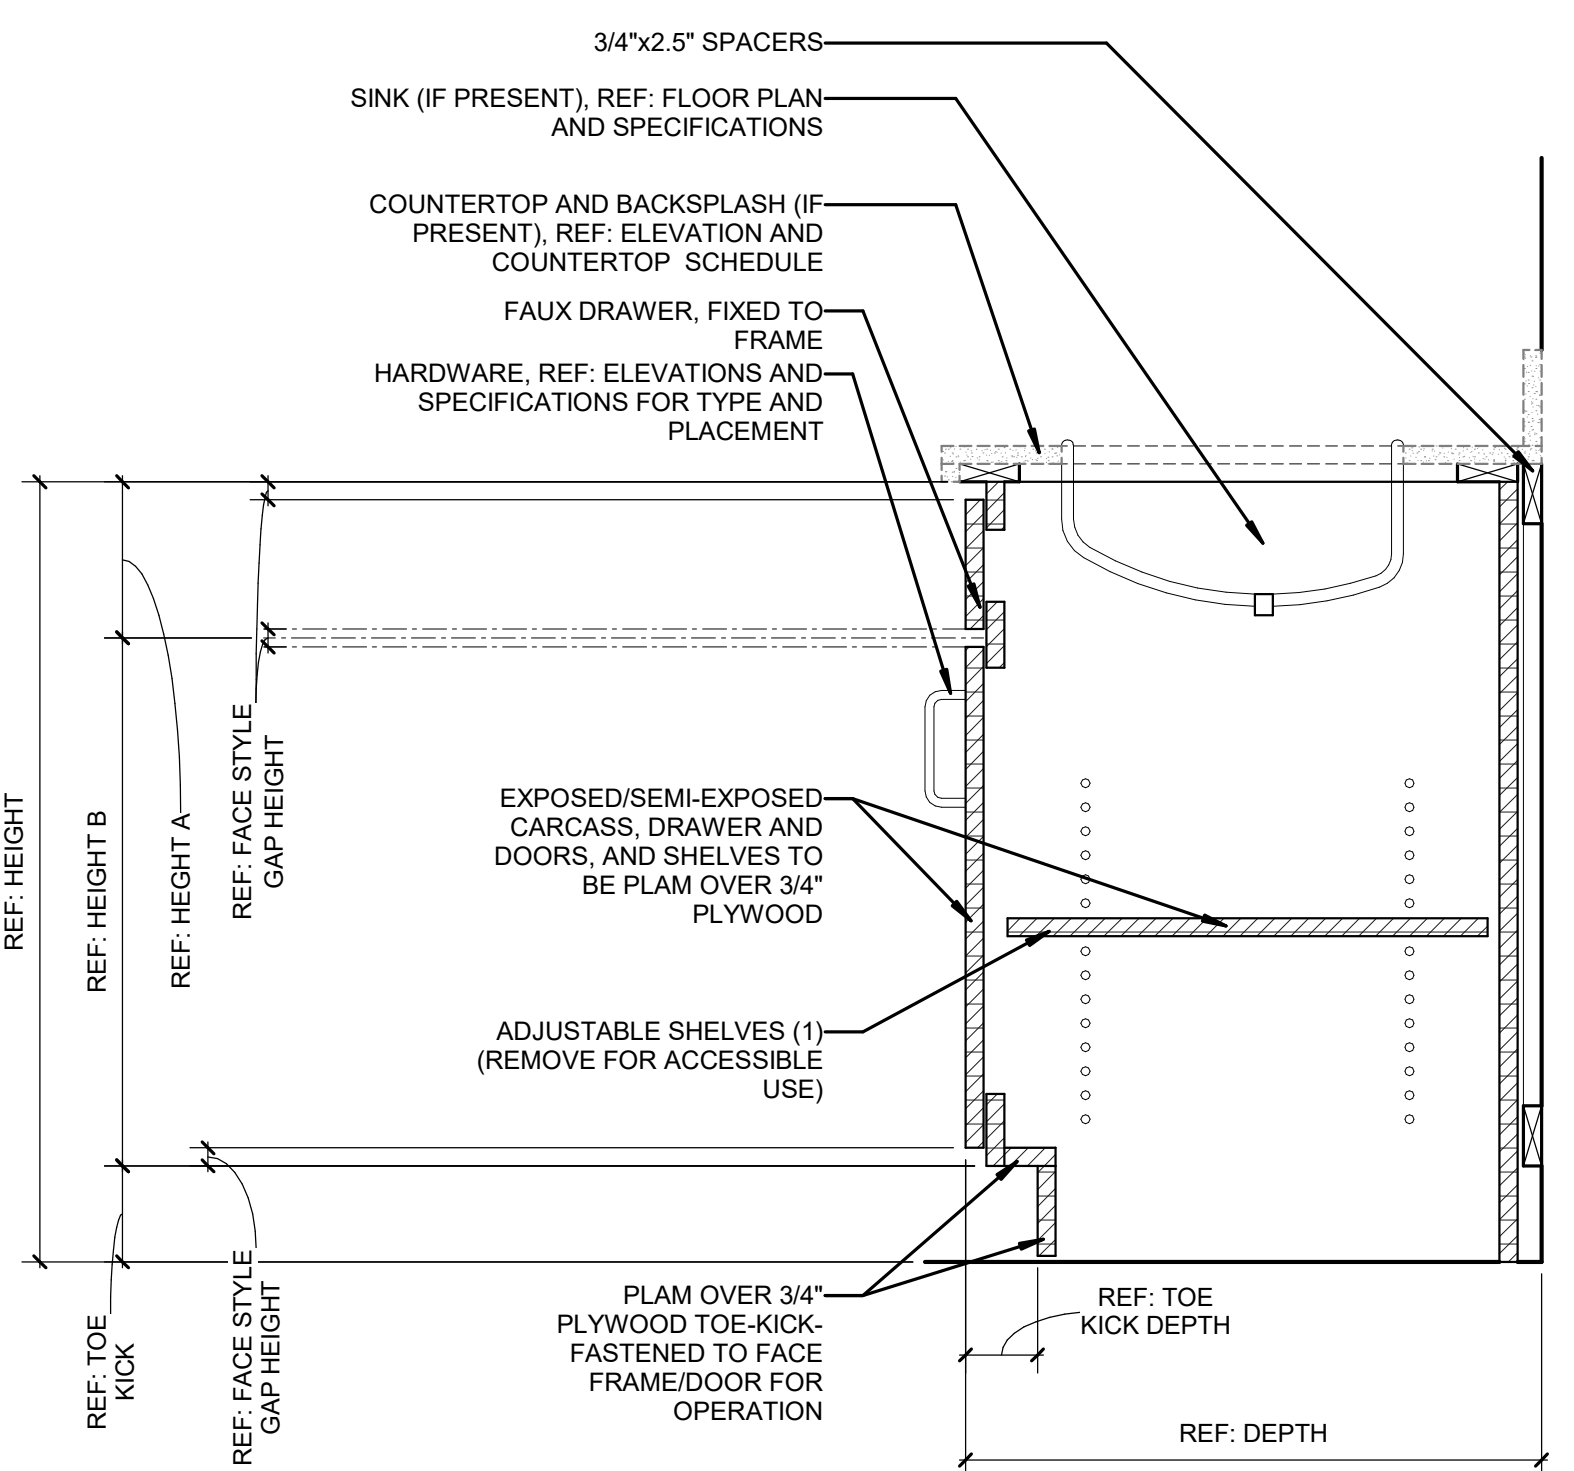

B5 SECTION - ADA SINK CABINET
1 1/2" = 1'-0"

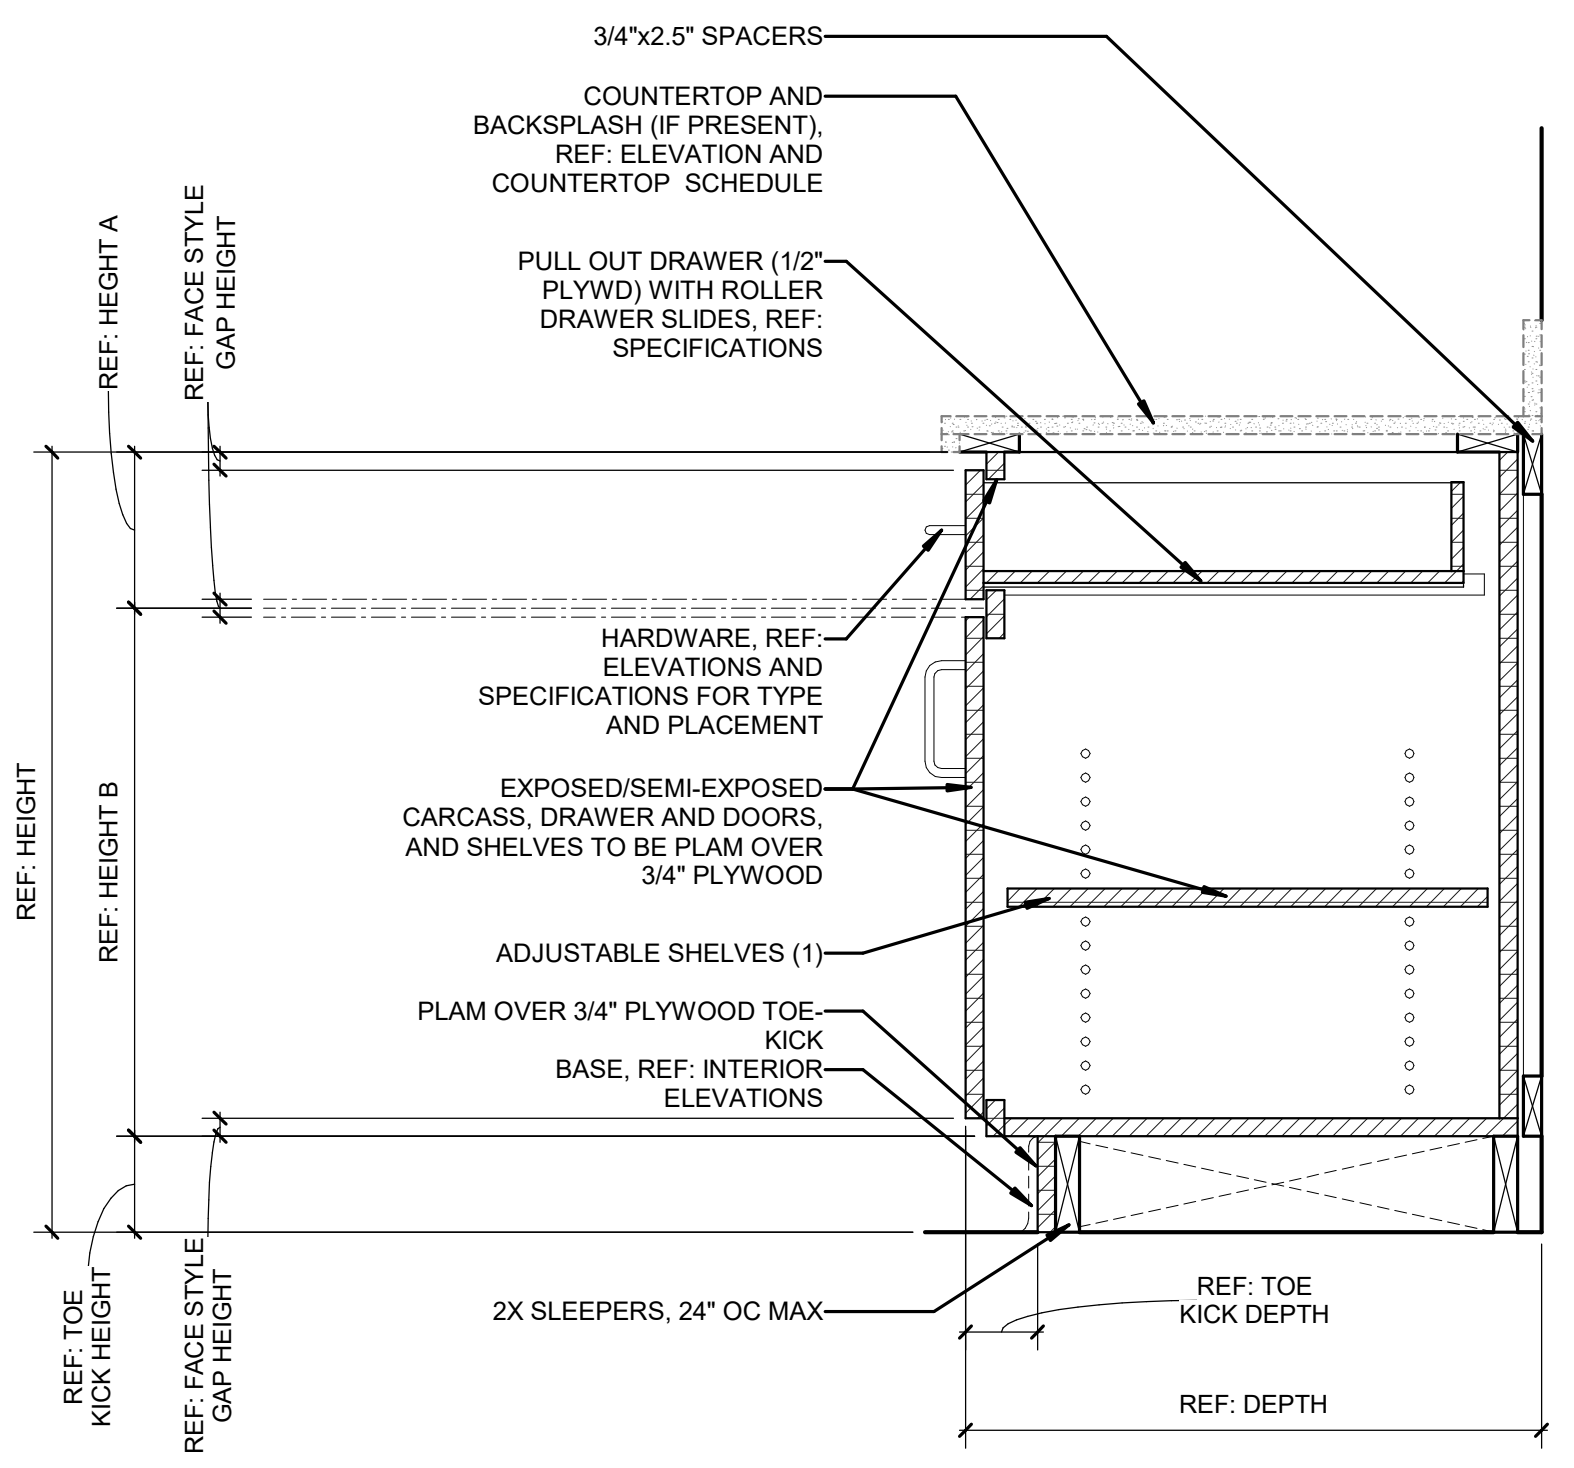

A5 SECTION - BASE CABINET
1 1/2" = 1'-0"

A1 FINISH PLAN
1/8" = 1'-0"



NHC BOARD OF ELECTIONS



101 NORTH THIRD STREET, SUITE 500
WILMINGTON, NORTH CAROLINA 28401
TEL. 910.790.9901 FAX. 910.790.3111
WWW.LS3P.COM



2023.04.04 11:30:09 0407
COPYRIGHT 2023 ALL RIGHTS RESERVED. PRINTED OR ELECTRONIC DRAWINGS AND DOCUMENTATION MAY NOT BE REPRODUCED IN ANY FORM WITHOUT WRITTEN PERMISSION FROM LS3P ASSOCIATES LTD.

New Hanover County
Board of Elections
230 Government Center Drive
Wilmington, NC 28403
LSP PROJECT: 7702- 90810

DATE	DESCRIPTION
0 2023.04.03	PERMIT SET

SHEET NAME:
FINISH LEGEND, RM
SCHEDULE & PLAN,
CASEWORK
DETAILS

ORIG SUBMISSION: 2023.04.03

SHEET:
A-801

PERMIT SET

Wilmington, NC 24803

LEAF PROJECT: 7702-190010


[illegible]

SHEET NAME:
**FURNITURE
COORDINATION
PLAN**

RIG 2023.04.03
SUBMISSION:

HEET: **A-901**

PERMIT SET

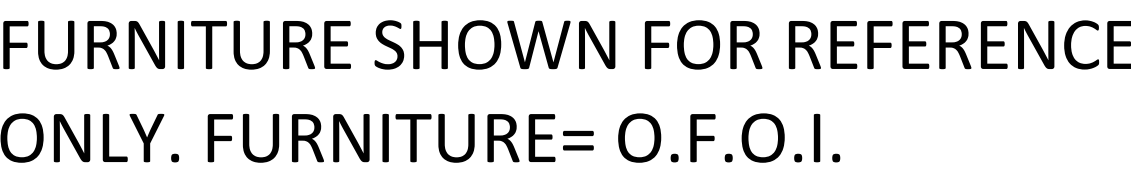

A1 FURNITURE COORDINATION PLAN
1/4" = 1'-0"