		WA	TER HEAT	TER SCH	EDULE			
SYMBOL	LOCATION/	STORAGE	GPH		ELECTRICAL CRITERIA	GAS CRITERIA		NOTES
OTMBOL	MODEL NO.	CAPACITY GALLONS	REC./TEMP. RISE*	OUTLET TEMPERATURE	KW INPUT	BTU INPUT	FLUE SIZE	NOTEG
EWH-1	UNDER KITCH SINK (SEE PLAN) / EEMAX SPEX100T	INSTANT	1.0 GPM/68°		10			7, 8
EWH-2	TOILET ROOMS/ EEMAX SPEX4208T	INSTANT	0.5 GPM/56°		4.1			7, 8
EWH-3	OFFICE AREA JANITOR ROOM /DSE-80	80	61/80°	125°F	12.0			1-7
EWH-4	JANITOR ROOM /DEL-10	10	23/80°	125°F	4.5			1-7
EWH-5	AM AREA JANITOR ROOM /DEL-20	20	23/80°	125°F	4.5		-	1-7
EWH-6	JANITOR ROOM /DSE-80	80	31/80°	125°F	6			1-7
EWH-7	JANITOR ROOM /DSE-80	80	46/80°	125°F	9.0			1-7

MS-2

KS-1

KS-2

EWC-1

HB/NFHB/

STATION

NFHB-R FOOTBATH MOP SINK

HOSE BIBB

SINK - TWO COMPARTMENT

SINK - SINGLE COMPARTMENT

DRINKING FOUNTAIN

FOOTBATH STATION

. PROVIDE T&P RELIEF VALVE AND VACUUM RELIEF VALVE

COORDINATE ELECTRICAL REQUIREMENTS WITH ELECTRICAL.

- PROVIDE GATE/BALL VALVES WITH UNIONS AND DIELECTRIC FITTINGS ON WATER INLET AND OUTLET CONNECTIONS. 3. ALL UNITS SHALL MEET ASHRAE 90.1-2001 AND ALL LOCAL CODE REQUIREMENTS. ALL GAS FIRED UNITS SHALL BE AGA CERTIFIED.
- 4. DESIGN BASIS: A.O. SMITH AND EEMAX. 5. PROVIDE HEAT TRAP OR HEAT TRAP NIPPLES AT WATER HEATER WATER SUPPLY CONNECTIONS.
- PROVIDE MANUFACTURED WATER EXPANSION RELIEF DEVICE, WATTS PLT-5 SERIES EXPANSION TANK(PROVIDE PLT-12 FOR EWH-3/6/7).
- PROVIDE BALL VALVE WITH UNION AND DIELECTRIC FITTINGS ON WATER INLET; PROVIDE UNION AND DIELECTRIC FITTINGS ON WATER OUTLET.

1/2"

1/2"

1/2"

1/2"

1/2"

1/2"

1/2"

3/4"

1/2"

#### FIXTURE CONNECTION SCHEDULE MINIMUM SIZE UTILITY TO FIXTURE WASTE HOT WATER COLD WATER FIXTURE # FIXTURE TYPE CONNECTION SUPPLY SUPPLY WATER CLOSET - FLUSH VALVE WC-1 WALL HUNG WATER CLOSET - FLUSH VALVE WC-1H WALL HUNG - H.C. WATER CLOSET - FLUSH VALVE WC-2 FLOOR MOUNTED L-1 LAVATORY - WALL-HUNG 1 1/4" 1/2" 1/2" 1/2" LAVATORY - UNDERMOUNT 1 1/4" UR-1 URINAL - WALL HUNG FLUSH VALVE UR-1H URINAL - WALL HUNG FLUSH VALVE - H.C. 3/4" MS-1 MOP SINK 1/2" 1/2"

PUMP SCHEDULE								
SYMBOL	SERVICE/ LOCATION	MANUFACTURER MODEL#	TYPE	FLOW (GPM)	HEAD (PSI/FT)	RPM	HP	NOTES
SP-1	ELEVATOR/ ELEVATOR PIT	STANCOR SE-100	SUBMERSIBLE	50	15.48/36	3450	1	
HWRP-1	HOT WATER/ SEE PLAN	TACO 113	IN-LINE	5	6.9/16	1725	1/8	1
HWRP-2	HOT WATER/ SEE PLAN	TACO 112	IN-LINE	3.5	9/22	3450	1/3	1
BP-1A/1B	DOMESTIC WATER / SEE PLAN	VC SYSTEMS DUPLEX	END SUCTION	340 (TOTAL)	80/185	3500	20/20	2

1 1/2"

1 1/2"

1 1/2"

- I. TACO CIRCULATOR WITH 265-3 DIGITAL TIMER. SET FLOW RATE(GPM) PER ENLARGED PLANS.
- 2. DUPLEX SYSTEM FLOW: 340 GPM(TOTAL). EACH DOMESTIC WATER BOOSTER PUMP AT 65% OF SYSTEM CAPACITY 221 GPM W/ 185' TDH. MODEL NO. 2VC-DPE-PMC-VH-20-430-460

FLOW TEST [	DATA SCHEDULE
UPON AWARD OF THE CONTRACT, THE F PERFORM A FLOW TEST ON THE TWO HY THE TEST DATA TO THE ENGINEER AND A PRESSURE/FLOW DATA WAS OBTAINED F	DRANTS NEAREST THE SITE AND FORWARD ARCHITECT. THE FOLLOWING WATER
STATIC PRESSURE	
RESIDUAL PRESSURE	
FLOW (GPM)	
ELEVATION OF TEST HYDRANT	
LOCATION OF TEST HYDRANT	
DATE OF TEST	
TIME OF DAY OF TEST	

### DRAINAGE PRODUCTS/SPECIALTIES

UNLESS OTHERWISE INDICATED NUMBERS ARE JAY R. SMITH. APPROVED EQUAL PRODUCTS: ZURN, JOSAM, WADE, WATTS AND PRECISION PLUMBING PRODUCTS

CO-EXPOSED CLEANOUT - UNFINISHED AREAS JAY R. SMITH FIG. 4420 CAST BRONZE COUNTERSUNK PLUG WITH SLOT TO RECEIVE 1/2" THICK STEEL BAR STOCK.

WCO-WALL CLEANOUT - FINISHED AREAS JAY R. SMITH FIG. 4436 C.I. FERRULE FOR NO HUB OR SERVICE WEIGHT PIPE, NICKEL BRONZE ROUND FRAME AND COVER WITH SECURING SCREWS.

JAY R. SMITH FIG. 4220 C.I. CLEANOUT WITH GASKET SEAL THREADED PLUG FOR EASY REMOVAL, ADJUSTABLE ROUND CAST IRON TOP WITH SECURING SCREW, SPEEDI-SET OUTLET CONNECTION.

JAY R. SMITH FIG. 4020 C.I. CLEANOUT WITH GASKET SEAL THREADED PLUG, ADJUSTABLE ROUND NICKEL BRONZE TOP, SPEEDI-SET OUTLET CONNECTION.

FCO-CARPETED FLOORS JAY R. SMITH FIG. 4020-Y C.I. CLEANOUT WITH GASKET SEAL THREADED PLUG, ADJUSTABLE ROUND NICKEL BRONZE TOP COMPLETE WITH STAINLESS STEEL CARPET MARKER WITH SECURING SCREW. SPEEDI-SET OUTLET CONNECTION.

YCO-EXTERIOR PAVED/CONCRETE AREAS JAY R. SMITH FIG. 4261 C.I. FLANGED HOUSING WITH HEAVY DUTY C.I. COVER, LIFTING

DEVICE, GASKET SEAL THREADED PLUG, V.P. SCREWS IN COVER. YCO-EXTERIOR UNSURFACED AREAS

JAY R. SMITH FIG. 4261 C.I. FLANGED HOUSING WITH HEAVY DUTY C.I. COVER, LIFTING DEVICE, GASKET SEAL THREADED PLUG, V.P. SCREWS IN COVER. PROVIDE 24" x 12" CONCRETE PAD FLUSH WITH SURFACE.

FD "G" - FLOOR DRAINS-GENERAL/RESTROOMS JAY R. SMITH FIG. 2005-B6 SERIES C.I. FLOOR DRAIN WITH 6" DIAMETER SQUARE NICKEL BRONZE STRAINER, SPEEDI-SET OUTLET CONNECTION AND TRAP PRIMER CONNECTION.

FD "M" -FLOOR DRAINS-GENERAL PURPOSE/MECHANICAL ROOM JAY R. SMITH FIG. 3715 SERIES CAST IRON 12" DIAMETER DRAIN WITH SEDIMENT BUCKET, CAST IRON GRATE WITH INTEGRAL 4" FUNNEL, SPEEDI-SET OUTLET CONNECTION. FS-1 - SANI-CEPTOR FLOOR & INDIRECT WASTE SINK JAY R. SMITH FIG. 3410-12 ACID RESISTANT FLOOR SINK WITH 1/2 GRATE AND DOME

FS-2 - SANI-CEPTOR FLOOR & INDIRECT WASTE SINK JAY R. SMITH FIG. 3430-12 ACID RESISTANT FLOOR SINK WITH 1/2 GRATE AND DOME

LAVATORY-WALL HUNG SUPPORT JAY R. SMITH #700 FOR MASONRY WALLS AND #700-M31 FOR METAL STUD WALLS.

ELECTRIC WATER COOLER CARRIER-WALL HUNG JAY R. SMITH FIG. 830 SUPPORT WITH UPRIGHTS OF HIGH STRENGTH STEEL WITH WELDED

BASES BOLTED TO FLOOR. FOR STEEL STUD WALLS, USE M31 RECTANGULAR UPRIGHTS.

TP-"A"-AUTOMATIC TRAP PRIMER PPP PRIME-PRO SERIES AUTOMATIC TRAP PRIMER WITH MULTIPLE OUTLET DISTRIBUTION UNITS AS REQUIRED.

WATER HAMMER ARRESTORS P.P.P. SYSTEM RATED PLUS SERIES COPPER WATER HAMMER ARRESTORS. INSTALL IN AN UPRIGHT POSITION AT ALL FLUSH VALVES, DISHWASHERS, PRV STATIONS, AND OTHER QUICK CLOSING VALVES, SOLENOIDS AND PLUMBING FIXTURES. LOCATE AND SIZE AS INDICATED ON DRAWINGS. WHERE NOT SHOWN ON DRAWINGS, LOCATE AND SIZE IN ACCORDANCE WITH PDI STANDARD

WOODFORD #24P WITH LOOSE TEE KEY AND VACUUM BREAKER HOSE BIBB, CHROME PLATED FOR USE IN PUBLIC AREAS.

NFHB-HOSEBIBB-EXTERIOR JAY R. SMITH FIG. 5609-QT NON FREEZE 3/4" CAST BRONZE EXPOSED HYDRANT

BOTTOM STRAINER.

BOTTOM STRAINER.

INTEGRAL VACUUM BREAKER, NICKEL BRONZE FACE, AND SIZED IN ACCORDANCE WITH WALL THICKNESS.

3/4" ROOF MOUNT PEDESTAL NON-FREEZE HYDRANT COMPLETE WITH MOUNTING FLANGE AND SHROUD, MALE HOSE END OUTLET WITH VACUUM BREAKER, DRAIN DOWN FITTING ON INLET SIDE, WOODFORD MODEL SRH.

IMS - ICE MAKER SUPPLY IPS WATER-TITE MODEL AB9700HACP PLASTIC BOX, BRASS QTR TURN VALVES W/ INTERGRAL LEAD FREE HAMMER ARRESTERS, 1/2" COLD WATER CONNECTION. PROVIDE GUY GRAY FR-12 SERIES IN FIRE RATED WALLS.

DSN - DOWNSPOUT NOZZLE JAY R. SMITH FIG. 1775. DOWNSPOUT COVER WITH HINGED PERFORATED COVER.

**RD - ROOF DRAIN** 

6" RD AND SMALLER: CAST IRON BODY WITH COMBINED FLASHING AND GRAVEL STOP. UNDERDECK CLAMP AND SUMP RECEIVER, ADJUSTABLE EXTENSION AND CAST IRON DOME. <u>JAY R. SMITH 1015-R-C</u> OR APPROVED EQUAL. 8" RD AND LARGER: HIGH CAPACITY WITH 216 SQ. IN. FREE AREA, HAVE A CAST IRON BODY

WITH COMBINED FLASHING AND GRAVEL STOP, UNDERDECK CLAMP AND SUMP RECEIVER, ADJUSTABLE EXTENSION AND CAST IRON DOME. ZURN MODEL Z101 OR APPROVED EQUAL. ERD - EMERGENCY ROOF DRAIN

6" ERD AND SMALLER: CAST IRON BODY, COMBINED FLASHING AND GRAVEL STOP, CAST-IRON DOME, 3" MINIMUM INTERNAL WATER DAM, UNDER DECK CLAMP, SUMP RECEIVER AND EXTENSION AS REQUIRED. <u>JAY R. SMITH 1070-C-R</u> OR APPROVED EQUAL.

8" ERD AND LARGER: HIGH CAPACITY WITH 216 SQ. IN. FREE AREA, HAVE A CAST IRON BODY WITH COMBINED FLASHING AND GRAVEL STOP, CAST-IRON DOME, 3" MINIMUM INTERNAL WATER DAM, UNDERDECK CLAMP, SUMP RECEIVER AND ADJUSTABLE EXTENSION AS REQUIRED. ZURN MODEL Z101 OR APPROVED EQUAL.

PLUMBING	NOTES

- REFER TO ARCHITECTURAL DRAWINGS FOR EXACT LOCATIONS AND ELEVATIONS OF ALL PLUMBING FIXTURES.
- ALL PLUMBING WORK SHALL BE INSTALLED IN ACCORDANCE WITH2018 NORTH CAROLINA PLUMBING CODE (WITH LOCAL)AMENDMENTS AND ALL APPLICABLE LOCAL CODE AND
  - ALL PIPING ABOVE GRADE SHALL BE PROPERLY SUPPORTED FROM THE BUILDING STRUCTURE AND SHALL NOT REST ON CEILING TILES OR BE SUPPORTED FROM
- WATER PIPING ROUTED ABOVE CEILING AND IN EXTERIOR WALLS SHALL BE ROUTED ON HEATED SIDE (UNDERSIDE) OF CEILING INSULATION AND HEATED SIDE (INSIDE)

CEILING TILES.

OF WALL INSULATION.

- SANITARY AND DRAINAGE PIPING 2" AND SMALLER SHALL BE SLOPED AT 1/4" PER FOOT MINIMUM, PIPING 3" AND LARGER SHALL BE SLOPED AT 1/8" PER FOOT MINIMUM.
- TOPS OF ALL FLOOR DRAINS AND CLEANOUTS SHALL BE SET FLUSH WITH FINISHED FLOOR. TRAP PRIMERS ARE TO BE PROVIDED ON ALL FLOOR DRAINS AND HUB DRAINS. TP "A" AUTOMATIC TRAP PRIMERS ARE TO BE PROVIDED IN ALL REQUIRE LOCATIONS, UON.
- LOCATE ALL SECTIONAL OR MAIN CONTROL VALVES WITHIN 1'-0" FROM ACCESS PANELS, CEILING TILES, OR OTHER POINT OF ACCESS.
- ALL COLD WATER, HOT WATER AND DRAIN PIPING AT HANDICAPPED FIXTURES SHALL BE INSULATED WITH HANDI-LAV GUARD MODELS 102 AND 105 INSULATION KITS.
- PROVIDE SHOCK ABSORBERS SIZED PER PDI SPECIFICATIONS ON ALL DOMESTIC WATER LINES SERVING FLUSH VALVE FIXTURES, WASHING MACHINES SUPPLIES, PRV STATIONS AND OTHER INSTALLATIONS WITH QUICK CLOSING VALVES.
- PROVIDE A BASE CLEANOUT AT THE LOWEST LEVEL OF ALL SANITARY AND WASTE STACKS.
- PROVIDE REDUCED PRESSURE BACKFLOW PREVENTORS AT ALL DOMESTIC WATER CONNECTIONS TO MECHANICAL EQUIPMENT, POOL AND IRRIGATION CONNECTIONS. AND VENDING EQUIPMENT CONNECTIONS AS REQUIRED BY LOCAL CODE AND AUTHORITIES. BACKFLOW PREVENTORS ARE TO BE LOCATED WITH A MINIMUM OF 1'-0" CLEARANCE AT THE LOWEST POINT AND AT NO MORE THAN 5'-0" ABOVE FLOOR AT THE HIGHEST POINT OF THE DEVICE.
- PROVIDE MANUFACTURED EXPANSION DEVICE OR FABRICATED EXPANSION LOOP ON ALL PIPING SYSTEMS CROSSING BUILDING EXPANSION JOINTS.
- CONTRACTOR SHALL COORDINATE ELECTRICAL CHARACTERISTICS AND REQUIREMENTS OF ALL PLUMBING EQUIPMENT WITH THE ELECTRICAL DRAWINGS AND THE ELECTRICAL CONTRACTOR, AND SHALL FURNISH EQUIPMENT WIRED FOR THE VOLTAGES SHOWN THEREIN.
- ALL PLUMBING EQUIPMENT, PIPING, INSULATION, ETC. INSTALLED IN HVAC PLENUM SPACES SHALL MEET CODE REQUIREMENTS FOR SMOKE AND COMBUSTIBILITY.
- ALL PLUMBING EQUIPMENT AND SYSTEMS SHALL BE GUARANTEED FOR A MINIMUM

PERIOD OF ONE YEAR AFTER FINAL ACCEPTANCE.

- ALL PIPE PENETRATIONS OF FIRE AND/OR SMOKE RATED ASSEMBLIES SHALL BE FIRE STOPPED AS REQUIRED TO RESTORE ASSEMBLY TO ORIGINAL INTEGRITY. FIRE BARRIER PRODUCTS SHALL BE AS MANUFACTURED BY 3M COMPANY, CP25 CAULK, CS195 COMPOSITE PANEL, FS195 WRAP/SRINK, TREMCO, HILTI, METACAULK, NELSON. OR PSS 7900 SERIES SYSTEMS AS RECOMMENDED BY MANUFACTURER FOR PARTICULAR APPLICATIONS, OR EQUIVALENT SYSTEM AS APPROVED BY LOCAL CODE OFFICIALS. ALSO, REFER TO DIVISION 7 - THERMAL AND MOISTURE PROTECTION.
- PROVIDE AN INLINE FILTER ON THE DOMESTIC WATER SUPPLY TO ALL ICE MACHINES. FILTRINE MODEL 4TM OR ENGINEER APPROVED EQUAL.
- 19. ALL VENT THRU ROOF PENETRATIONS SHALL BE ROUTED TO TERMINATE AT THE LEAST VISIBLE LOCATION FROM THE ENTRY VIEW.
- PROVIDE A FLANGED DOUBLE SPHERE FLOATING FLANGE FLEXIBLE CONNECTOR COMPLETE WITH CONTROL RODS AT THE DOMESTIC BOOSTER PUMP SUCTION AND DISCHARGE CONNECTIONS (PRESSURE RATING AS REQUIRED BY SYSTEM PRESSURE). KINETICS KINFLEX
- PROVIDE PRVS AT ALL BRANCH LINES SERVING FIXTURES OFF THE CW MAIN DOWNSTREAM OF THE BOOSTER PUMP, WHERE PRESSURES EXCEED 80 PSI.
- THE MINIMUM CLEAR HEIGHT FOR ALL PLUMBING SYSTEMS: REFER TO ARCHITECTURAL DRAWING FOR CLEAR HEIGHTS.

# SEISMIC NOTE:

ALL MECHANICAL EQUIPMENT SHALL BE PROVIDED WITH SEISMIC RESTRAINTS FOR THE SEISMIC USE GROUP IN WHICH THE BUILDING IS LOCATED IN (SEE STRUCTURAL DRAWINGS) AND ACCORDANCE WITH THE 2012 INTERNATIONAL BUILDING CODE SECTION 1631 EARTHQUAKE LOADS, ASCE 7-05 CHAPTER 13 (FORMULAS 13.3-1, 13.3-2, AND 13.3-3), AND THE 2012 INTERNATIONAL BUILDING CODE CHAPTER 17 STRUCTURAL TESTS AND SPECIAL INSPECTIONS. DESIGN OF SYSTEM AND ALL SUBMITTAL DATA TO INCLUDE SEISMIC CALCULATIONS CERTIFIED BY A PROFESSIONAL ENGINEER LICENSED IN THE STATE OF PROJECT LOCATION AND EMPLOYED BY THE RESTRAINT MANUFACTURER. SHOP DRAWINGS SHALL BE SUBMITTED FOR APPROVAL. SEISMIC RESTRAINTS SHALL BE BY MASON INDUSTRIES INC. OR AN APPROVED EQUAL. SEE SPECIFICATIONS FOR ADDITIONAL INFORMATION.

PLUMBING LEGEND					
SYMBOL	ABBREVIATION	DESCRIPTION			
	A/C	ABOVE CEILING			
	AD	AREA DRAIN			
	A/F	ABOVE FLOOR			
	AFF	ABOVE FINISHED FLOOR			
	AFG	ABOVE FINISHED GRADE			
	AP	ACCESS PANEL			
	B/C	BELOW COUNTER			
	B/F	BELOW FLOOR			
	B/G	BELOW GRADE			
	BV	HOT WATER RETURN BALANCING VALVE			
	CV	CHECK VALVE			
	CW	COLD WATER PIPING			
C	DN	PIPING TURNING DOWN			
	FCO	FLOOR CLEANOUT			
[O]C—	FD	FLOOR DRAIN			
 G	G	GAS PIPING - LOW PRESSURE			
—MG—	MG	GAS PIPING - MEDIUM PRESSURE			
$\longrightarrow$	GV	GATE/BALL VALVE			
<b>─</b> ~;,	HB/NFHB	HOSE BIBB/NON-FREEZE HOSE BIBB			
	H.C.	HANDICAPPED			
©c—	HD	HUB DRAIN			
	HW	HOT WATER PIPING			
	HWR	HOT WATER RETURN PIPING			
	O/H	OVER HEAD			
∞		P-TRAP			
	PRV	PRESSURE REDUCING VALVE			
0 0	RD	ROOF DRAIN			
	RPBP	REDUCED PRESSURE BACKFLOW PREVENTOR			
s	S,W	SOIL, WASTE PIPING (ABOVE GROUND)			
	TP	TRAP PRIMER			
 		UNION			
<u> </u>	UP	PIPING TURNING UP			
	V	VENT PIPING			
	VTR	VENT THRU ROOF			
1	wco	WALL CLEANOUT			
<u> </u>	WH/NFWH	WALL HYDRANT/NON-FREEZE WALL HYDRANT			
<u> </u>	YCO	YARD CLEANOUT			

**DESIGN CRITERIA:** 

AR SORTABLE MULTI-STORY V3.0 IT INFRASTRUCTURE DESIGN NAFC V9.4 2021

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PLUMBING SHEET INDEX					
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P-408	ENLARGED RESTROOM PLANS - PLUMBING				
P-409	ENLARGED PLANS - PLUMBING				
TOTAL DRAWINGS ISSUI	ED: 45				

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UMBER DATE DESCRIPTION 01/21/22 BID SET

PRINT RECORD

PROJECT INFORMATION

**PROJECT** 

WILMINGTON, NC


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AND EXISTING CONDITIONS AT THE SITE BEFORE PROCEEDING WITH EACH PHASE OF HIS WORK. 01/21/22 2021-136 SHEET TITLE

GENERAL NOTES, LEGENDS AND **SCHEDULES -**PLUMBING

SHEET NUMBER

P-001

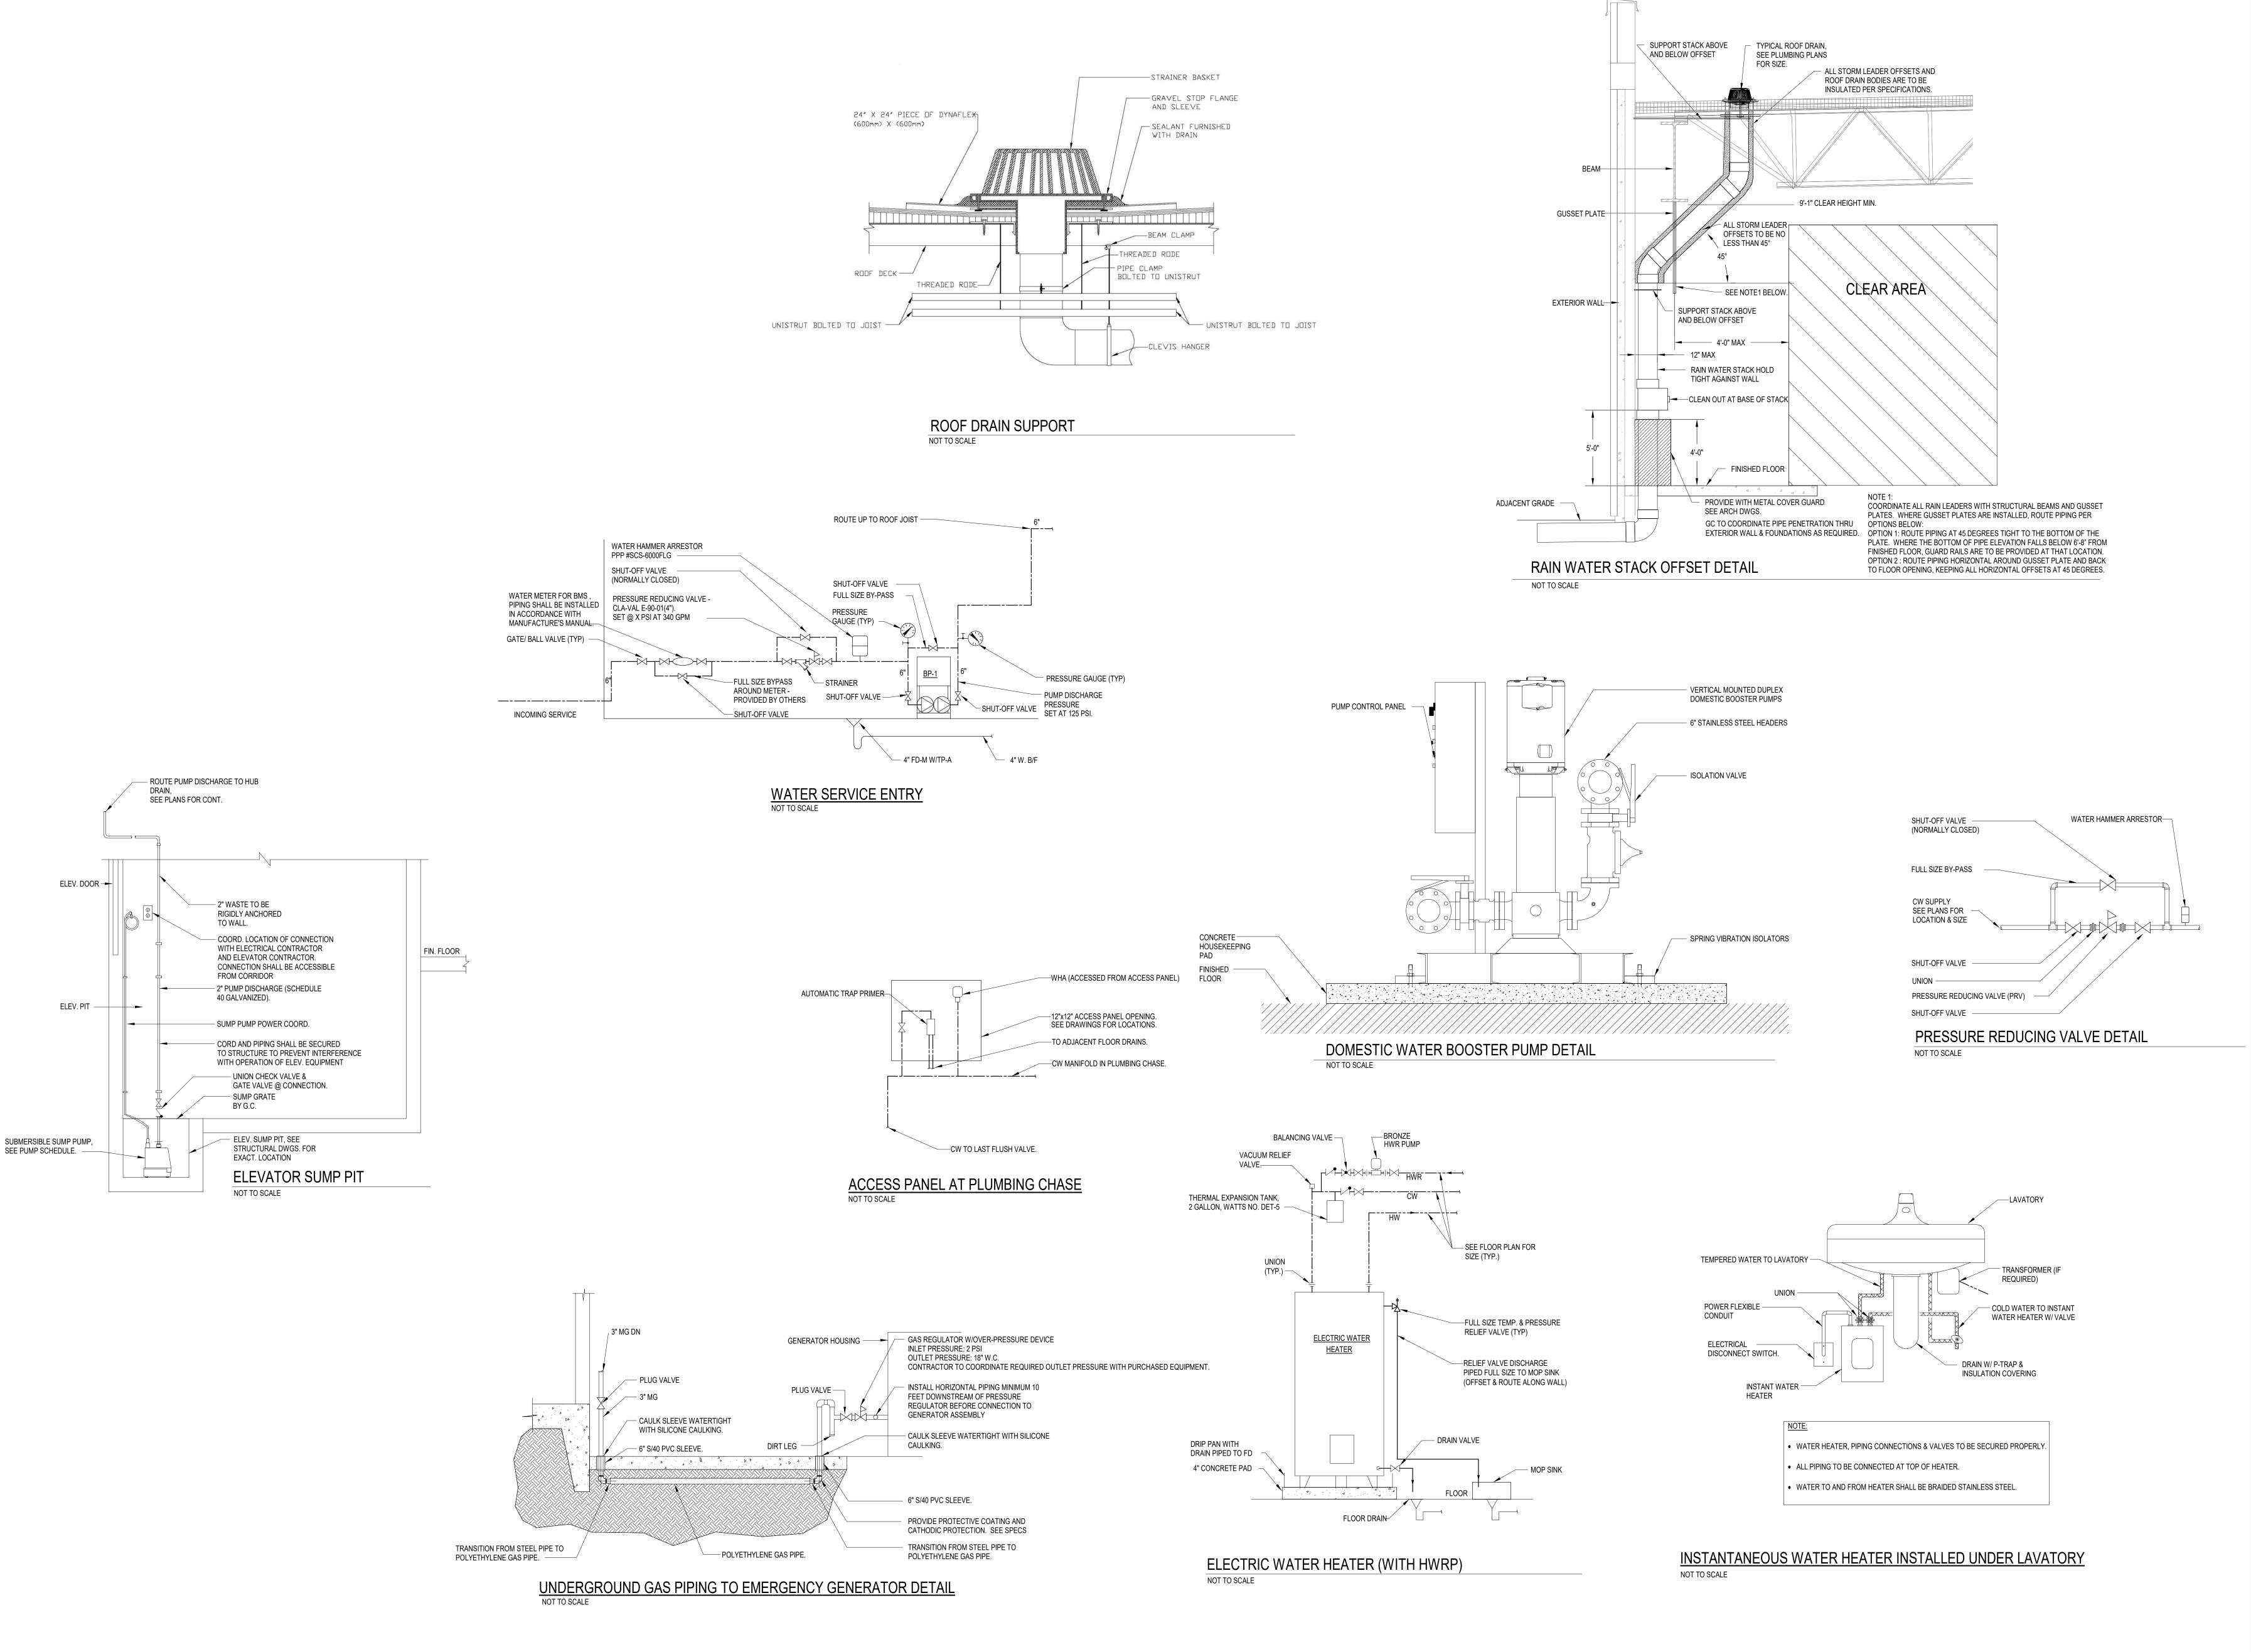

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Drawn By:Author Checked By:Checker

PRINT RECORD

NUMBER DATE DESCRIPTION

01/21/22 BID SET

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PROJECT WHALE

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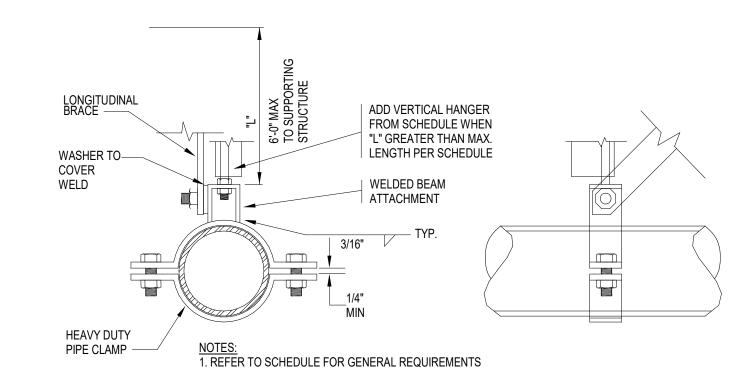
01/21/22 2021-136

SHEET TITLE

PLUMBING

DETAILS


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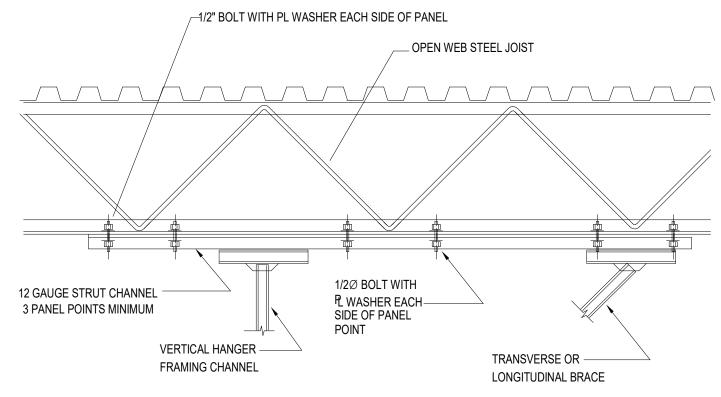


### LONGITUDINAL BRACING FOR PIPES

NOT TO SCALE

PIPE SIZE (IN.)	MAX. WT. (lbs per foot)	VERTICAL HANGERS	TRANSVERSE BRACES (CABLE SIZE)	LONGITUDINAL BRACES (CABLE SIZE)	BOLT SIZE	CONNECTION TYPE TO STRUCTURAL MEMBER	ROD SIZE (in.)	MAX. LENGTH FOR RODS
1 - 2-1/2	7.9	L2X2X16GA	L2-1/2x2-1/2x16GA (1/4" CABLE)	L2-1/2x2-1/2x16GA (1/4" CABLE)	3/8	A	1/2	25"
3	10.8	L2X2X16GA	L2-1/2x2-1/2x16GA (1/4" CABLE)	L2-1/2x2-1/2x16GA (1/4" CABLE)	3/8	А	1/2	25"
4	16.3	L2X2X16GA	L2-1/2x2-1/2x16GA (1/4" CABLE)	L2-1/2x2-1/2x16GA (1/4" CABLE)	3/8	А	5/8	31"



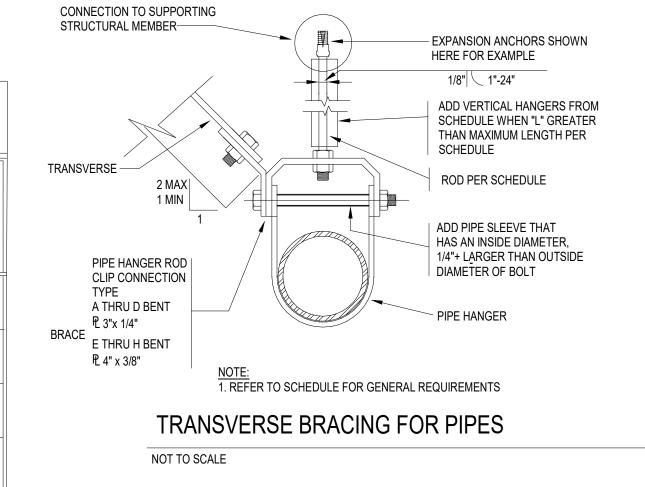

## CONNECTIONS TO OPEN WEB STEEL JOIST

NOT TO SCALE

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01/21/22 BID SET

PROJECT INFORMATION

PROJECT WHALE

WILMINGTON, NC

SEEFRIED INDUSTRIAL PROPERTIES


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THE CONTRACTOR SHALL VERIFY ALL DIMENSIONS AND EXISTING CONDITIONS AT THE SITE BEFORE PROCEEDING WITH EACH PHASE OF HIS WORK.

DATE PROJECT NO
01/21/22 2021-136
SHEET TITLE

PLUMBING DETAILS

P-003

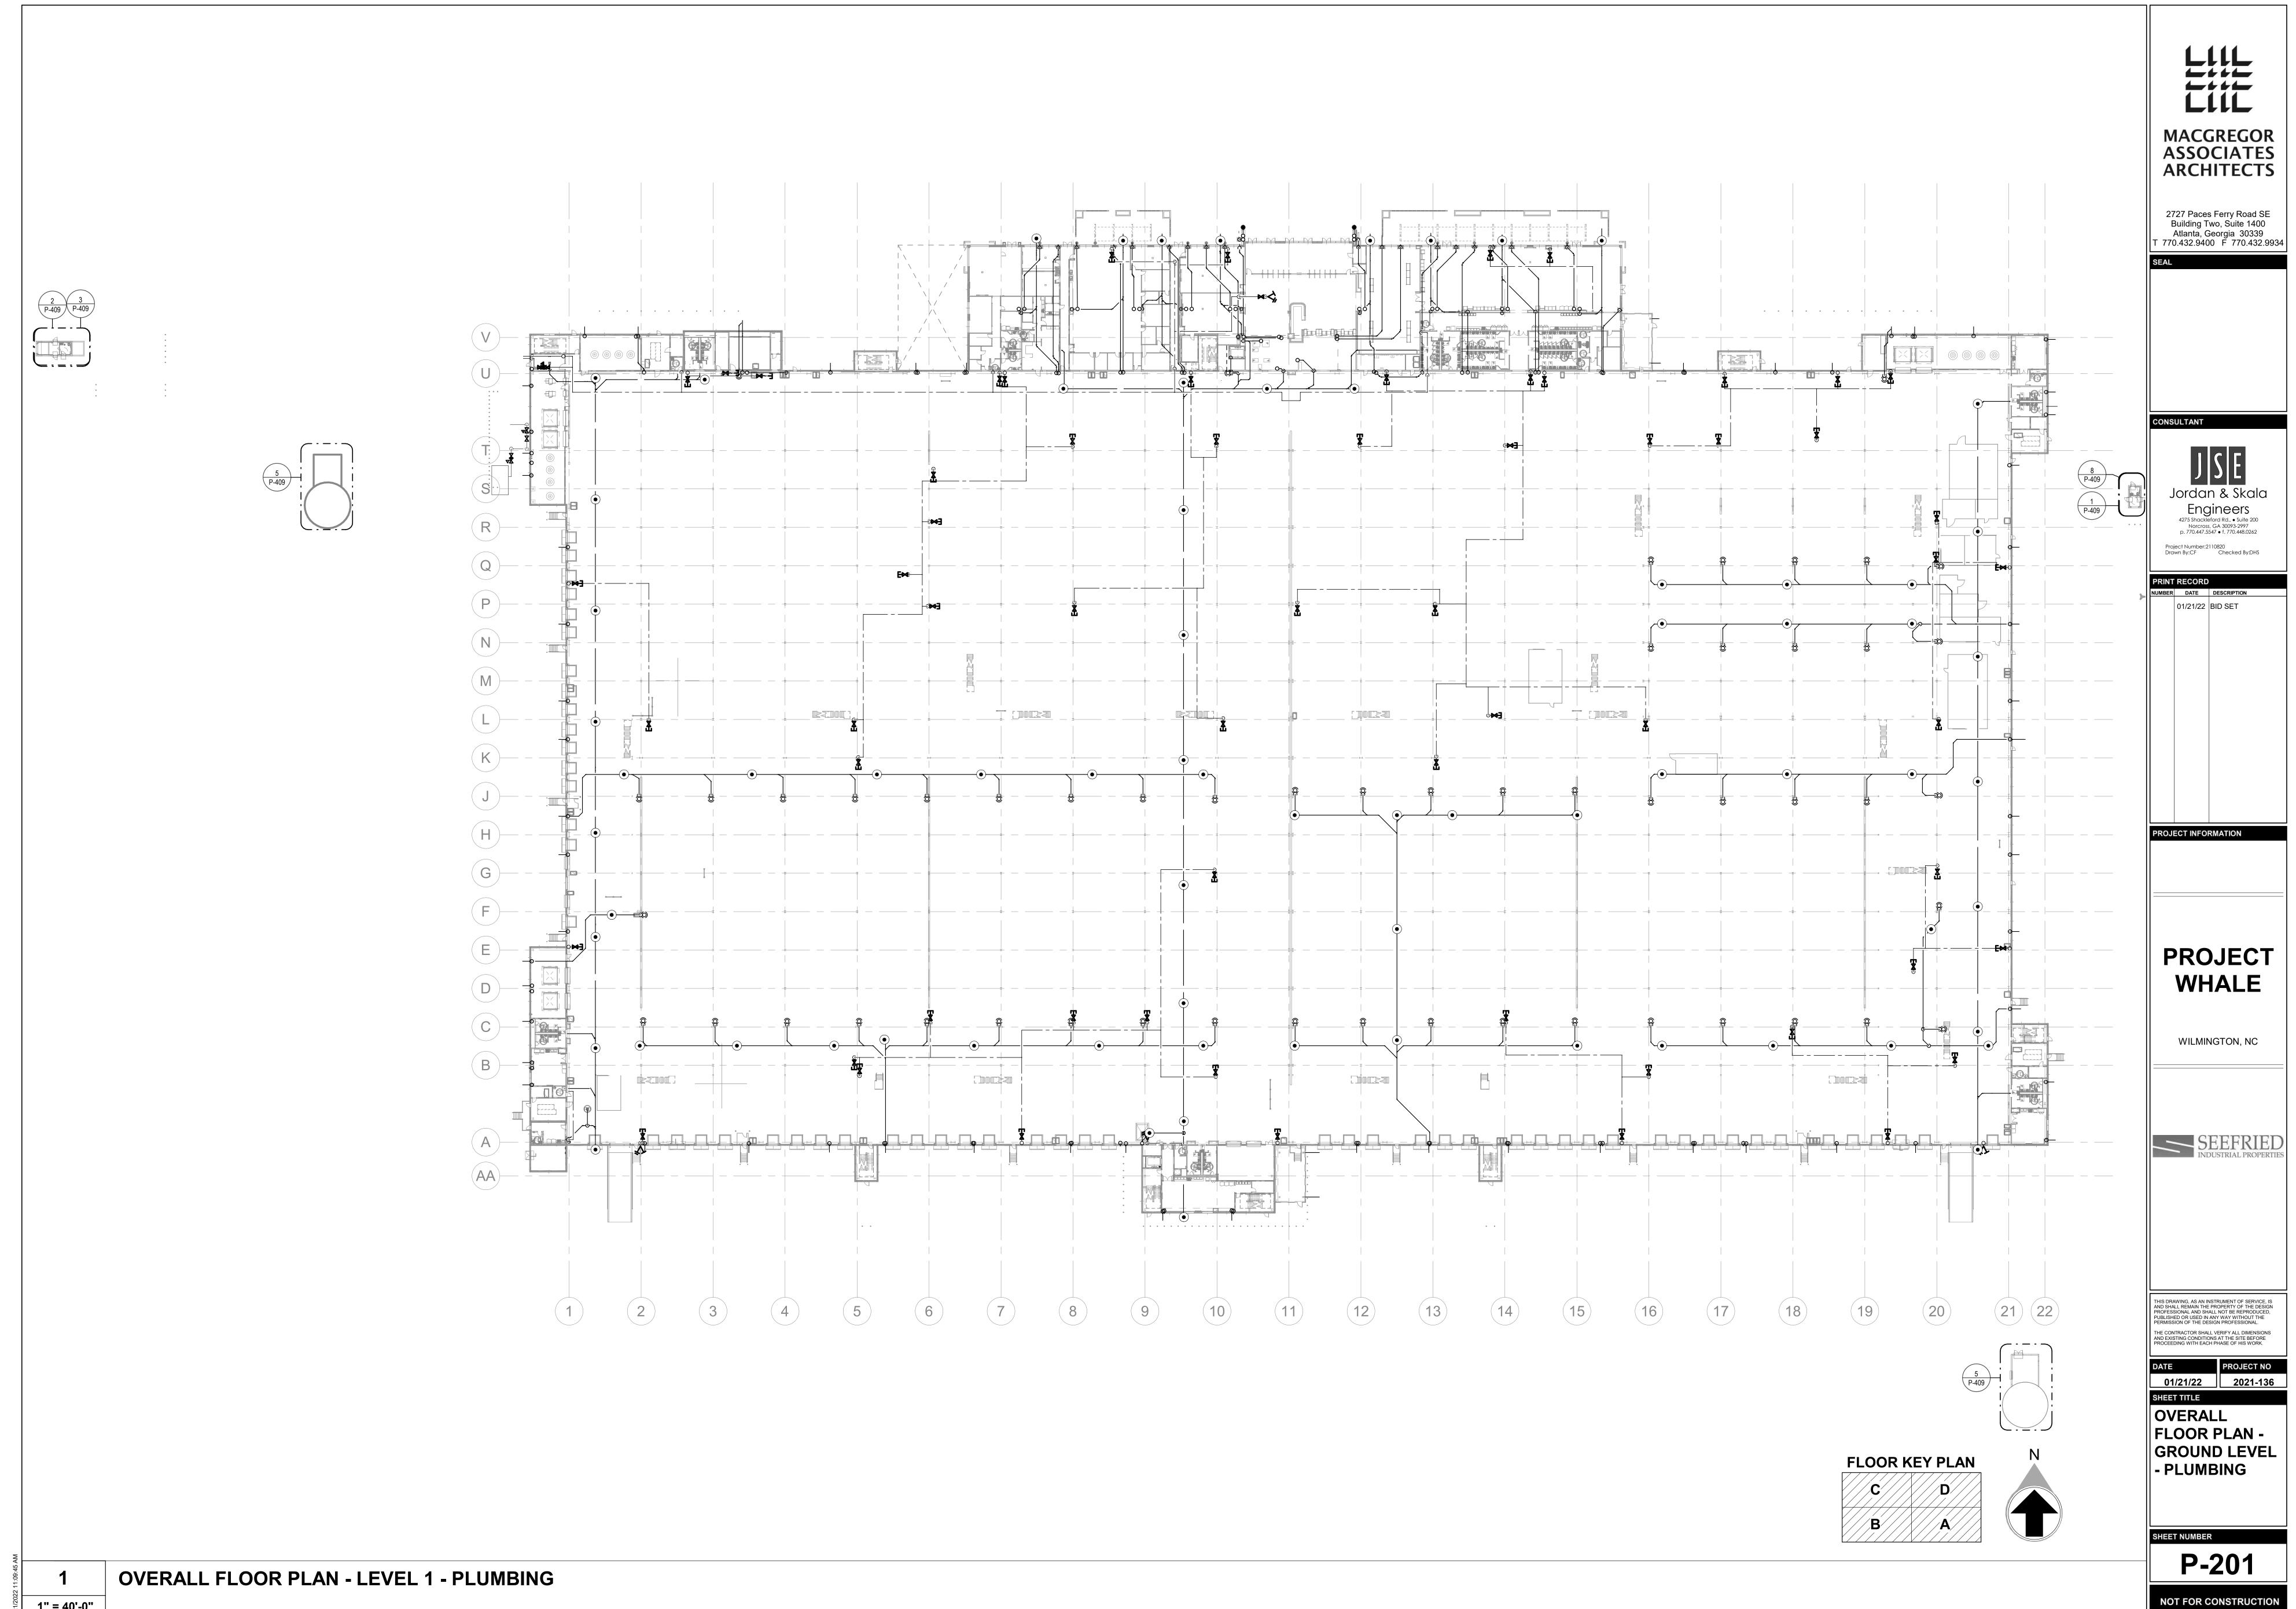

1" = 40'-0"

PIPE B/F-COORDINATE WITH MECHANICAL.(TYP.) 2"HD-----2"HD-----2"HD----−8"RL UP /--I.E.=3'-8" BFF. 2"HD FOR CONDENSATE FROM ACS, COORDINATE WITH MECHANICAL FOR HUB DRAIN TIED INTO THE STORM \_\_8"ST B/G, SEE CIVIL FOR CONT. SYSTEM, TRAP IS NOT REQUIRED. (TYP.) SEE CIVIL FOR CONT. G 2"HD FOR CONDENSATE FROM ACS, COORDINATE WITH MECHANICAL.
FOR HUB DRAIN TIED INTO THE STORM SYSTEM, TRAP IS NOT REQUIRED. (TYP.)-/--8"RL UP /--I.E.=4'-8" BFF. SEE CIVIL FOR CONT. <u>FCO</u> ( 1-1/2"CW SERVING WCS ON LEVEL 1-2"CW SERVING WCS (7639 SF) 1.E.=7'-8" BFF. COORDINATE WITH MECHANICAL.
FOR HUB DRAIN TIED INTO THE STORM
SYSTEM, TRAP IS NOT REQUIRED. (TYP.)— COORDINATE WITH MECHANICAL. FOR HUB DRAIN TIED INTO THE STORM SYSTEM, TRAP IS NOT REQUIRED. (TYP.) 2"HD-----SEE CIVIL FOR CONT. 2"HD-----ווות הודר **י**דורת חודר 4"ST B/G, <u>r - TINNTITETIZZATĪ</u> SEE CIVIL FOR CONT. THIS WC IS ON MEZZANINE LEVLE-1-1/2"CW SERVING WCS ON LEVEL 1 1-1/2"CW SERVING (250 DFU) WCS ON LEVEL 1-2"CW SERVING WCS-2"CW SERVING WCS-/−4"ST B/G, SEE CIVIL FOR CONT. (5200 SF) W/ SHUT-OFF VALVE IN 1-W130 VERTICAL 10"ST B/G, SEE CIVIL FOR CONT.— ---8"ST B/G, ∣ 10"ST B/G, ∠8"ST B/G, SEE CIVIL FOR CONT. SEE CIVIL FOR CONT. SEE CIVIL FOR CONT. SEE CIVIL FOR CONT. SEE CIVIL FOR CONT.-SEE CIVIL FOR CONT. SEE CIVIL FOR CONT. (AA) SMOKER CANOPY SEE CIVIL FOR CONT. STORAGE 1-W141 DOWNSPOUT, REFER TO SCUPPER DESIGN IS NOT ARCHITECTURAL PLANS. PLUMBING'S SCOPE, REFER (1705 SF)□ TO ARCHITECTURAL ROOF PLANS FOR SCUPPERS(TYP.) DOWNSPOUT NOZZLE SHALL BE INSTALLED AT 18" ABOVE STORM PIPING & ROOF DRAINS ARE SIZED BASED ON 2018 NORTH CAROLINA PLUMBING CODE. (PRIMARY ROOF DRAIN: BASED ON RAINFALL RATE OF 4.5" ONE-HOUR DURATION AND A 100-YEAR RETURN PERIOD; SECONDARY ROOF DRAIN: BASED ON 100-YEAR, 15-MINUTE RAINFALL(8.5"/HOUR). FINISHED GRADE U.O.N. ABOVE GROUND: OFFSET RAIN WATER LEADER AT ROOF 45-DEGREE ANGLE, WHILE MAINTAINING FLOOR CLEAR HEIGHT

KEYNOTES

- PROVIDE 1/2" WATER TAP WITH BALL VALVE AND COPPER MANIFOLD. ROUTE 1/2" COPPER PIPING FROM TAP TO EACH OWNER PROVIDED WATER COOLER. STUB COPPER PIPING 24" ABOVE FLOOR AT WATER COOLER LOCATION. PROVIDE 1/2" X 3/8" ANGLE STOP SUPPLY VALVE. ALL LOCATIONS TO BE REVIEWED BY TENANT PRIOR TO INSTALLATION.
- REVIEWED BY TENANT PRIOR TO INSTALLATION.

  PROVIDE LONGITUDINAL AND TRANSVERSE BRACING. SEE DETAILS ON P-003.

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Project Number:2110820
Drawn By:CF Checked By:DHS

PRINT RECORD

NUMBER DATE DESCRIPTION

01/21/22 BID SET

PROJECT INFORMATION

PROJECT WHALE

WILMINGTON, NC

SEEFRIED INDUSTRIAL PROPERTIES

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THE CONTRACTOR SHALL VERIFY ALL DIMENSIONS

DATE

01/21/22

PROJECT NO

2021-136

SHEET TITLE

PARTIAL FLOOR PLAN -GROUND LEVEL A - PLUMBING


SHEET NUMBER

FLOOR KEY PLAN

P-202

1 PARTIAL GROUND FLOOR - A - PLUMBING

1" = 20'-0"

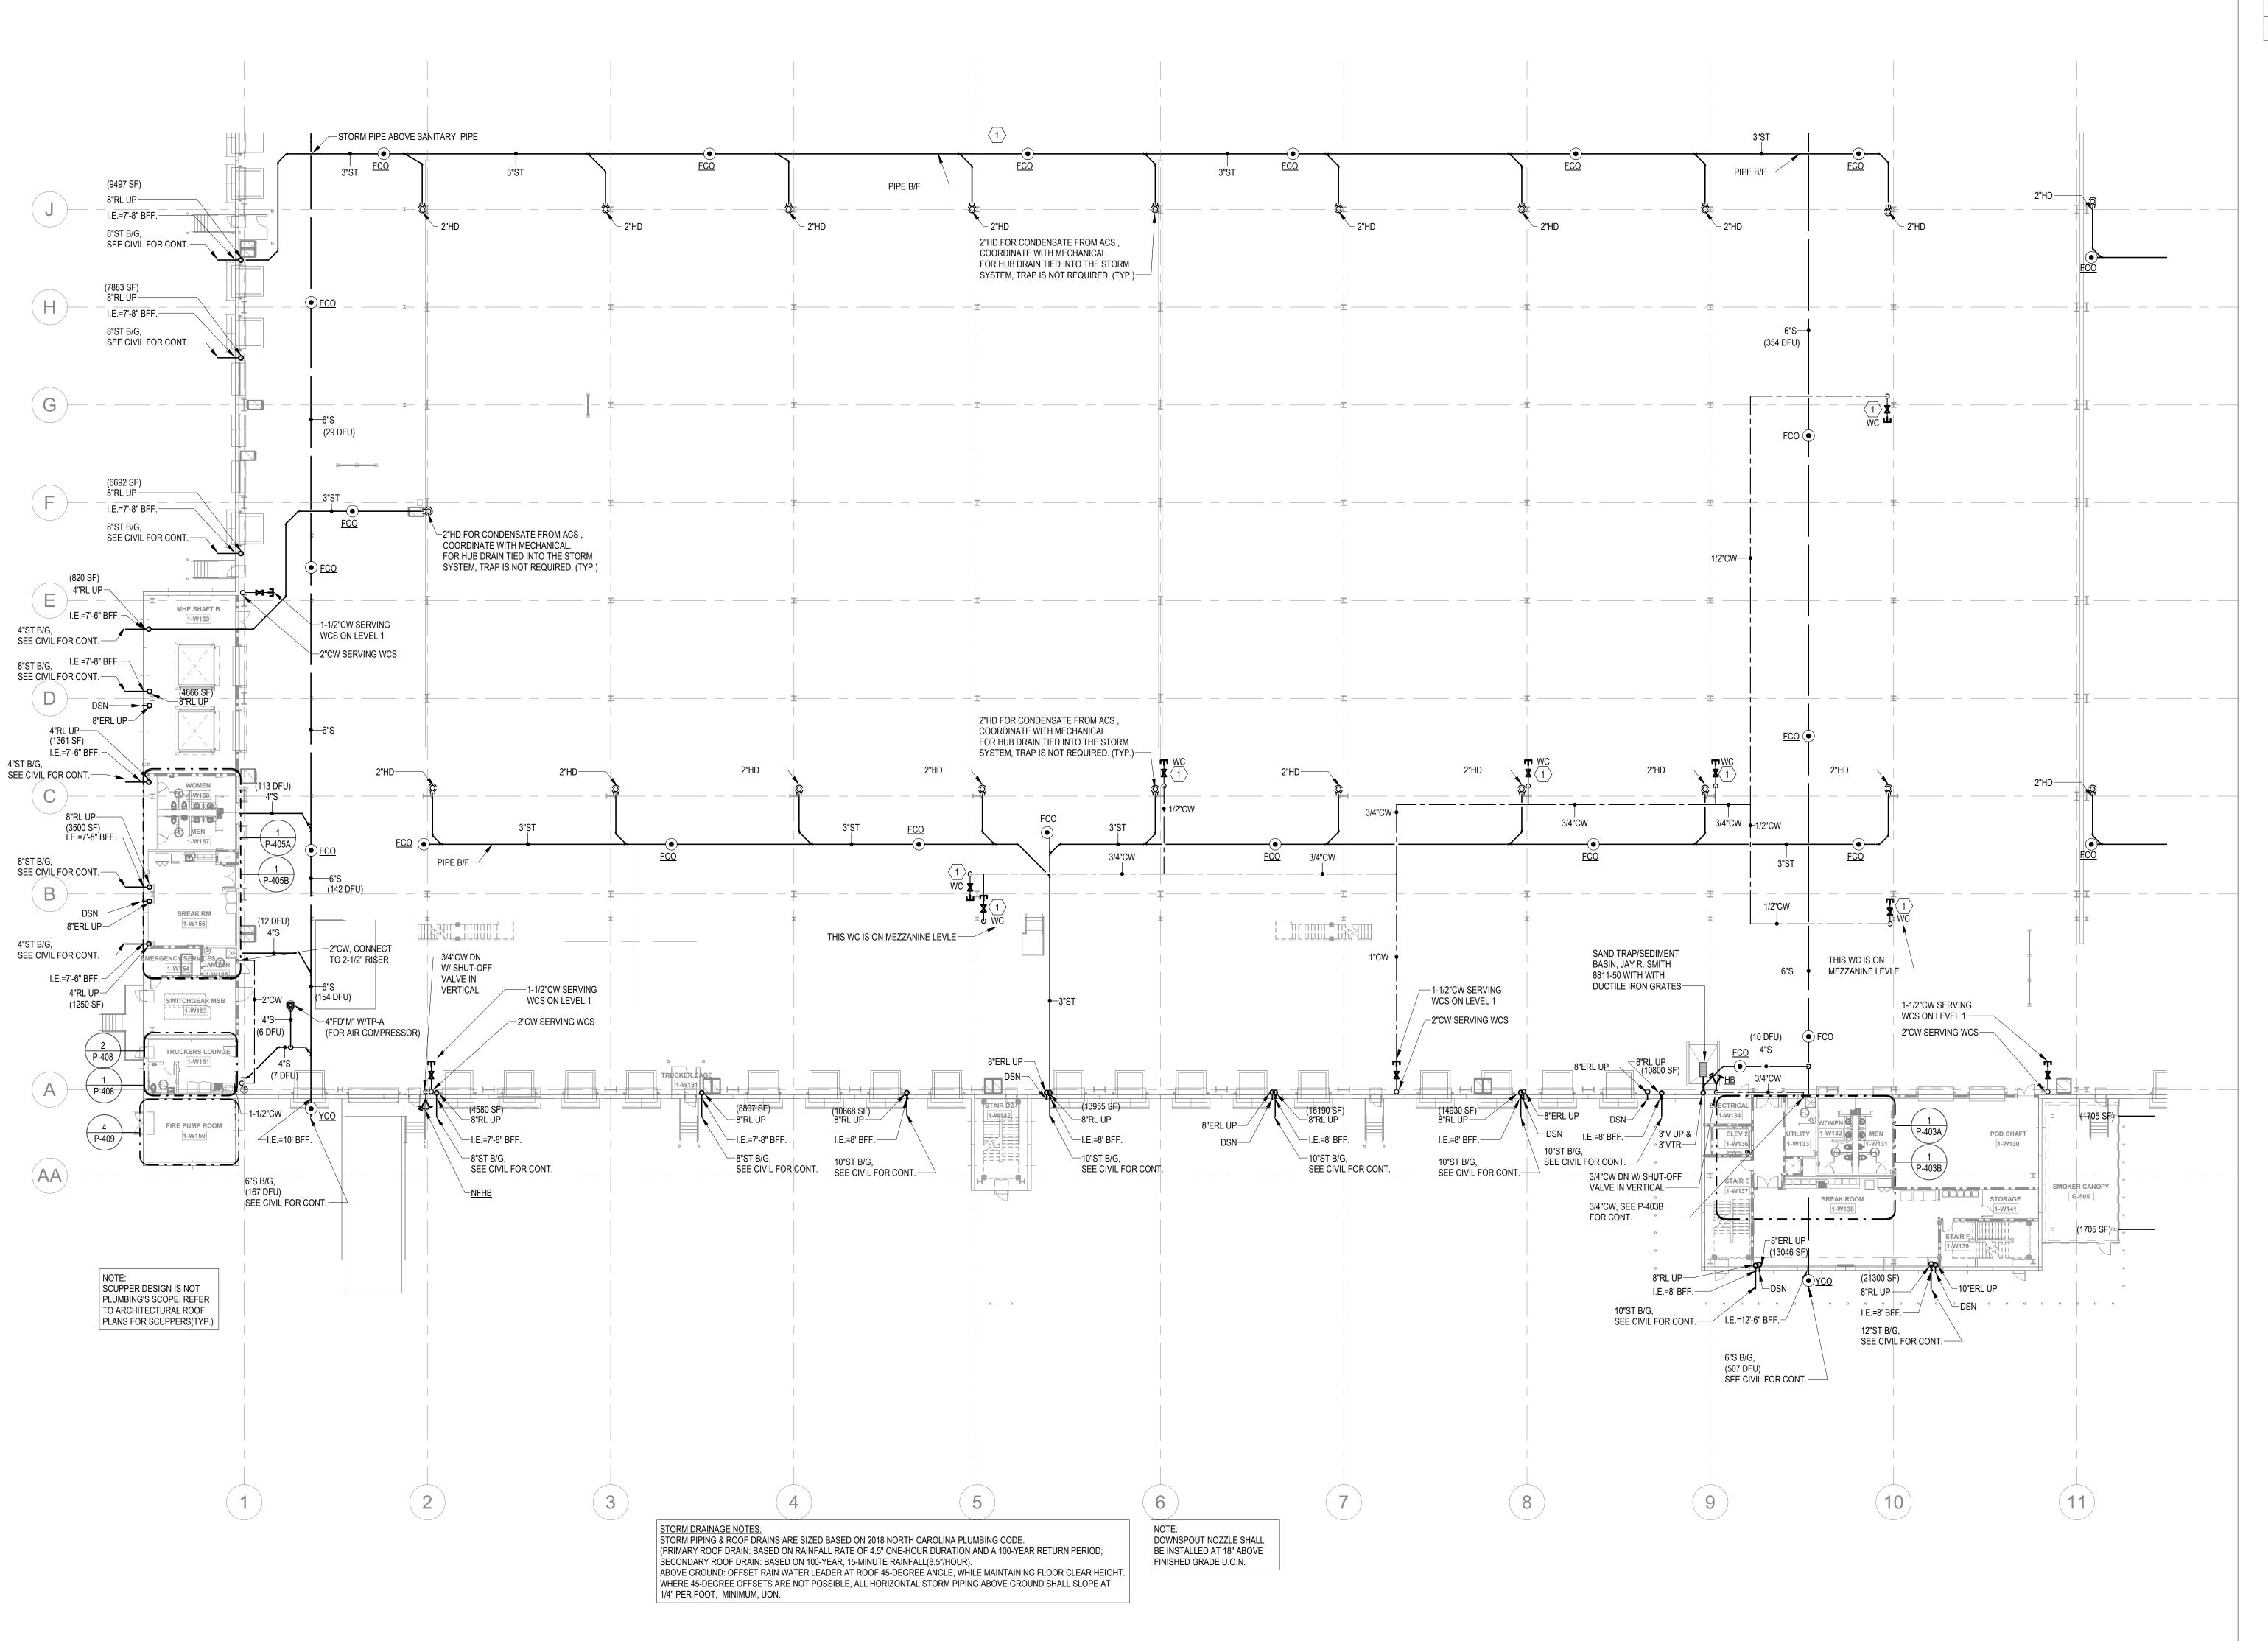

- PROVIDE 1/2" WATER TAP WITH BALL VALVE AND COPPER MANIFOLD. ROUTE 1/2" COPPER PIPING FROM TAP TO EACH OWNER PROVIDED WATER COOLER. STUB COPPER PIPING 24" ABOVE FLOOR AT WATER COOLER LOCATION. PROVIDE 1/2" X 3/8" ANGLE STOP SUPPLY VALVE. ALL LOCATIONS TO BE REVIEWED BY TENANT PRIOR TO INSTALLATION.
- PROVIDE LONGITUDINAL AND TRANSVERSE BRACING. SEE DETAILS ON P-003.

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PROJECT INFORMATION

**PROJECT WHALE** 

WILMINGTON, NC

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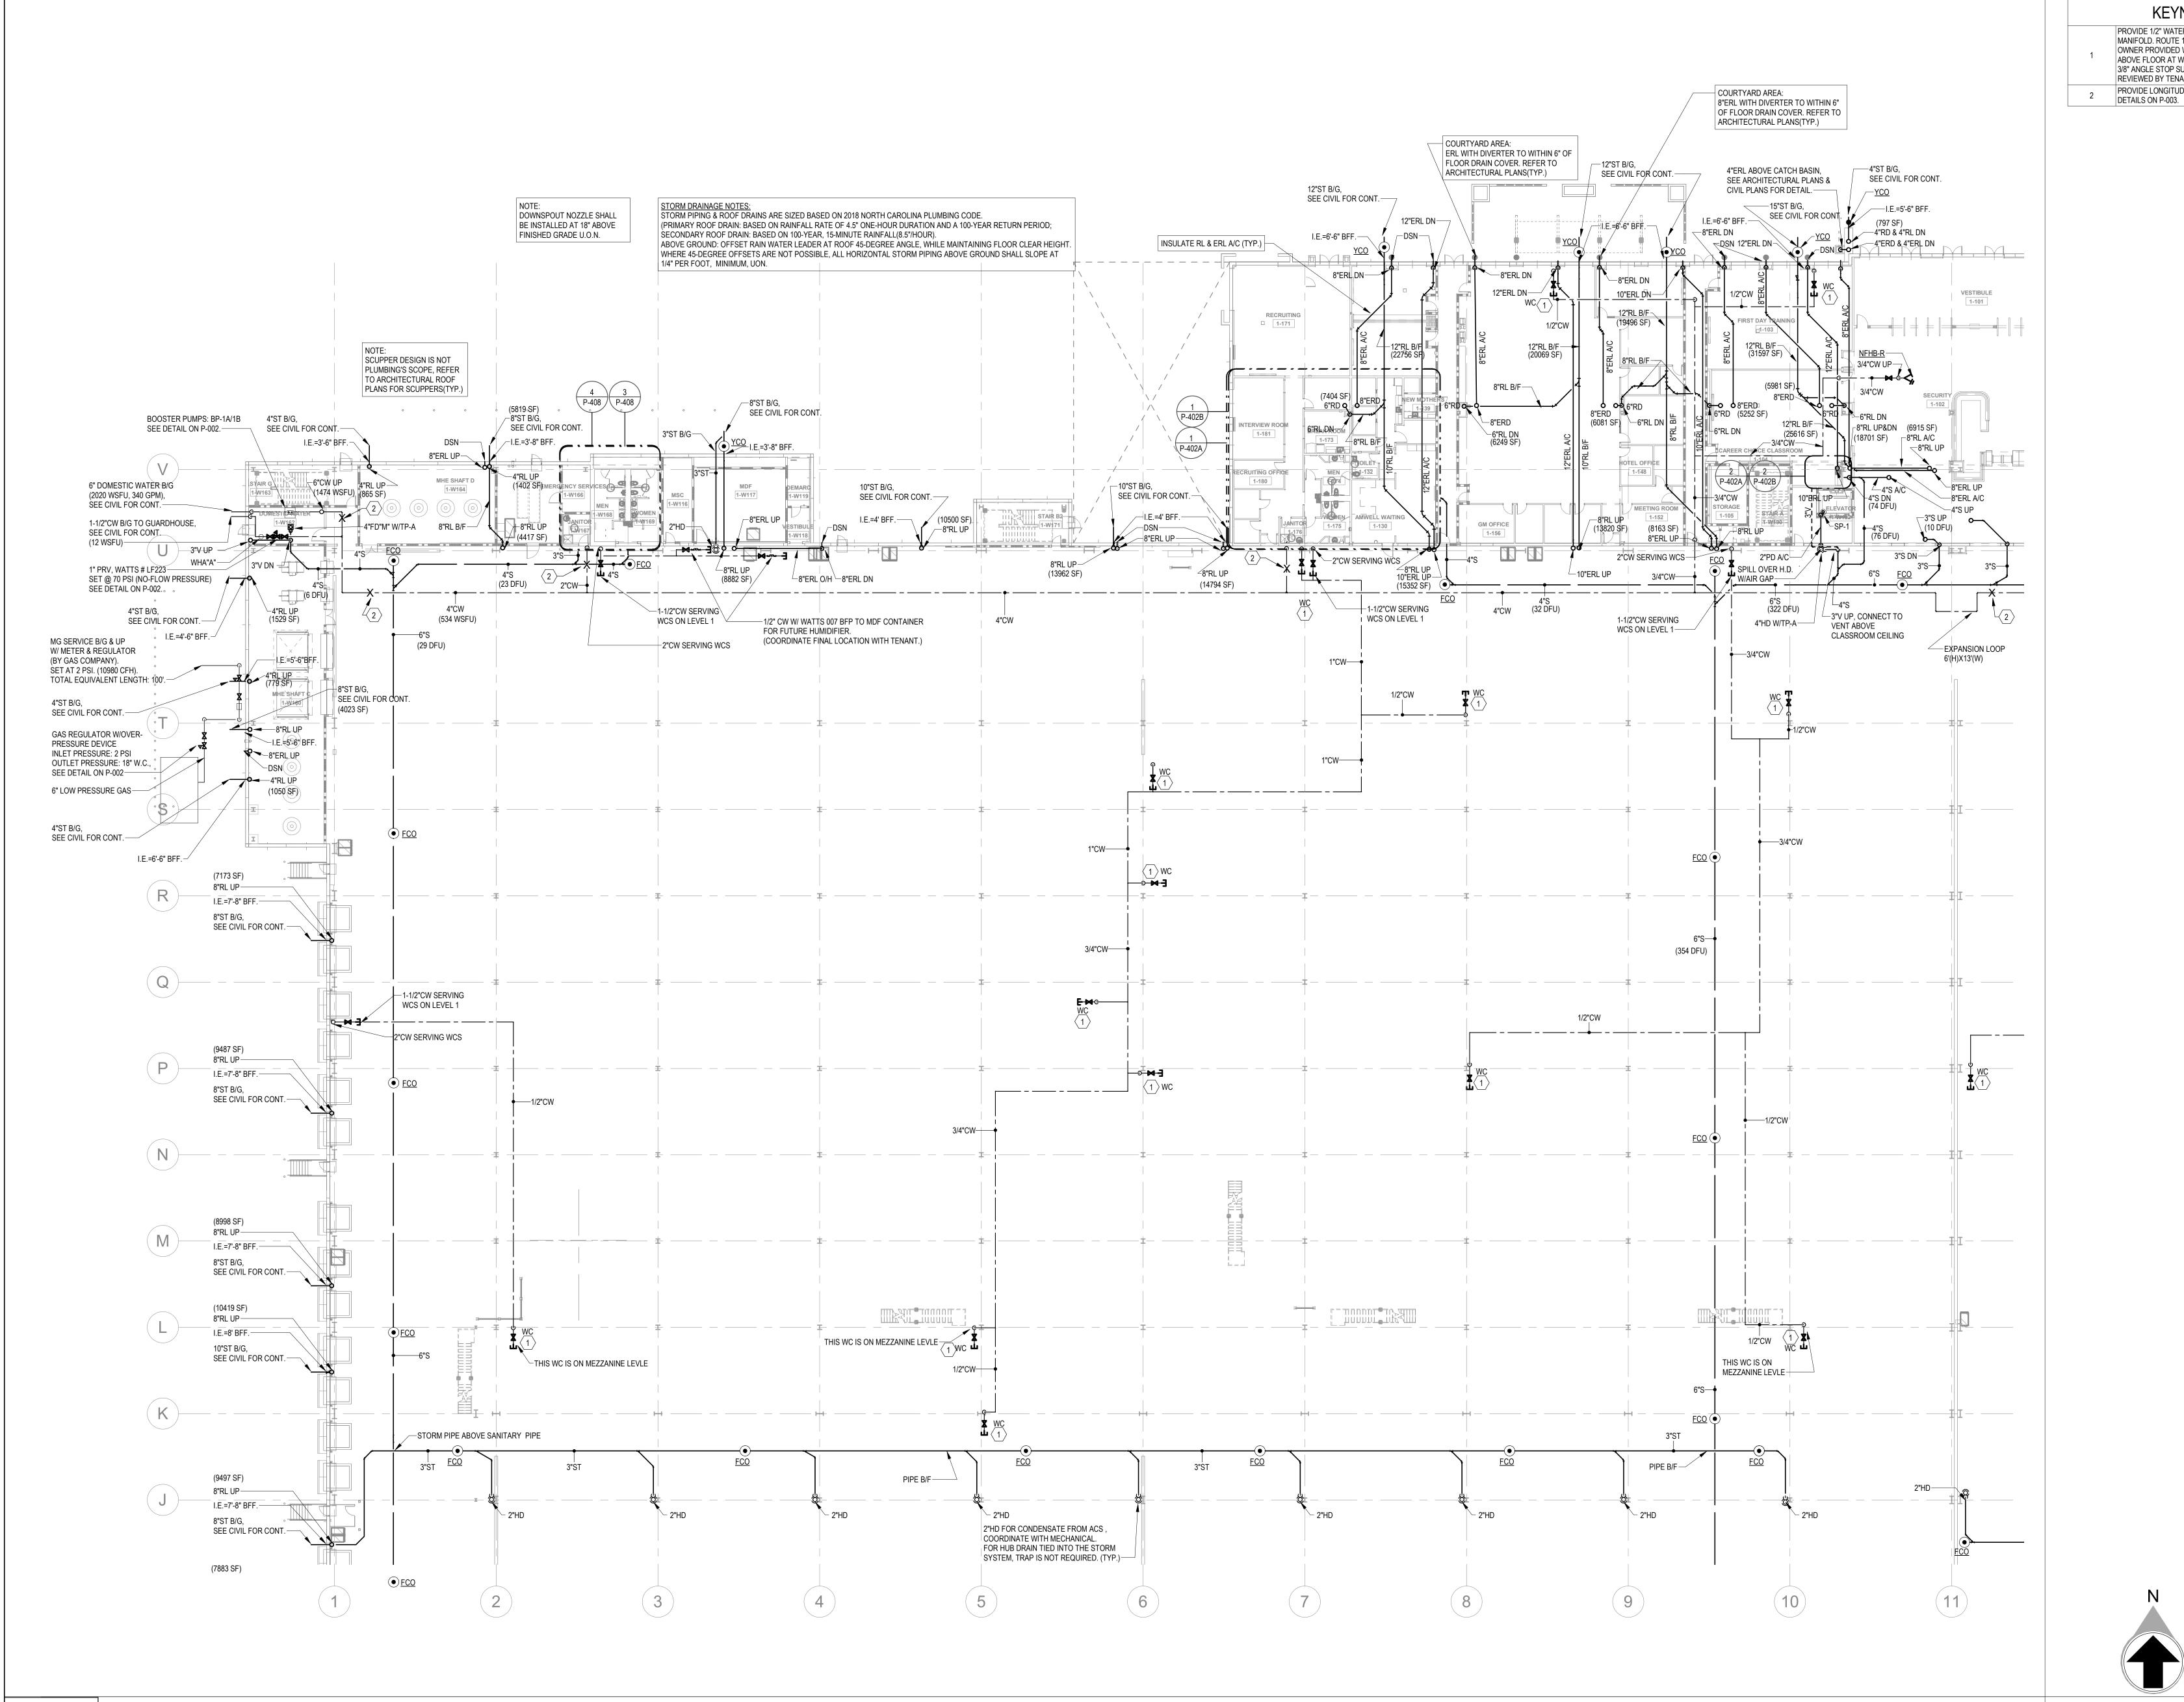
DATE PROJECT NO 2021-136 SHEET TITLE PARTIAL FLOOR PLAN -GROUND LEVEL

B - PLUMBING

SHEET NUMBER

FLOOR KEY PLAN

P-203



REYNOTES

PROVIDE 1/2" WATER TAP WITH BALL VALVE AND COPPER MANIFOLD. ROUTE 1/2" COPPER PIPING FROM TAP TO EACH OWNER PROVIDED WATER COOLER. STUB COPPER PIPING 24" ABOVE FLOOR AT WATER COOLER LOCATION. PROVIDE 1/2" X 3/8" ANGLE STOP SUPPLY VALVE. ALL LOCATIONS TO BE REVIEWED BY TENANT PRIOR TO INSTALLATION.

PROVIDE LONGITUDINAL AND TRANSVERSE BRACING. SEE DETAILS ON P-003.

MACGREG ASSOCIAT

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Project Number:2110820 Drawn By:CF Checked By:DHS

PRINT RECORD

NUMBER DATE DESCRIPTION

01/21/22 BID SET

PROJECT INFORMATION

PROJECT WHALE

WILMINGTON, NC

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DATE PROJECT NO

01/21/22 2021-136

SHEET TITLE

PARTIAL

FLOOR PLAN -

FLOOR PLAN -GROUND LEVEL C - PLUMBING

SHEET NUMBER

FLOOR KEY PLAN

P-204

PROVIDE 1/2" WATER TAP WITH BALL VALVE AND COPPER MANIFOLD. ROUTE 1/2" COPPER PIPING FROM TAP TO EACH OWNER PROVIDED WATER COOLER. STUB COPPER PIPING 24" ABOVE FLOOR AT WATER COOLER LOCATION. PROVIDE 1/2" X 3/8" ANGLE STOP SUPPLY VALVE. ALL LOCATIONS TO BE REVIEWED BY TENANT PRIOR TO INSTALLATION. PROVIDE LONGITUDINAL AND TRANSVERSE BRACING. SEE DETAILS ON P-003. /-- ERL ABOVE CATCH BASIN, SEE ARCHITECTURAL PLANS & COURTYARD AREA: CIVIL PLANS FOR DETAIL. ERL WITH DIVERTER TO WITHIN 6" OF INSULATE RL & ERL A/C FLOOR DRAIN COVER. REFER TO SEE CIVIL FOR CONT. SEE CIVIL FOR CONT. ARCHITECTURAL PLANS(TYP.) SEE CIVIL FOR CONT. SEE CIVIL FOR CONT.-<u>—YCO</u> \_I.E.=6'-6" BFF. −10"ST B/G, /---I.E.=5'-6" BFF. I.E.=5'-6" BFF.— SEE CIVIL FOR CONT. (797 SF) SEE CIVIL FOR CONT. ┌12"ERL DN ← 12"ERL DN —4"RD & 4"RL DN (797 SF) 4"RD & 4"RL DN —I.E.=6'-6" BFF. 4"ERD & 4"ERL DN 8"ERL DN-... /─10"ERL DN **STORM DRAINAGE NOTE\$:** DOWNSPOUT NOZZLE SHALL STORM PIPING & ROOF DRAINS ARE SIZED BASED ON 2018 NORTH CAROLINA PLUMBING CODE. 4"ERD & 4"ERL DN-(PRIMARY ROOF DRAIN: BASED ON RAINFALL RATE OF 4.5" ONE-HOUR DURATION AND A 100-YEAR RETURN PERIOD; BE INSTALLED AT 18" ABOVE SECONDARY ROOF DRAIN: BASED ON 100-YEAR, 15-MINUTE RAINFALL(8.5"/HOUR). FINISHED GRADE U.O.N. 10"ERL DN-12"RL B/F-ABOVE GROUND: OFFSET RAIN WATER LEADER AT ROOF 45-DEGREE ANGLE, WHILE MAINTAINING FLOOR CLEAR HEIGHT (23327 SF) WHERE 45-DEGREE OFFSETS ARE NOT POSSIBLE, ALL HORIZONTAL STORM PIPING ABOVE GROUND SHALL SLOPE AT 1/4" PER FOOT, MINIMUM, UON. ∠8"ERL DN (20702 SF) NFHB-R 3/4"CW UP NOTE: SCUPPER DESIGN IS NOT PLUMBING'S SCOPE, REFER 10"ERD (9202 SF) 12"RL B/F TO ARCHITECTURAL ROOF (26647 SF) OCKERS PLANS FOR SCUPPERS(TYP.) 6"RD Q 4"\$T B/G, ∘ ∘ ∘ √\_8"S₹ B/G, 6"RL DN 6"RL DN SEE CIVIL FOR CONT SEE CIVIL FOR CONT. SEE CIVIL FOR CONT. 8"RL B/F-┌8"RL UP&DN (6915 SF) I.E.=4' BFF.-/--I.E.=4' BFF. /--I.E.=3'-6" BFF. SEE CIVIL FOR CONT. 3"\$T B/G-(10298 SF) 8"RL-A/C ∕—4"RL UP \_\_4"ST В/G, DOWNSPOUT, REFER TO SEE CIVIL FOR CONT. ARCHITECTURAL PLANS. 10"ERL A/C <sup>∠</sup>10"ERL UP SEE CIVIL FOR CONT. SEE CIVIL FOR CONT. 1-W109 SEE CIVIL FOR CONT. —I.E.=4' BFF. (16 DFU) \_\_10"ERL UP (76 DFU) /─4"RL UP 3"S DN-/—I.E.=4' BFF. 10"ERL UP---/ <sup>∟</sup>8"RL UP 10"ERL UP ┌─4"ST B/G, (15182 SF) SEE CIVIL FOR CONT. FCO (17445 SF) WC 2 1/2"CW -2"CW SERVING WCS \_\_\_2"CW B/G TO 1"CW -1-1/2"CW SERVING SECONDARY GUARDHOUSE, WCS ON LEVEL 4 -1-1/2"CW SERVING TOTOLU T WCS ON LEVEL 1 SEE CIVIL FOR CONT. (12 WSFU) STARTING IE=3'-6" BFF--EXPANSION LOOP 6'(H)X13'(W) 1-W115 SEE CIVIL FOR CONT. 1"CW----1 WC 4"KL UF (814 SF) 8"ST B/G, SEE CIVIL FOR CONT. ─I.E.=3'-8" BFF. ─8"RL UP COORDINATE WITH MECHANICAL. SEE CIVIL FOR CONT. FOR HUB DRAIN TIED INTO THE STORM SYSTEM, TRAP IS NOT REQUIRED. (TYP.) WC 1 1-1/2"CW SERVING WCS ON LEVEL 1 2"CW SERVING WCS SEE CIVIL FOR CONT. −8"RL UP 1/2"CW-----~8"RL UP <sup>°</sup> 3/4"CW SEE CIVIL FOR CONT. THIS WC IS ON MEZZANINE LEVLE -10"ST B/G, SEE CIVIL FOR CONT. /-2"HD AND CONNECT TO CONDENSATE FROM ACS ,
COORDINATE WITH MECHANICAL.(TYP.) FCO 🕏 3"ST 2"HD----−8"RL UP ─I.E.=3'-8" BFF. PIPE B/F-PIPE B/F-2"HD FOR CONDENSATE FROM ACS, COORDINATE WITH MECHANICAL. FOR HUB DRAIN TIED INTO THE STORM SYSTEM, TRAP IS NOT REQUIRED. (TYP.) `– 2"HD `− 2"HD 8"ST B/G, SEE CIVIL FOR CONT. **FLOOR KEY PLAN** 16 (19) (22) (11) (13) (15) (18) (20) (21)

LILL
LILL
MACGREGOR
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KEYNOTES

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Project Number:2110820 Drawn By:CF Checked By:DHS

PRINT RECORD

NUMBER DATE DESCRIPTION

01/21/22 BID SET

PROJECT INFORMATION

PROJECT WHALE

WILMINGTON, NC

SEEFRIED INDUSTRIAL PROPERTIES

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DATE

01/21/22

PROJECT NO

2021-136

SHEET TITLE

PARTIAL

FLOOR PLAN 
GROUND LEVEL

D - PLUMBING


SHEET NUMBER


P-205

NOT FOR CONSTRUCTION

1 PARTIAL GROUND FLOOR - D - PLUMBING

1" = 20'-0"

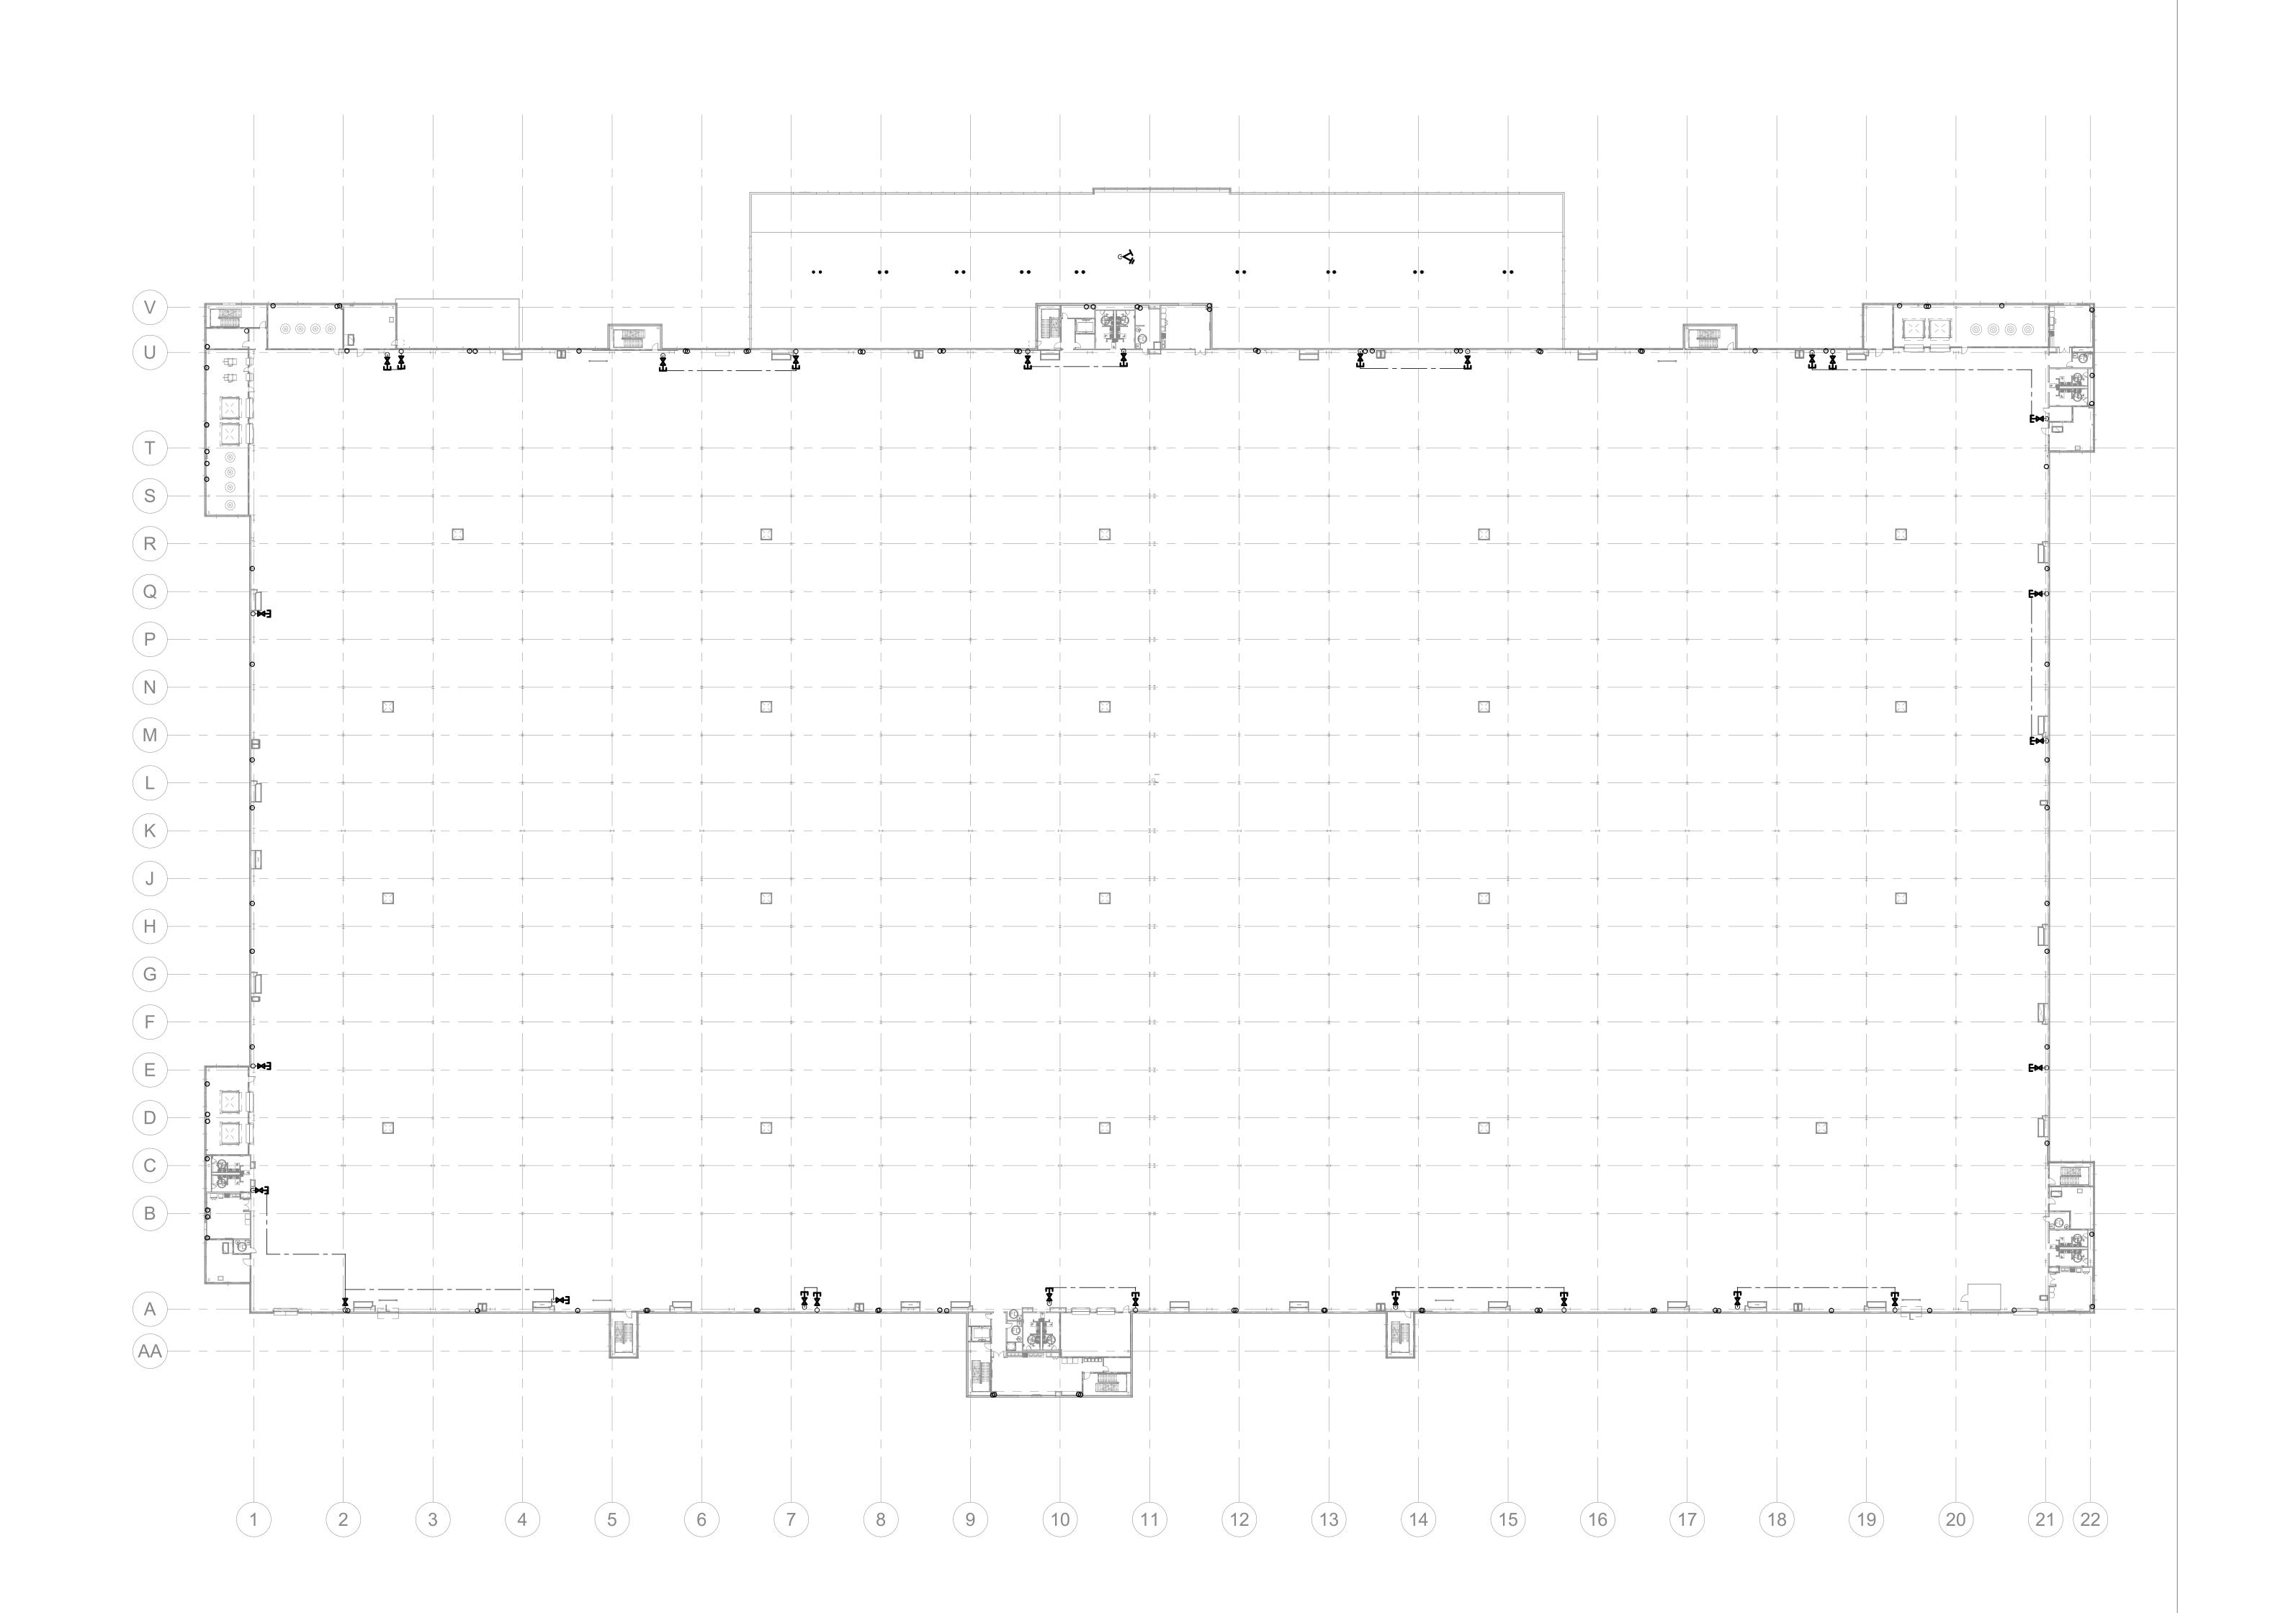

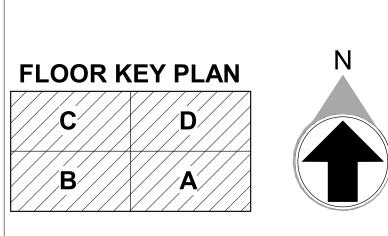



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PROJECT

WHALE

WILMINGTON, NC

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DATE

01/21/22

PROJECT NO
2021-136

SHEET TITLE

OVERALL

FLOOR PLAN LEVEL 2 PLUMBING

SHEET NUMBER

D\_206

P-206

──8"RL UP ─8"RL UP ─8"RL UP 1-1/2"CW SERVING WCS ON LEVEL 2 2"CW SERVING WCS-—1-1/2"CW SERVING WCS ON LEVEL 2 \_\_\_\_\_\_ \_\_2"CW SERVING WCS 2"CW SERVING WCS-----10"ERL UP POD SHAFT 2-W230 FLOOR KEY PLAN

- PROVIDE 1/2" WATER TAP WITH BALL VALVE AND COPPER MANIFOLD. ROUTE 1/2" COPPER PIPING FROM TAP TO EACH OWNER PROVIDED WATER COOLER. STUB COPPER PIPING 24" ABOVE FLOOR AT WATER COOLER LOCATION. PROVIDE 1/2" X
- 3/8" ANGLE STOP SUPPLY VALVE. ALL LOCATIONS TO BE REVIEWED BY TENANT PRIOR TO INSTALLATION.

  PROVIDE LONGITUDINAL AND TRANSVERSE BRACING. SEE DETAILS ON P-003.

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01/21/22 BID SET

PROJECT INFORMATION

**PROJECT** WHALE

WILMINGTON, NC


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DATE PROJECT NO 2021-136 SHEET TITLE PARTIAL FLOOR PLAN -LEVEL 2 A -

PLUMBING

SHEET NUMBER

P-207

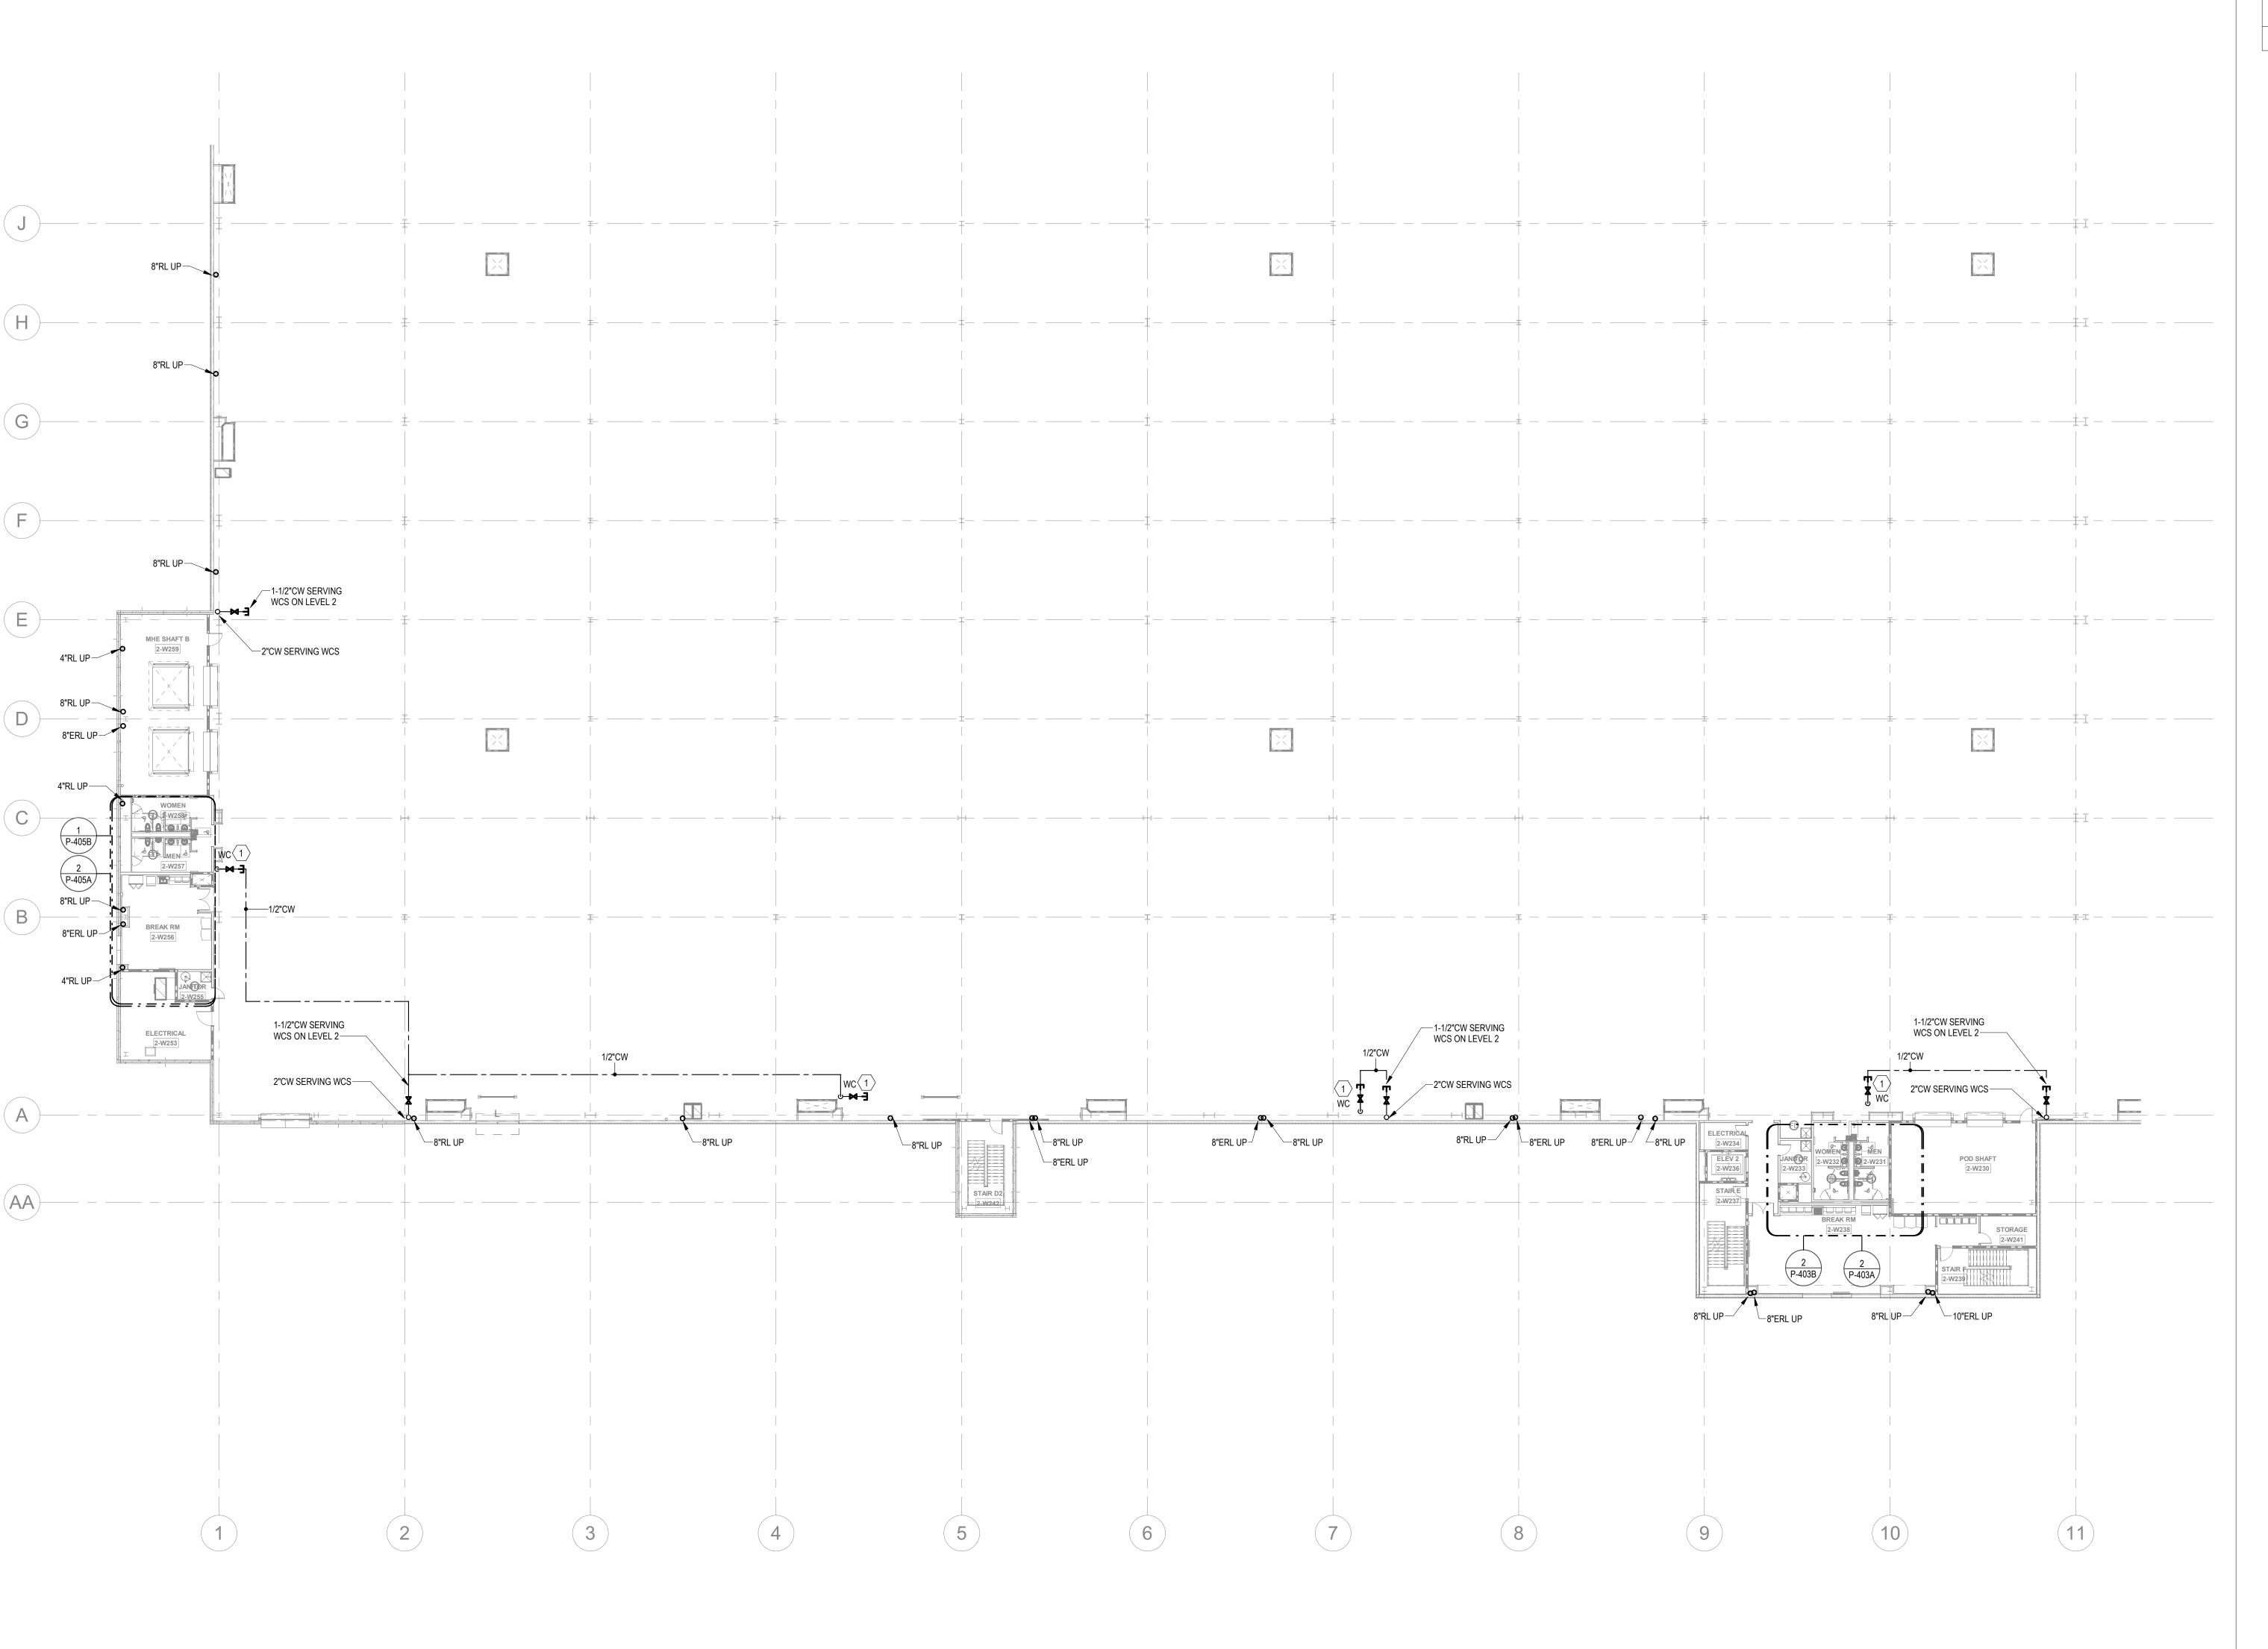

KEYNOTE

- PROVIDE 1/2" WATER TAP WITH BALL VALVE AND COPPER MANIFOLD. ROUTE 1/2" COPPER PIPING FROM TAP TO EACH OWNER PROVIDED WATER COOLER. STUB COPPER PIPING 24" ABOVE FLOOR AT WATER COOLER LOCATION. PROVIDE 1/2" X 3/8" ANGLE STOP SUPPLY VALVE. ALL LOCATIONS TO BE
- 3/8" ANGLE STOP SUPPLY VALVE. ALL LOCATIONS TO BE REVIEWED BY TENANT PRIOR TO INSTALLATION.

  PROVIDE LONGITUDINAL AND TRANSVERSE BRACING. SEE DETAILS ON P-003.

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PRINT RECORD

NUMBER DATE DESCRIPTION

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PROJECT INFORMATION

PROJECT WHALE

WILMINGTON, NC

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THE CONTROL CONDITIONS AT THE SITE REFORE

DATE PROJECT NO

01/21/22 2021-136

SHEET TITLE

PARTIAL

FLOOR PLAN 
LEVEL 2 B -

PLUMBING

**FLOOR KEY PLAN** 

P-208

NOT FOR CONSTRUCTION

PARTIAL FLOOR PLANS - LEVEL 2 - B - PLUMBING

NFHB-R ──8"RL|UP 8"ERL UP— ∕−4"RL UP MHE SHAFT D 2-W264 BREAK RM 2-W263 2-W265 ∕−8"RL UP 8"RL UP——— 8"ERL UP—— 8"ERL UP 8"ERL UP -2"CW SERVING WCS 1/2"CW --- 1-1/2"CW SERVING WCS ON LEVEL 2 1-1/2"CW SERVING -1-1/2"CW SERVING MHE SHAFT C WCS ON LEVEL 2 WCS ON LEVEL 2 2-W260 8"RL UP-8"ERL UP 1-1/2"CW SERVING WCS ON LEVEL 2 2"CW SERVING WCS 8"RL UP— 8"RL UP-8"RL UP FLOOR KEY PLAN

- PROVIDE 1/2" WATER TAP WITH BALL VALVE AND COPPER MANIFOLD. ROUTE 1/2" COPPER PIPING FROM TAP TO EACH OWNER PROVIDED WATER COOLER. STUB COPPER PIPING 24" ABOVE FLOOR AT WATER COOLER LOCATION. PROVIDE 1/2" X 3/8" ANGLE STOP SUPPLY VALVE. ALL LOCATIONS TO BE REVIEWED BY TENANT PRIOR TO INSTALLATION.
- PROVIDE LONGITUDINAL AND TRANSVERSE BRACING. SEE DETAILS ON P-003.

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Project Number:2110820 Drawn By:CF Checked By:DHS

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**PROJECT WHALE** 

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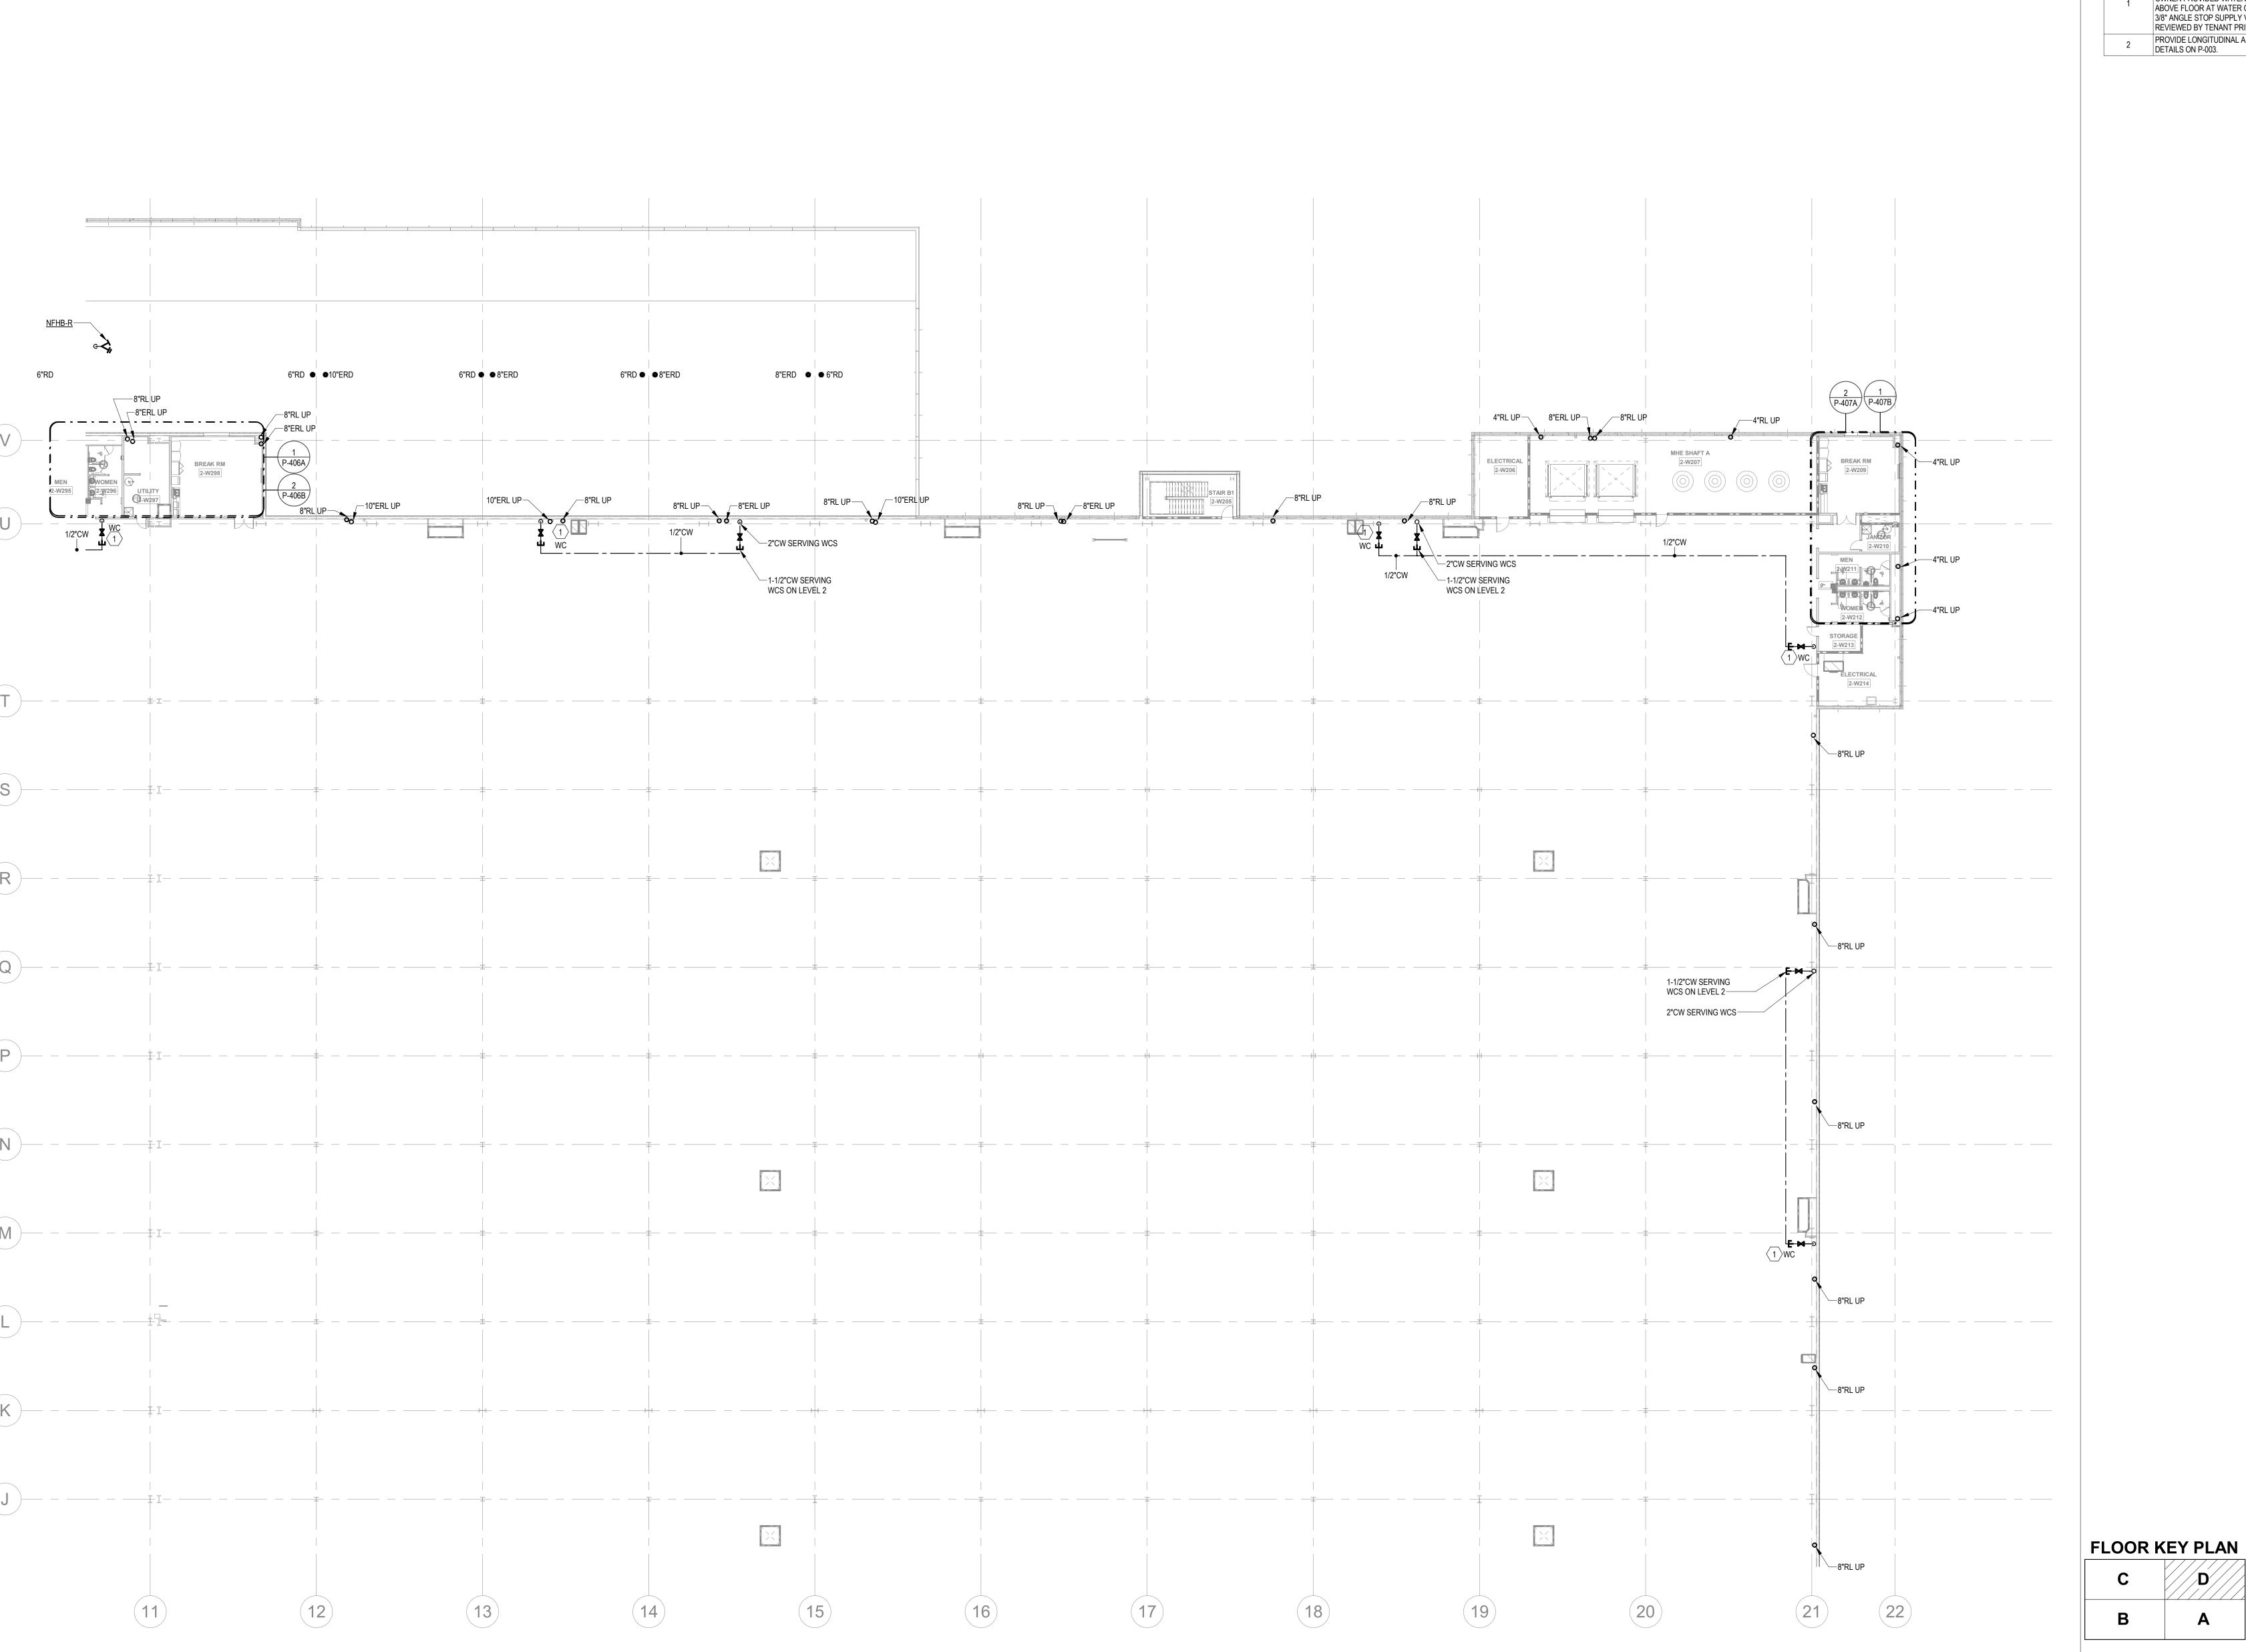
DATE PROJECT NO 2021-136 SHEET TITLE PARTIAL

FLOOR PLAN -LEVEL 2 C -PLUMBING

P-209

NOT FOR CONSTRUCTION

PARTIAL FLOOR PLANS - LEVEL 2 - C - PLUMBING 1" = 20'-0"



PROVIDE 1/2" WATER TAP WITH BALL VALVE AND COPPER MANIFOLD. ROUTE 1/2" COPPER PIPING FROM TAP TO EACH OWNER PROVIDED WATER COOLER. STUB COPPER PIPING 24" ABOVE FLOOR AT WATER COOLER LOCATION. PROVIDE 1/2" X 3/8" ANGLE STOP SUPPLY VALVE. ALL LOCATIONS TO BE REVIEWED BY TENANT PRIOR TO INSTALLATION. PROVIDE LONGITUDINAL AND TRANSVERSE BRACING. SEE DETAILS ON P-003.

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01/21/22 BID SET

PROJECT WHALE

WILMINGTON, NC

DATE PROJECT NO 2021-136 SHEET TITLE PARTIAL FLOOR PLAN -


LEVEL 2 D -PLUMBING


SHEET NUMBER


P-210

PARTIAL FLOOR PLANS - LEVEL 2 - D - PLUMBING

1" = 20'-0"

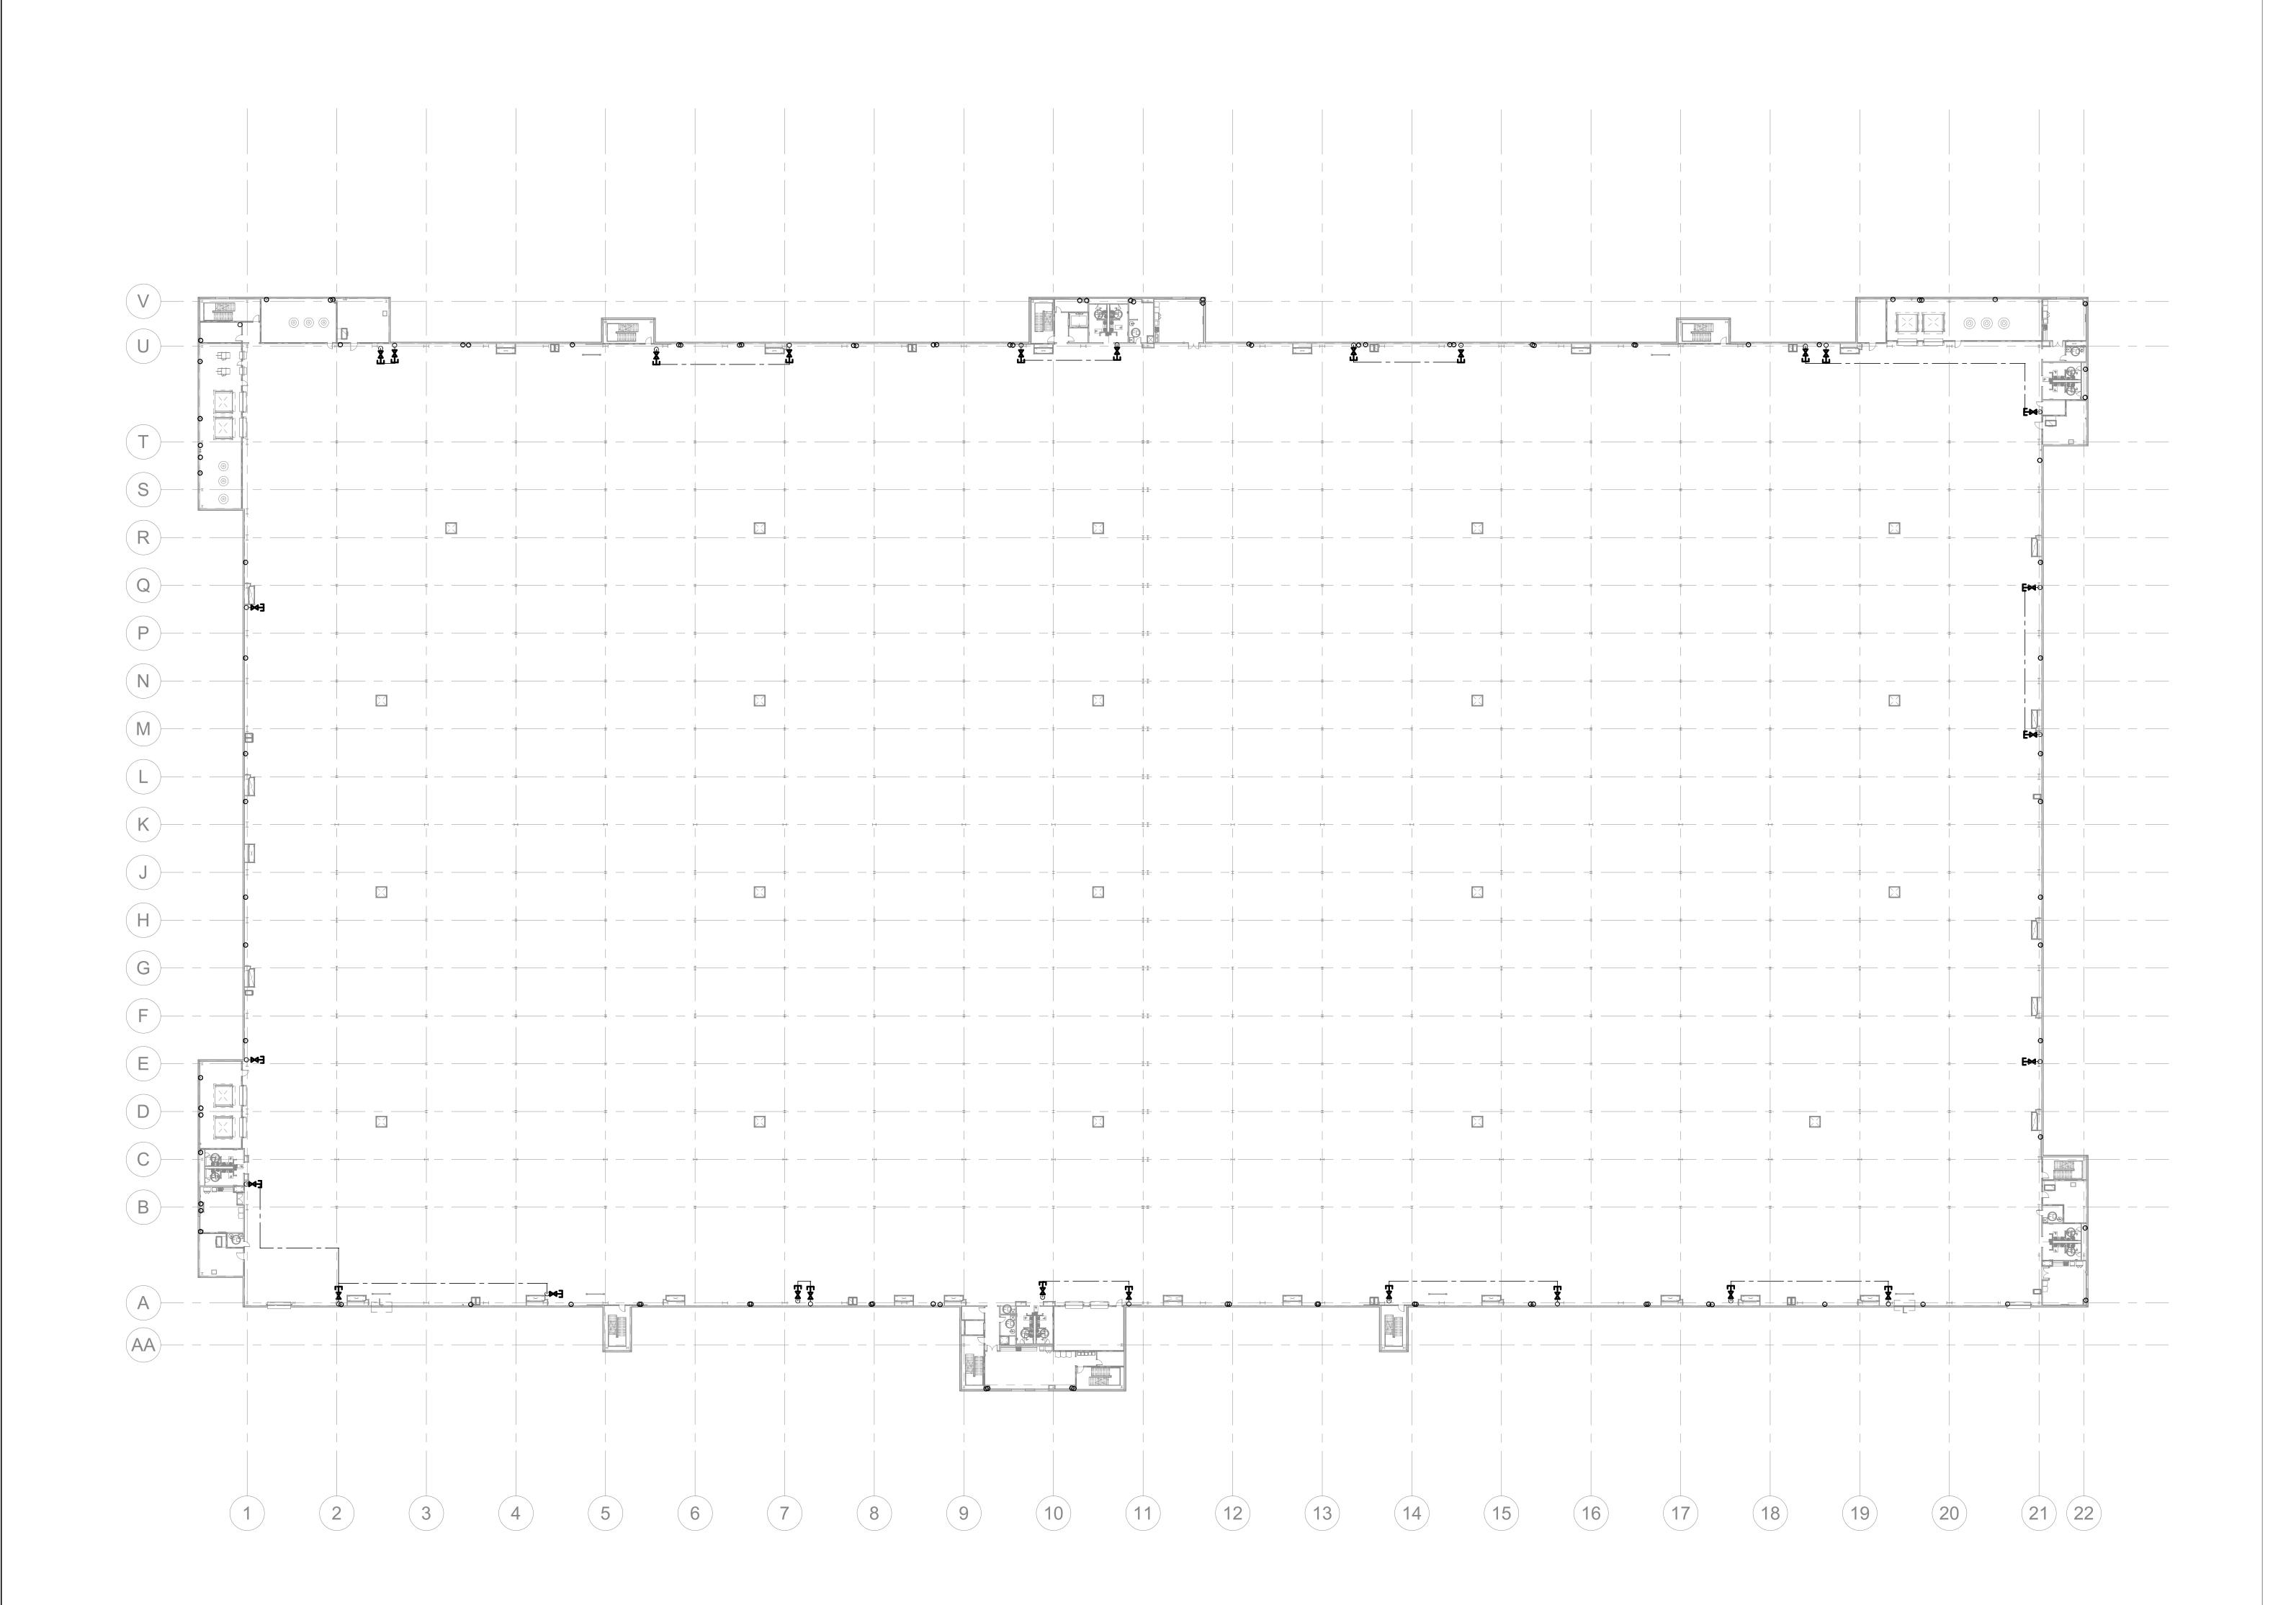

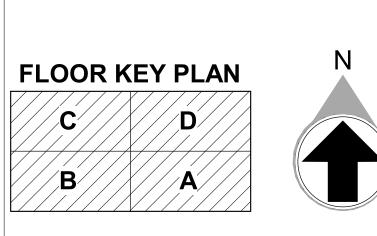

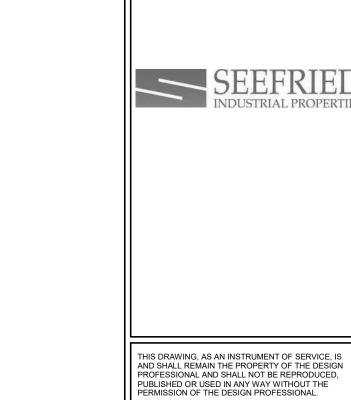

DATE PROJECT NO 2021-136 SHEET TITLE

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**PROJECT** 

**WHALE** 

WILMINGTON, NC

OVERALL FLOOR PLAN -LEVEL 3 -PLUMBING

SHEET NUMBER

P-211

─8"RL UP ─8"RL UP ─8"RL UP 1-1/2"CW SERVING WCS ON LEVEL 3 2"CW SERVING WCS-`—8"RL UP —1-1/2"CW SERVING WCS ON LEVEL 3 1-1/2"CW SERVING WCS ON LEVEL 3 ∠2"CW SERVING WCS 2"CW SERVING WCS-<sup>\</sup>─8"RL UP —10"ERL UP POD SHAFT 3-W330 STORAGE 3-W341 FLOOR KEY PLAN

- PROVIDE 1/2" WATER TAP WITH BALL VALVE AND COPPER MANIFOLD. ROUTE 1/2" COPPER PIPING FROM TAP TO EACH OWNER PROVIDED WATER COOLER. STUB COPPER PIPING 24" ABOVE FLOOR AT WATER COOLER LOCATION. PROVIDE 1/2" X 3/8" ANGLE STOP SUPPLY VALVE. ALL LOCATIONS TO BE REVIEWED BY TENANT PRIOR TO INSTALLATION.
- PROVIDE LONGITUDINAL AND TRANSVERSE BRACING. SEE DETAILS ON P-003.

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**PROJECT WHALE** 

WILMINGTON, NC

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DATE PROJECT NO 2021-136 SHEET TITLE PARTIAL FLOOR PLAN -

LEVEL 3 A -PLUMBING

SHEET NUMBER

P-212

8"RL UP 8"RL UP— 1-1/2"CW SERVING WCS ON LEVEL 3 MHE SHAFT B 2"CW SERVING WCS 1-1/2"CW SERVING WCS ON LEVEL 3—— —1-1/2"CW SERVING WCS ON LEVEL 3 2"CW SERVING WCS-2"CW SERVING WCS-

DETAILS ON P-003.

PROVIDE 1/2" WATER TAP WITH BALL VALVE AND COPPER MANIFOLD. ROUTE 1/2" COPPER PIPING FROM TAP TO EACH OWNER PROVIDED WATER COOLER. STUB COPPER PIPING 24"

ABOVE FLOOR AT WATER COOLER LOCATION. PROVIDE 1/2" X 3/8" ANGLE STOP SUPPLY VALVE. ALL LOCATIONS TO BE REVIEWED BY TENANT PRIOR TO INSTALLATION. PROVIDE LONGITUDINAL AND TRANSVERSE BRACING. SEE

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PROJECT INFORMATION

PROJECT WHALE

WILMINGTON, NC

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DATE PROJECT NO 2021-136 SHEET TITLE PARTIAL FLOOR PLAN -

LEVEL 3 B -PLUMBING

> SHEET NUMBER P-213

──8"RL UP ─8"ERL UP 8"ERL UP-MHE SHAFT D

3-W364 ELECTRICAL 3-W365 STORAGE 3-W362 8"RL UP—— 8"ERL UP— 8"ERL UP 8"ERL UP \_\_8"ERL UP 2"CW SERVING WCS -2"CW SERVING WCS -2"CW SERVING WCS 1/2"CW 1-1/2"CW SERVING WCS ON LEVEL 3 ---1-1/2"CW SERVING WCS ON LEVEL 3 1-1/2"CW SERVING WCS ON LEVEL 3 4"RL UP 8"RL UP 1-1/2"CW SERVING WCS ON LEVEL 3 8"RL UP— 8"RL UP-8"RL UP FLOOR KEY PLAN 11

**KEYNOTES** 

PROVIDE 1/2" WATER TAP WITH BALL VALVE AND COPPER MANIFOLD. ROUTE 1/2" COPPER PIPING FROM TAP TO EACH OWNER PROVIDED WATER COOLER. STUB COPPER PIPING 24" ABOVE FLOOR AT WATER COOLER LOCATION. PROVIDE 1/2" X 3/8" ANGLE STOP SUPPLY VALVE. ALL LOCATIONS TO BE REVIEWED BY TENANT PRIOR TO INSTALLATION.

PROVIDE LONGITUDINAL AND TRANSVERSE BRACING. SEE DETAILS ON P-003.

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PROJECT WHALE

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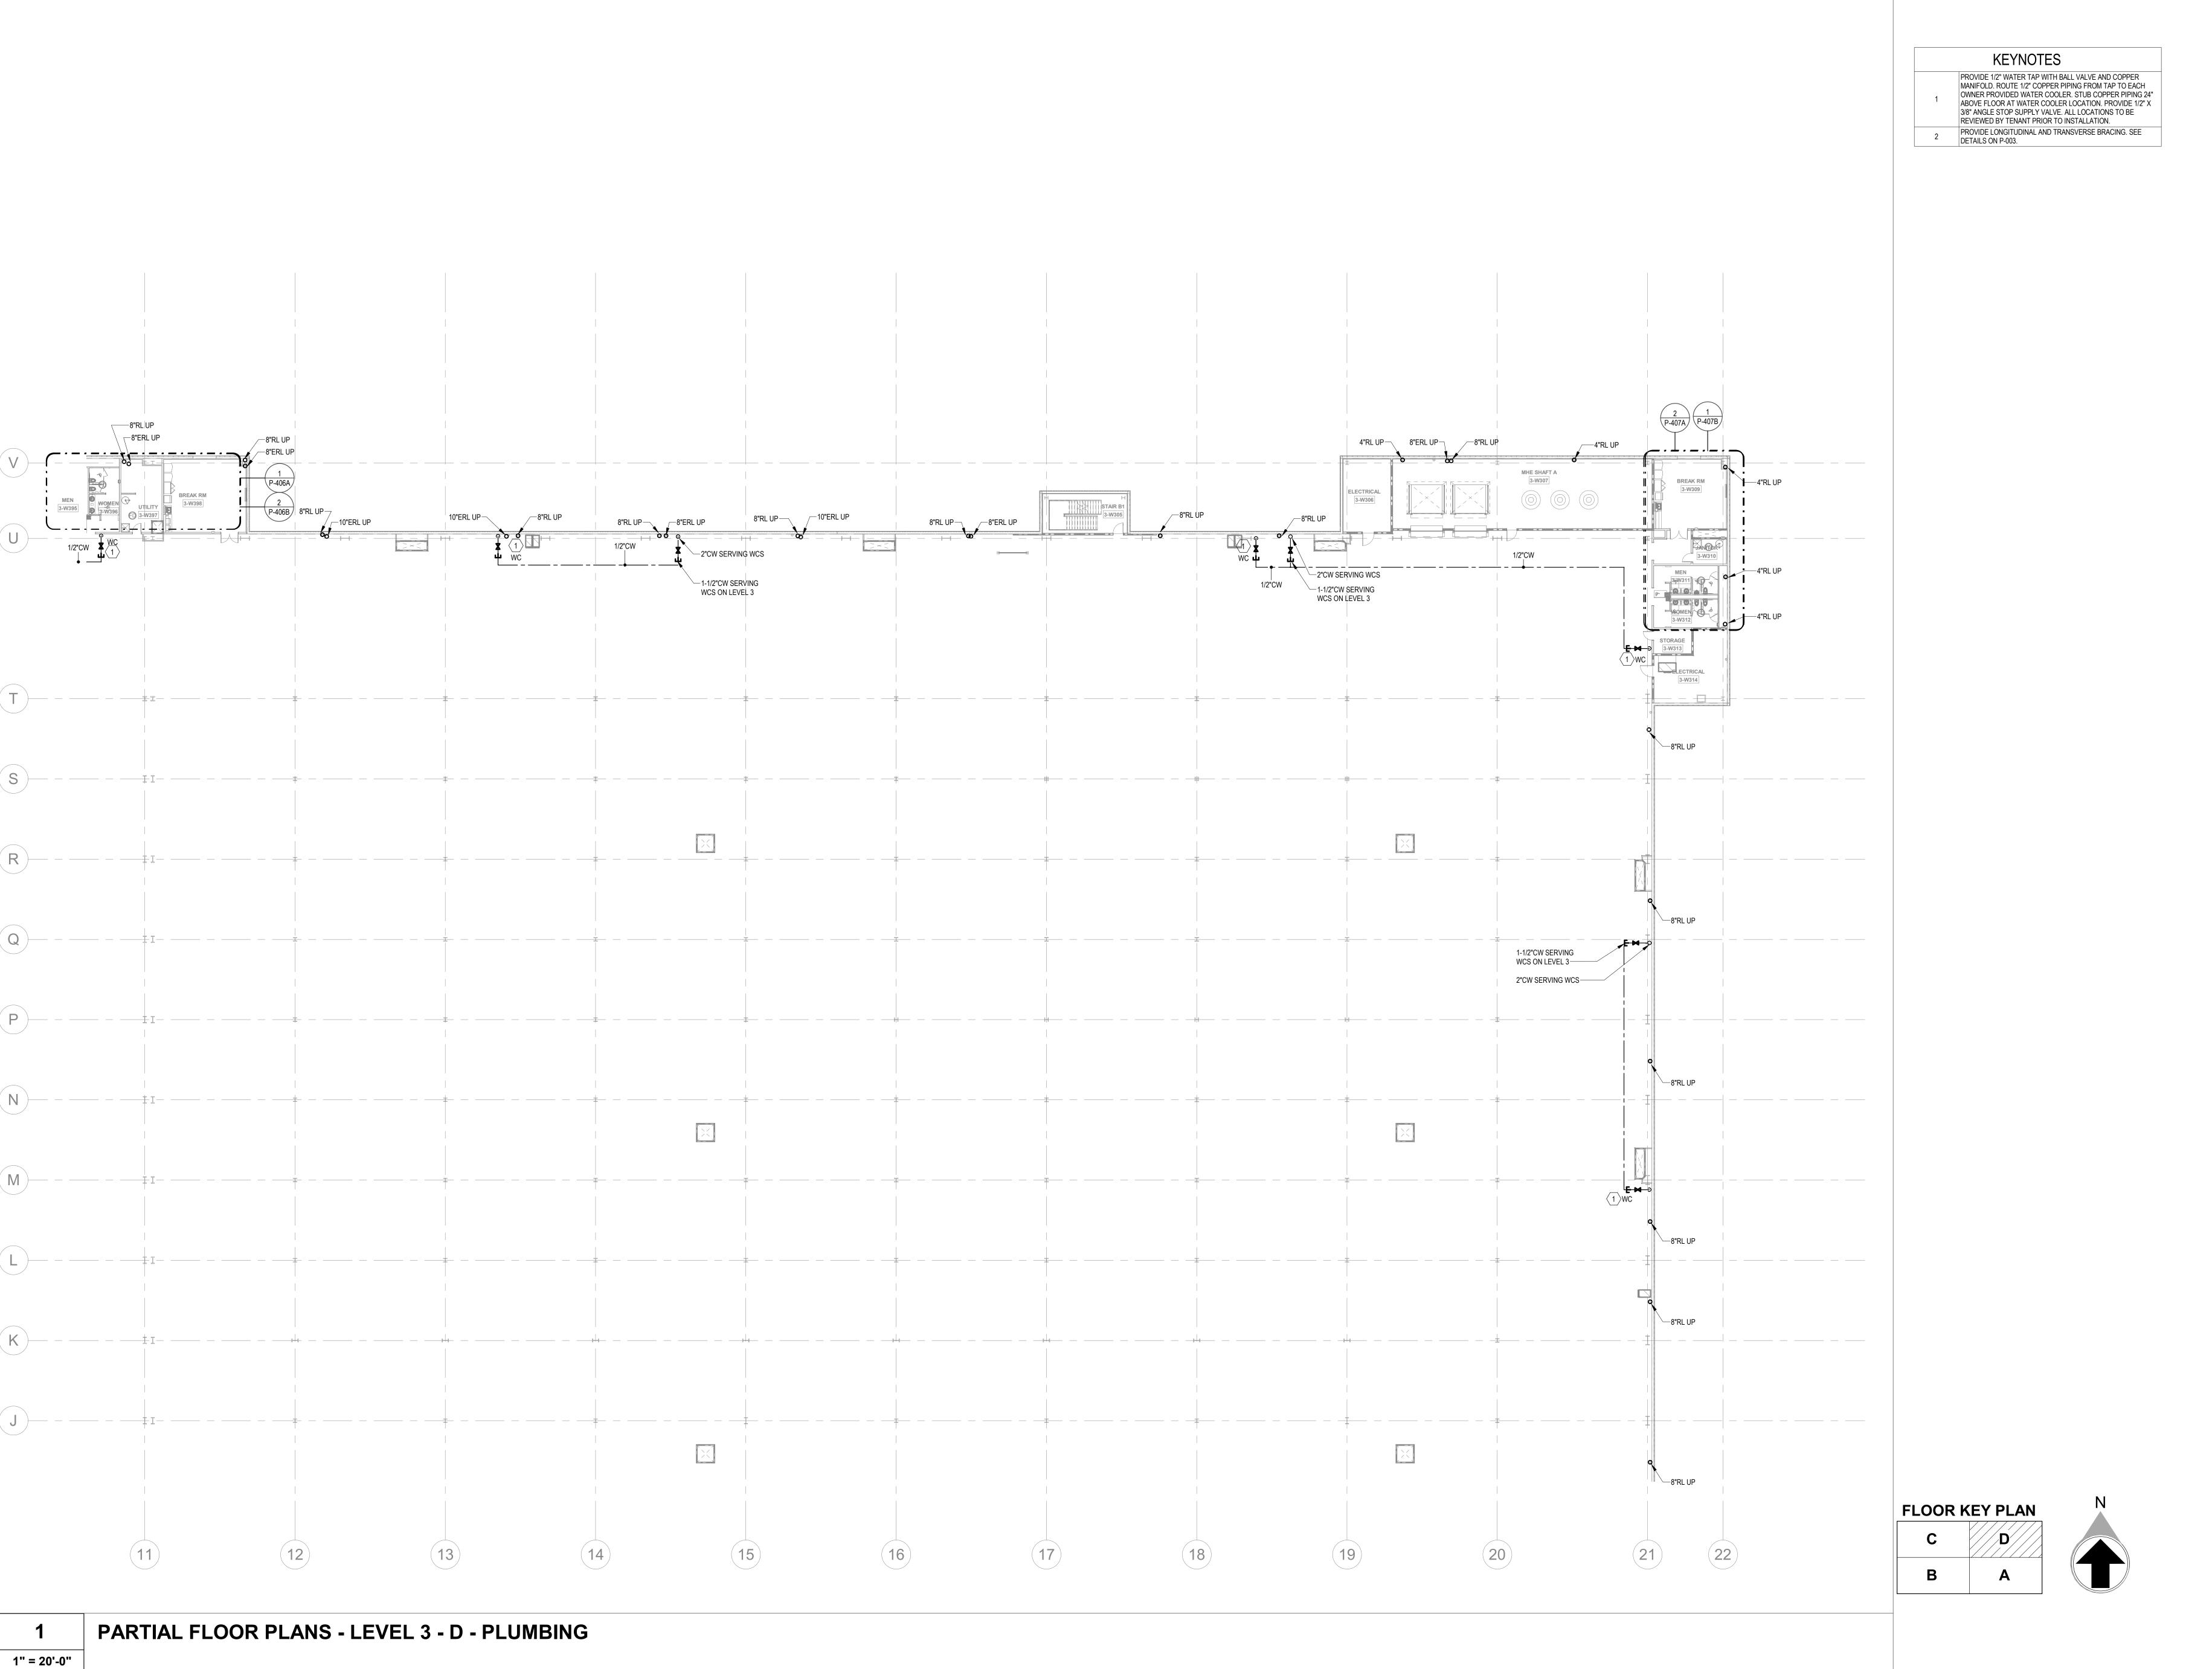
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01/21/22 PROJECT NO 2021-136 SHEET TITLE PARTIAL FLOOR PLAN -LEVEL 3 C -PLUMBING

P-214

NOT FOR CONSTRUCTION

1" = 20'-0"



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SHEET TITLE


PARTIAL


FLOOR PLAN 
LEVEL 3 D -


HEET NUMBER

PLUMBING

P-215

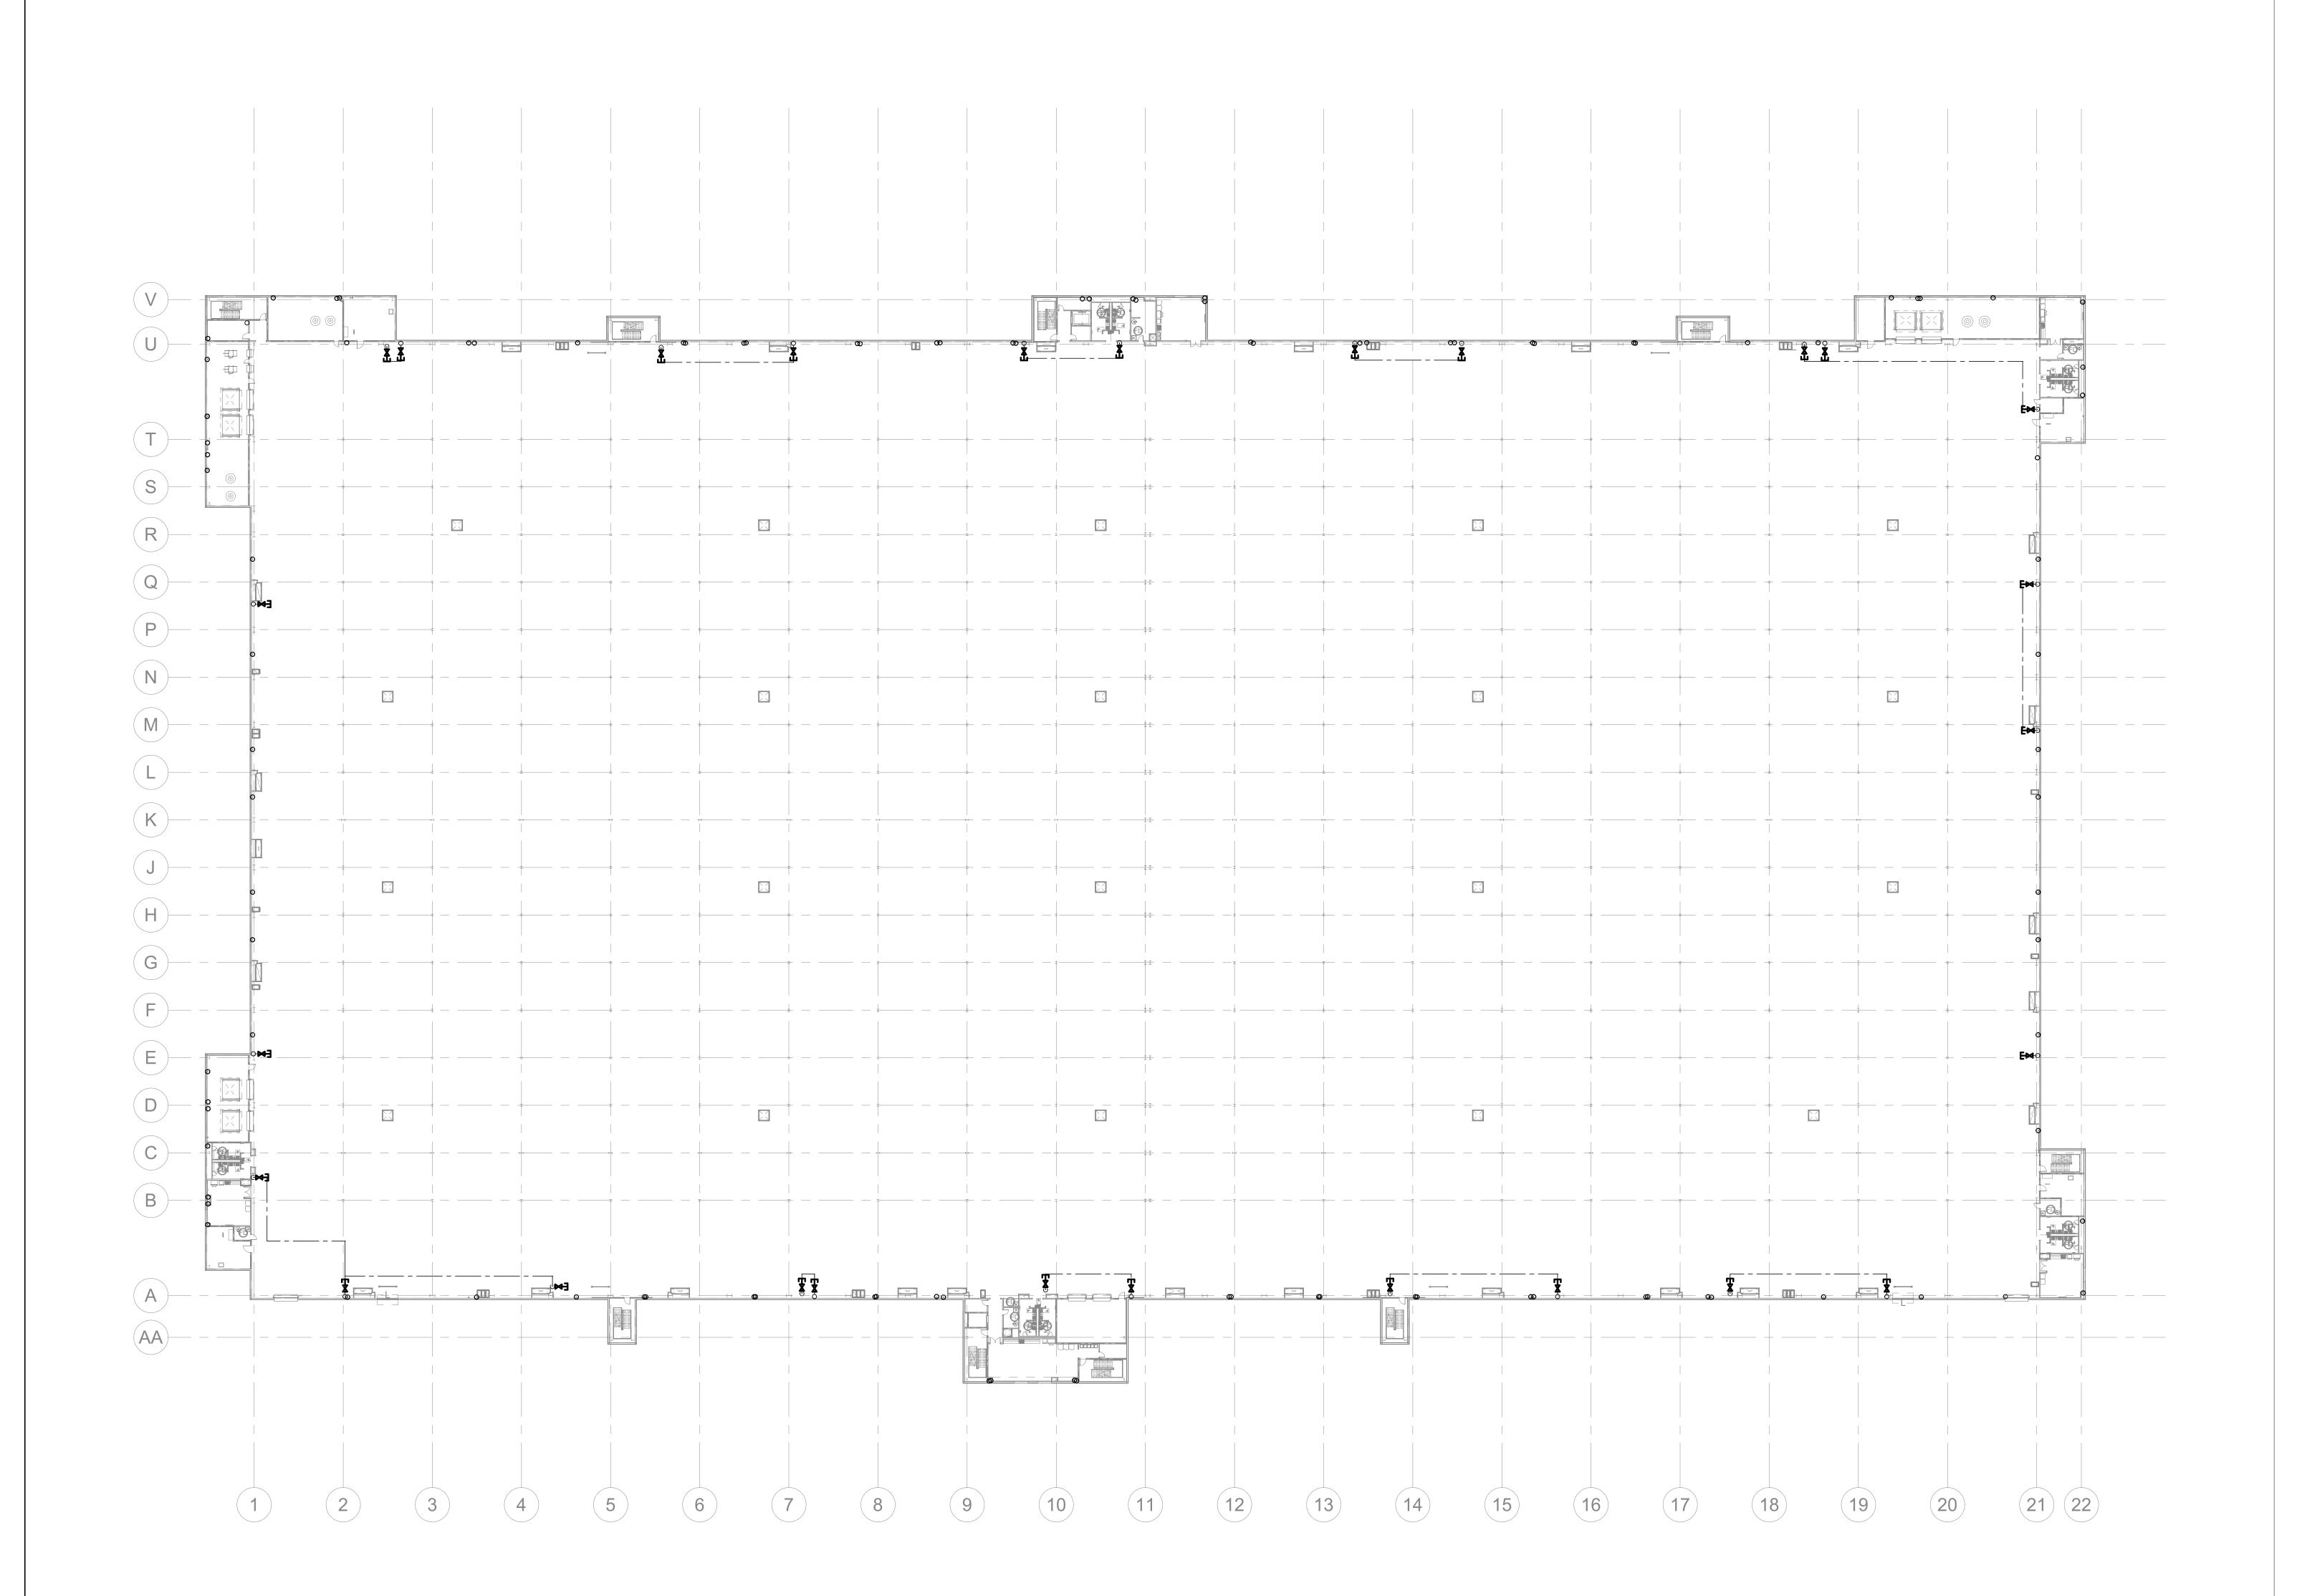

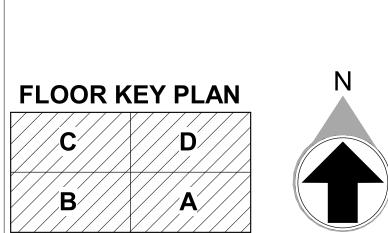

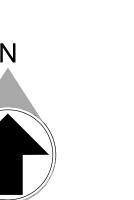

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PROJECT INFORMATION

**PROJECT** 


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DATE PROJECT NO 2021-136 SHEET TITLE OVERALL FLOOR PLAN -LEVEL 4 -PLUMBING

SHEET NUMBER P-216



KEYNOTE

- PROVIDE 1/2" WATER TAP WITH BALL VALVE AND COPPER MANIFOLD. ROUTE 1/2" COPPER PIPING FROM TAP TO EACH OWNER PROVIDED WATER COOLER. STUB COPPER PIPING 24" ABOVE FLOOR AT WATER COOLER LOCATION. PROVIDE 1/2" X 3/8" ANGLE STOP SUPPLY VALVE. ALL LOCATIONS TO BE REVIEWED BY TENANT PRIOR TO INSTALLATION.
- 3/8" ANGLE STOP SUPPLY VALVE. ALL LOCATIONS TO BE REVIEWED BY TENANT PRIOR TO INSTALLATION.

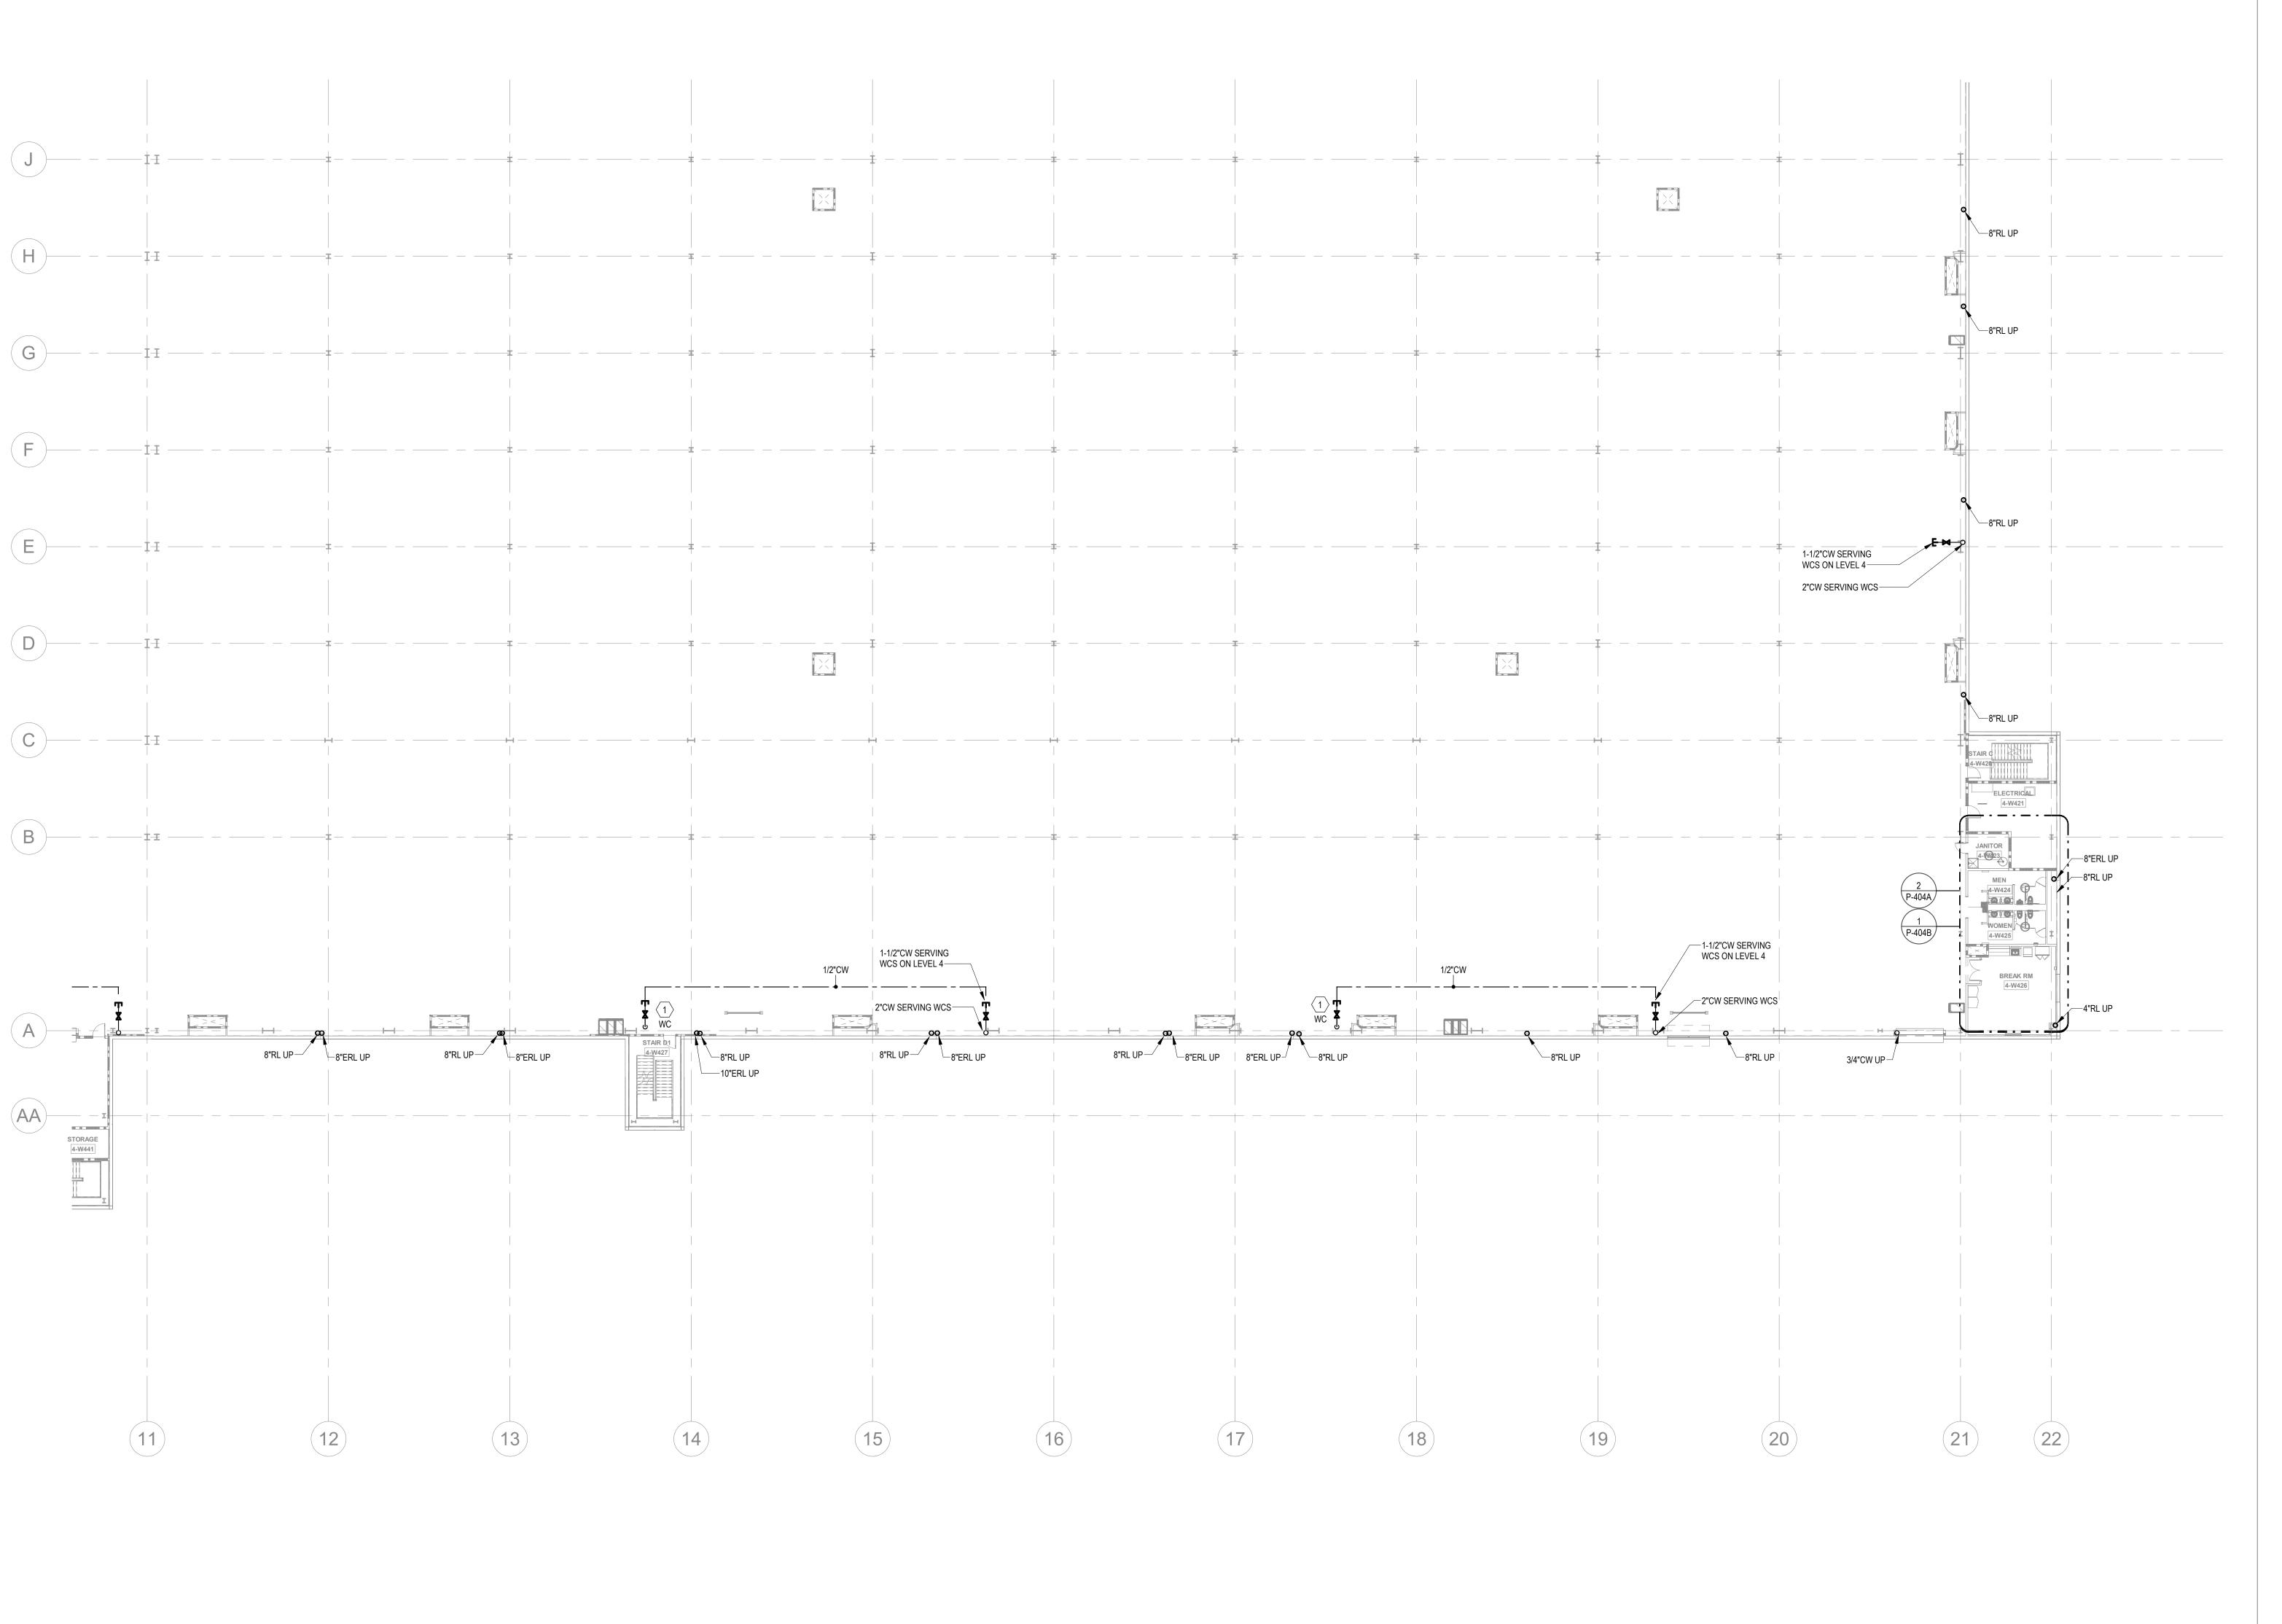  PROVIDE LONGITUDINAL AND TRANSVERSE BRACING. SEE DETAILS ON P-003.

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NUMBER DATE DESCRIPTION

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PROJECT WHALE

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PROJECT NO

2021-136

SHEET TITLE

PARTIAL


FLOOR PLAN -

FLOOR PLAN LEVEL 4 A -PLUMBING

**FLOOR KEY PLAN** 

SHEET NUMBER

P-217

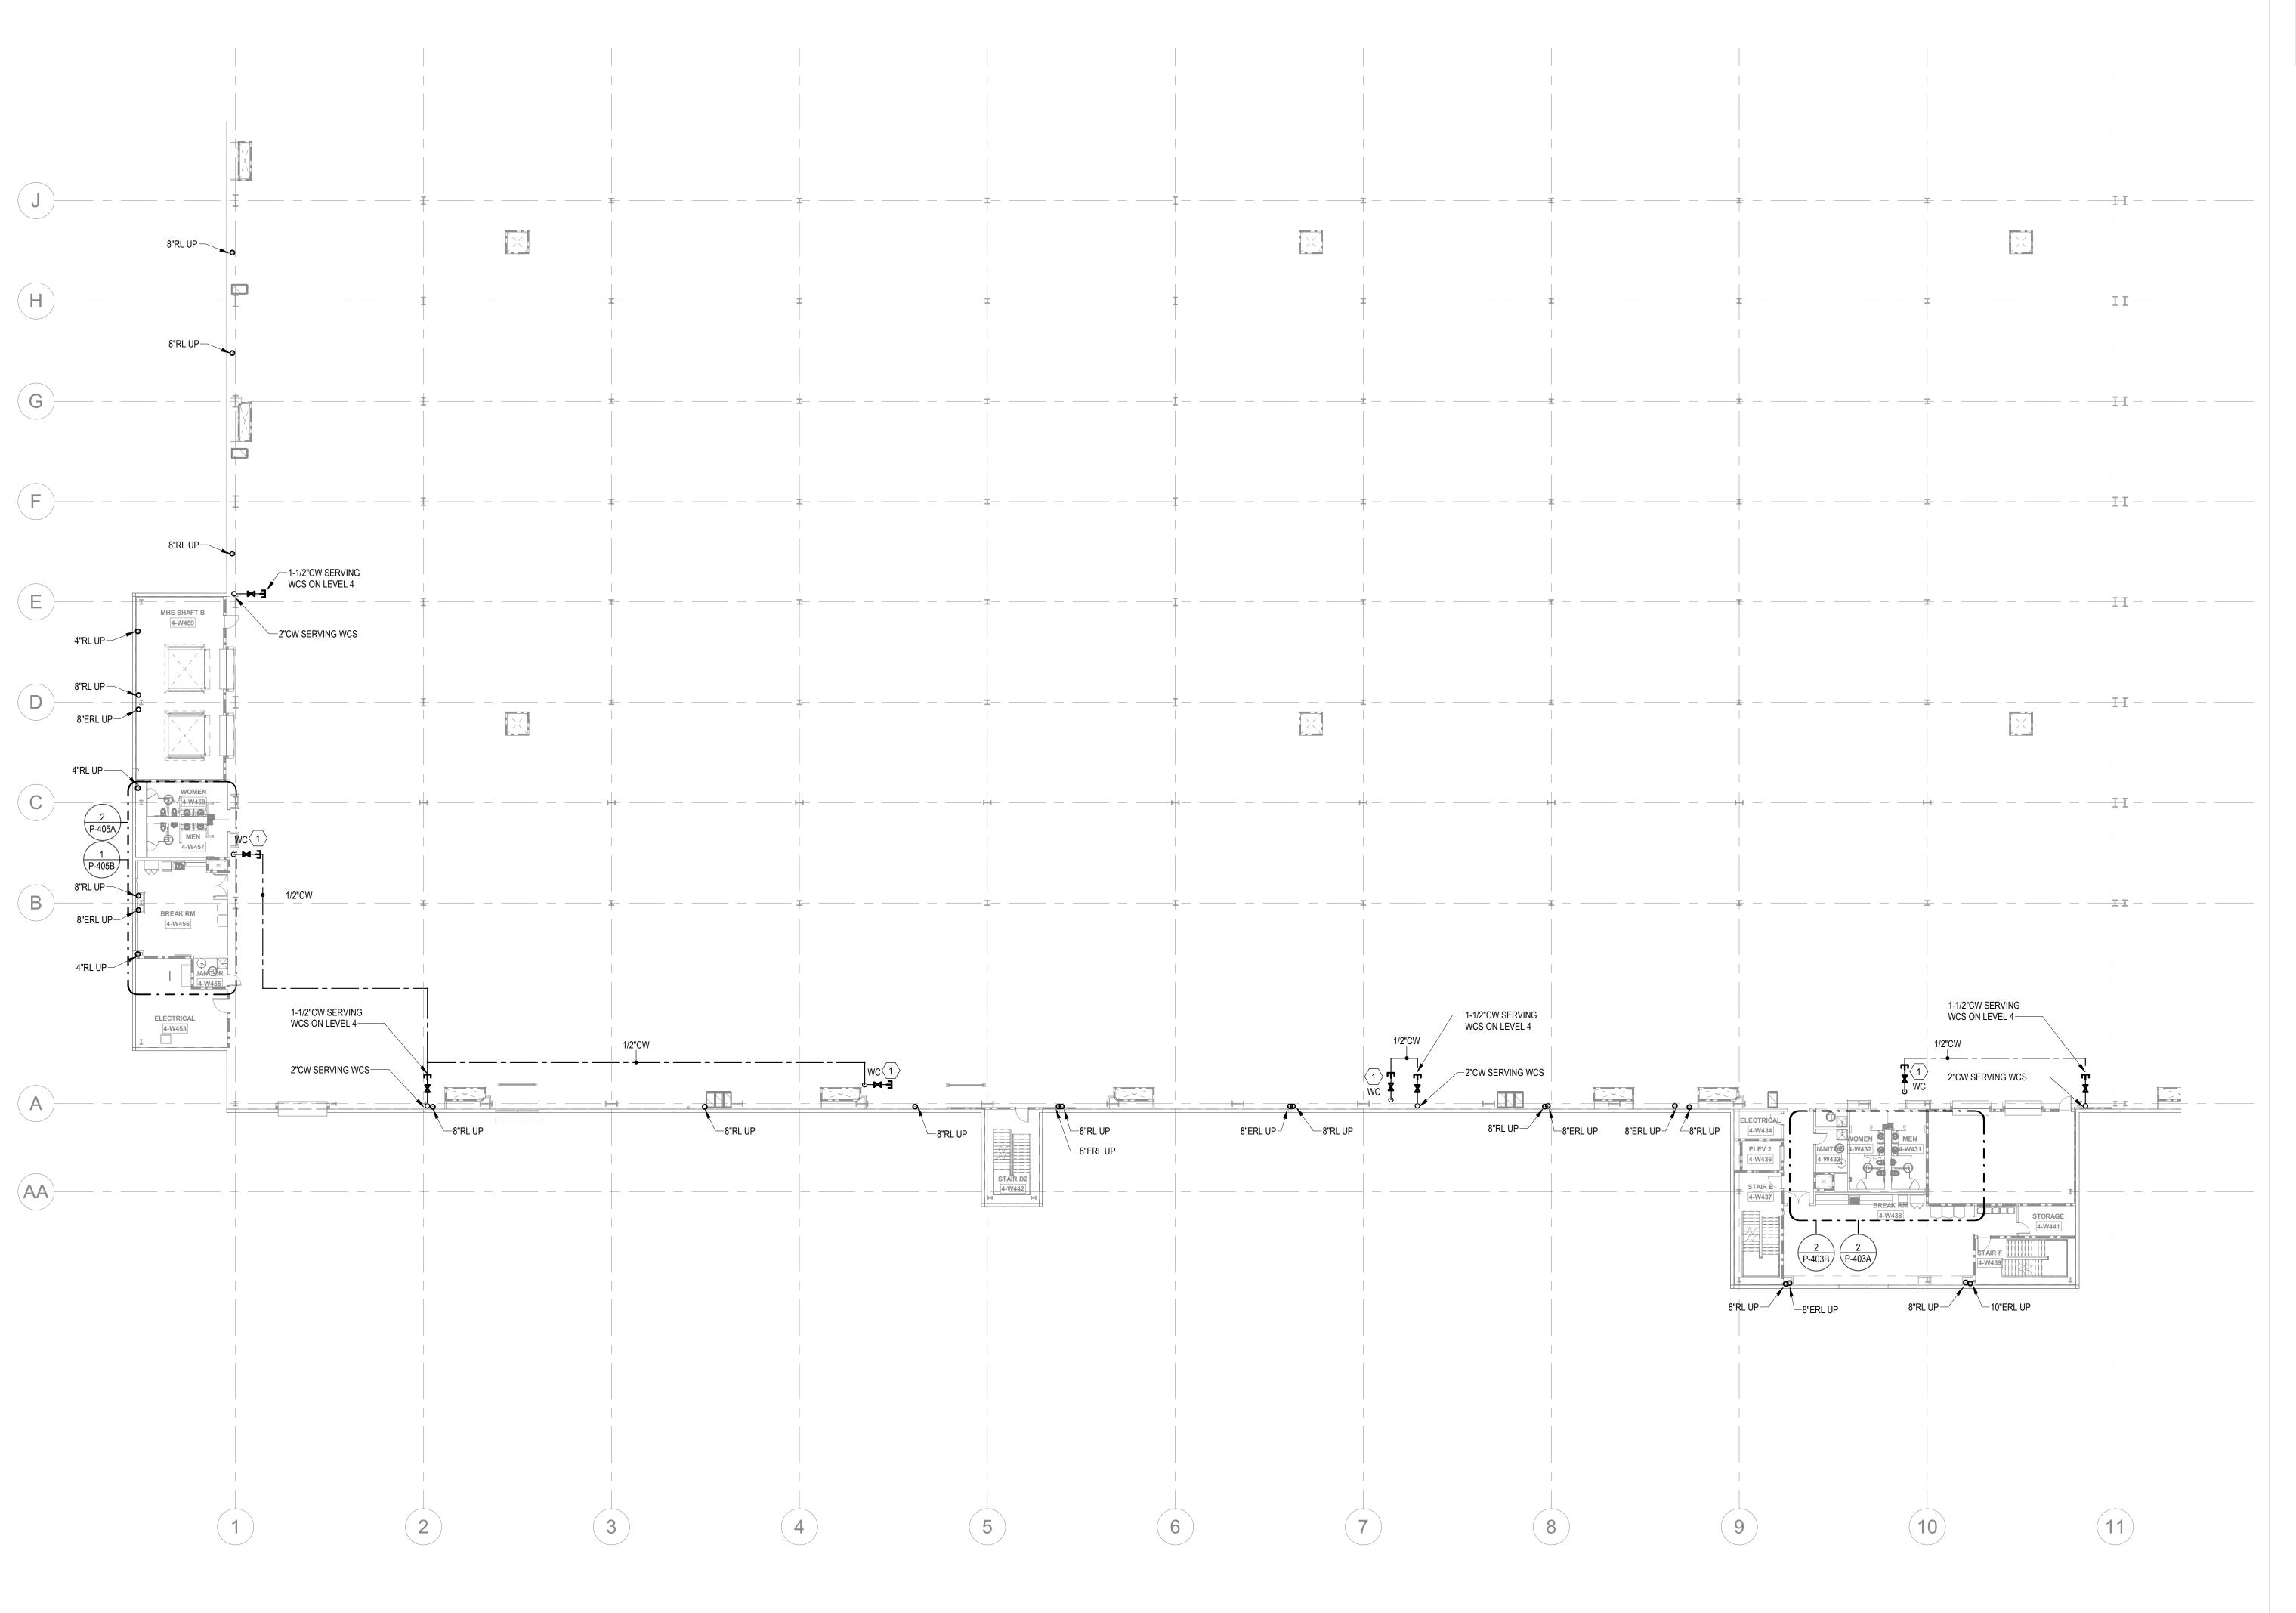

**KEYNOTES** 

- PROVIDE 1/2" WATER TAP WITH BALL VALVE AND COPPER MANIFOLD. ROUTE 1/2" COPPER PIPING FROM TAP TO EACH OWNER PROVIDED WATER COOLER. STUB COPPER PIPING 24" ABOVE FLOOR AT WATER COOLER LOCATION. PROVIDE 1/2" X 3/8" ANGLE STOP SUPPLY VALVE. ALL LOCATIONS TO BE REVIEWED BY TENANT PRIOR TO INSTALLATION.
- PROVIDE LONGITUDINAL AND TRANSVERSE BRACING. SEE DETAILS ON P-003.

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PROJECT INFORMATION

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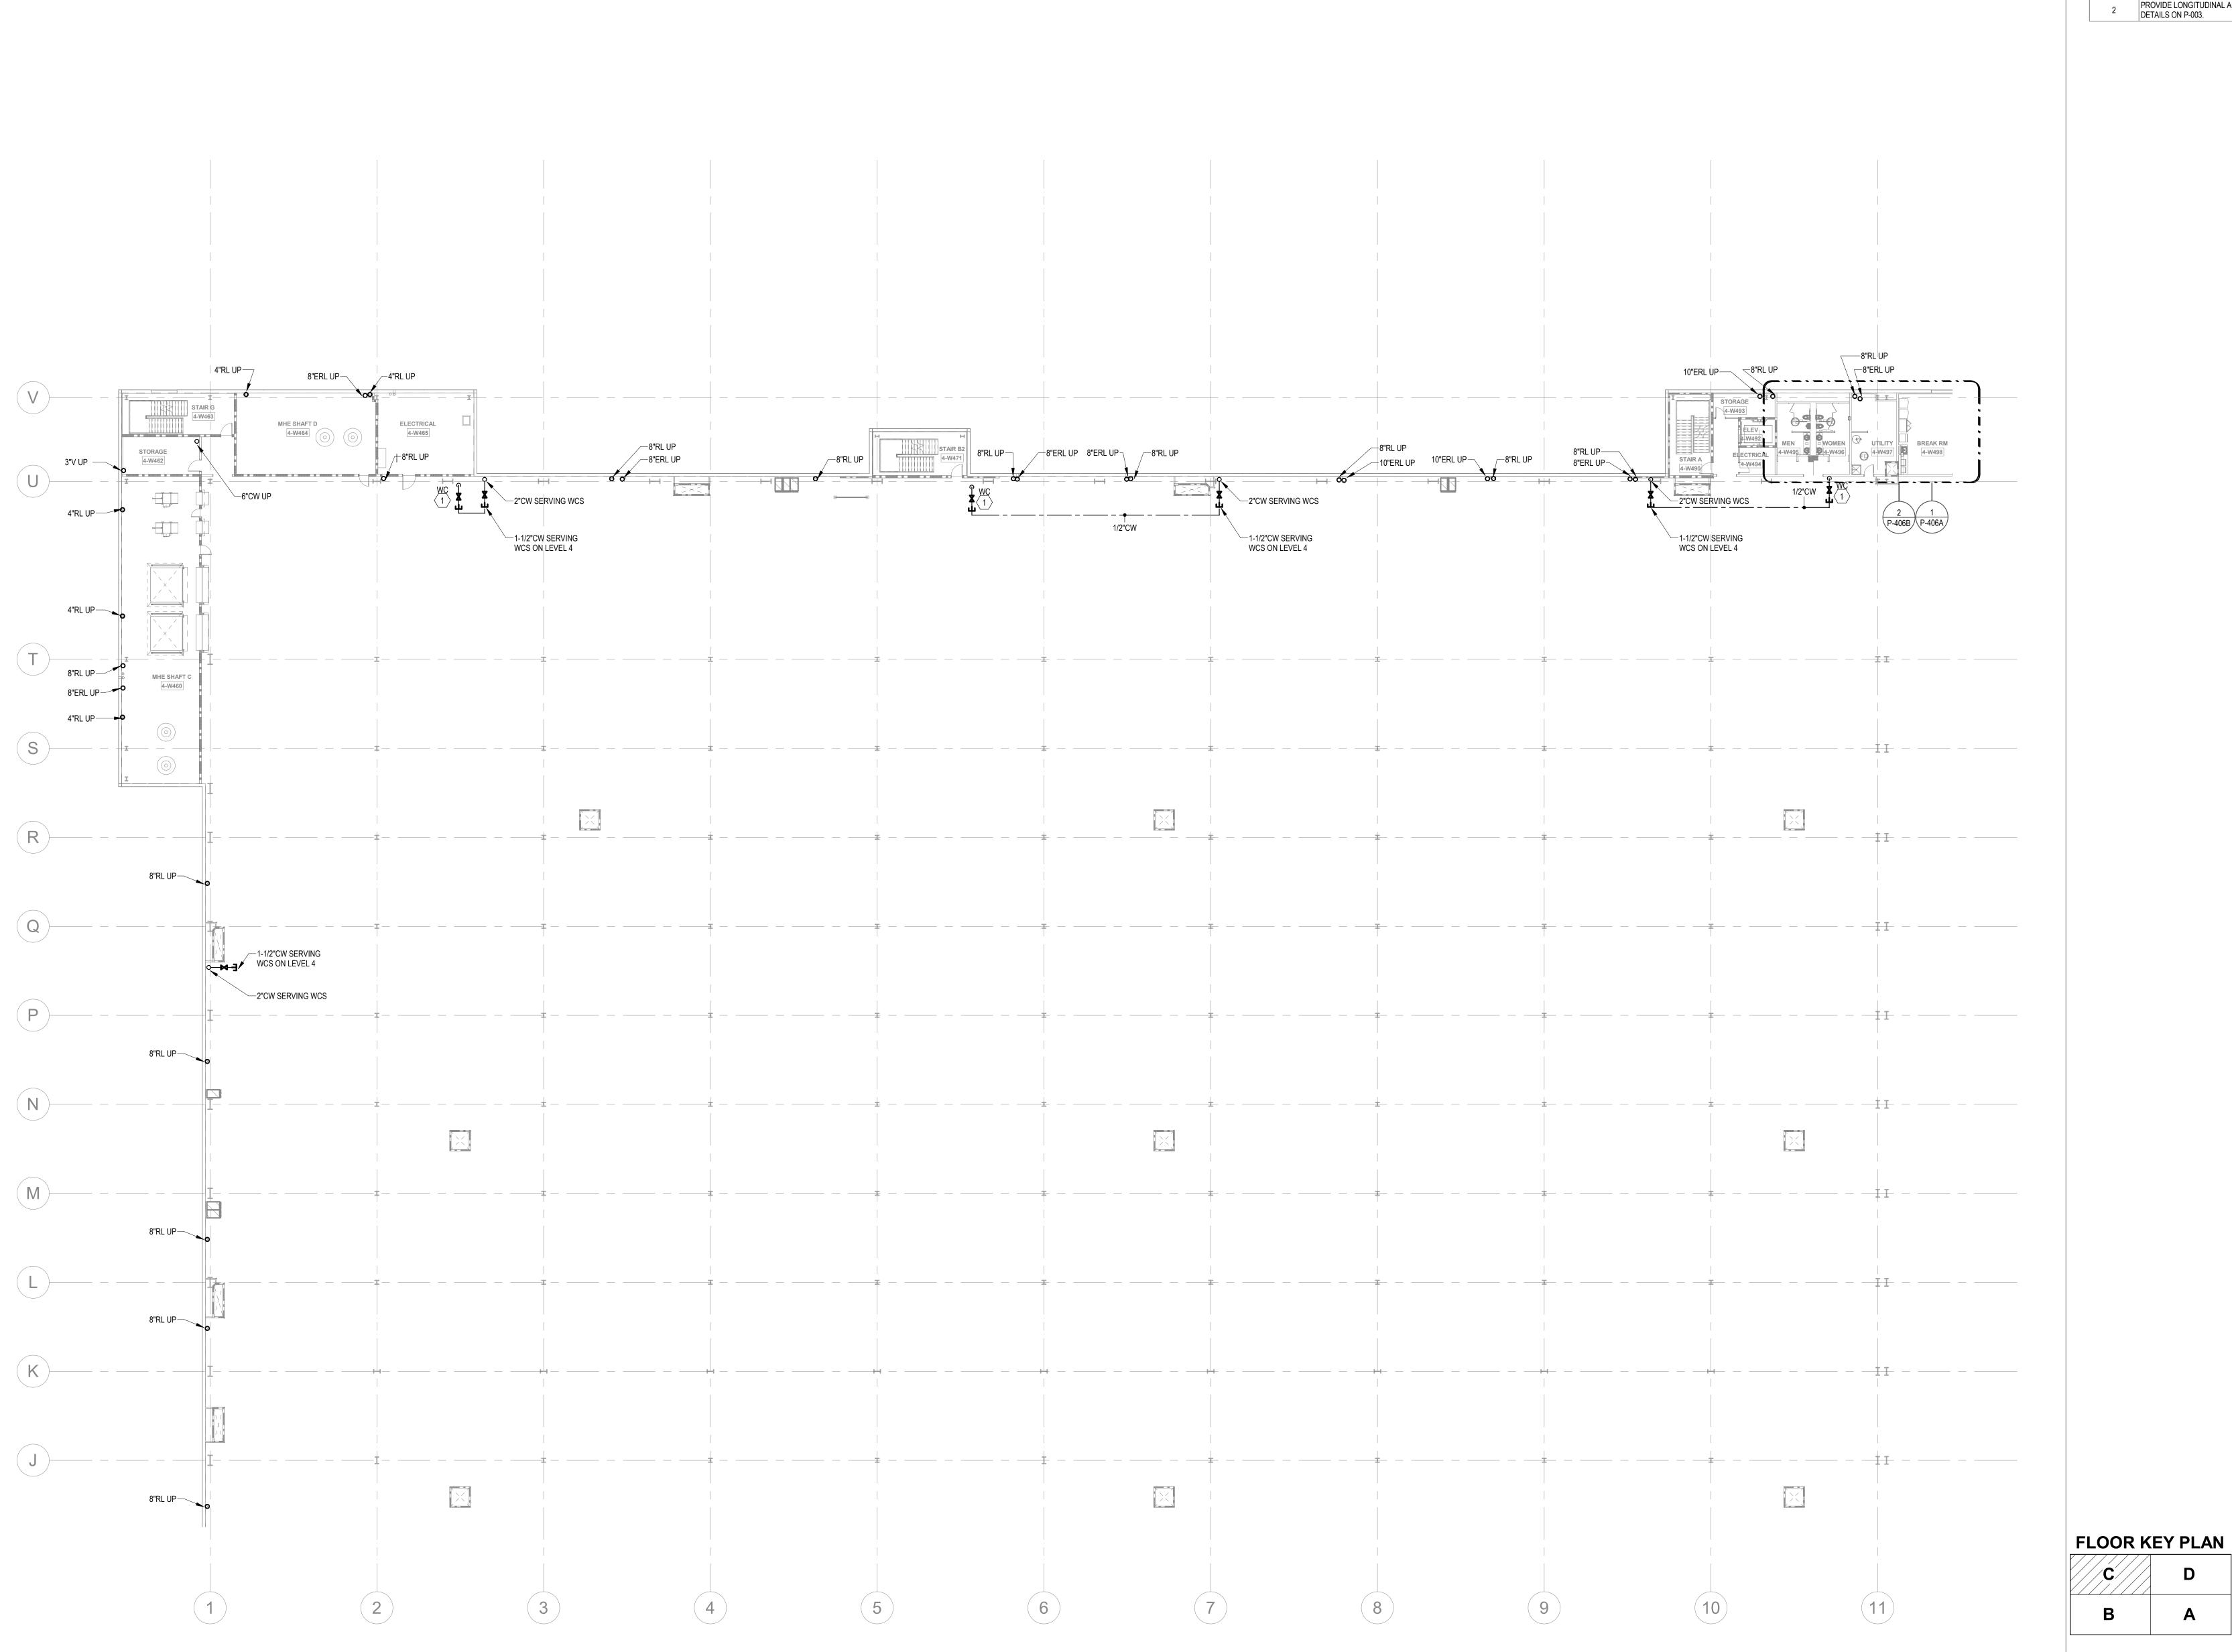
DATE PROJECT NO 2021-136 SHEET TITLE PARTIAL

FLOOR PLAN -LEVEL 4 B -PLUMBING

**FLOOR KEY PLAN** 

NOT FOR CONSTRUCTION

SHEET NUMBER P-218



PARTIAL FLOOR PLANS - LEVEL 4 - C - PLUMBING

1" = 20'-0"

**KEYNOTES** 

PROVIDE 1/2" WATER TAP WITH BALL VALVE AND COPPER MANIFOLD. ROUTE 1/2" COPPER PIPING FROM TAP TO EACH OWNER PROVIDED WATER COOLER. STUB COPPER PIPING 24" ABOVE FLOOR AT WATER COOLER LOCATION. PROVIDE 1/2" X 3/8" ANGLE STOP SUPPLY VALVE. ALL LOCATIONS TO BE REVIEWED BY TENANT PRIOR TO INSTALLATION.

PROVIDE LONGITUDINAL AND TRANSVERSE BRACING. SEE DETAILS ON P-003.

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01/21/22

PROJECT NO
2021-136


SHEET TITLE

PARTIAL
FLOOR PLAN LEVEL 4 C PLUMBING

SHEET NUMBER

P\_210

P-219

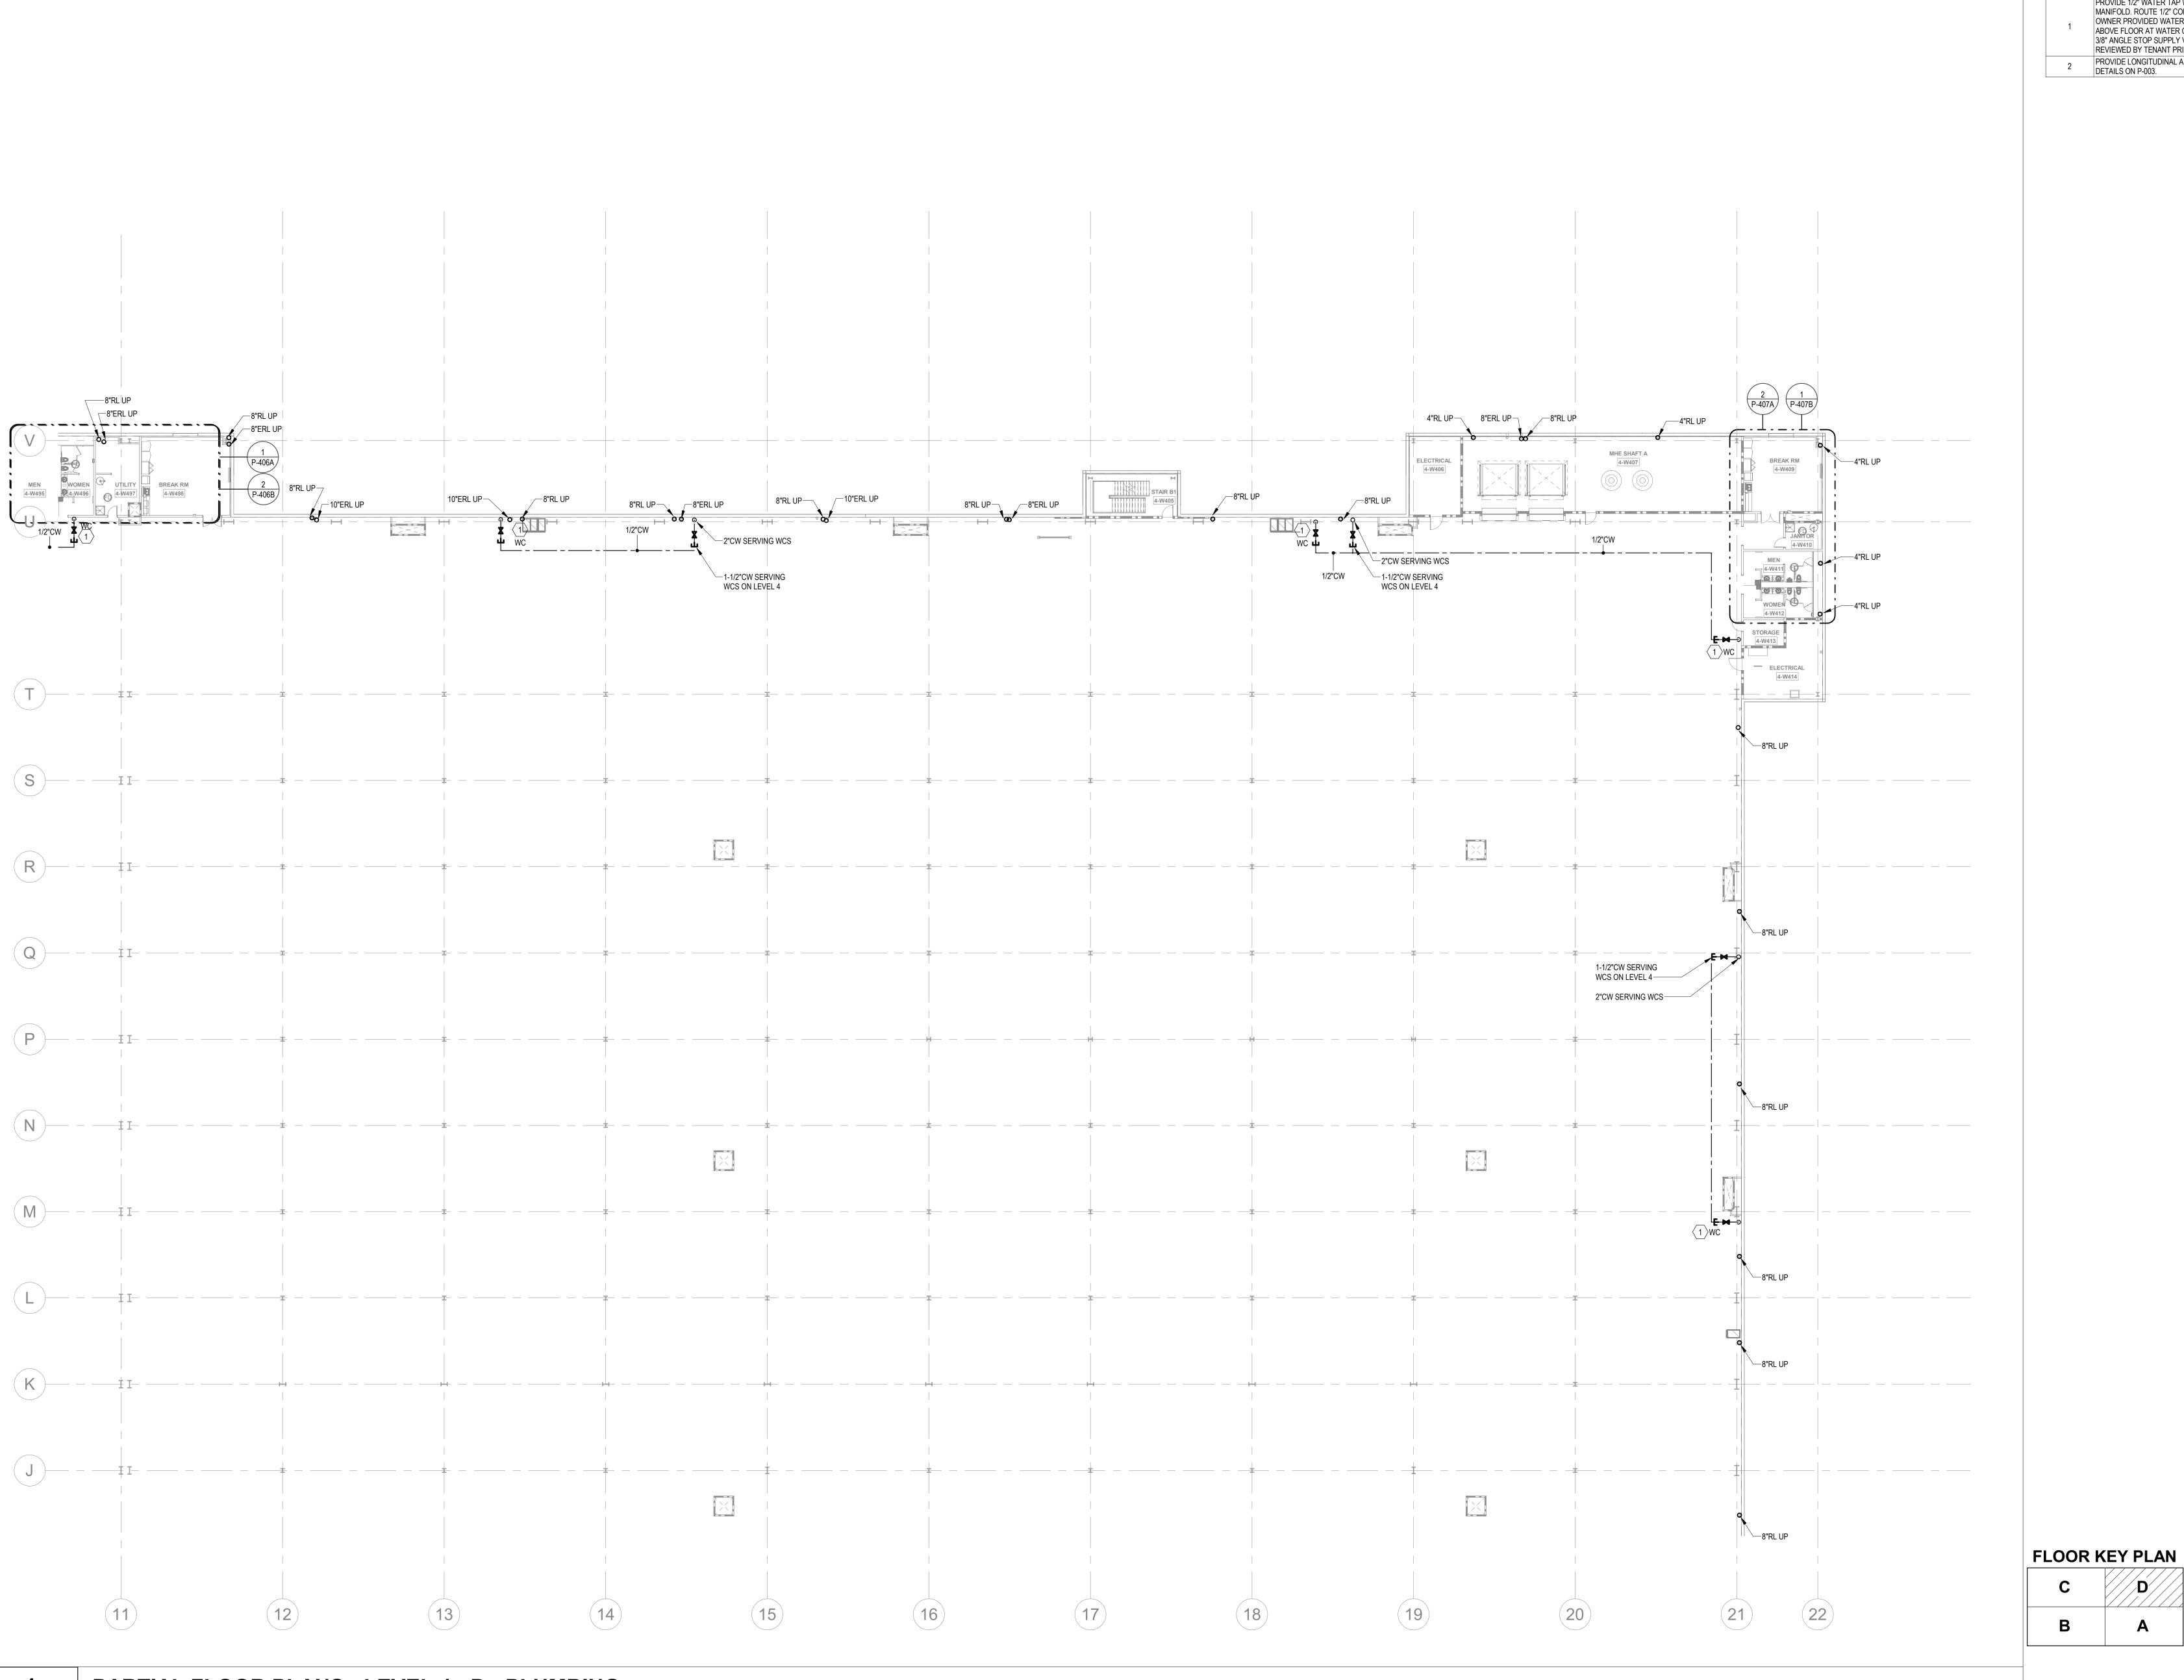

- PROVIDE 1/2" WATER TAP WITH BALL VALVE AND COPPER MANIFOLD. ROUTE 1/2" COPPER PIPING FROM TAP TO EACH OWNER PROVIDED WATER COOLER. STUB COPPER PIPING 24" ABOVE FLOOR AT WATER COOLER LOCATION. PROVIDE 1/2" X 3/8" ANGLE STOP SUPPLY VALVE. ALL LOCATIONS TO BE REVIEWED BY TENANT PRIOR TO INSTALLATION.
- PROVIDE LONGITUDINAL AND TRANSVERSE BRACING. SEE DETAILS ON P-003.

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**PROJECT** 

WILMINGTON, NC

01/21/22 PROJECT NO 2021-136 SHEET TITLE PARTIAL


FLOOR PLAN -LEVEL 4 D -PLUMBING

P-220

NOT FOR CONSTRUCTION

PARTIAL FLOOR PLANS - LEVEL 4 - D - PLUMBING

1" = 20'-0"

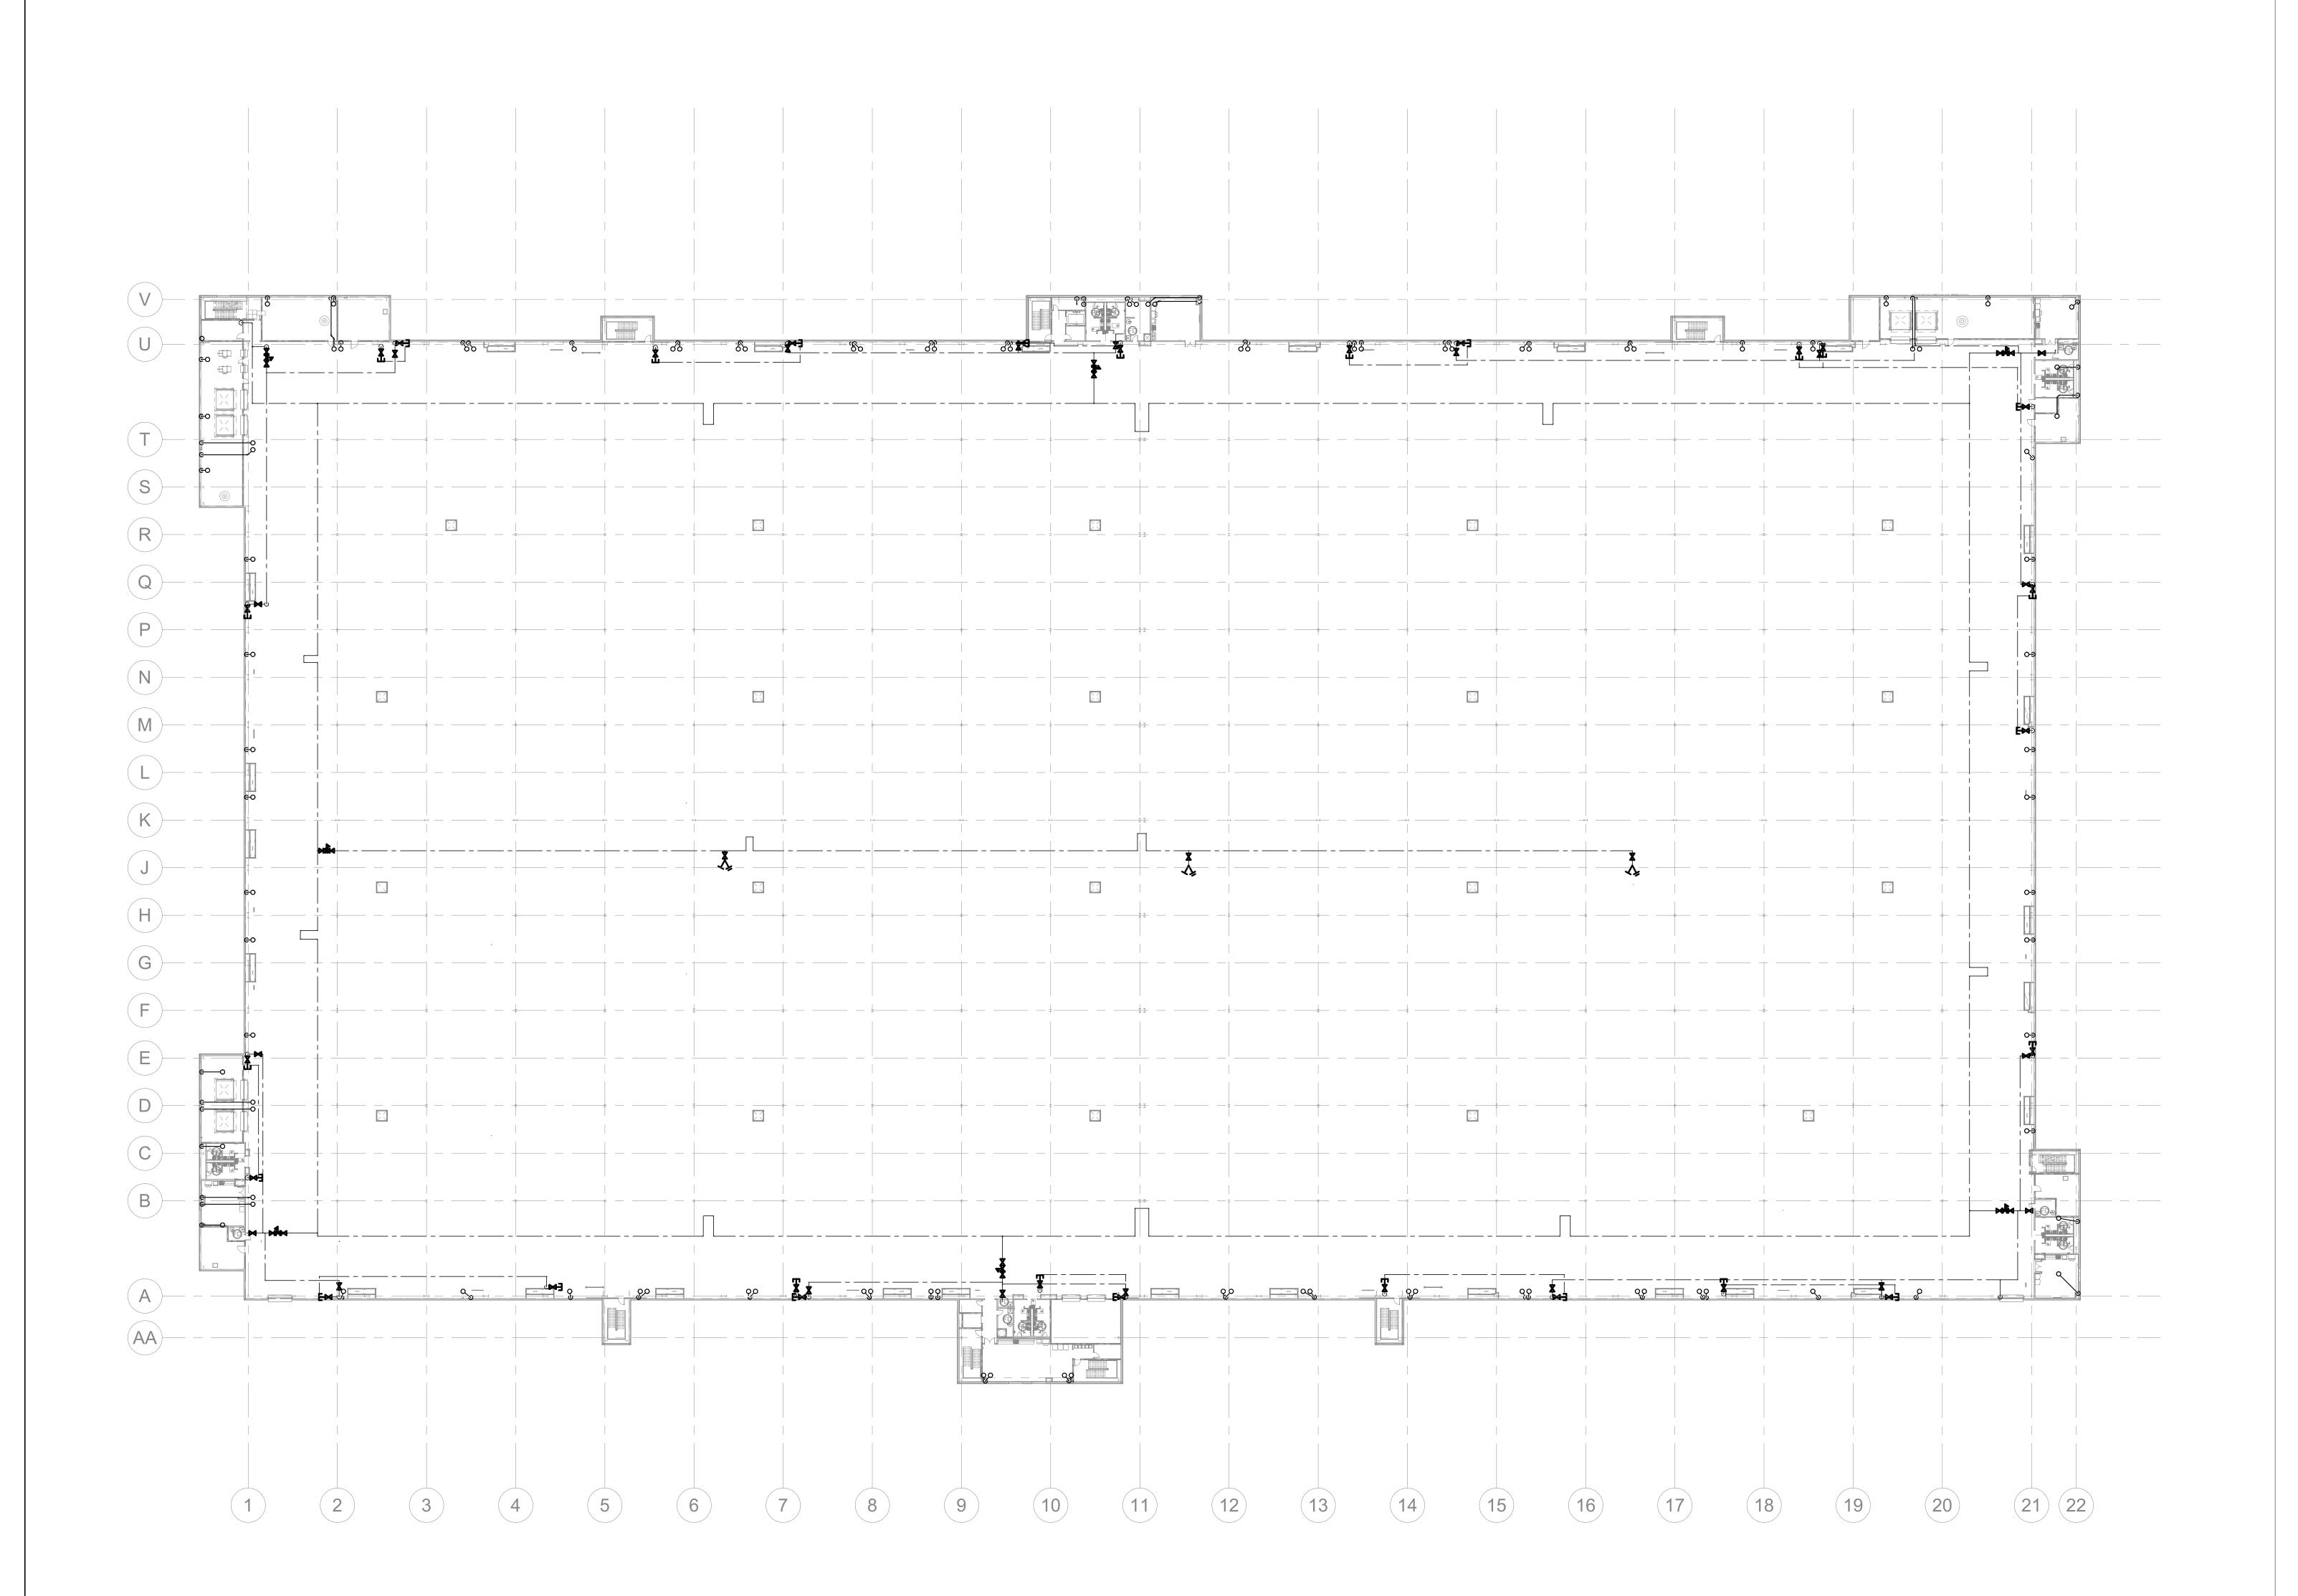

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DATE DESCRIPTION

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PROJECT INFORMATION

PROJECT

**WHALE** 

WILMINGTON, NC

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DATE

01/21/22

PROJECT NO
2021-136

SHEET TITLE

OVERALL

FLOOR PLAN LEVEL 5 -

PLUMBING

SHEET NUMBER

P-221


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FLOOR KEY PLAN

C

B

A

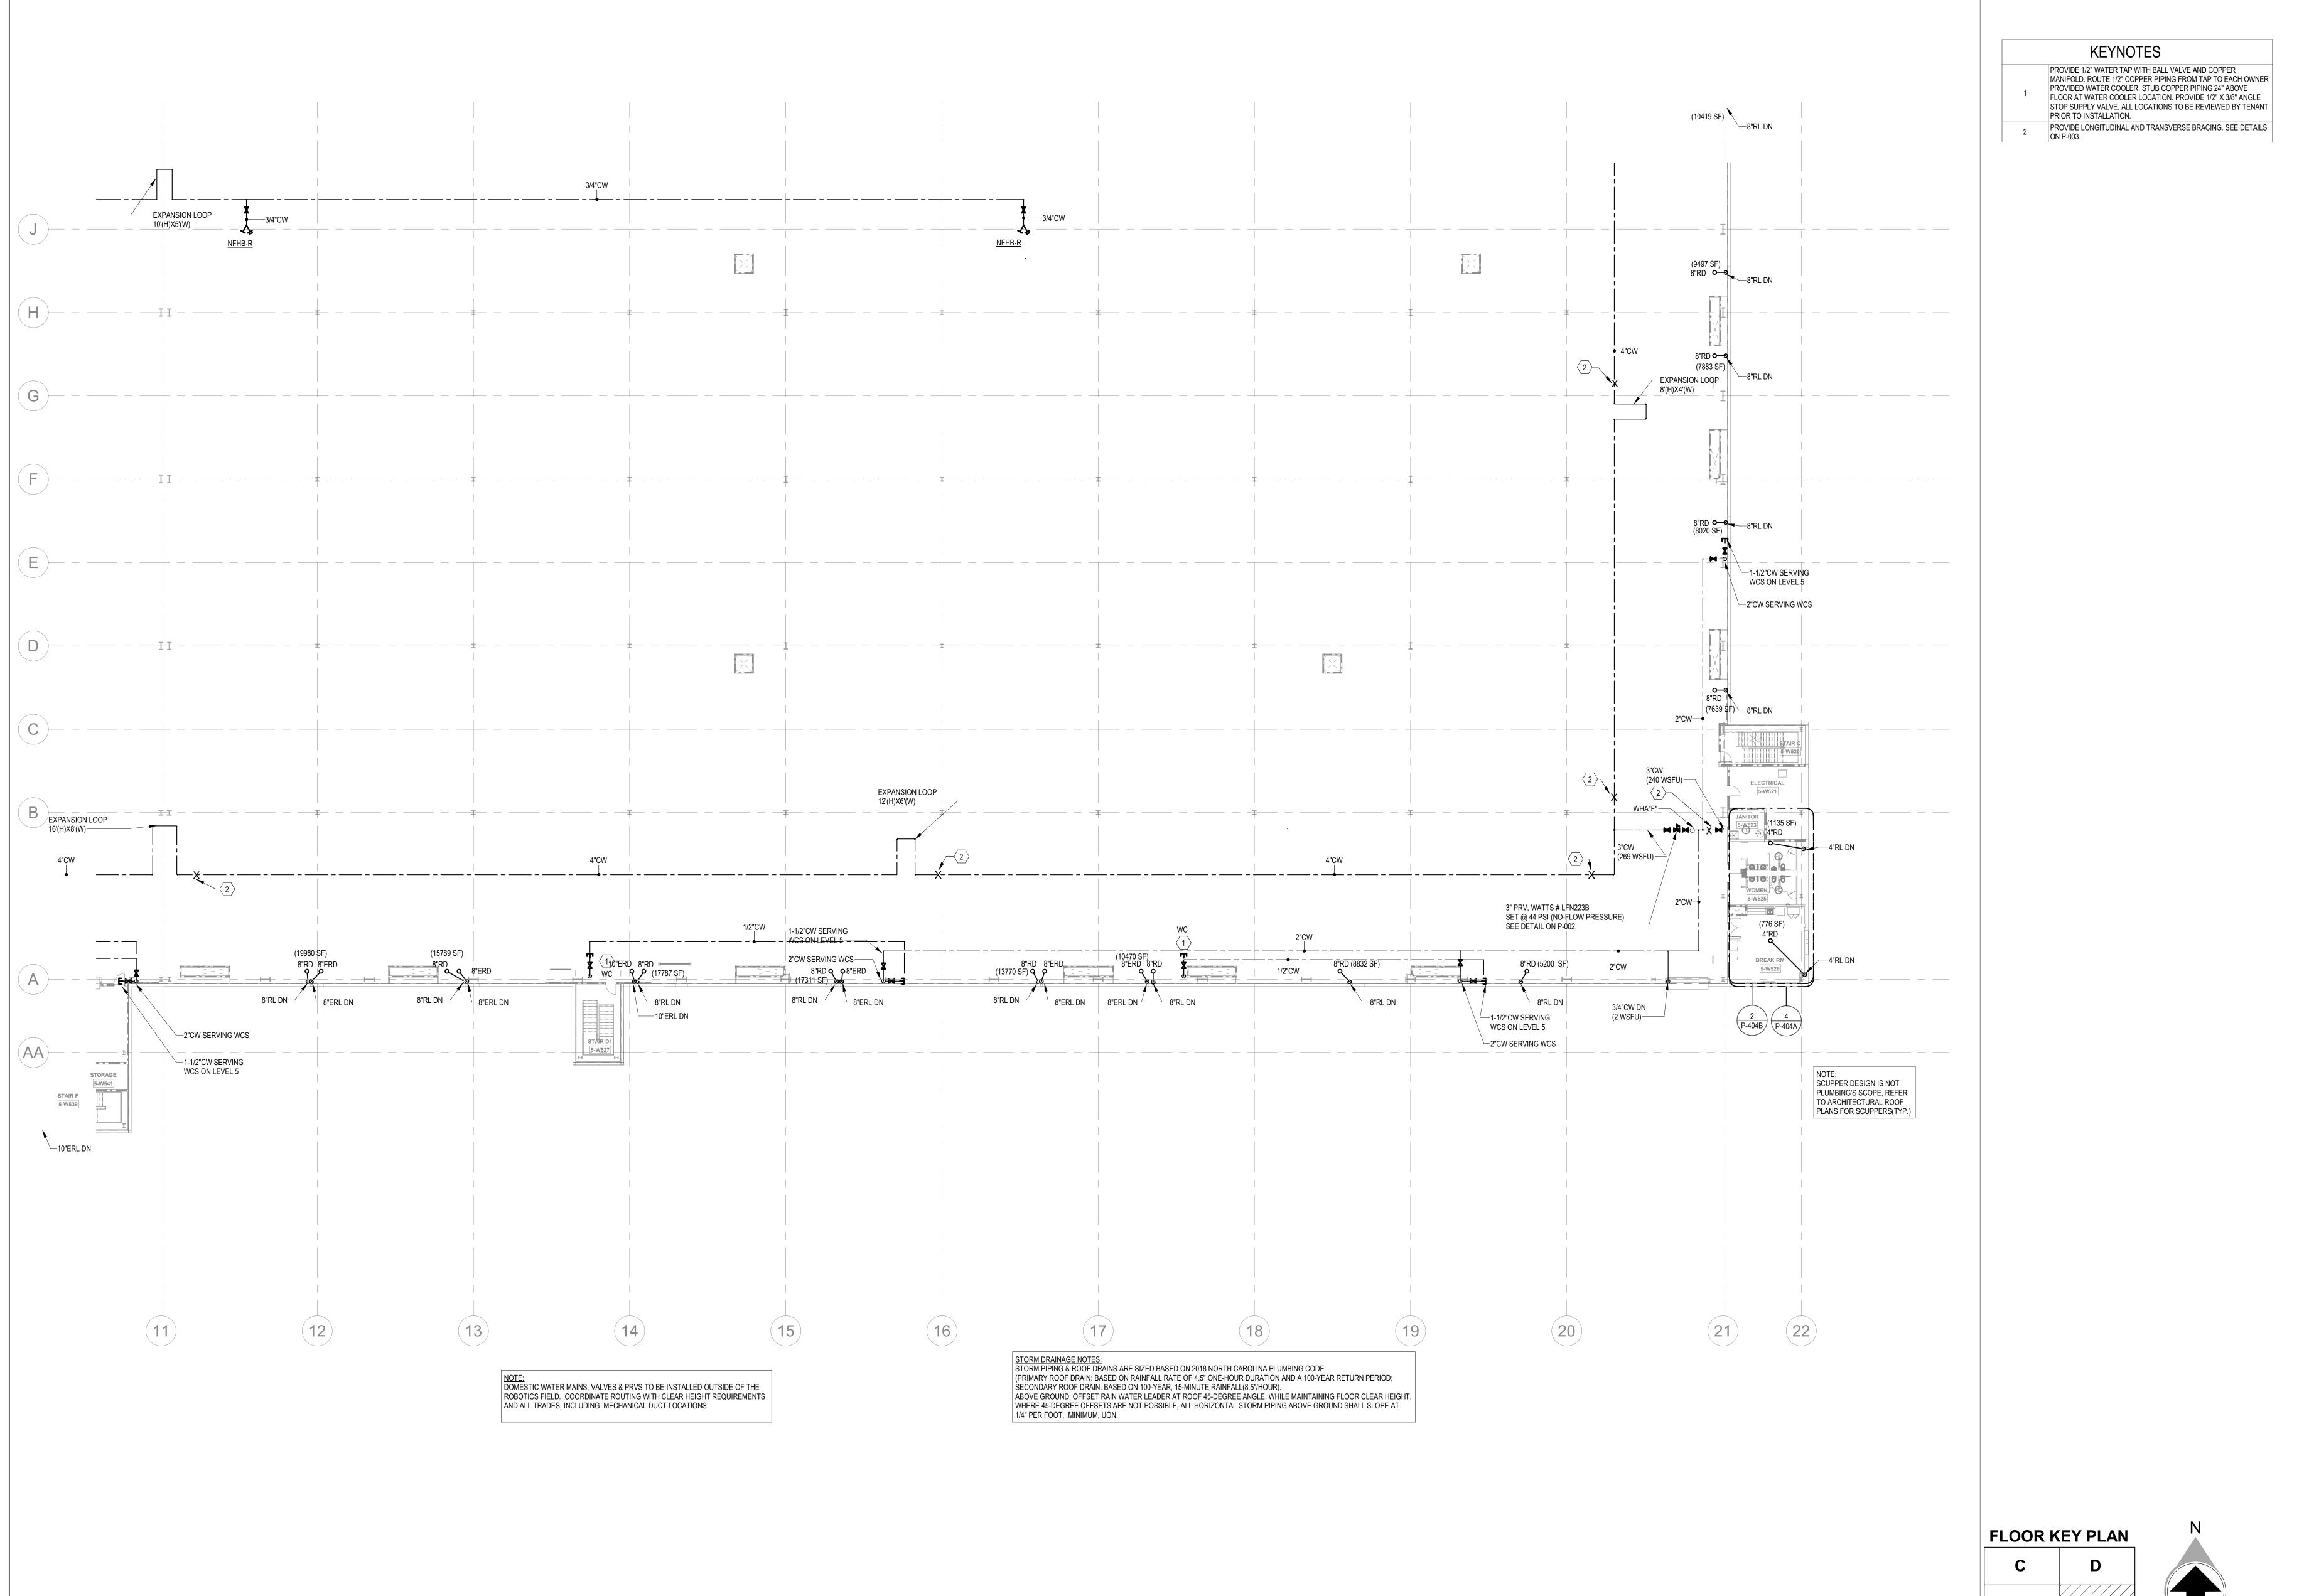

MACGREGOR ASSOCIATES

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PROJECT INFORMATION

**PROJECT WHALE** 

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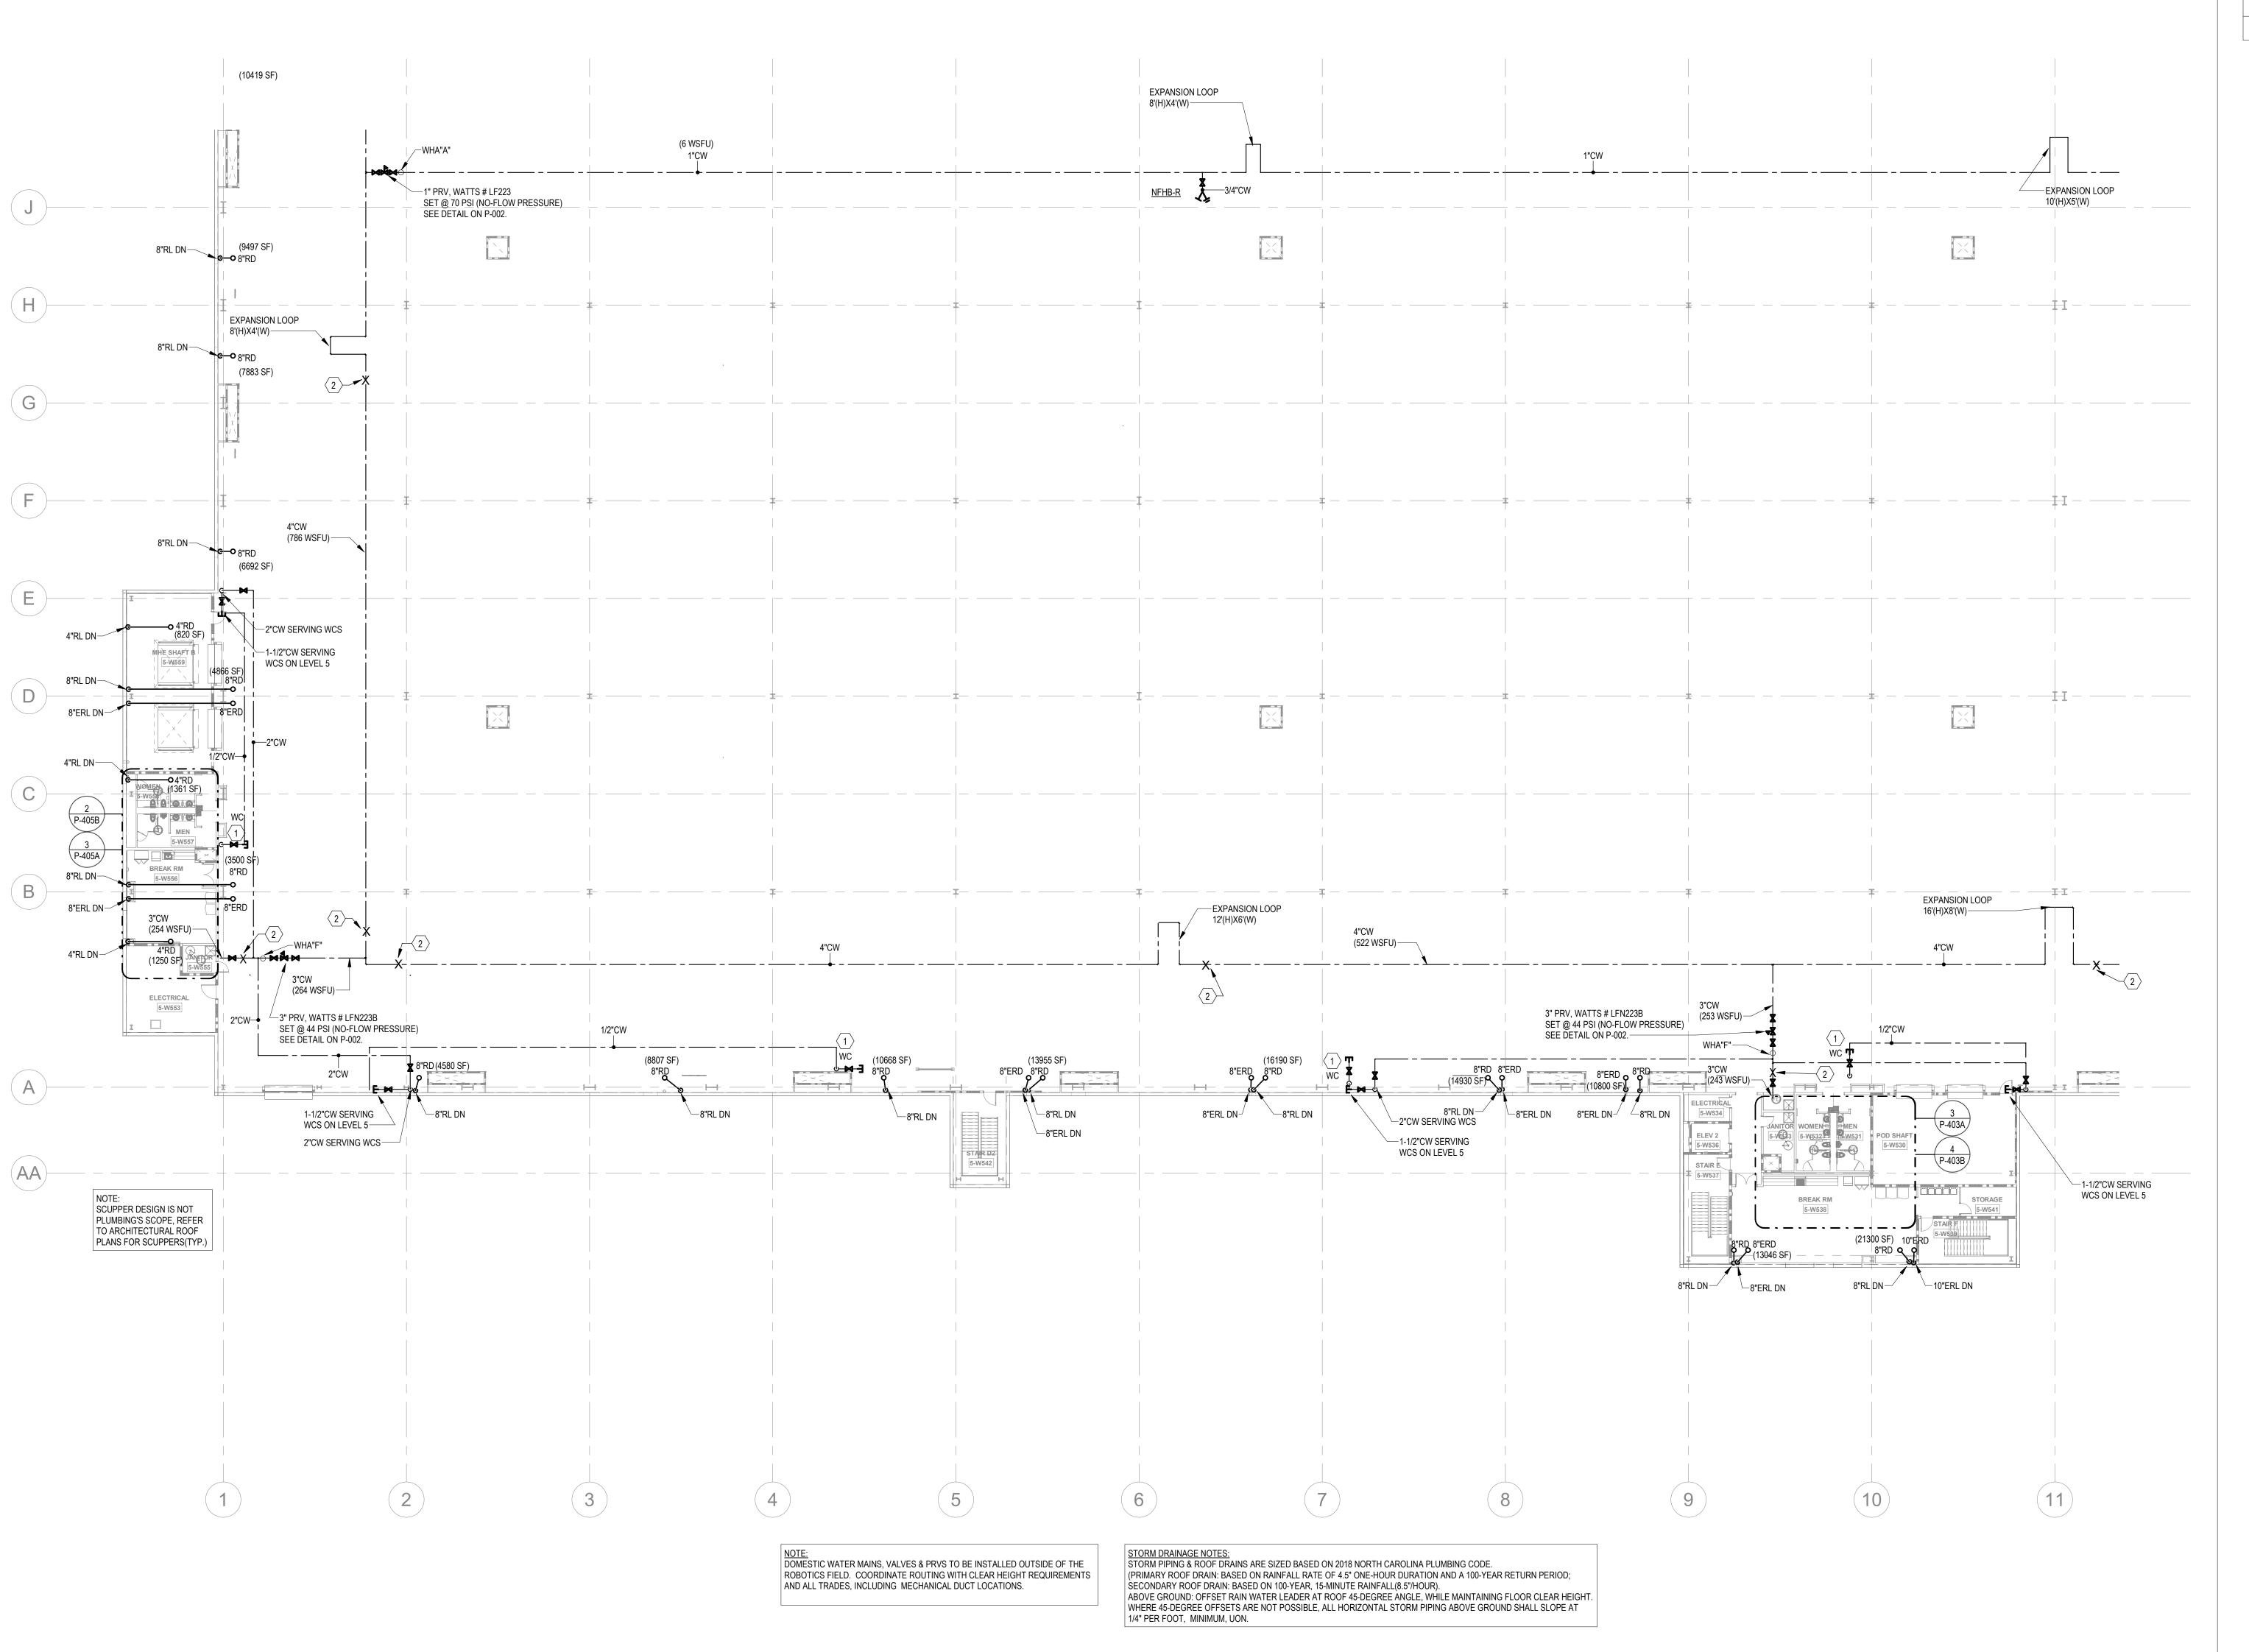
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DATE PROJECT NO 2021-136 SHEET TITLE PARTIAL FLOOR PLAN -

LEVEL 5 A -PLUMBING

SHEET NUMBER

P-222



**KEYNOTES** 

- PROVIDE 1/2" WATER TAP WITH BALL VALVE AND COPPER MANIFOLD. ROUTE 1/2" COPPER PIPING FROM TAP TO EACH OWNER PROVIDED WATER COOLER. STUB COPPER PIPING 24" ABOVE FLOOR AT WATER COOLER LOCATION. PROVIDE 1/2" X 3/8" ANGLE STOP SUPPLY VALVE. ALL LOCATIONS TO BE REVIEWED BY TENANT PRIOR TO INSTALLATION.
- PROVIDE LONGITUDINAL AND TRANSVERSE BRACING. SEE DETAILS

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 PROJECT NO

 01/21/22
 2021-136
 SHEET TITLE PARTIAL FLOOR PLAN -

LEVEL 5 B -PLUMBING

P-223

NOT FOR CONSTRUCTION

SHEET NUMBER

**FLOOR KEY PLAN** 

**KEYNOTES** 

PROVIDE 1/2" WATER TAP WITH BALL VALVE AND COPPER MANIFOLD. ROUTE 1/2" COPPER PIPING FROM TAP TO EACH OWNER PROVIDED WATER COOLER. STUB COPPER PIPING 24" ABOVE FLOOR AT WATER COOLER LOCATION. PROVIDE 1/2" X 3/8" ANGLE STOP SUPPLY VALVE. ALL LOCATIONS TO BE REVIEWED BY TENANT PRIOR TO INSTALLATION. PROVIDE LONGITUDINAL AND TRANSVERSE BRACING. SEE DETAILS ON P-003.

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**WHALE** 

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DATE PROJECT NO 2021-136

FLOOR PLAN -

LEVEL 5 C -

PLUMBING

SHEET NUMBER

SHEET TITLE


PARTIAL

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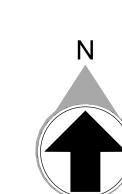
STORM DRAINAGE NOTES: STORM PIPING & ROOF DRAINS ARE SIZED BASED ON 2018 NORTH CAROLINA PLUMBING CODE. (PRIMARY ROOF DRAIN: BASED ON RAINFALL RATE OF 4.5" ONE-HOUR DURATION AND A 100-YEAR RETURN PERIOD; SECONDARY ROOF DRAIN: BASED ON 100-YEAR, 15-MINUTE RAINFALL(8.5"/HOUR). ABOVE GROUND: OFFSET RAIN WATER LEADER AT ROOF 45-DEGREE ANGLE, WHILE MAINTAINING FLOOR CLEAR HEIGHT. WHERE 45-DEGREE OFFSETS ARE NOT POSSIBLE, ALL HORIZONTAL STORM PIPING ABOVE GROUND SHALL SLOPE AT

1/4" PER FOOT, MINIMUM, UON.

NOTE:
DOMESTIC WATER MAINS, VALVES & PRVS TO BE INSTALLED OUTSIDE OF THE ROBOTICS FIELD. COORDINATE ROUTING WITH CLEAR HEIGHT REQUIREMENTS AND ALL TRADES, INCLUDING MECHANICAL DUCT LOCATIONS.

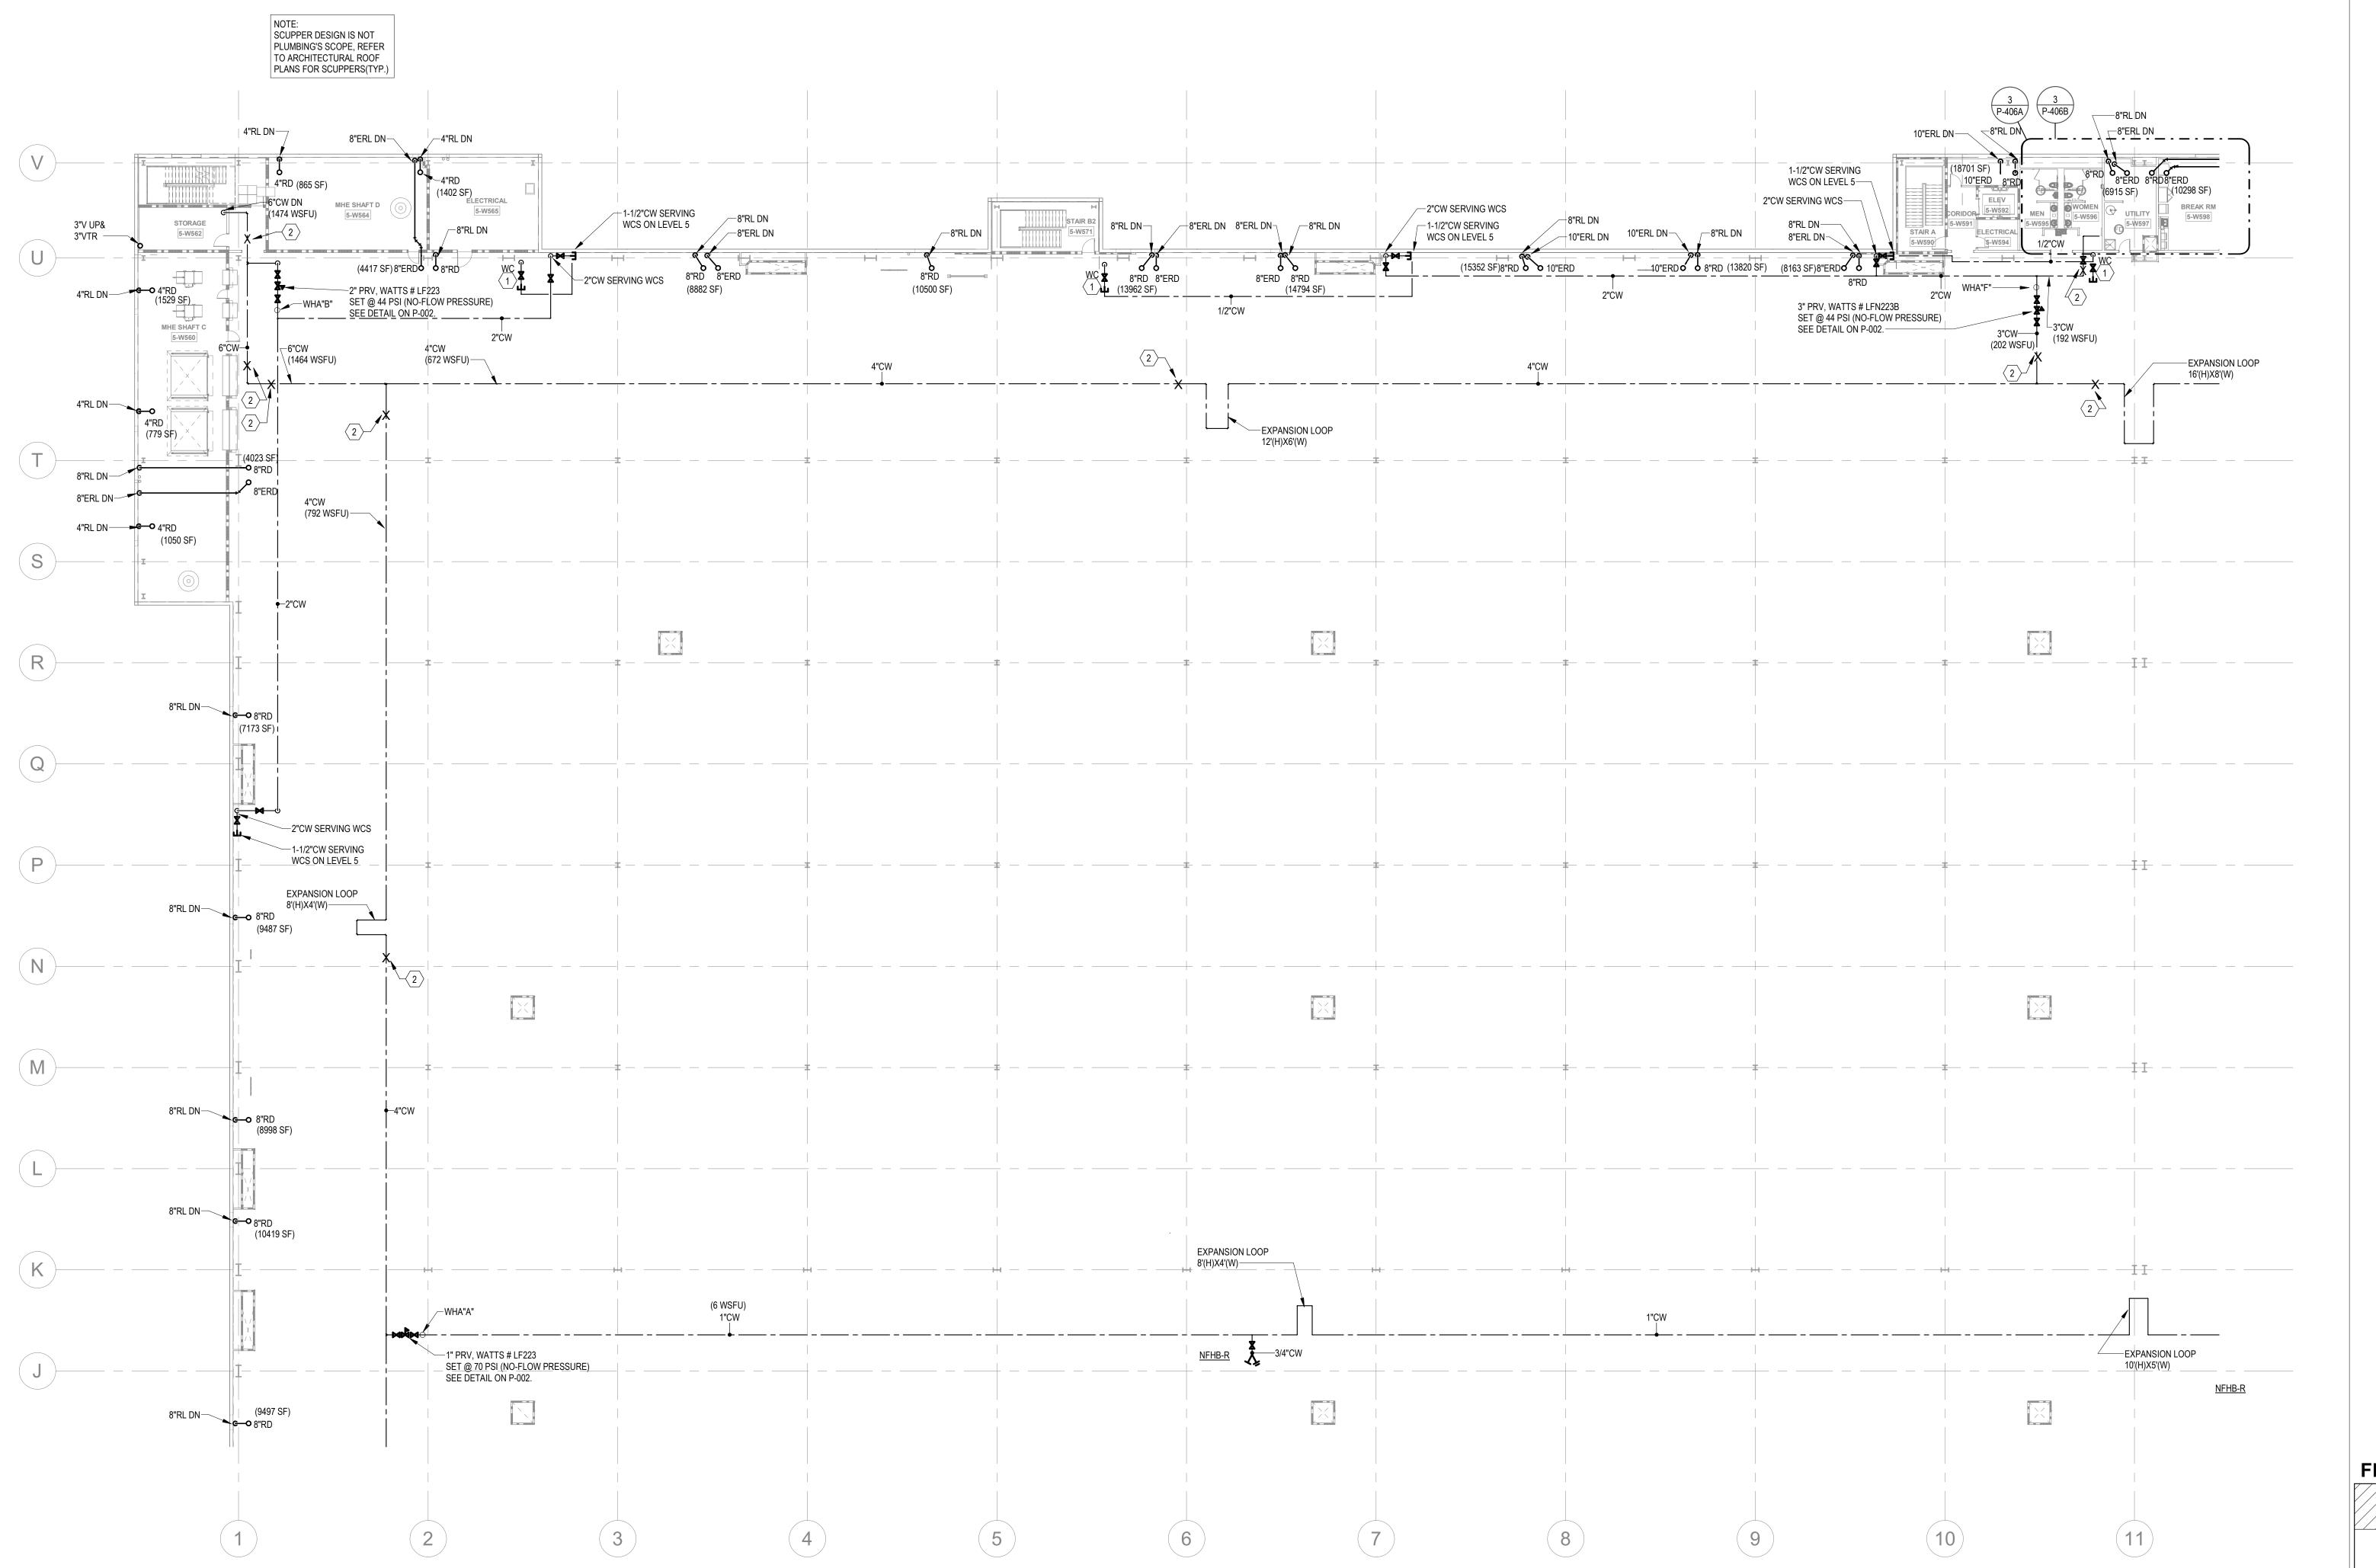

**FLOOR KEY PLAN** 



PARTIAL FLOOR PLANS - LEVEL 5 - C - PLUMBING

1" = 20'-0"

NOT FOR CONSTRUCTION

P-224

**KEYNOTES** PROVIDE 1/2" WATER TAP WITH BALL VALVE AND COPPER MANIFOLD. ROUTE 1/2" COPPER PIPING FROM TAP TO EACH OWNER PROVIDED WATER COOLER. STUB COPPER PIPING 24" ABOVE MACGREGOR ASSOCIATES FLOOR AT WATER COOLER LOCATION. PROVIDE 1/2" X 3/8" ANGLE STOP SUPPLY VALVE. ALL LOCATIONS TO BE REVIEWED BY TENANT PRIOR TO INSTALLATION. PROVIDE LONGITUDINAL AND TRANSVERSE BRACING. SEE DETAILS **ARCHITECTS** ON P-003. 2727 Paces Ferry Road SE Building Two, Suite 1400 Atlanta, Georgia 30339 T 770.432.9400 F 770.432.9934 STORM DRAINAGE NOTES: STORM PIPING & ROOF DRAINS ARE SIZED BASED ON 2018 NORTH CAROLINA PLUMBING CODE. NOTE:
DOMESTIC WATER MAINS, VALVES & PRVS TO BE INSTALLED OUTSIDE OF THE ROBOTICS FIELD. COORDINATE ROUTING WITH CLEAR HEIGHT REQUIREMENTS (PRIMARY ROOF DRAIN: BASED ON RAINFALL RATE OF 4.5" ONE-HOUR DURATION AND A 100-YEAR RETURN PERIOD; AND ALL TRADES, INCLUDING MECHANICAL DUCT LOCATIONS. SECONDARY ROOF DRAIN: BASED ON 100-YEAR, 15-MINUTE RAINFALL(8.5"/HOUR). ABOVE GROUND: OFFSET RAIN WATER LEADER AT ROOF 45-DEGREE ANGLE, WHILE MAINTAINING FLOOR CLEAR HEIGHT. WHERE 45-DEGREE OFFSETS ARE NOT POSSIBLE, ALL HORIZONTAL STORM PIPING ABOVE GROUND SHALL SLOPE AT 1/4" PER FOOT, MINIMUM, UON.

> Jordan & Skala Engineers
>
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**PROJECT** 

WILMINGTON, NC


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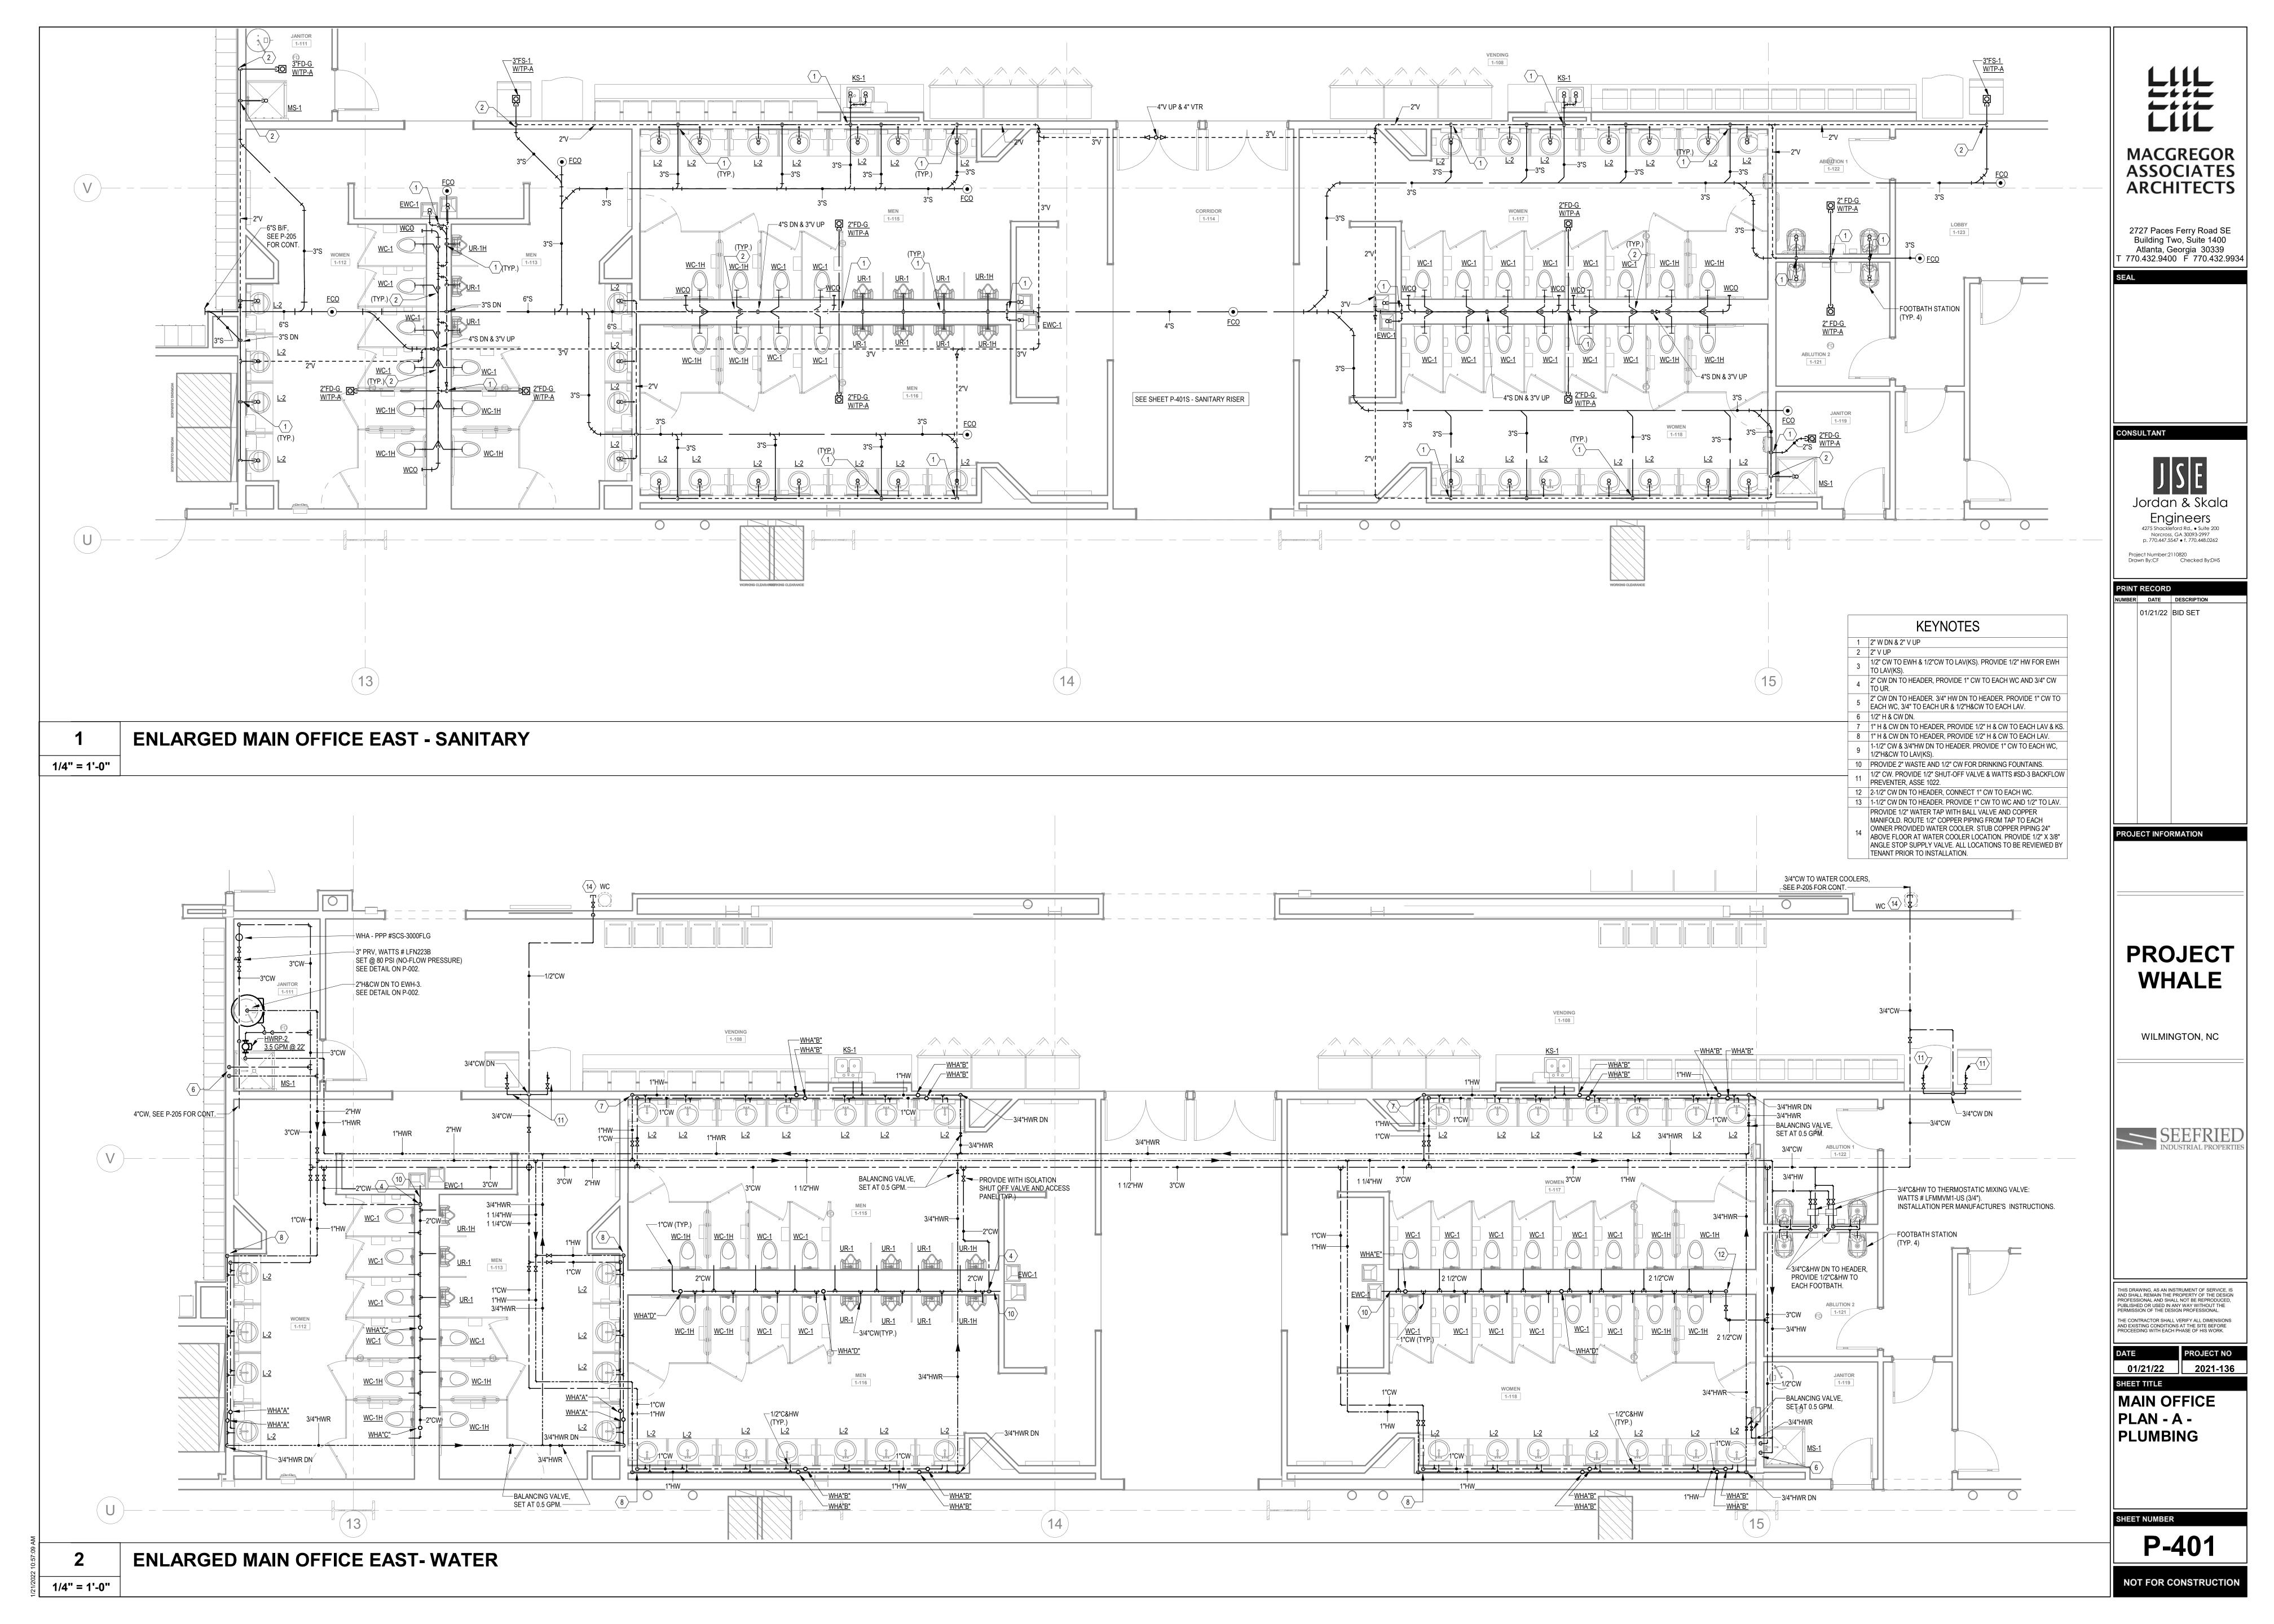
01/21/22 PROJECT NO 2021-136 SHEET TITLE PARTIAL FLOOR PLAN -


LEVEL 5 D -PLUMBING

SHEET NUMBER

P-225 NOT FOR CONSTRUCTION



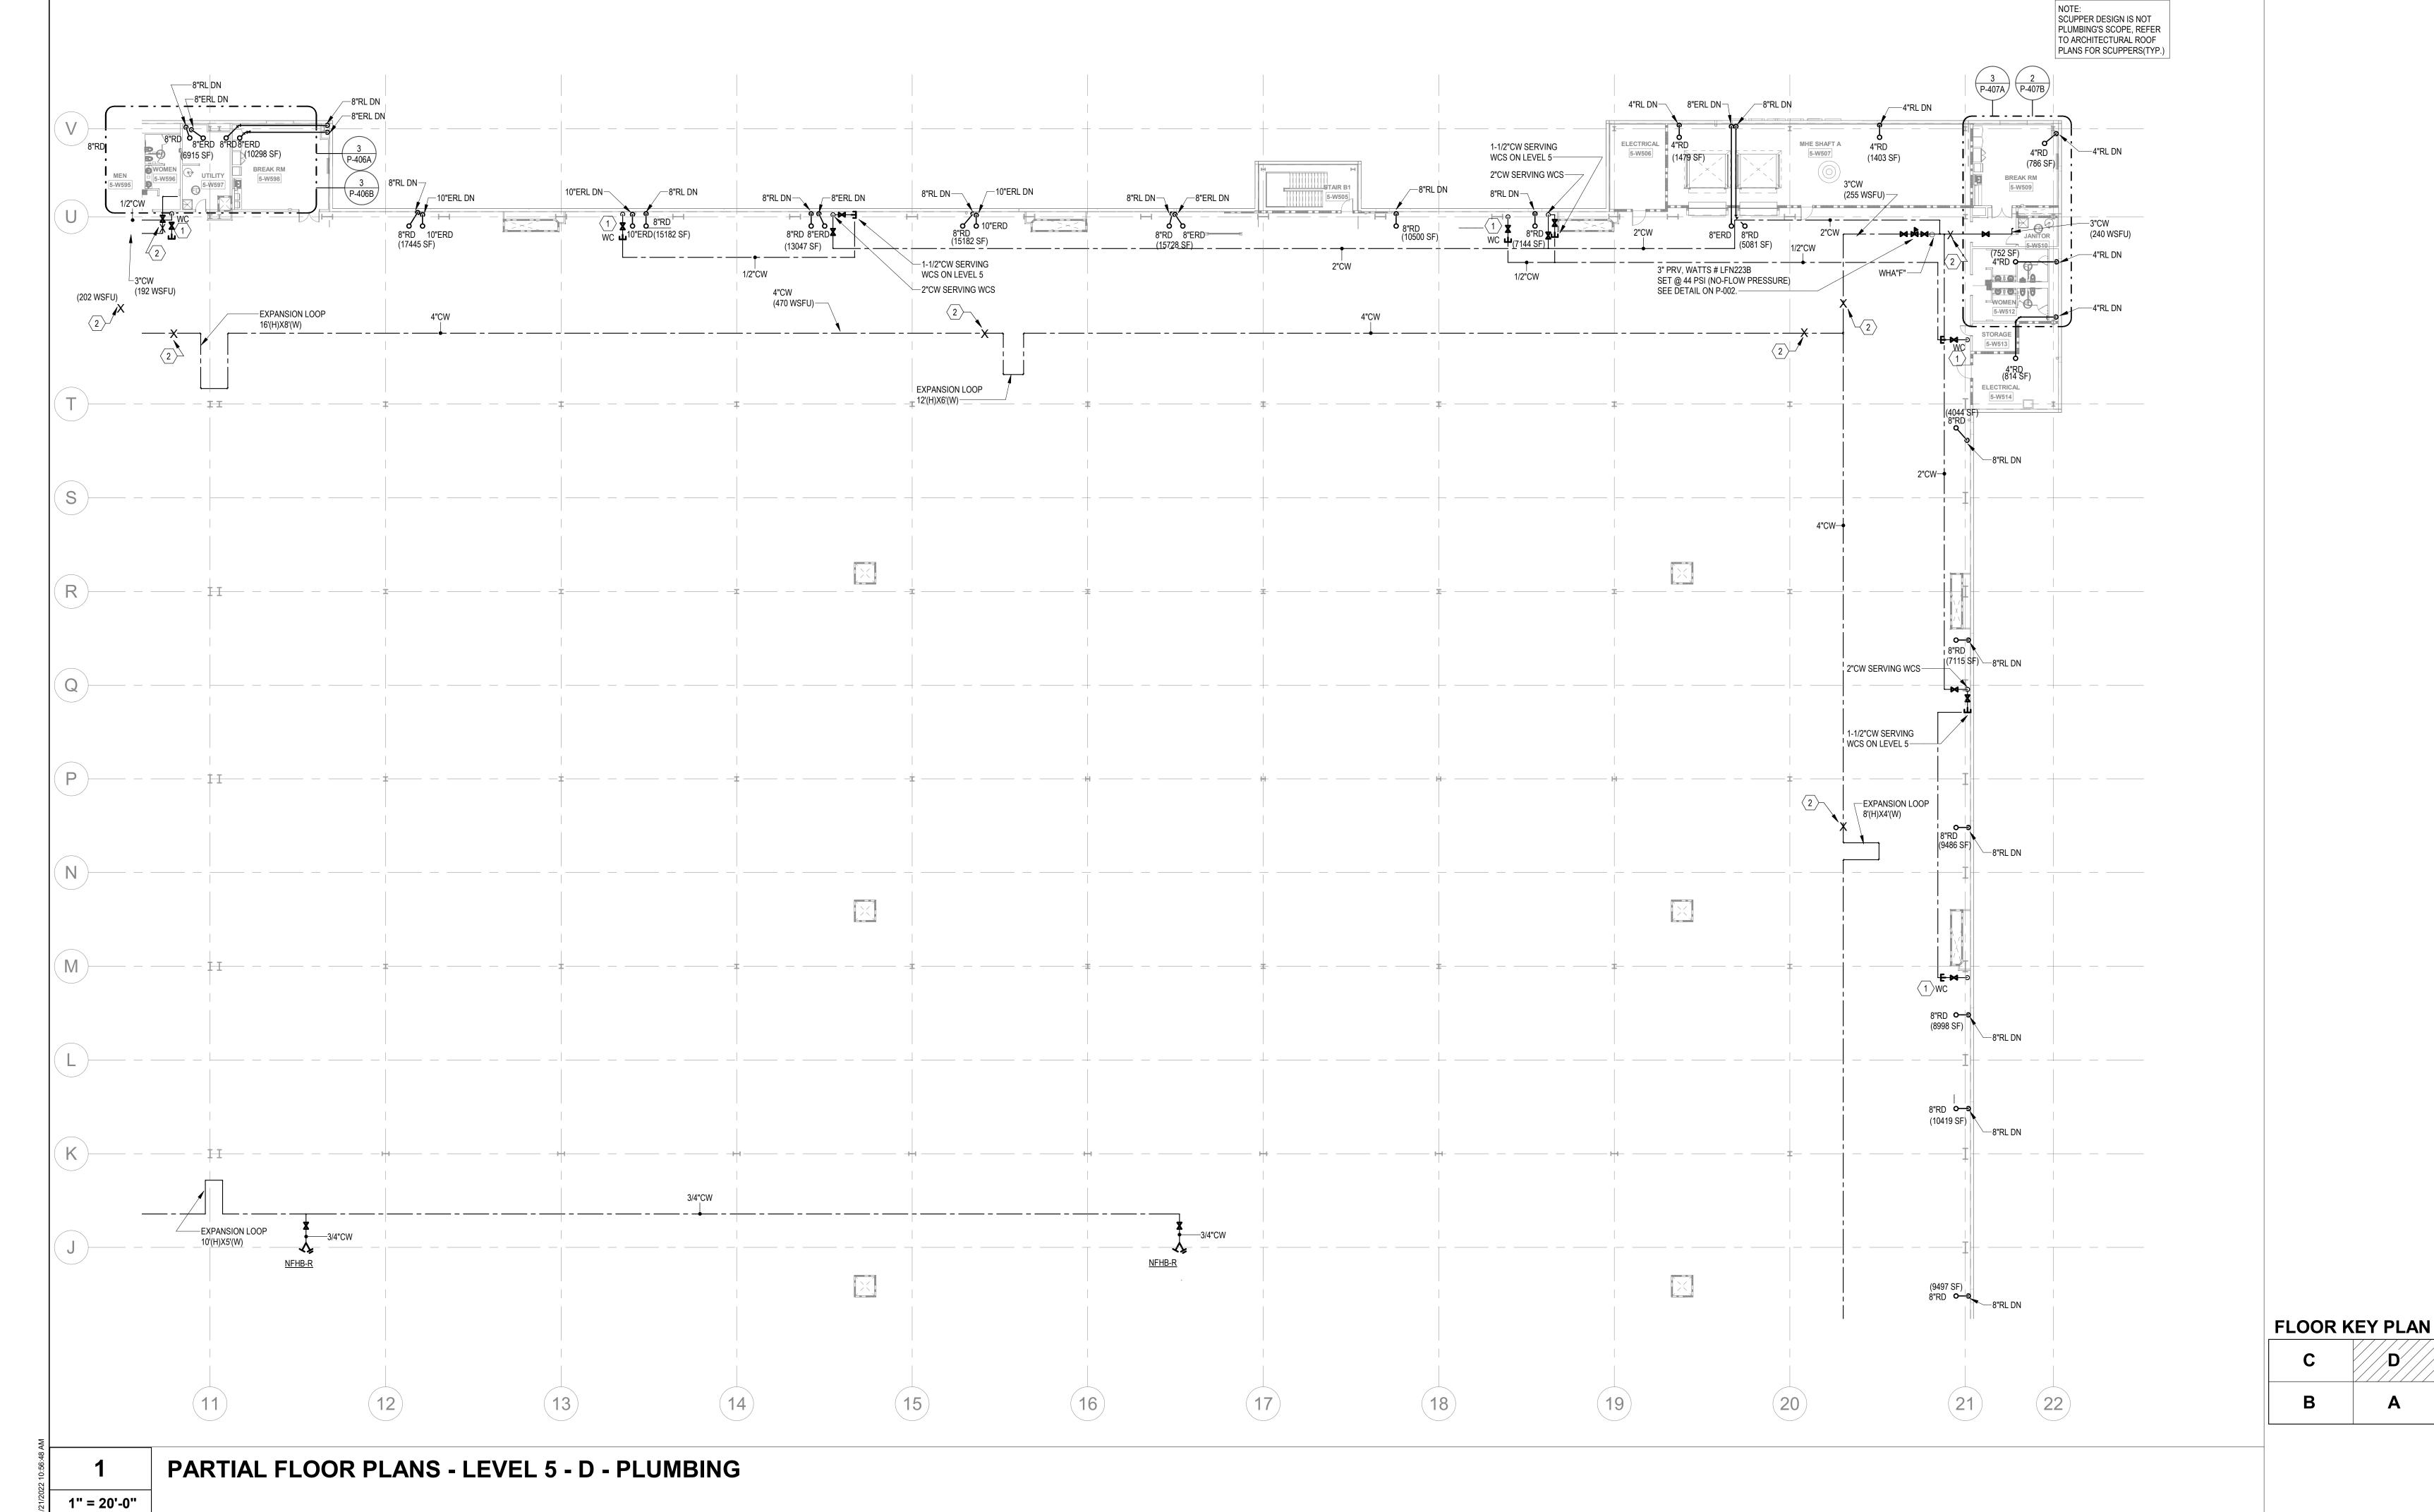

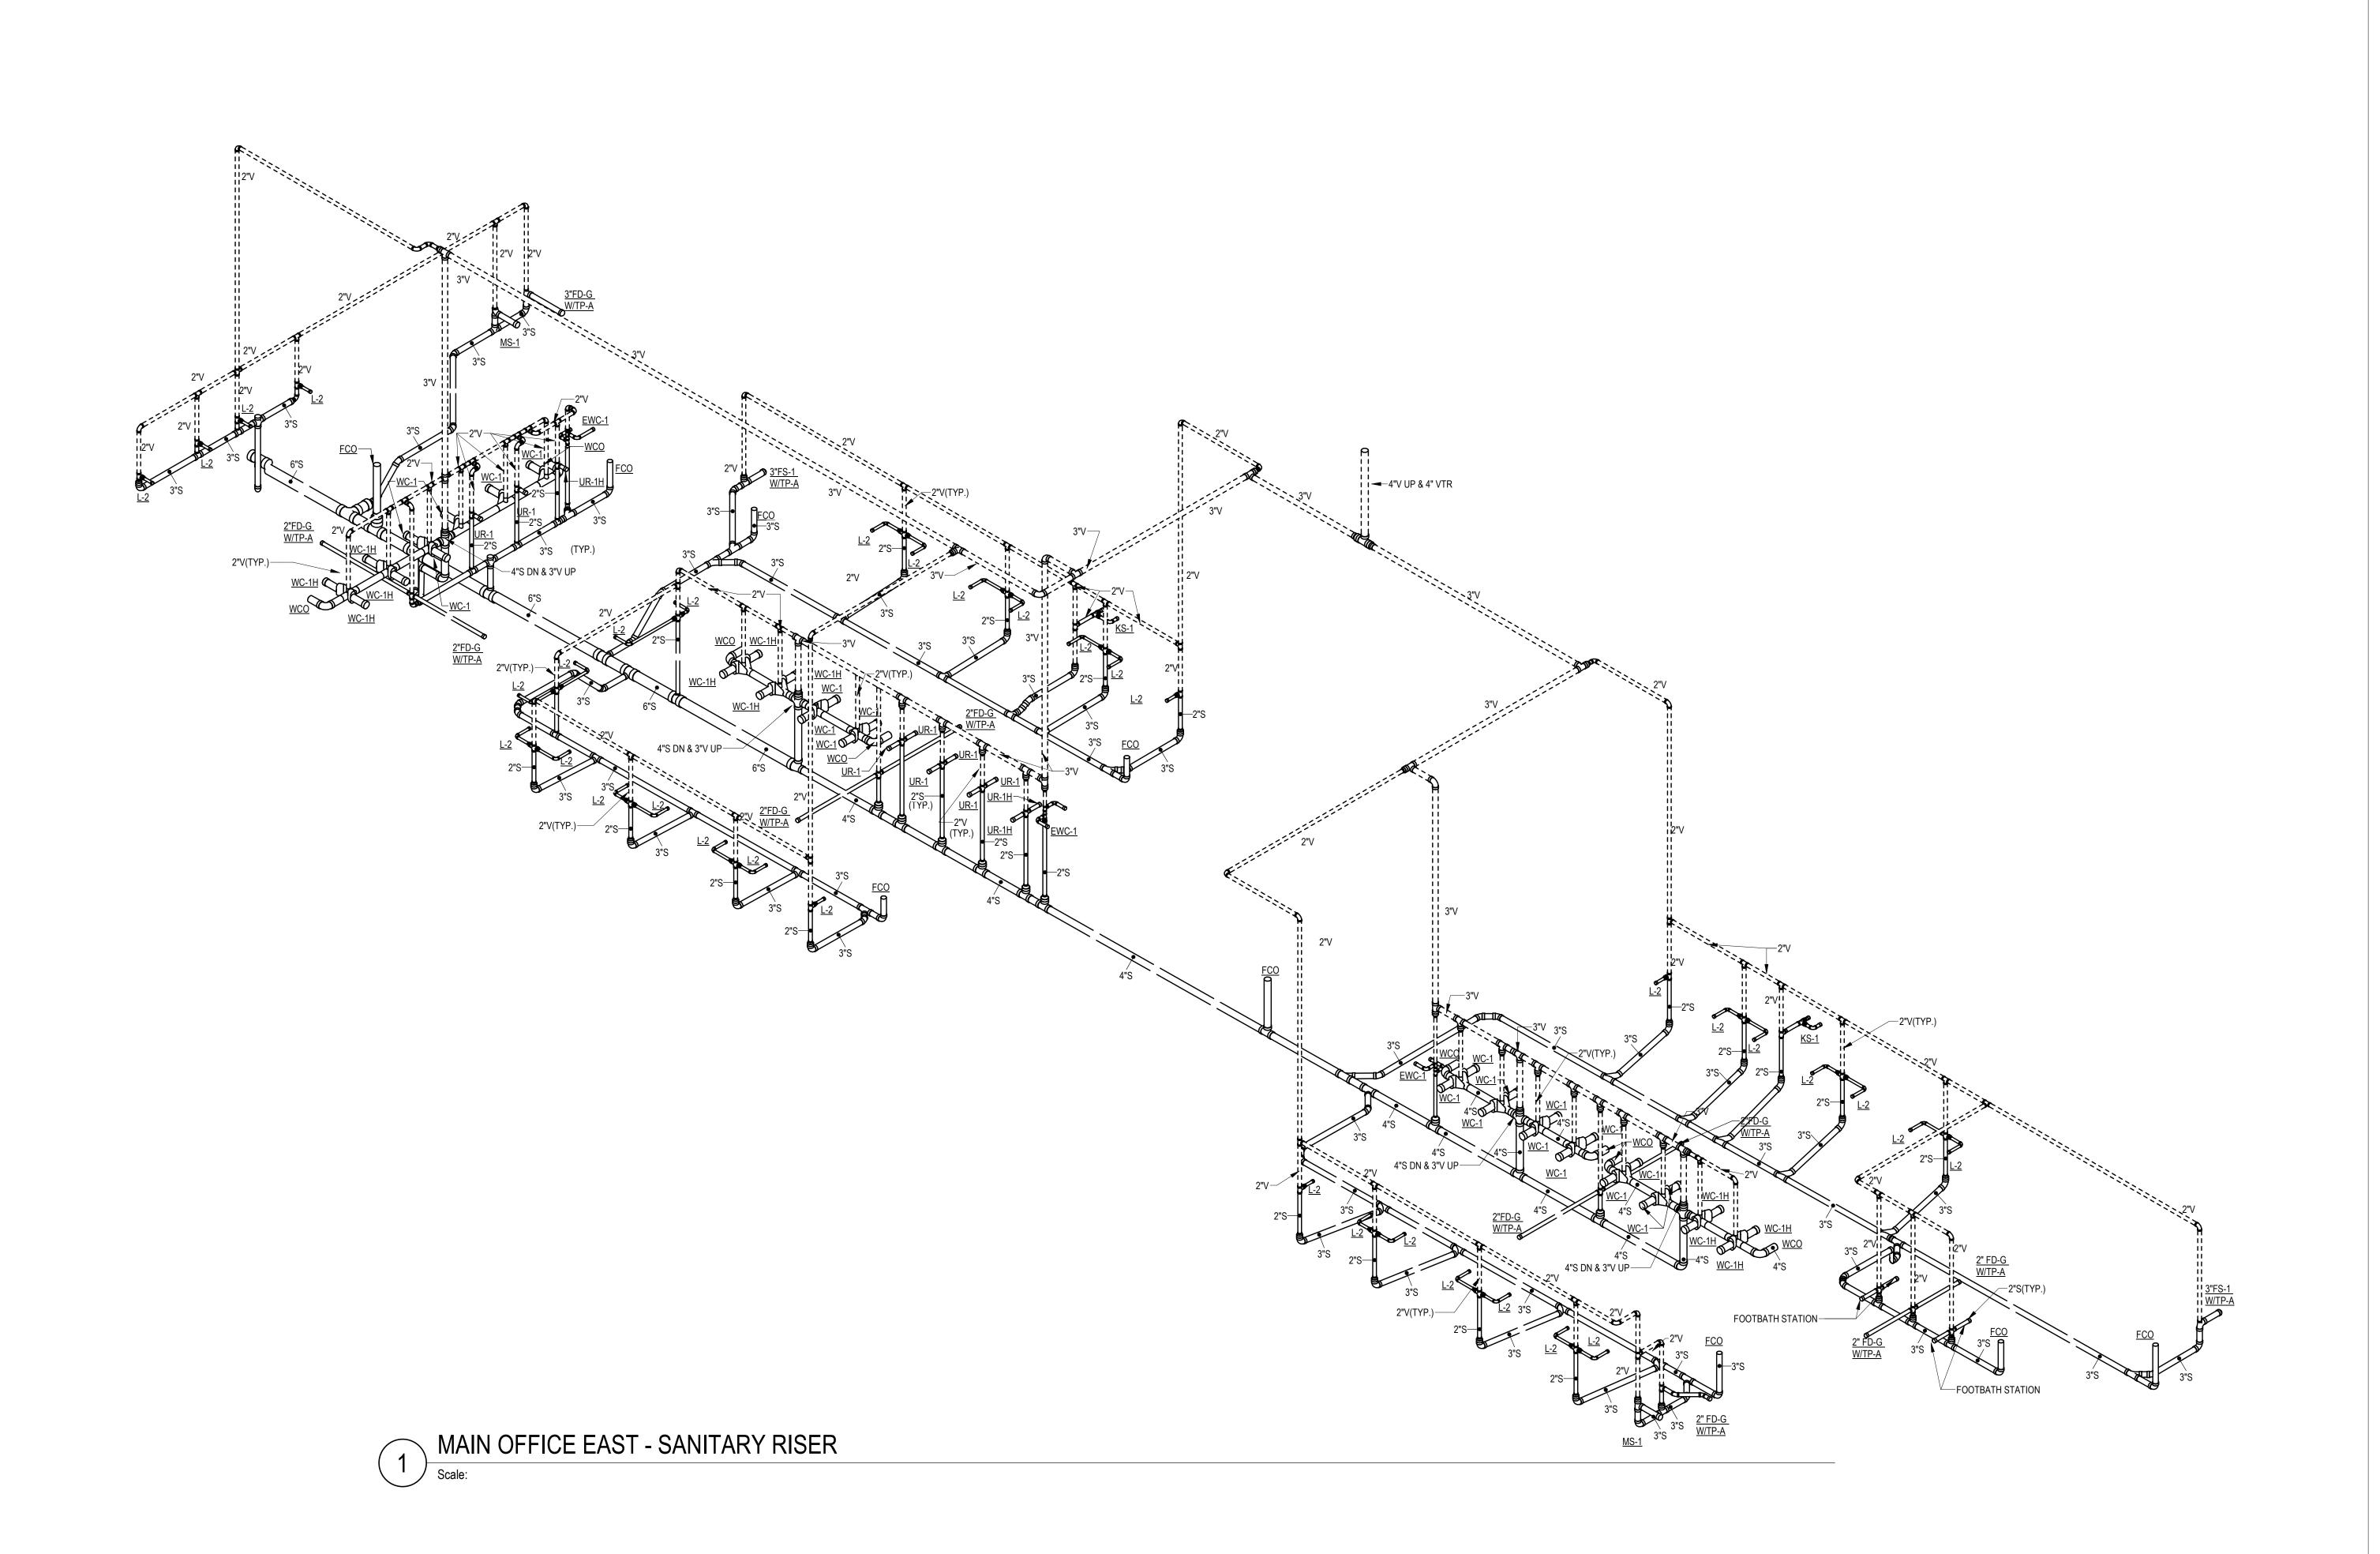

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Project Number:2110820
Drawn By:CF Checked By:DHS

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NUMBER DATE DESCRIPTION

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PROJECT WHALE

WILMINGTON, NC

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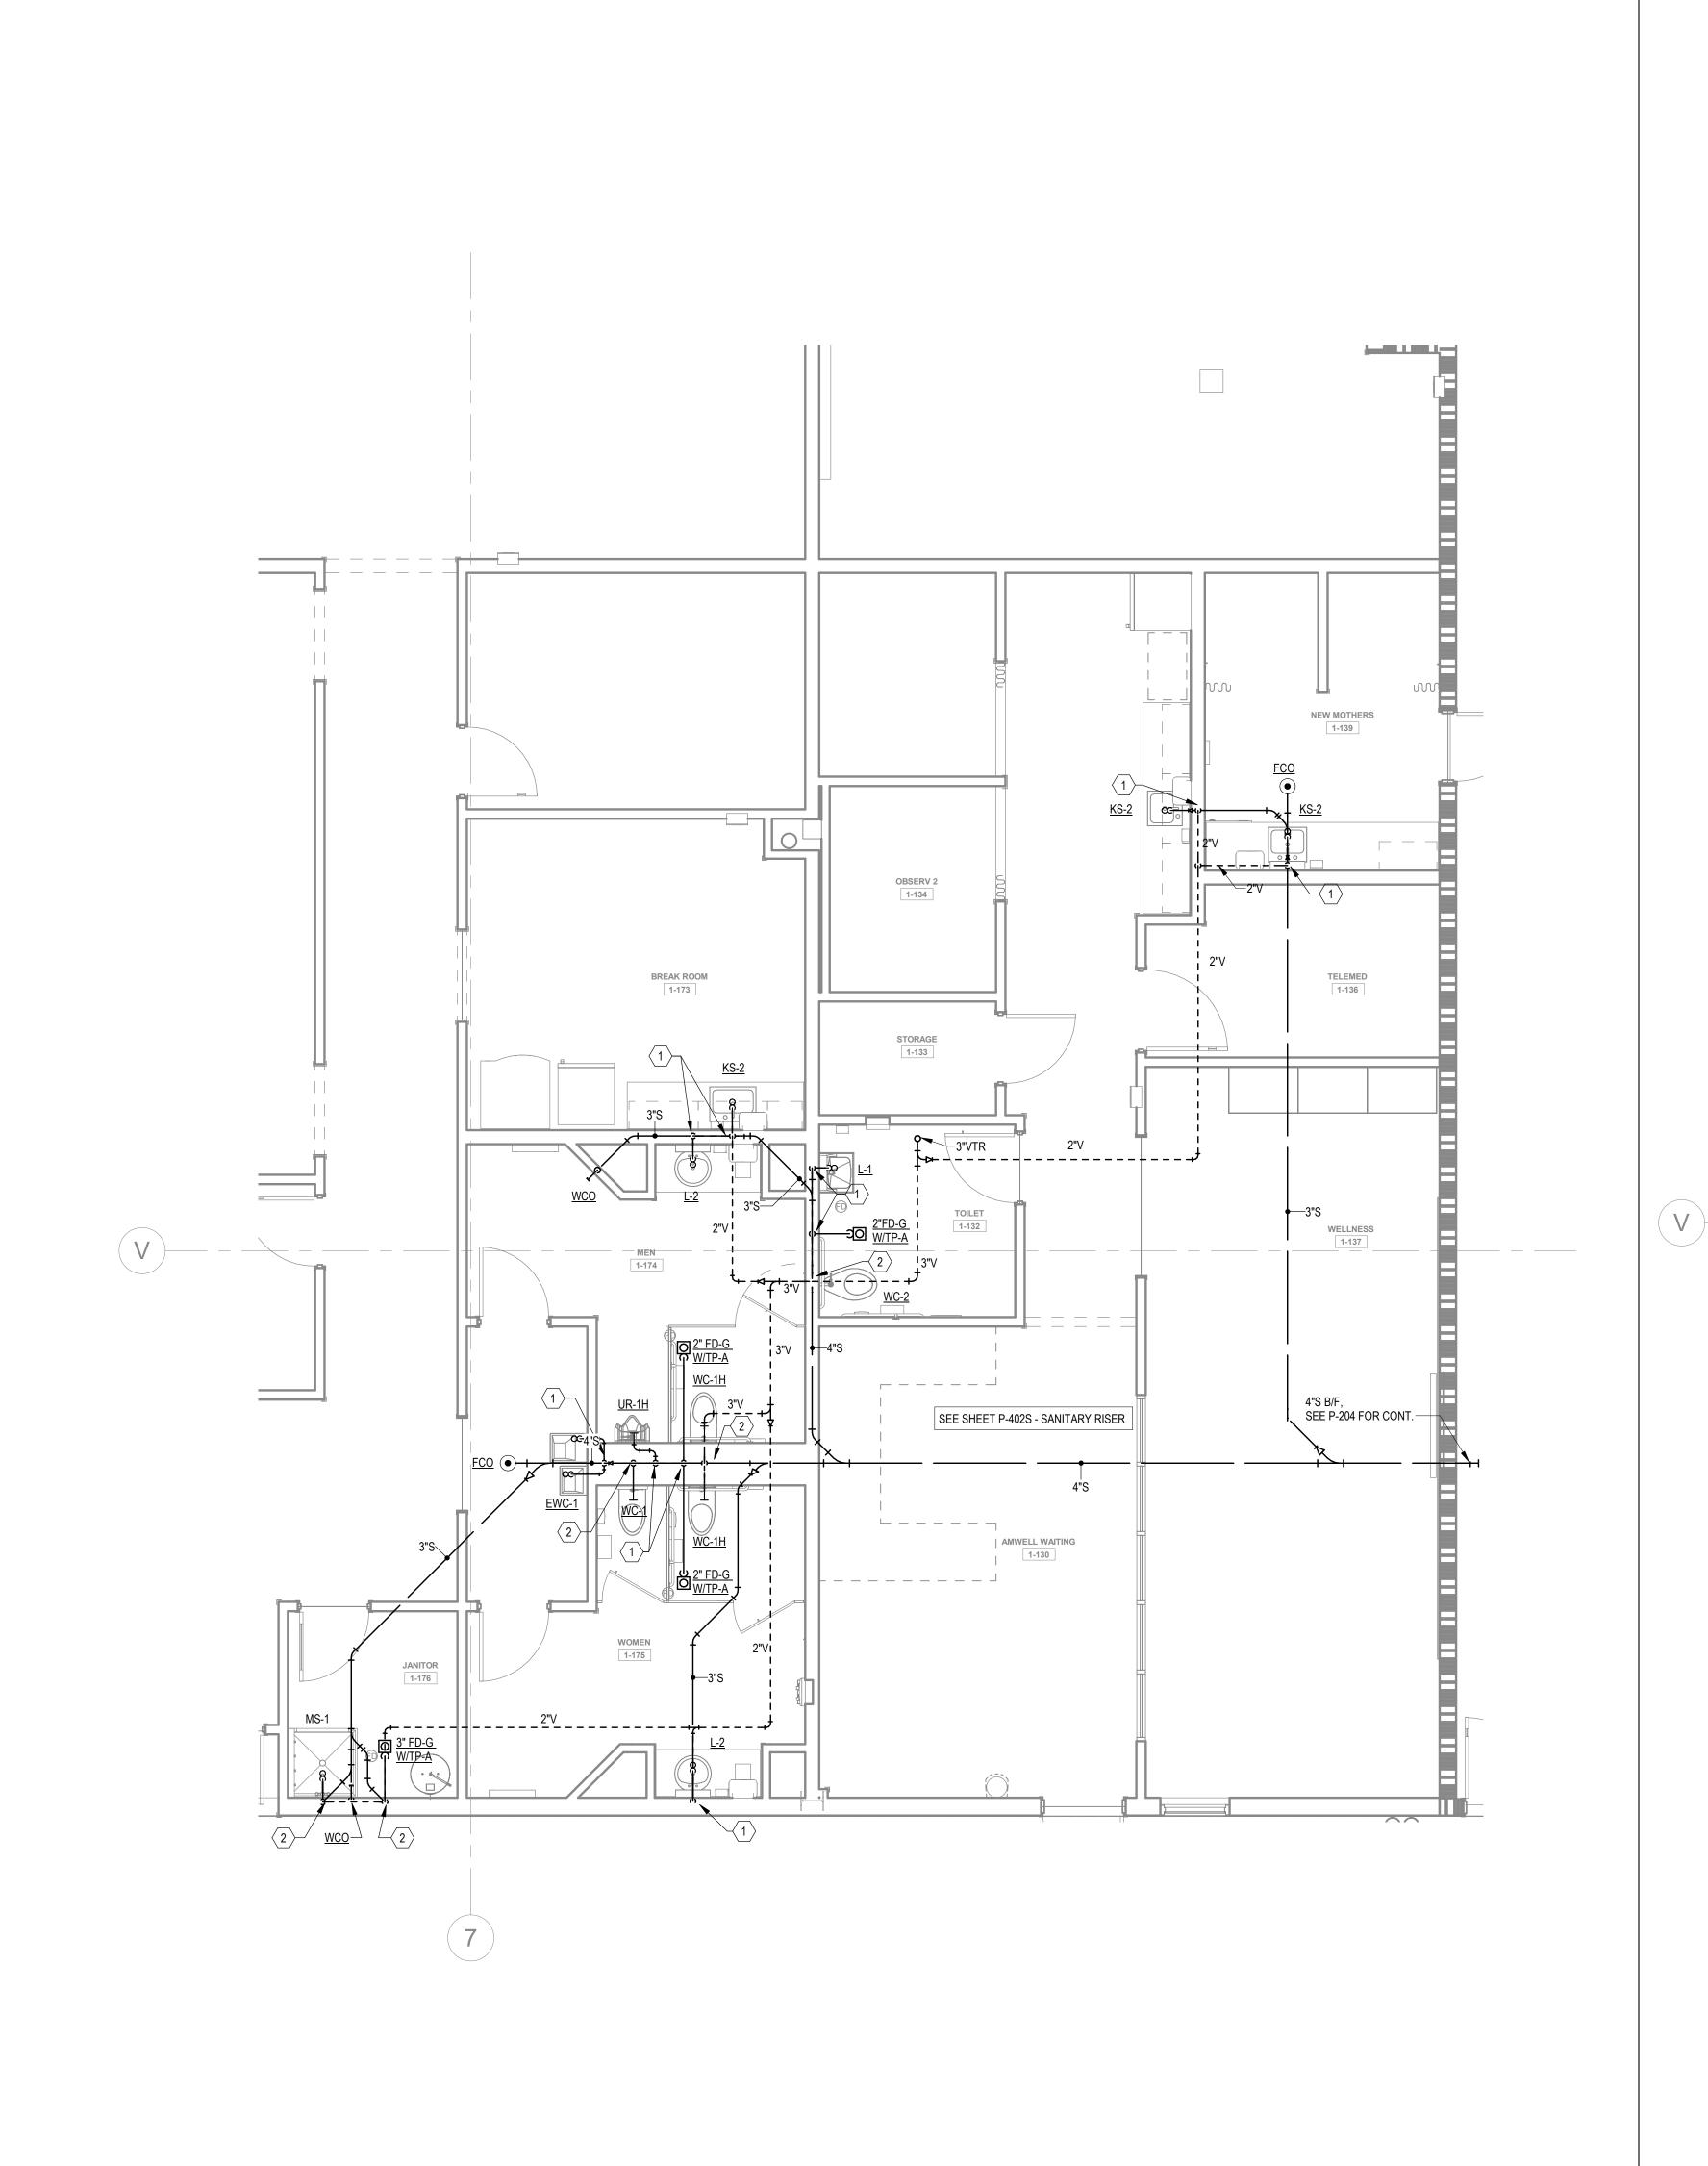
DATE PROJECT NO

01/21/22 2021-136

SHEET TITLE

MAIN OFFICE -SANITARY RISER

P-401S



# **KEYNOTES**

1 2" W DN & 2" V UP 2 2" V UP

- 3 1/2" CW TO EWH & 1/2"CW TO LAV(KS). PROVIDE 1/2" HW FOR EWH TO LAV(KS).
- 4 2" CW DN TO HEADER, PROVIDE 1" CW TO EACH WC AND 3/4" CW TO UR. 2" CW DN TO HEADER. 3/4" HW DN TO HEADER. PROVIDE 1" CW TO EACH WC, 3/4" TO EACH UR & 1/2"H&CW TO EACH LAV.
- 6 1/2" H & CW DN. 7 1" H & CW DN TO HEADER, PROVIDE 1/2" H & CW TO EACH LAV & KS.
- 8 1" H & CW DN TO HEADER, PROVIDE 1/2" H & CW TO EACH LAV.
- 9 1-1/2" CW & 3/4"HW DN TO HEADER. PROVIDE 1" CW TO EACH WC, 1/2"H&CW TO LAV(KS).
- 10 PROVIDE 2" WASTE AND 1/2" CW FOR DRINKING FOUNTAINS. 11 1/2" CW. PROVIDE 1/2" SHUT-OFF VALVE & WATTS #SD-3 BACKFLOW PREVENTER, ASSE 1022.

ANGLE STOP SUPPLY VALVE. ALL LOCATIONS TO BE REVIEWED BY

- 12 2-1/2" CW DN TO HEADER, CONNECT 1" CW TO EACH WC. 13 1-1/2" CW DN TO HEADER. PROVIDE 1" CW TO WC AND 1/2" TO LAV.
- PROVIDE 1/2" WATER TAP WITH BALL VALVE AND COPPER MANIFOLD. ROUTE 1/2" COPPER PIPING FROM TAP TO EACH OWNER PROVIDED WATER COOLER. STUB COPPER PIPING 24" ABOVE FLOOR AT WATER COOLER LOCATION. PROVIDE 1/2" X 3/8"

TENANT PRIOR TO INSTALLATION.

Jordan & Skala

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MACGREGOR ASSOCIATES

**ARCHITECTS** 

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PROJECT INFORMATION

PROJECT WHALE

WILMINGTON, NC

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PLAN - B -SANITARY


P-402A

NOT FOR CONSTRUCTION

**ENLARGED CAREER CHOICE CLASSROOM - SANITARY** 

COUNTER FOR CONDENSATE

3"V, SEE P-204 FOR CONT.

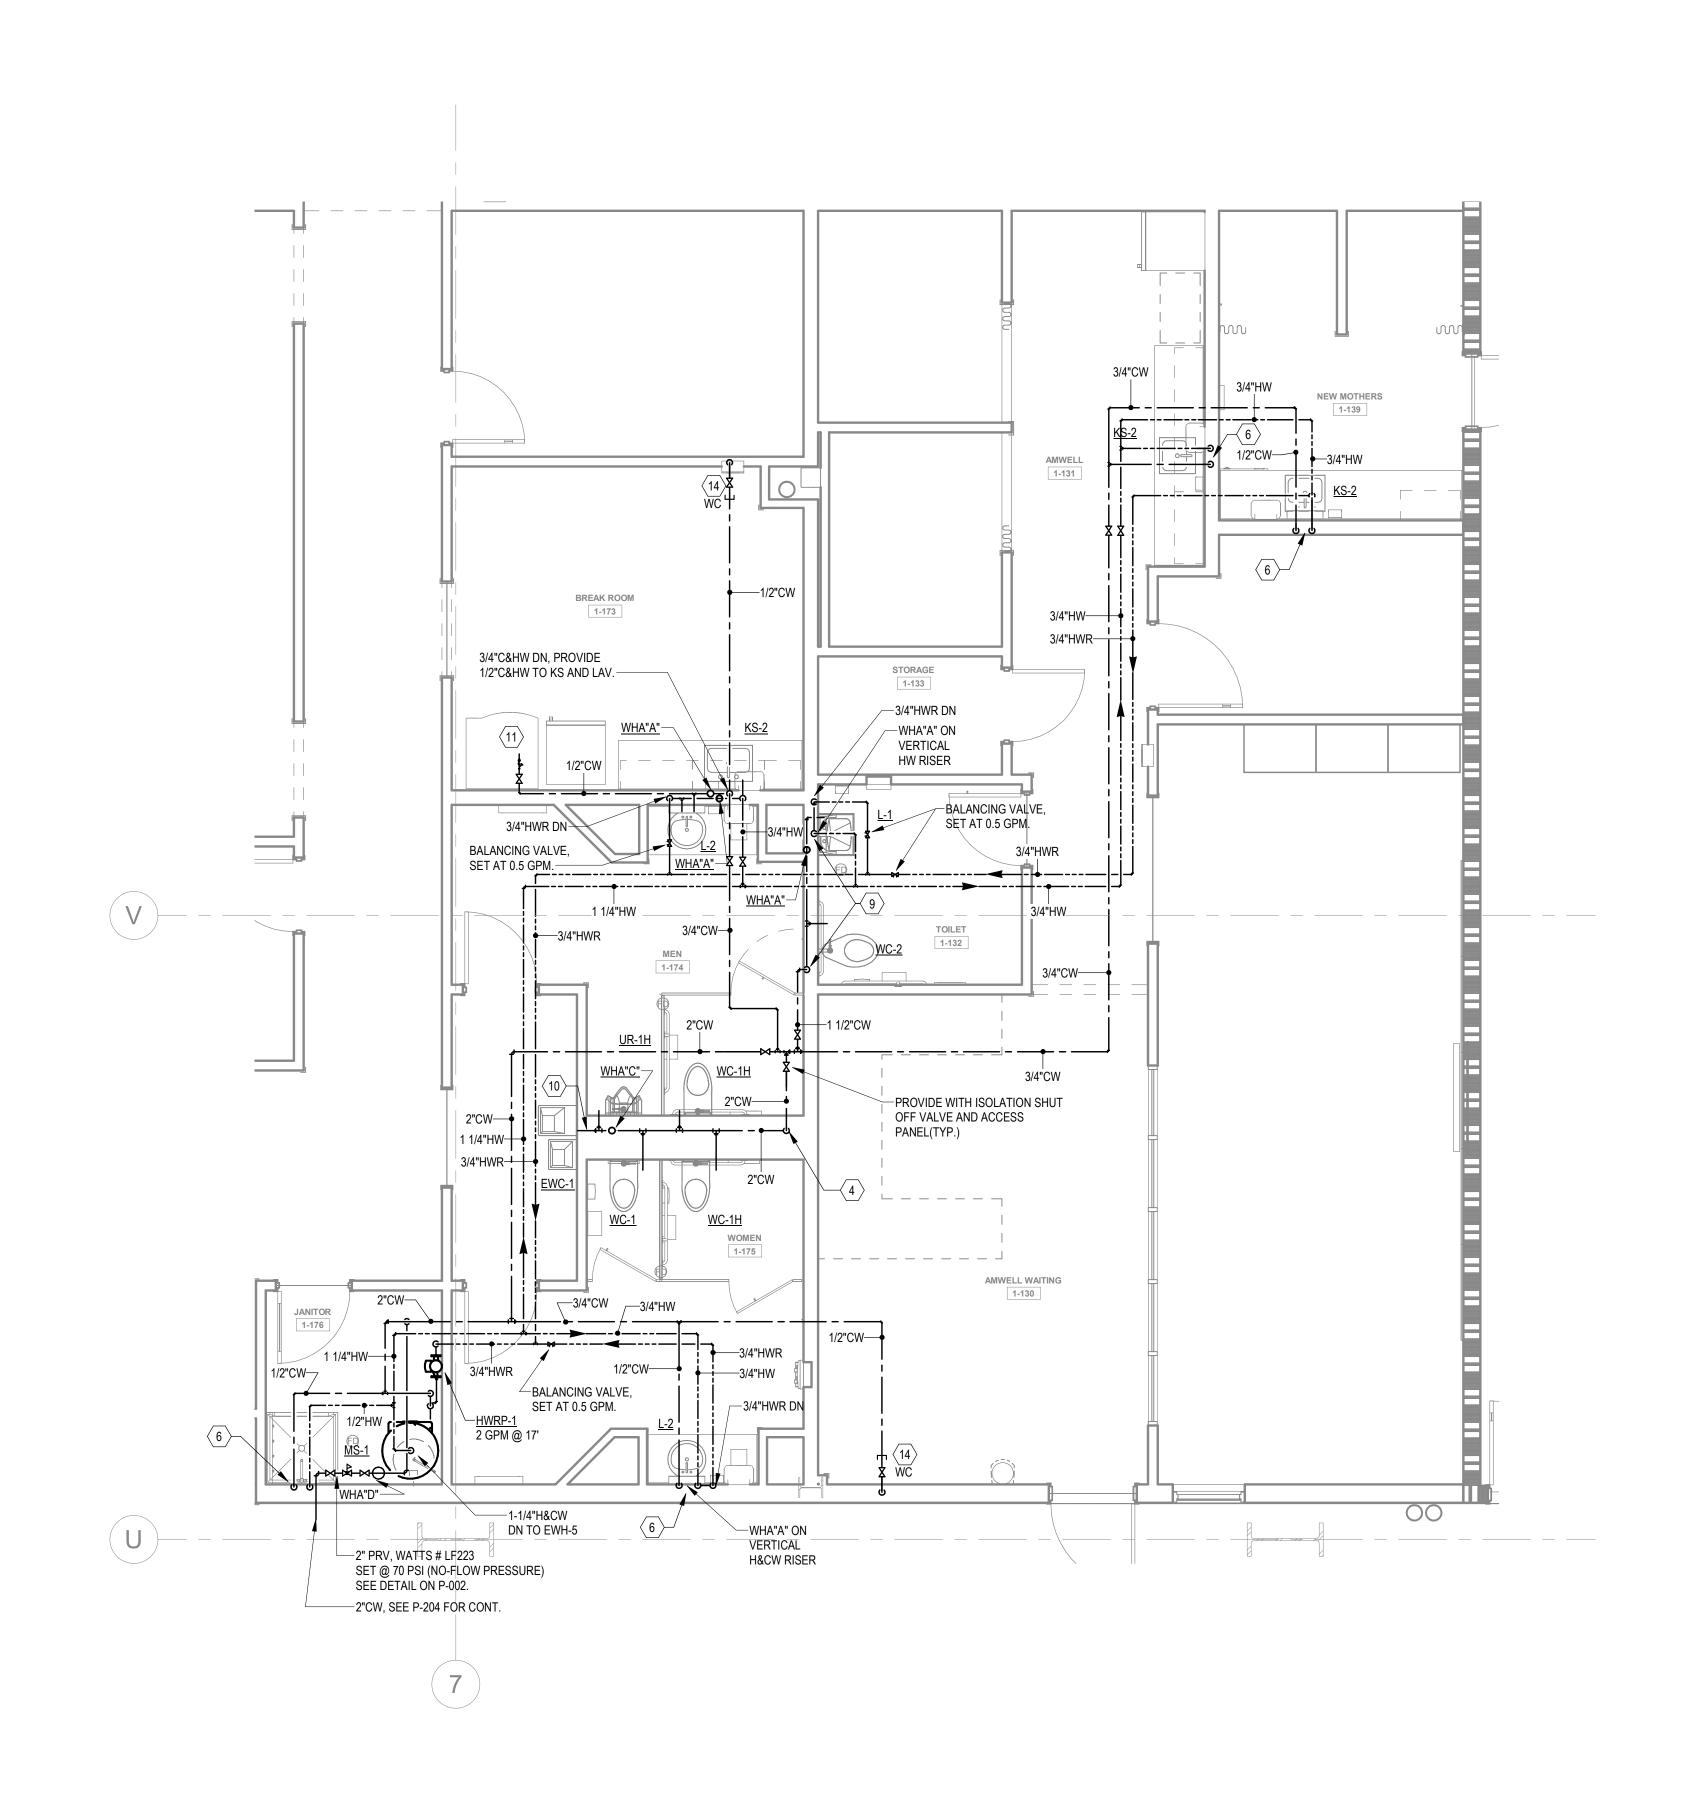

### **KEYNOTES**

1 2" W DN & 2" V UP 2 2" V UP

- 6 1/2" H & CW DN. 7 1" H & CW DN TO HEADER, PROVIDE 1/2" H & CW TO EACH LAV & KS.
- 8 1" H & CW DN TO HEADER, PROVIDE 1/2" H & CW TO EACH LAV.

- 12 2-1/2" CW DN TO HEADER, CONNECT 1" CW TO EACH WC.
- PROVIDE 1/2" WATER TAP WITH BALL VALVE AND COPPER

3 1/2" CW TO EWH & 1/2"CW TO LAV(KS). PROVIDE 1/2" HW FOR EWH TO LAV(KS). 4 2" CW DN TO HEADER, PROVIDE 1" CW TO EACH WC AND 3/4" CW TO UR. 2" CW DN TO HEADER. 3/4" HW DN TO HEADER. PROVIDE 1" CW TO EACH WC, 3/4" TO EACH UR & 1/2"H&CW TO EACH LAV. 9 1-1/2" CW & 3/4"HW DN TO HEADER. PROVIDE 1" CW TO EACH WC, 1/2"H&CW TO LAV(KS). 10 PROVIDE 2" WASTE AND 1/2" CW FOR DRINKING FOUNTAINS. 11 1/2" CW. PROVIDE 1/2" SHUT-OFF VALVE & WATTS #SD-3 BACKFLOW PREVENTER, ASSE 1022. 13 1-1/2" CW DN TO HEADER. PROVIDE 1" CW TO WC AND 1/2" TO LAV. MANIFOLD. ROUTE 1/2" COPPER PIPING FROM TAP TO EACH OWNER PROVIDED WATER COOLER. STUB COPPER PIPING 24" ABOVE FLOOR AT WATER COOLER LOCATION. PROVIDE 1/2" X 3/8" ANGLE STOP SUPPLY VALVE. ALL LOCATIONS TO BE REVIEWED BY TENANT PRIOR TO INSTALLATION.


> Jordan & Skala Engineers
>
> 4275 Shackleford Rd., • Suite 200
> Norcross, GA 30093-2997
> p. 770.447.5547 • f. 770.448.0262 Project Number:2110820 Drawn By:Author Checked By:Checker PRINT RECORD

MACGREGOR ASSOCIATES

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WILMINGTON, NC

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PLAN - B -WATER

P-402B

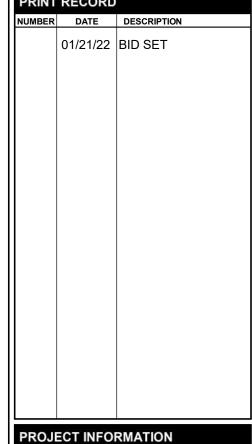
NOT FOR CONSTRUCTION

**ENLARGED CAREER CHOICE CLASSROOM - WATER** 

--- 3/4"CW TO NFHB-R, SEE P-204 FOR CONT.

SEE P-204 FOR CONT.

3/4" PRV, WATTS # LF223 SET @ 60 PSI (NO-FLOW PRESSURE) SEE DETAIL ON P-002.

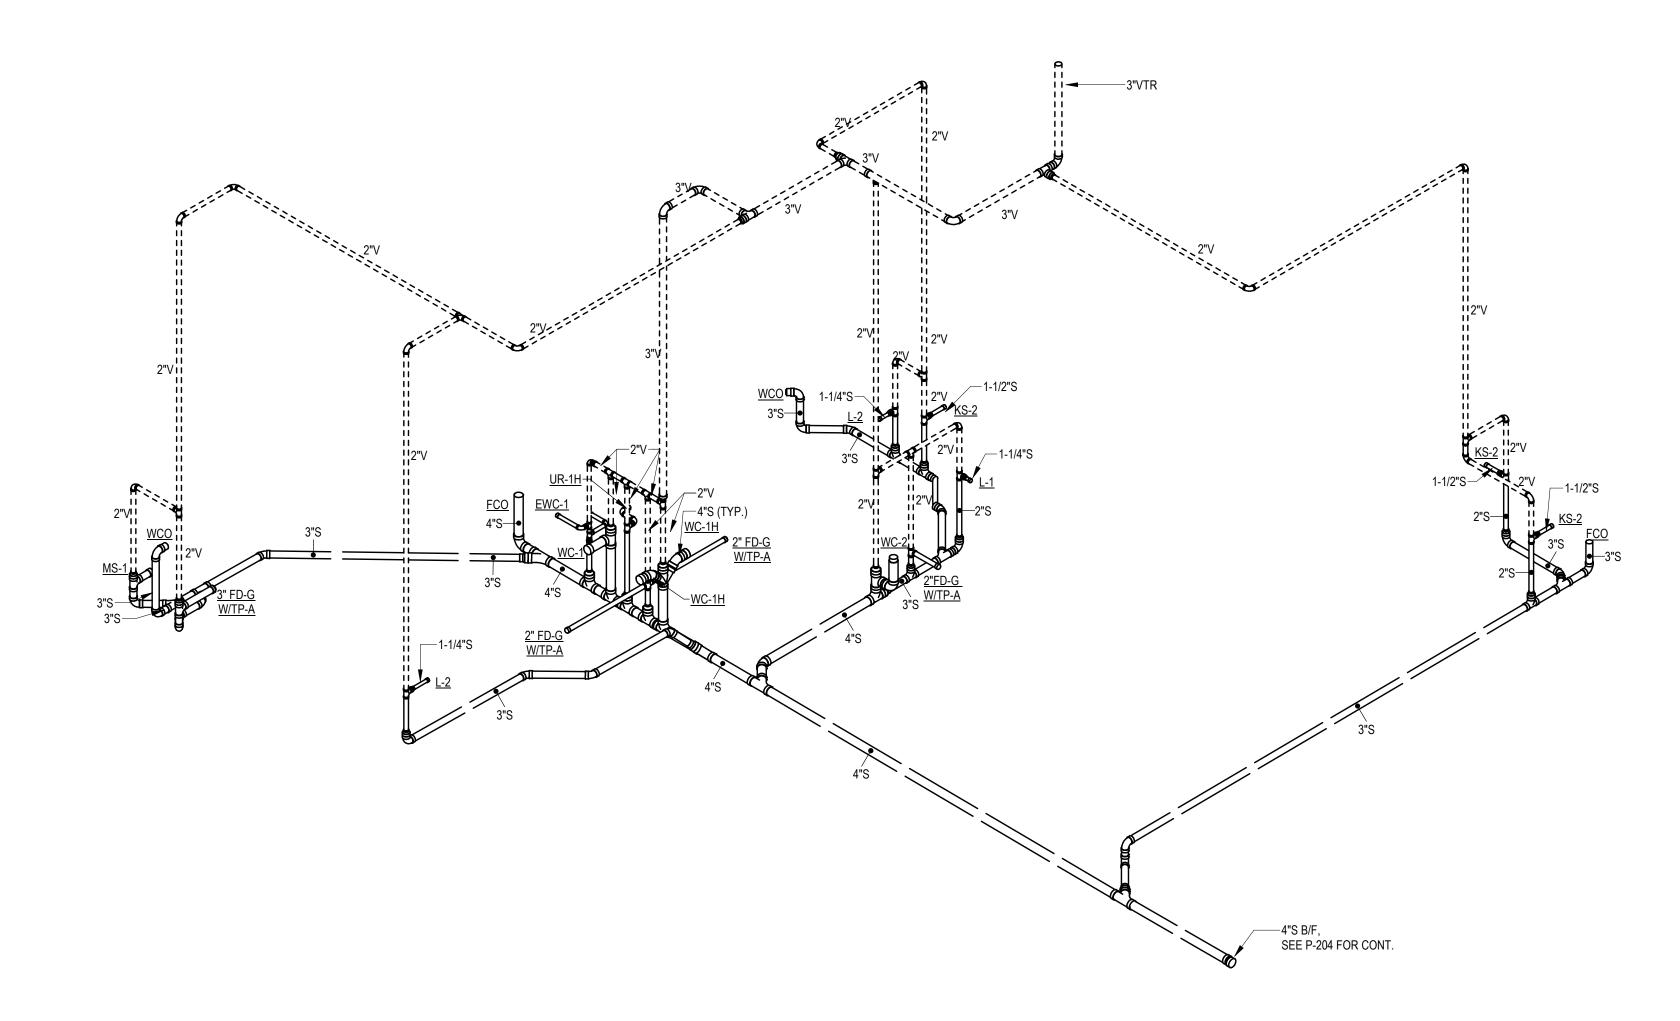

MAIN OFFICE WEST - SANITARY RISER

Scale:

LILL

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Project Number:2110820
Drawn By:CF Checked By:DHS

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NUMBER DATE DESCRIPTION

01/21/22 BID SET

PROJECT INFORMATION

PROJECT WHALE

WILMINGTON, NC

SEEFRIED INDUSTRIAL PROPERTIES

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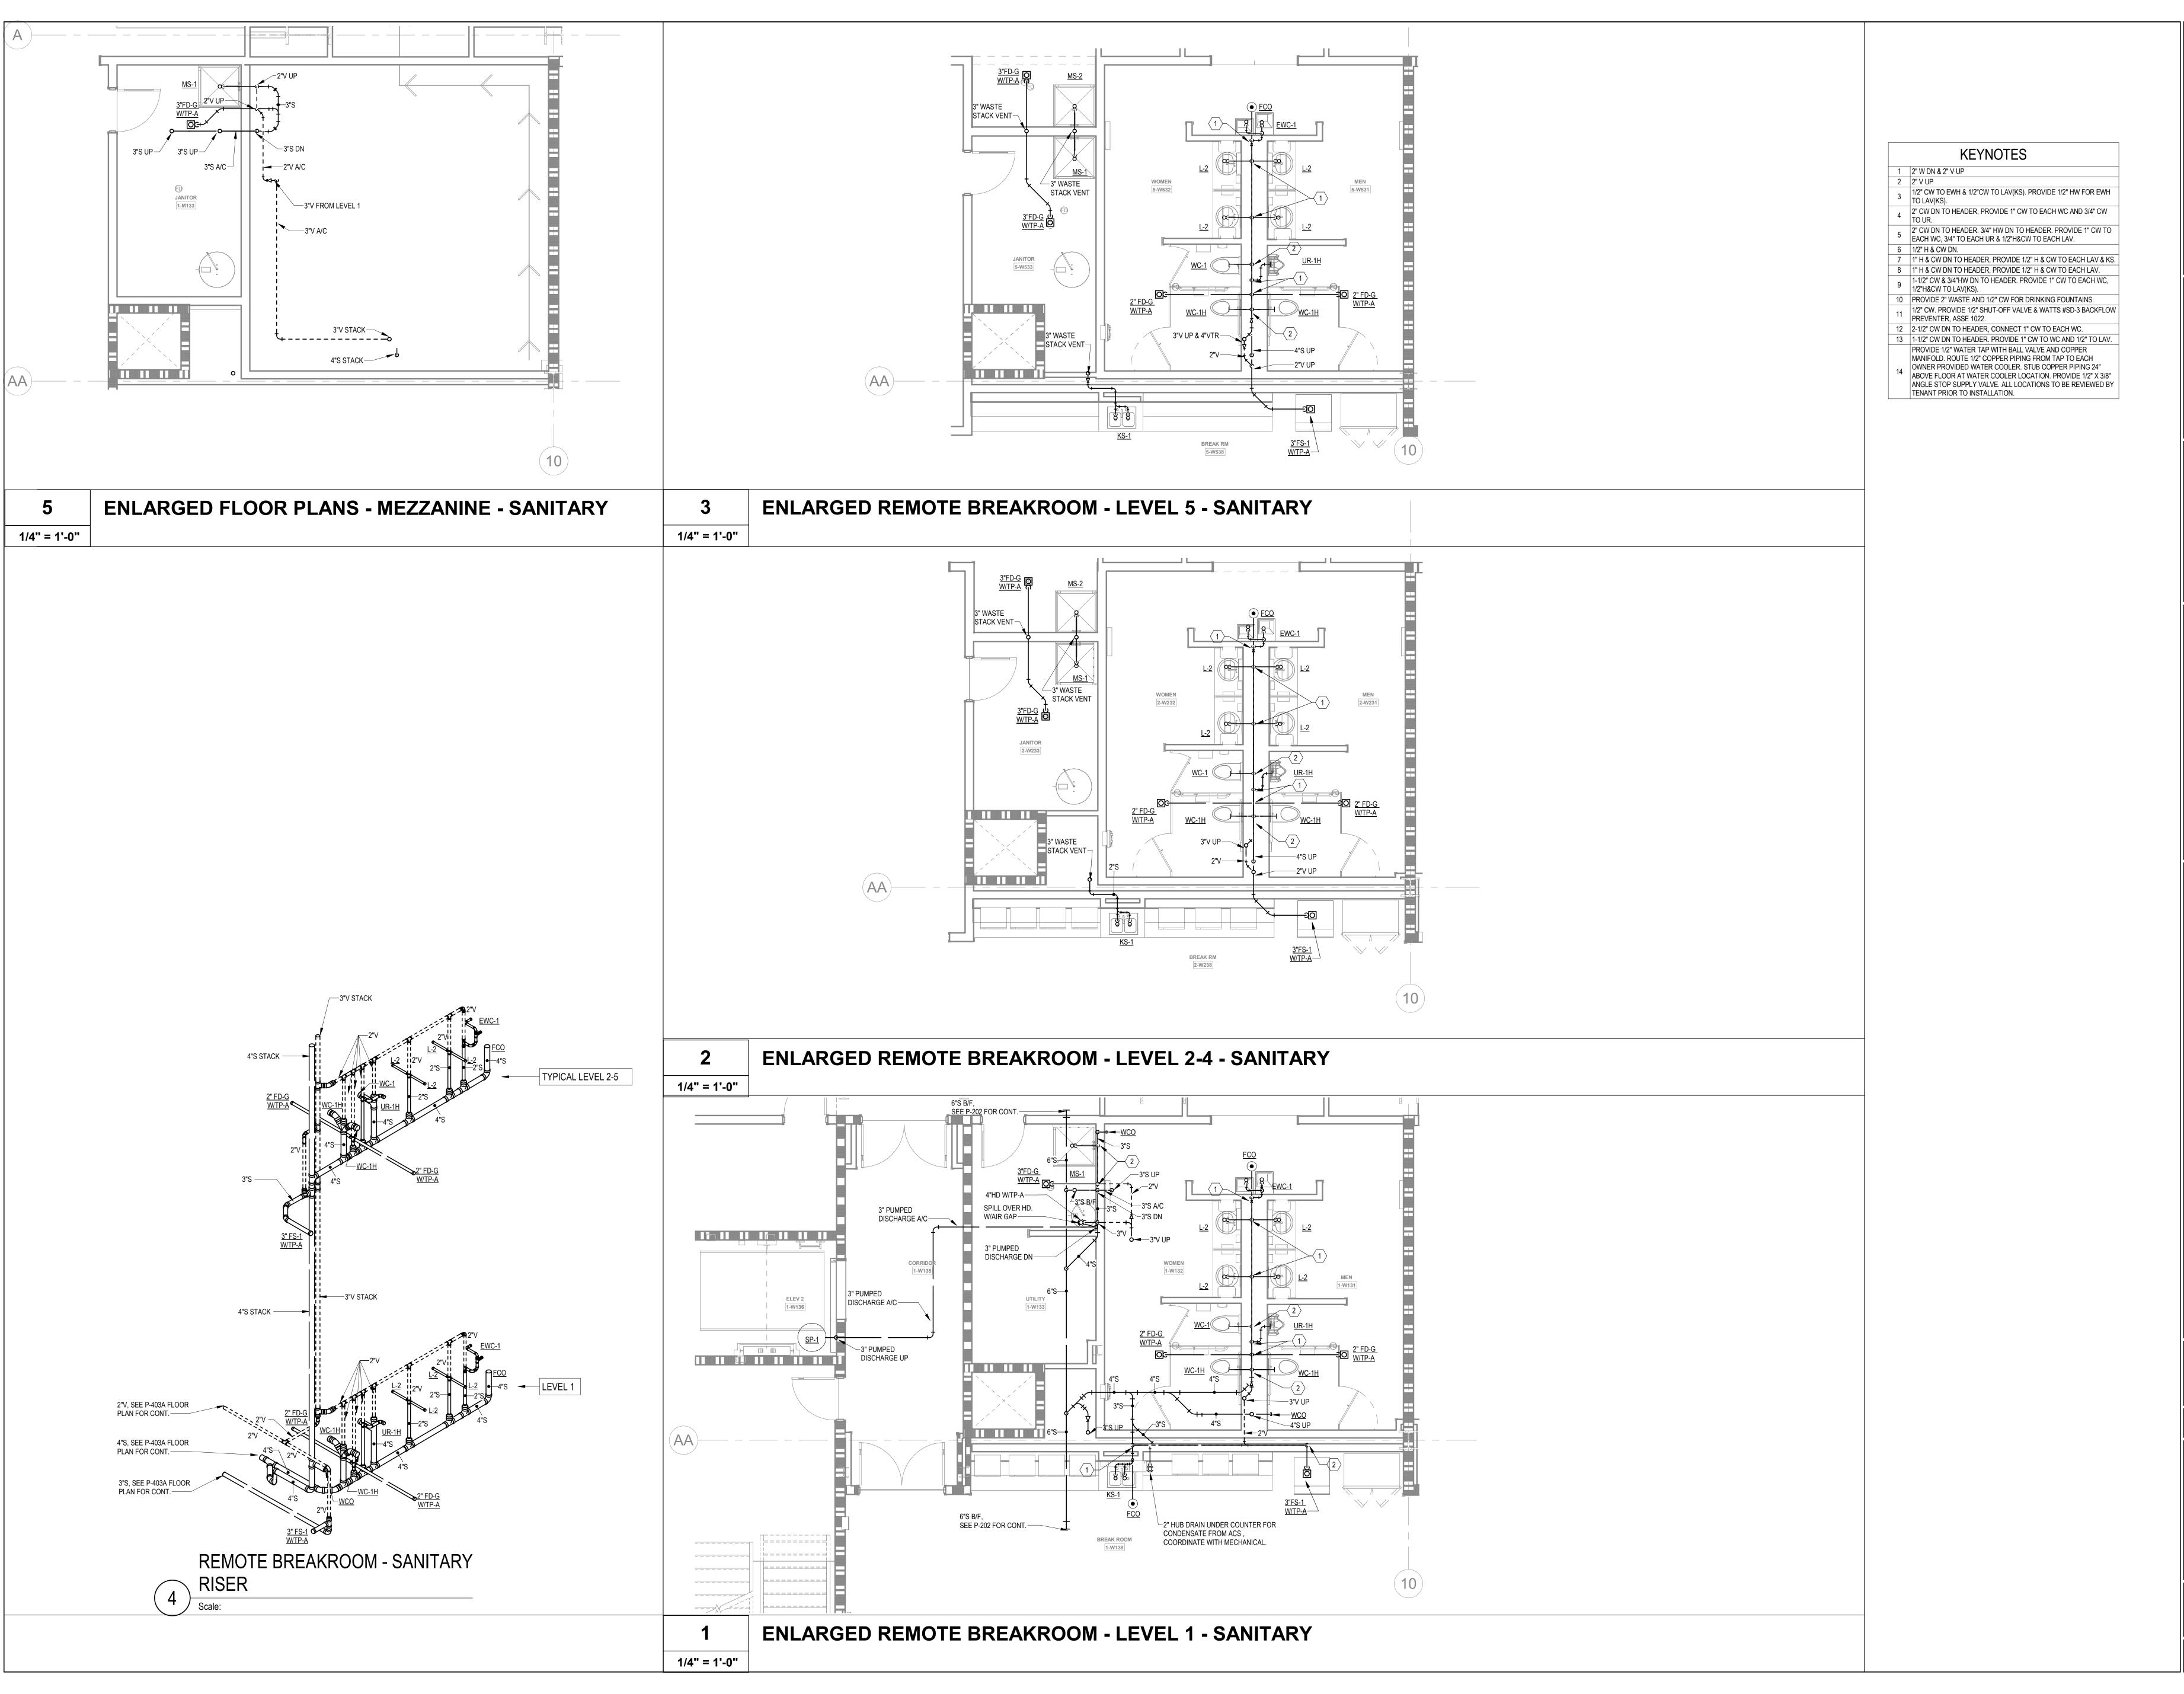
DATE PROJECT NO
01/21/22 2021-136

SHEET TITLE

MAIN OFFICE -

MAIN OFFICE -SANITARY RISER

P-402S



LILL

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PROJECT INFORMATION

PROJECT WHALE

WILMINGTON, NC

SEEFRIED INDUSTRIAL PROPERTIES


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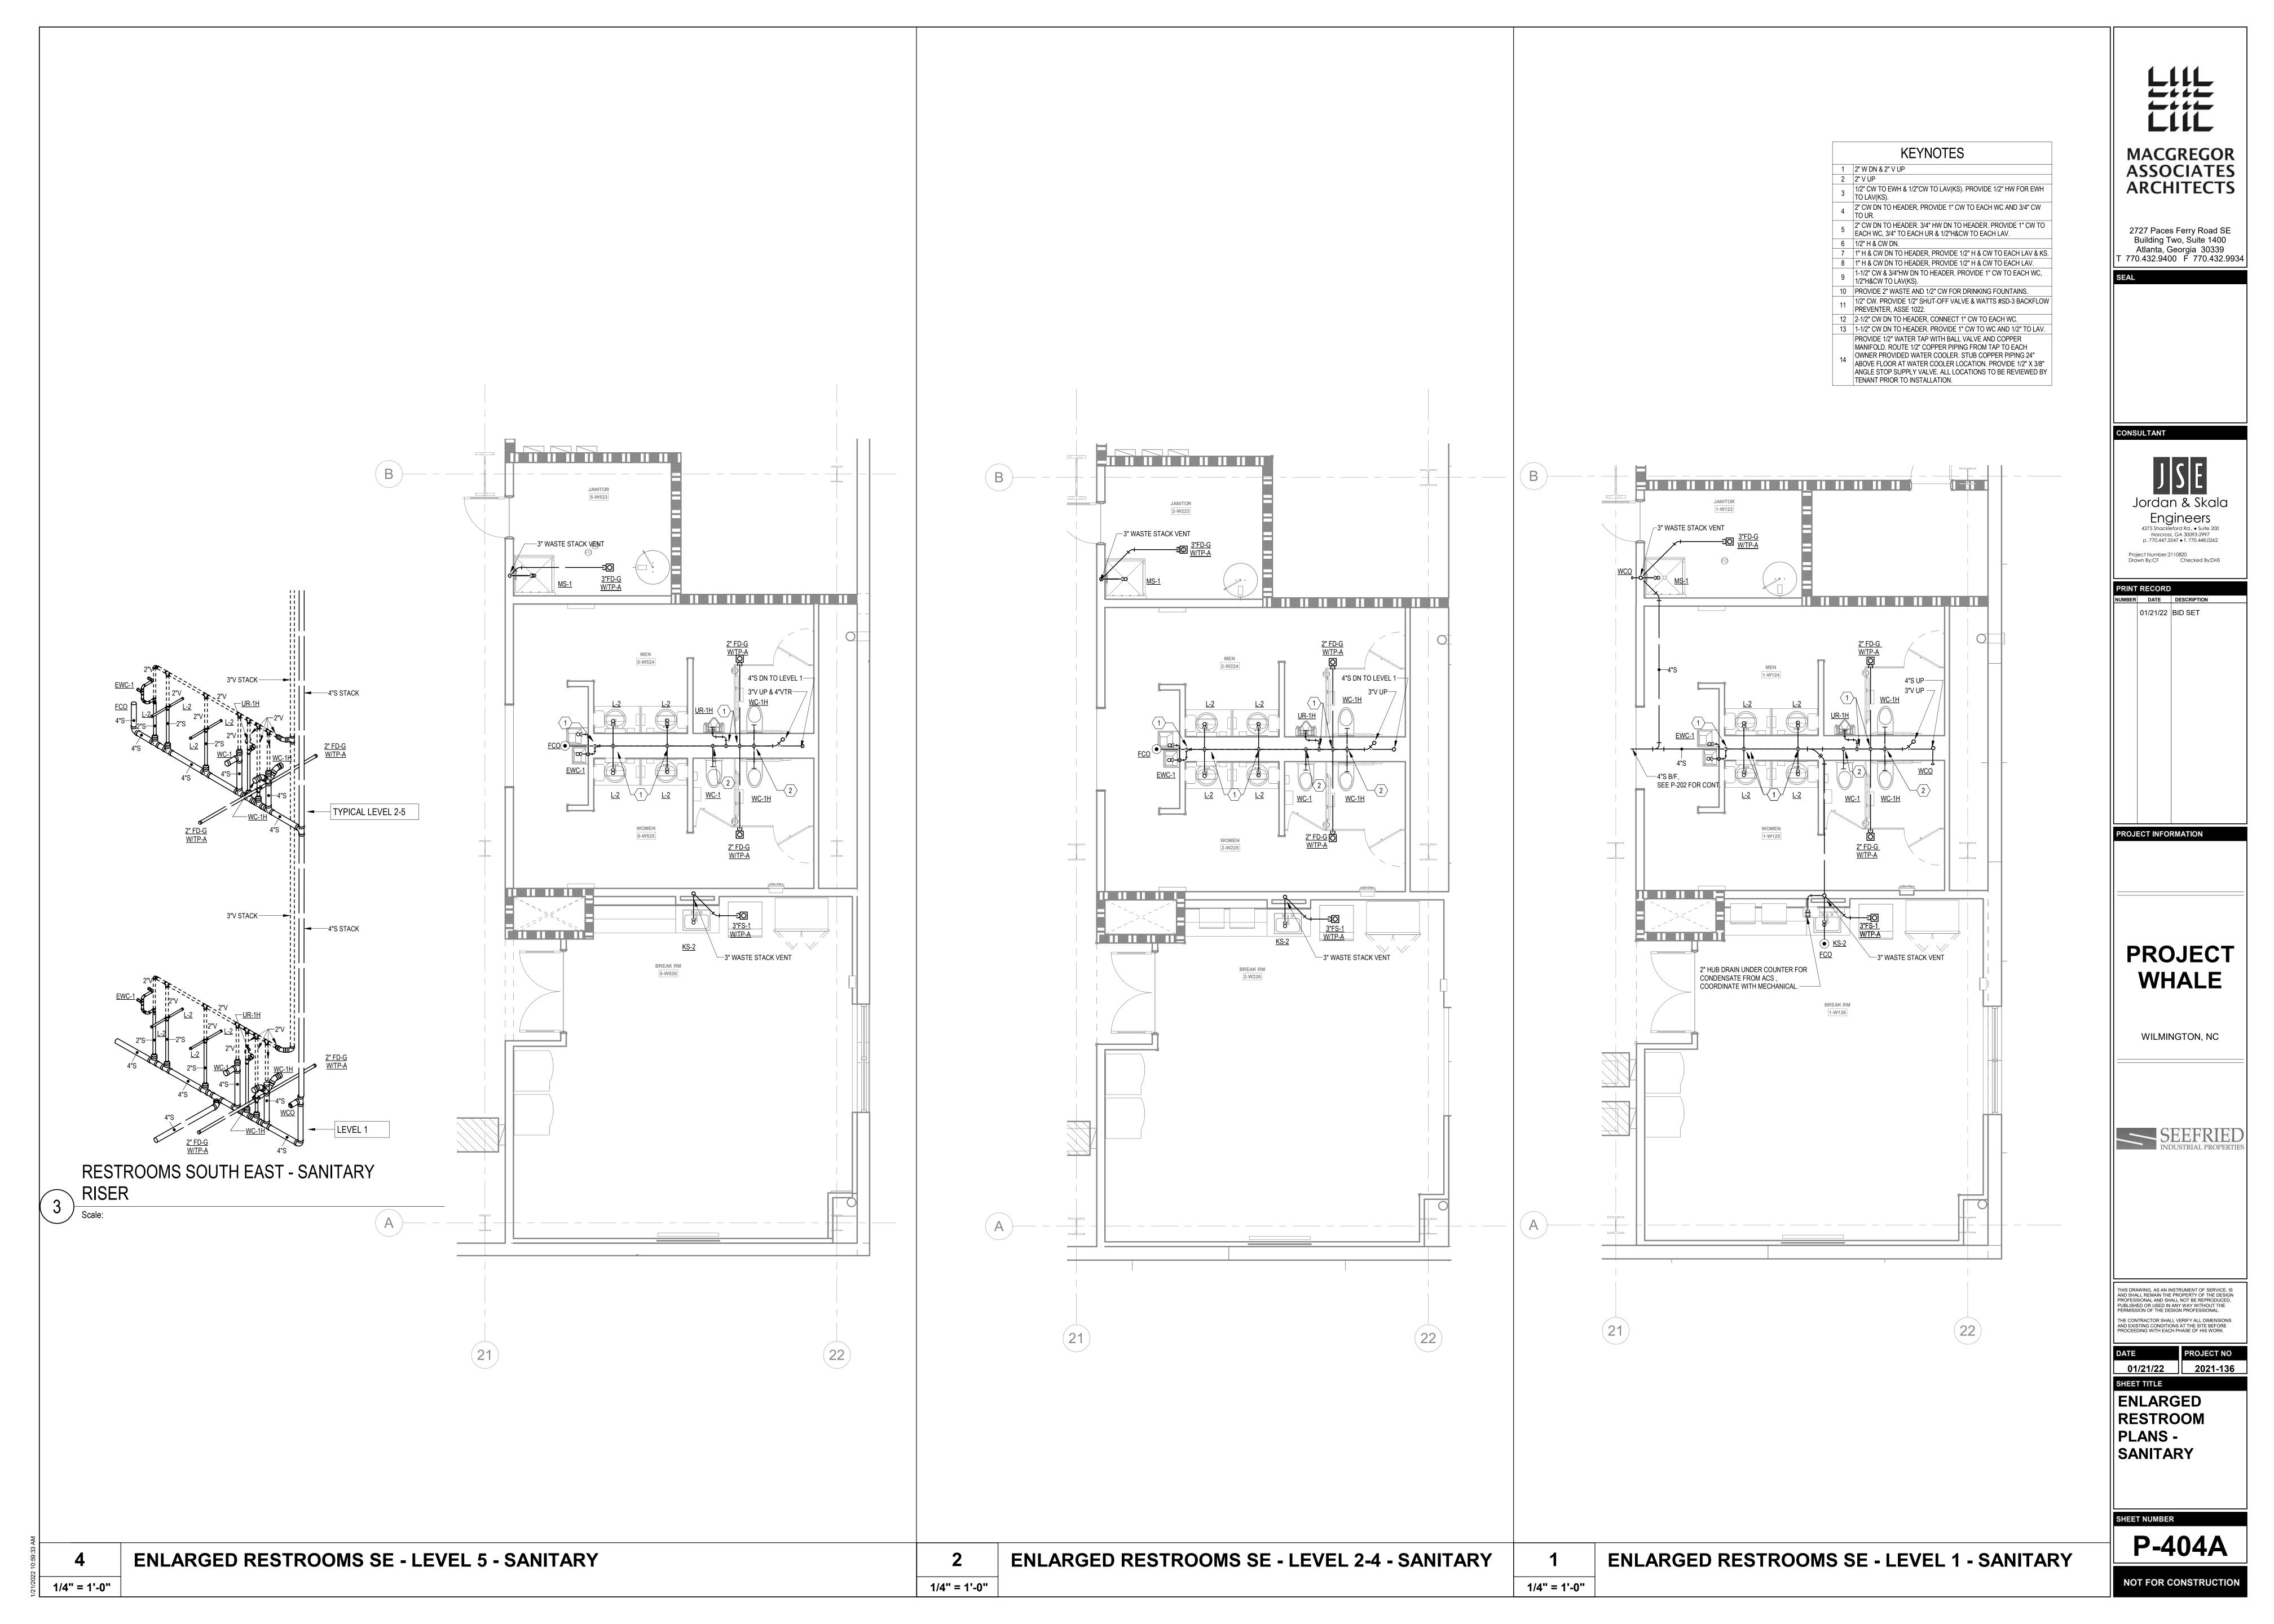
CONTRACTOR SHALL VERIFY ALL DIMENSIONS EXISTING CONDITIONS AT THE SITE BEFORE


DATE PROJECT NO
01/21/22 2021-136
SHEET TITLE
ENLARGED


REMOTE BREAKROOM PLANS -SANITARY

P-403A



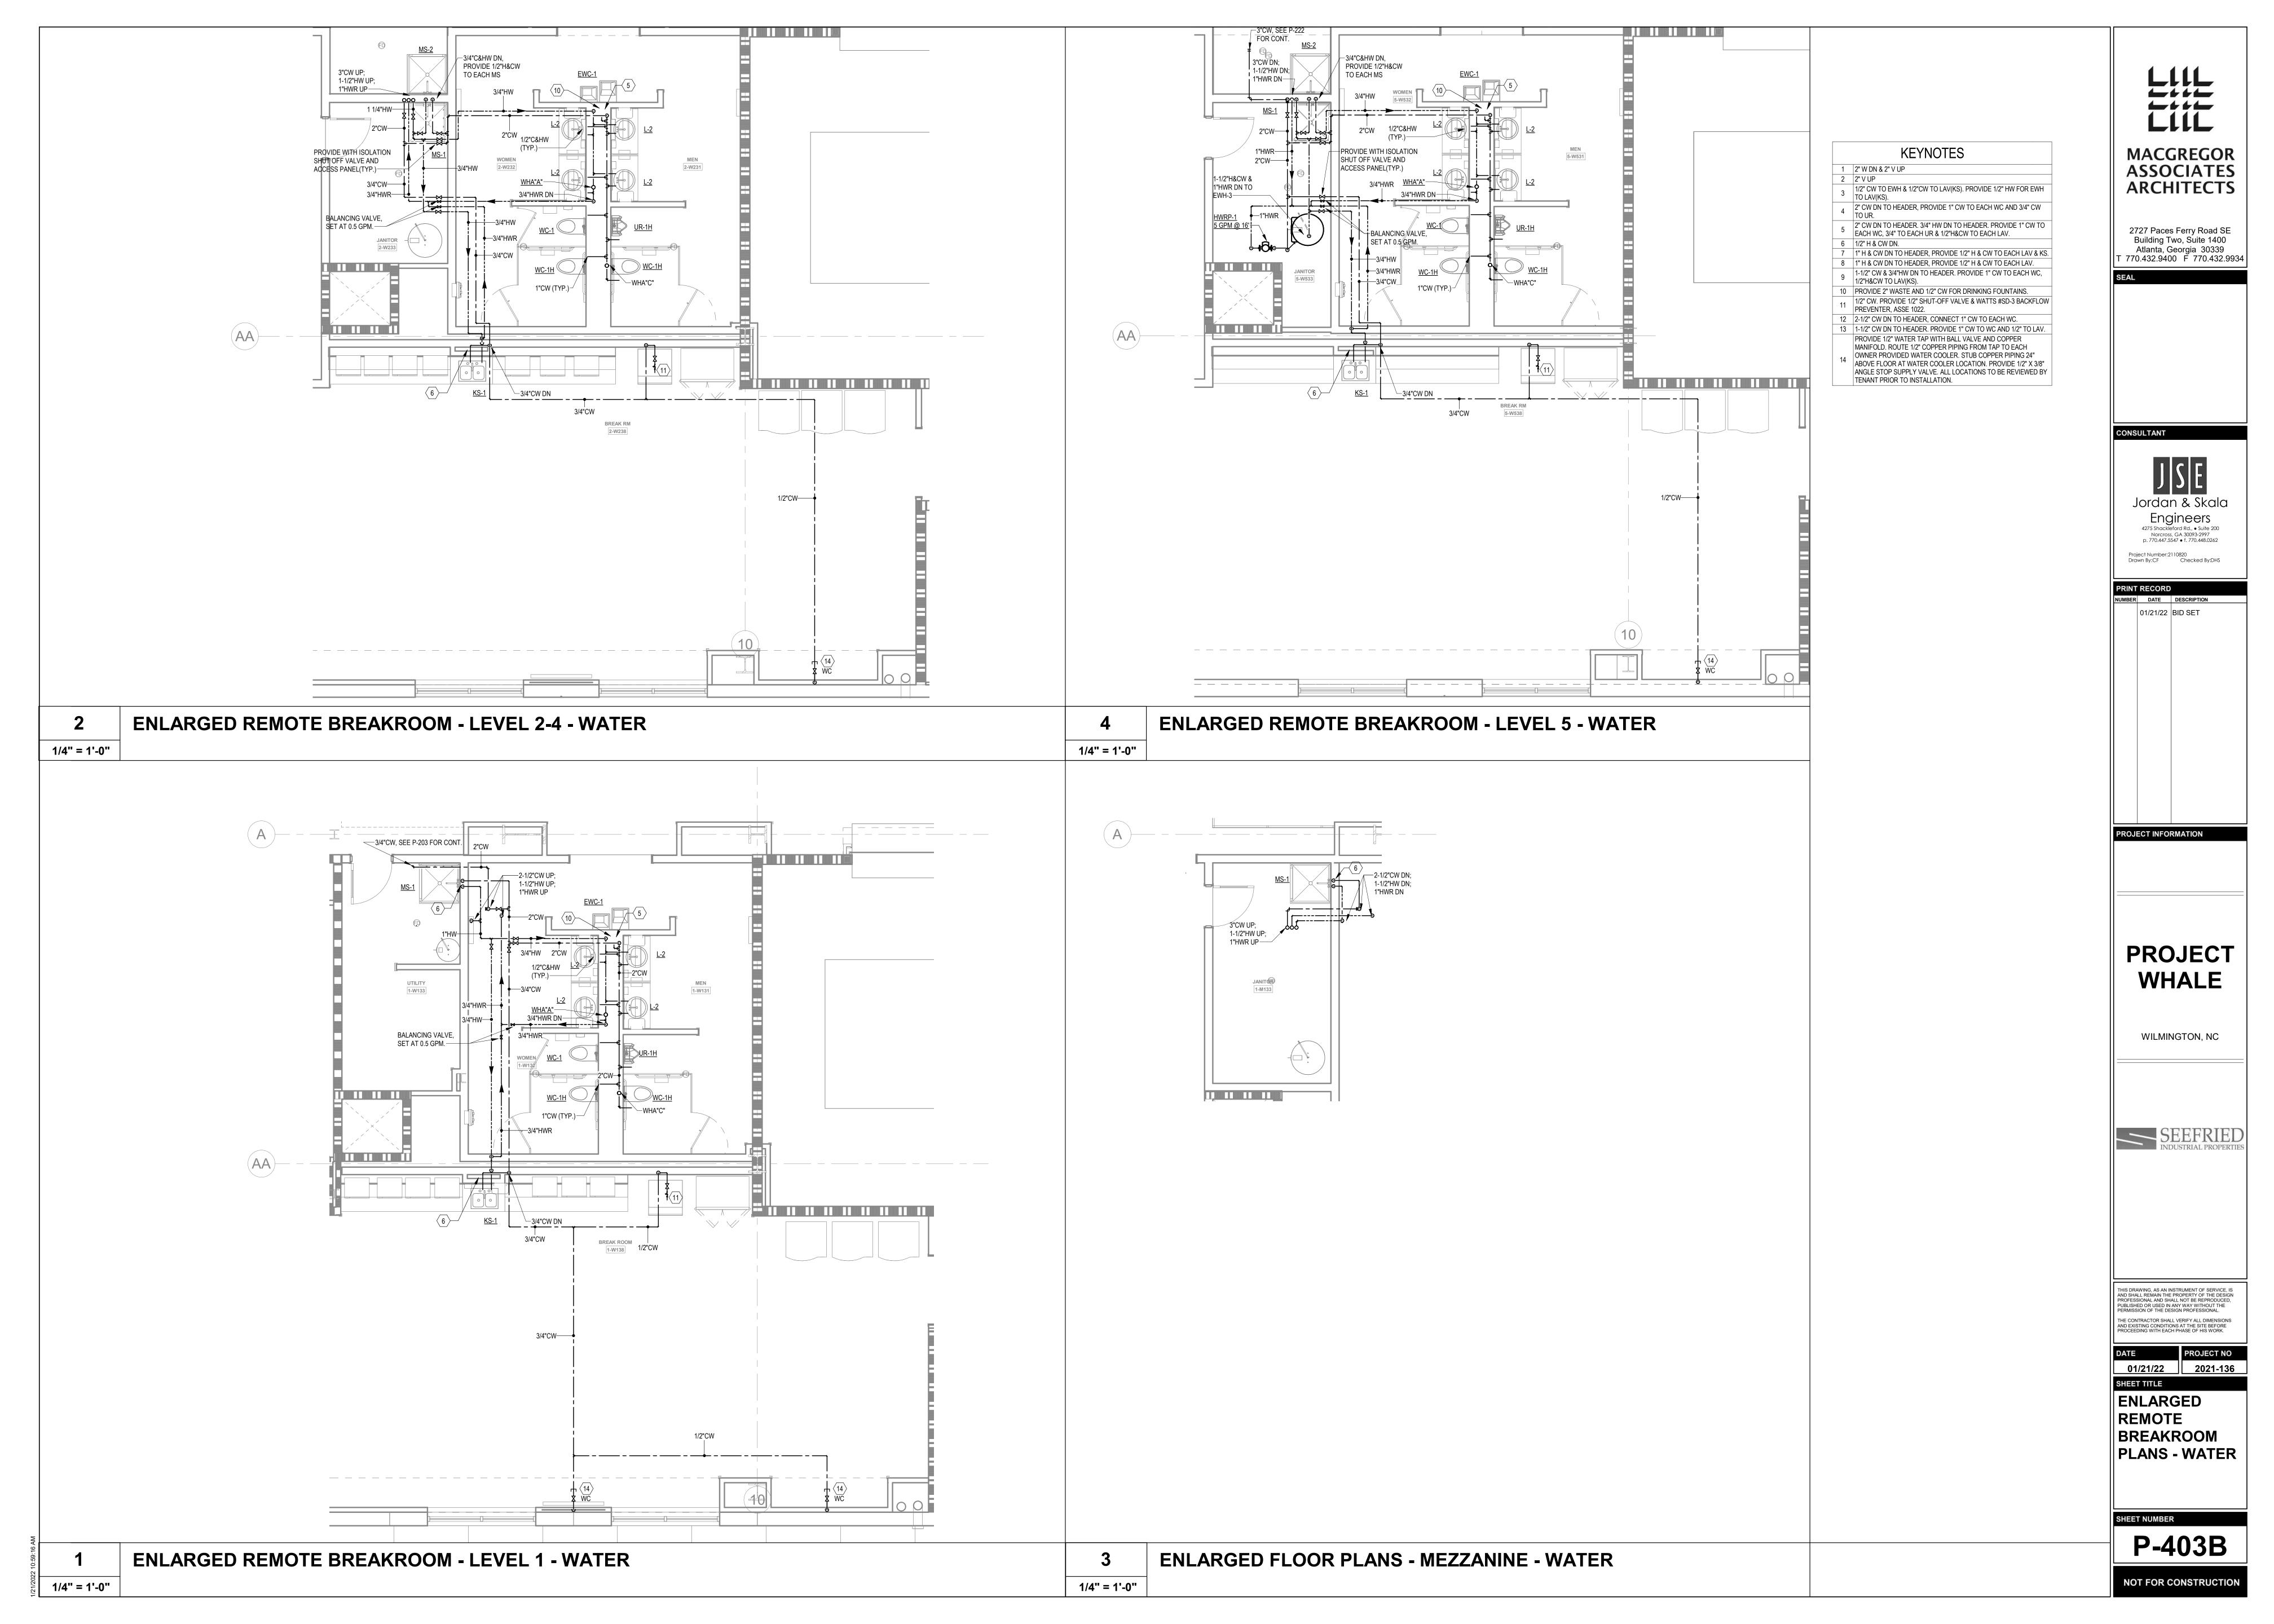

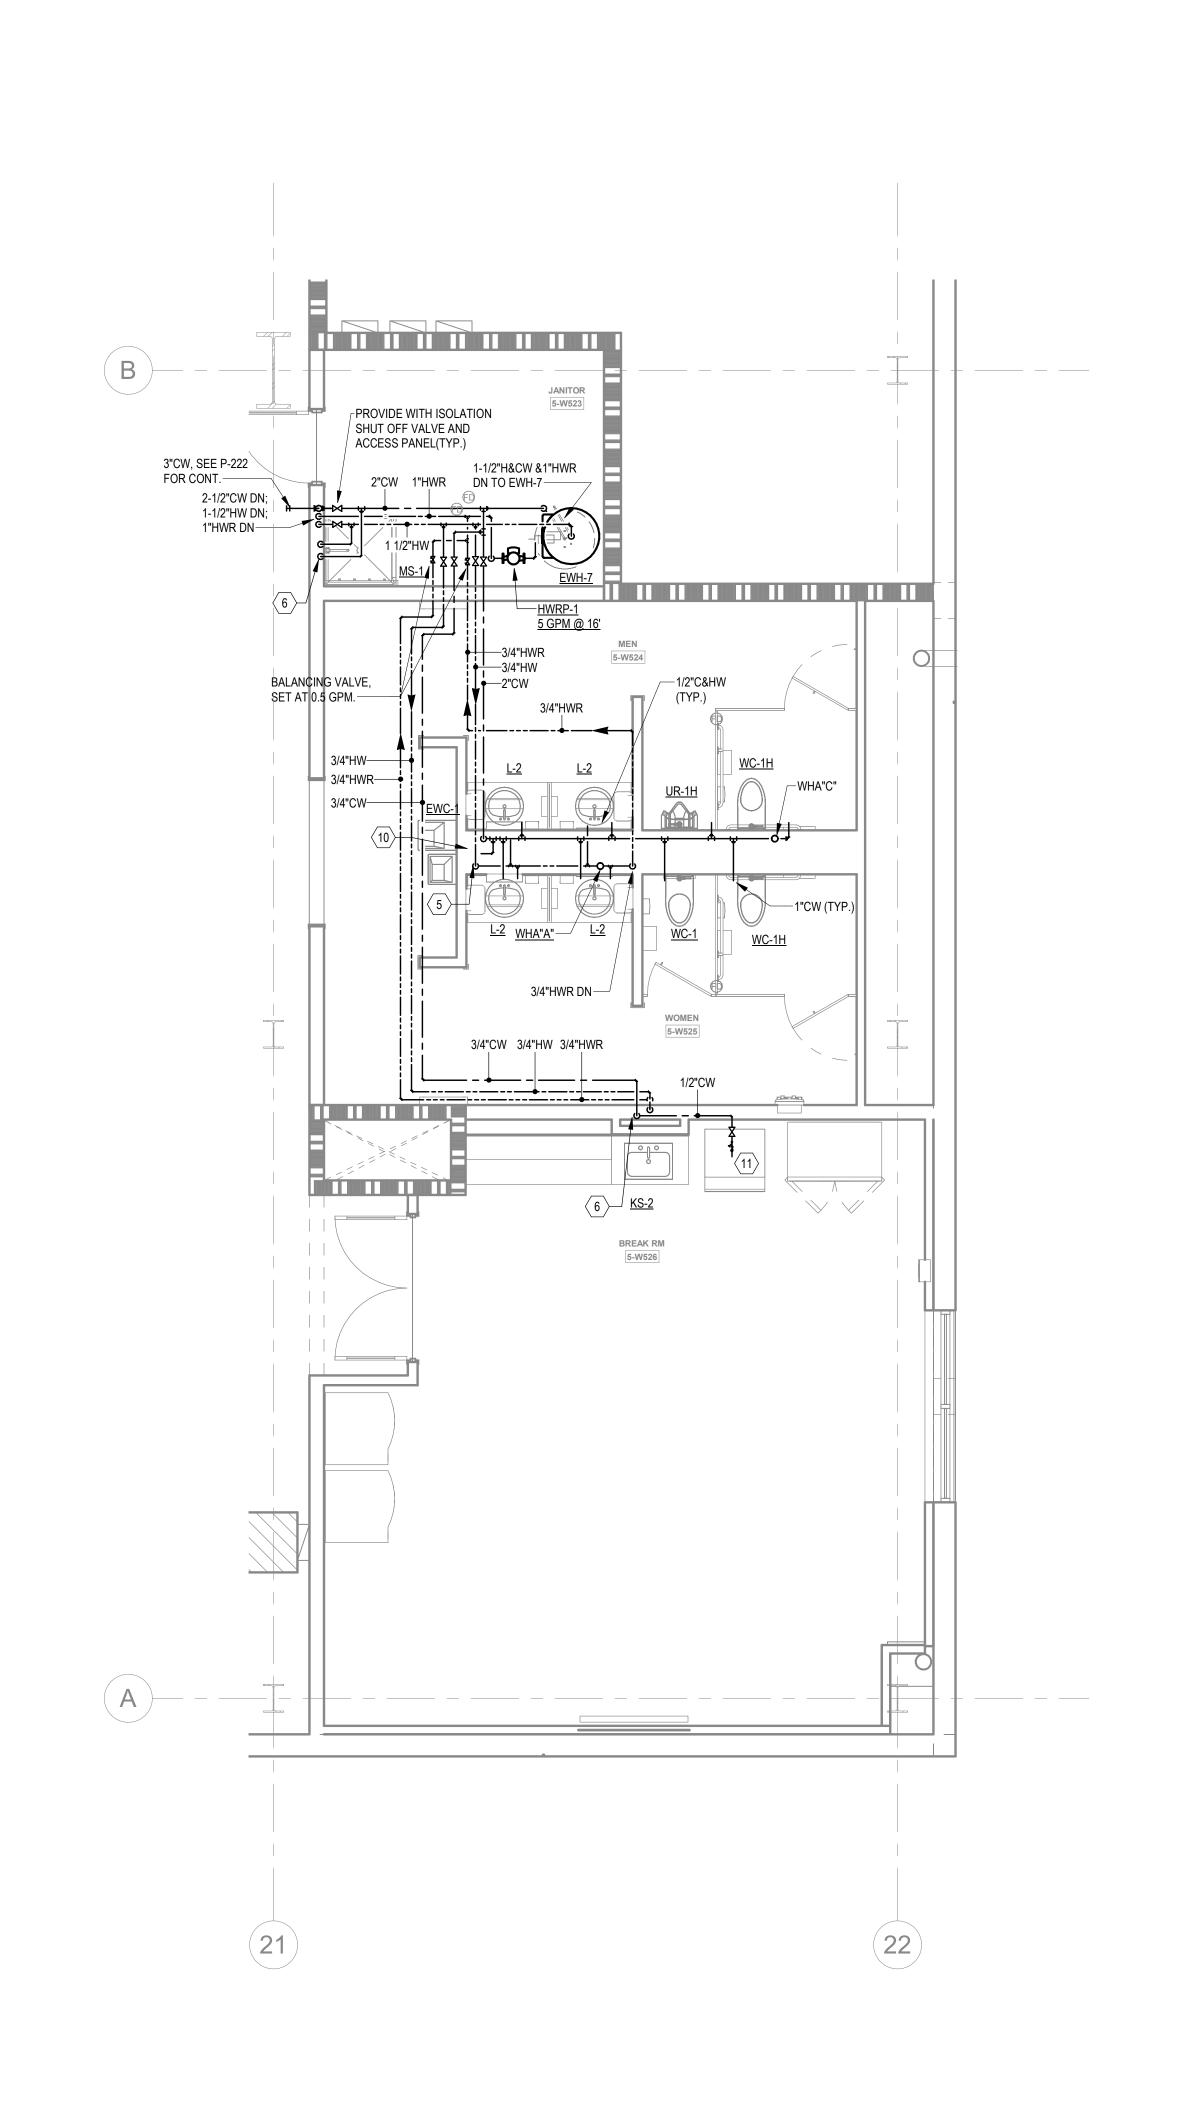

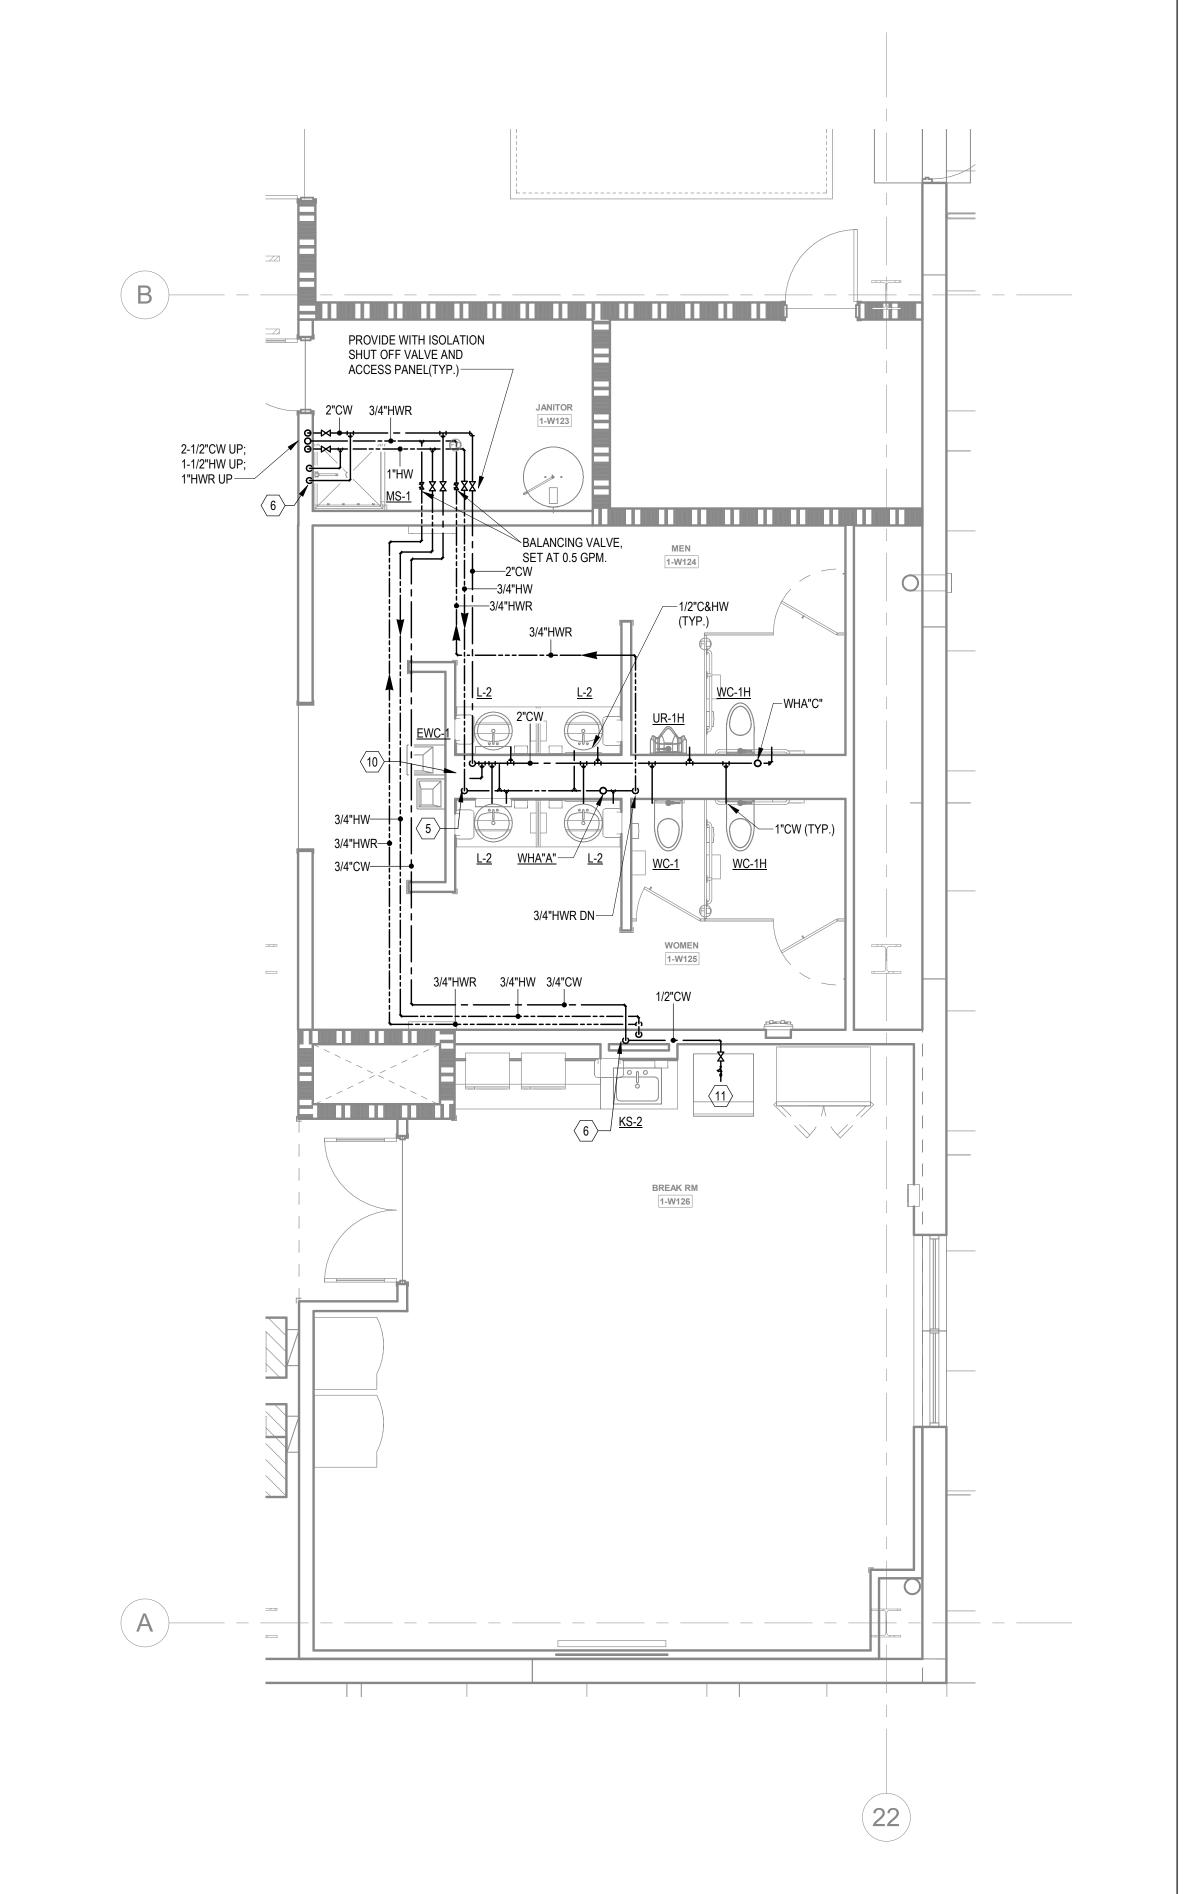

#### **KEYNOTES**

- 1 2" W DN & 2" V UP
- 2 2" V UP

  1/2" CW TO EWH & 1/2"CW TO LAV(KS). PROVIDE 1/2" HW FOR EWH TO LAV(KS).
- 4 2" CW DN TO HEADER, PROVIDE 1" CW TO EACH WC AND 3/4" CW TO UR.
- 2" CW DN TO HEADER. 3/4" HW DN TO HEADER. PROVIDE 1" CW TO EACH WC, 3/4" TO EACH UR & 1/2"H&CW TO EACH LAV.
- 6 1/2" H & CW DN.
  7 1" H & CW DN TO HEADER, PROVIDE 1/2" H & CW TO EACH LAV & KS.
- 8 1" H & CW DN TO HEADER, PROVIDE 1/2" H & CW TO EACH LAV.

  9 1-1/2" CW & 3/4"HW DN TO HEADER. PROVIDE 1" CW TO EACH WC,
  1/2"H&CW TO LAV(KS).
- 1/2"H&CW TO LAV(KS).

  10 PROVIDE 2" WASTE AND 1/2" CW FOR DRINKING FOUNTAINS.
- 11 1/2" CW. PROVIDE 1/2" SHUT-OFF VALVE & WATTS #SD-3 BACKFLOW PREVENTER, ASSE 1022.
- 12 2-1/2" CW DN TO HEADER, CONNECT 1" CW TO EACH WC.
   13 1-1/2" CW DN TO HEADER. PROVIDE 1" CW TO WC AND 1/2" TO LAV.
   PROVIDE 1/2" WATER TAP WITH BALL VALVE AND COPPER
- MANIFOLD. ROUTE 1/2" COPPER PIPING FROM TAP TO EACH
  OWNER PROVIDED WATER COOLER. STUB COPPER PIPING 24"

  14
- ABOVE FLOOR AT WATER COOLER. STUB COPPER PIPING 24"

  ABOVE FLOOR AT WATER COOLER LOCATION. PROVIDE 1/2" X 3/8"

  ANGLE STOP SUPPLY VALVE. ALL LOCATIONS TO BE REVIEWED BY TENANT PRIOR TO INSTALLATION.

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Project Number:2110820

Drawn By:CF Checked By:DHS

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PROJECT INFORMATION

PROJECT

WILMINGTON, NC

**WHALE** 

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DATE

01/21/22

PROJECT NO
2021-136


ENLARGED
RESTROOM
PLANS - WATER


P-404B

NOT FOR CONSTRUCTION

2


1/4" = 1'-0"

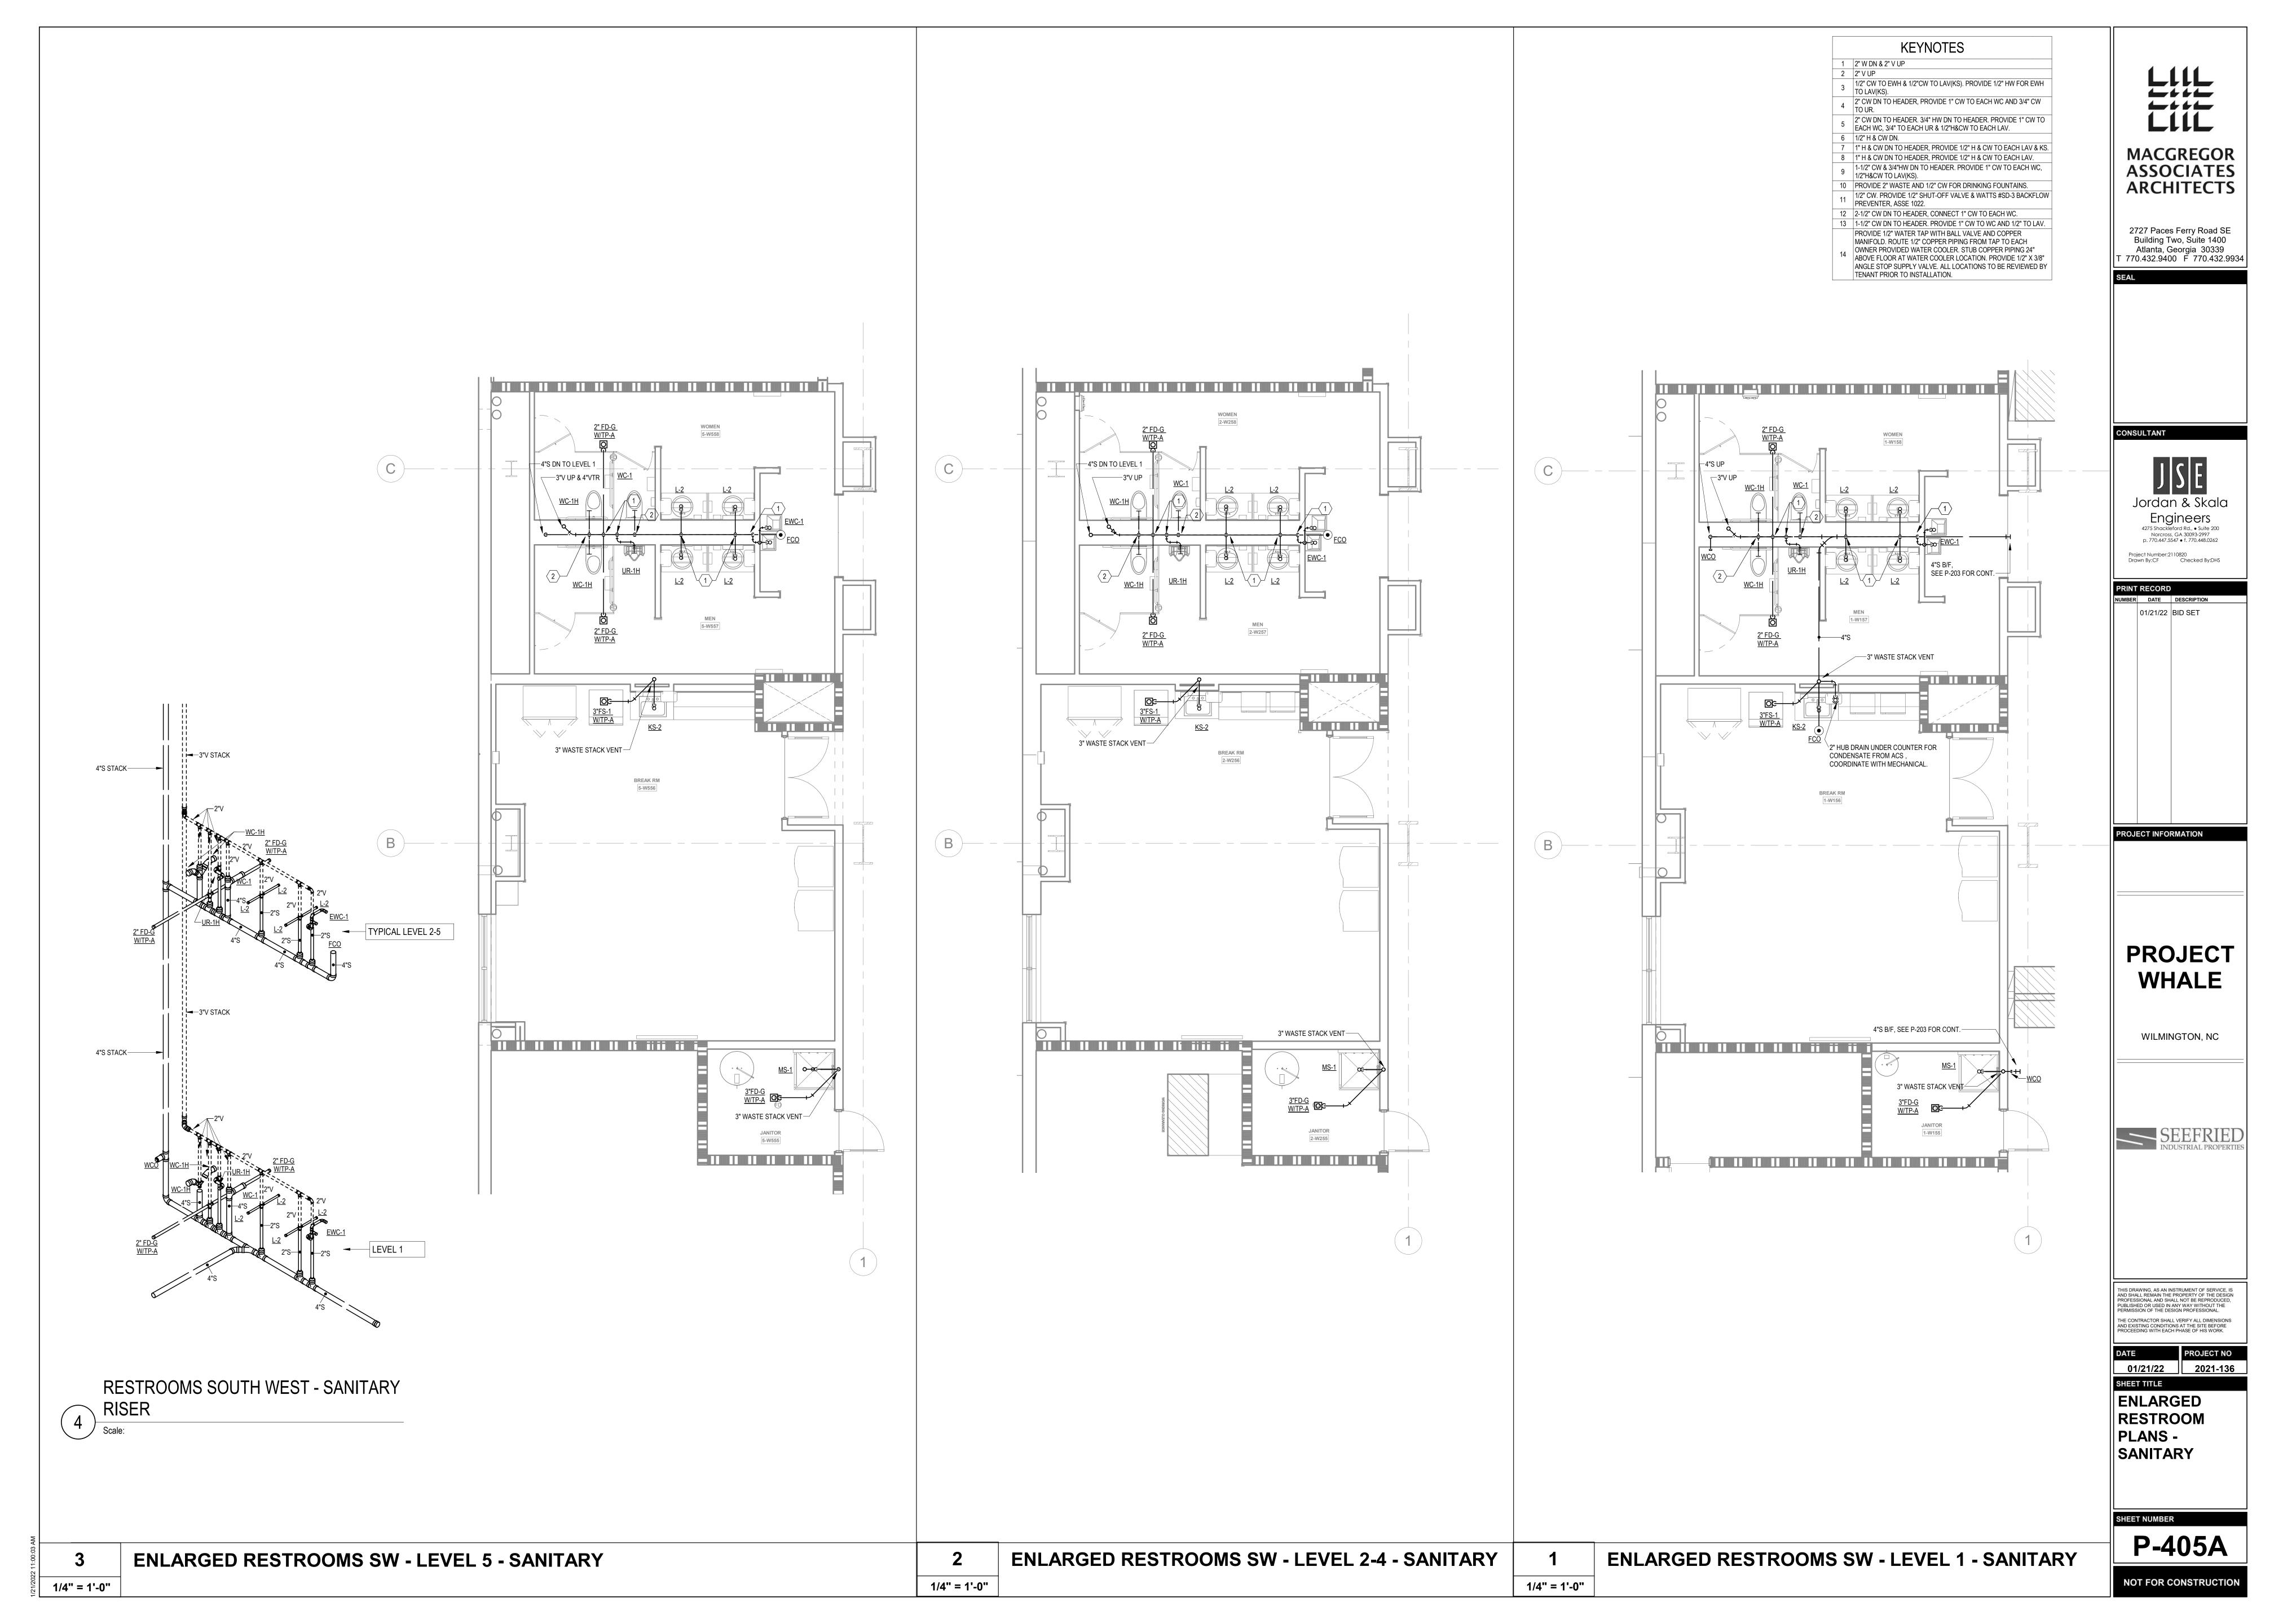

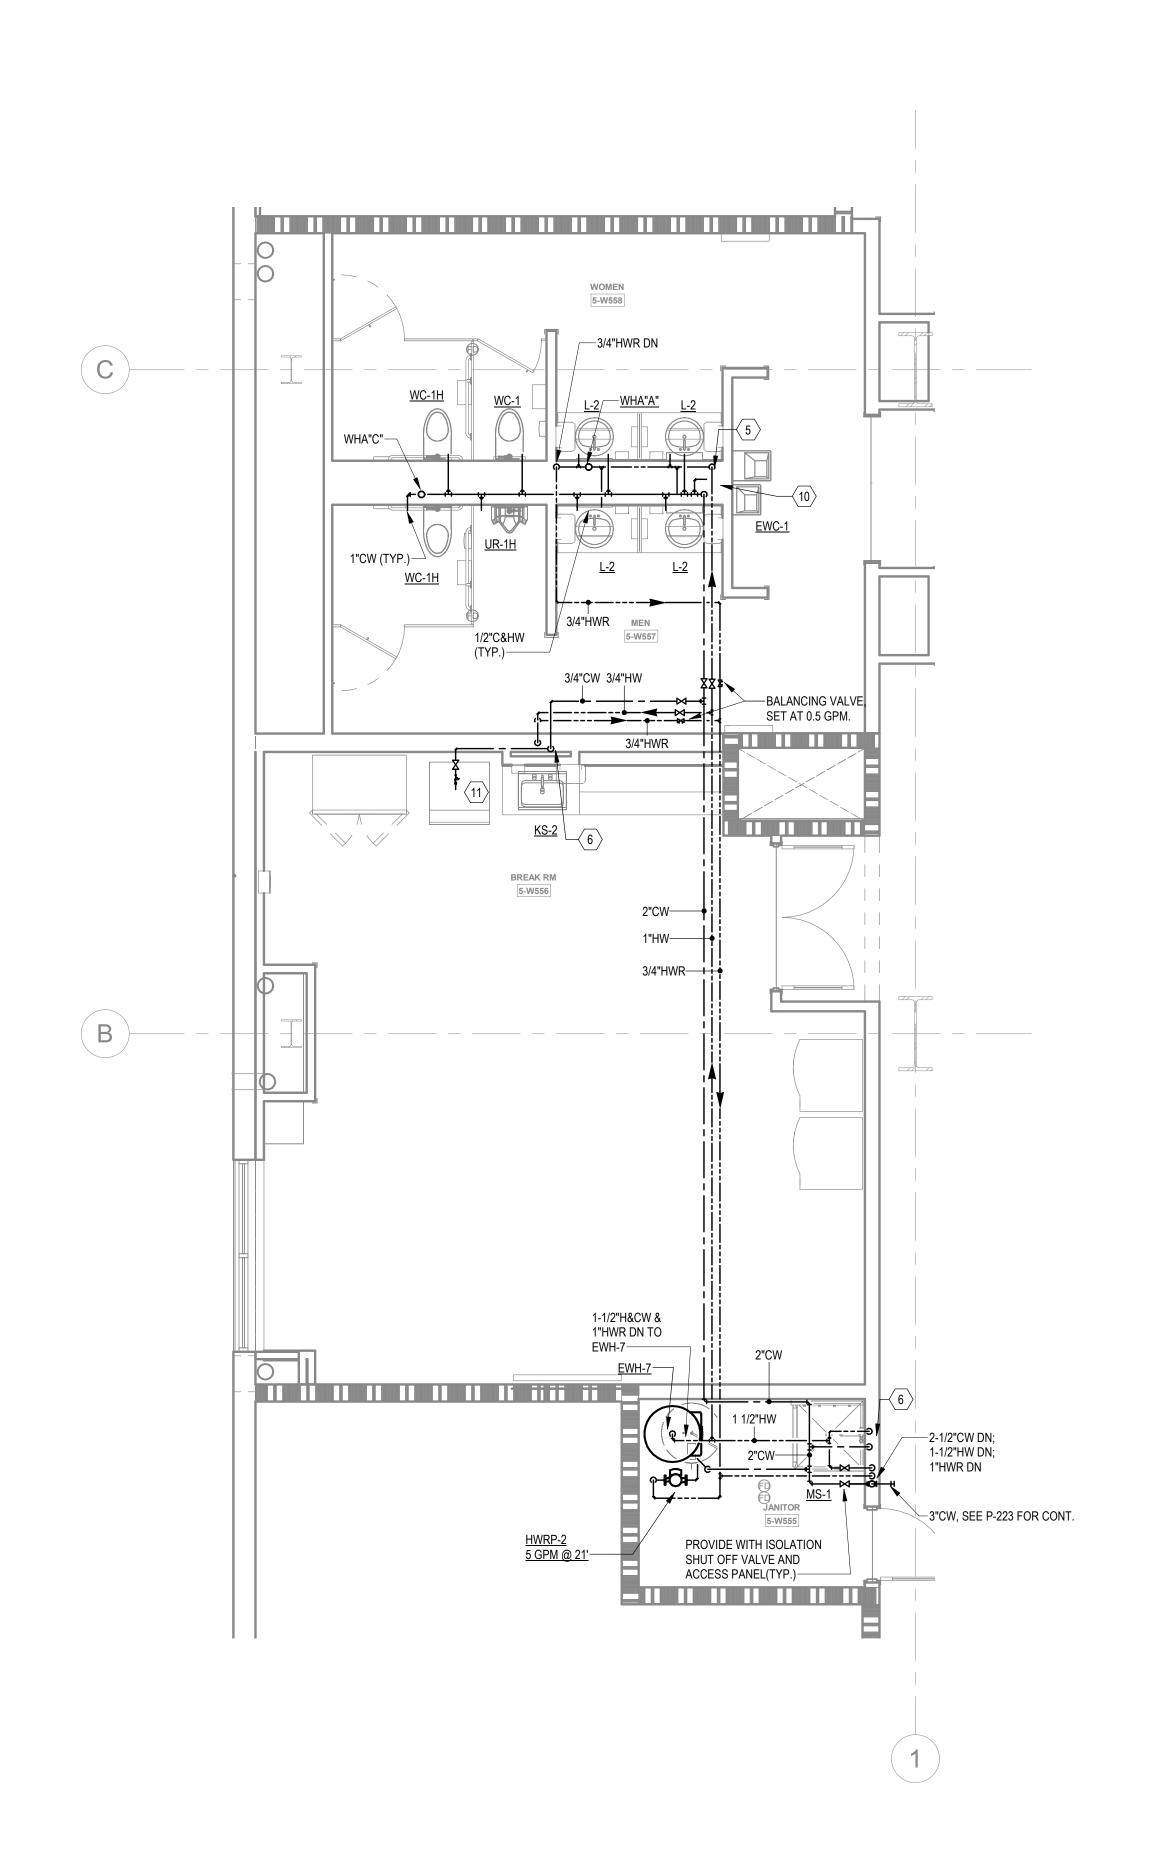



- 1 2" W DN & 2" V UP
- 2 2" V UP 3 1/2" CW TO EWH & 1/2"CW TO LAV(KS). PROVIDE 1/2" HW FOR EWH TO LAV(KS).
- 4 2" CW DN TO HEADER, PROVIDE 1" CW TO EACH WC AND 3/4" CW TO UR.
- 2" CW DN TO HEADER. 3/4" HW DN TO HEADER. PROVIDE 1" CW TO EACH WC, 3/4" TO EACH UR & 1/2"H&CW TO EACH LAV.
- 6 1/2" H & CW DN. 7 1" H & CW DN TO HEADER, PROVIDE 1/2" H & CW TO EACH LAV & KS.
- 8 1" H & CW DN TO HEADER, PROVIDE 1/2" H & CW TO EACH LAV. 9 1-1/2" CW & 3/4"HW DN TO HEADER. PROVIDE 1" CW TO EACH WC, 1/2"H&CW TO LAV(KS).
- 10 PROVIDE 2" WASTE AND 1/2" CW FOR DRINKING FOUNTAINS.
- 11 1/2" CW. PROVIDE 1/2" SHUT-OFF VALVE & WATTS #SD-3 BACKFLOW PREVENTER, ASSE 1022.
- 12 2-1/2" CW DN TO HEADER, CONNECT 1" CW TO EACH WC. 13 1-1/2" CW DN TO HEADER. PROVIDE 1" CW TO WC AND 1/2" TO LAV.
- PROVIDE 1/2" WATER TAP WITH BALL VALVE AND COPPER MANIFOLD. ROUTE 1/2" COPPER PIPING FROM TAP TO EACH
- OWNER PROVIDED WATER COOLER. STUB COPPER PIPING 24" ABOVE FLOOR AT WATER COOLER LOCATION. PROVIDE 1/2" X 3/8" ANGLE STOP SUPPLY VALVE. ALL LOCATIONS TO BE REVIEWED BY TENANT PRIOR TO INSTALLATION.

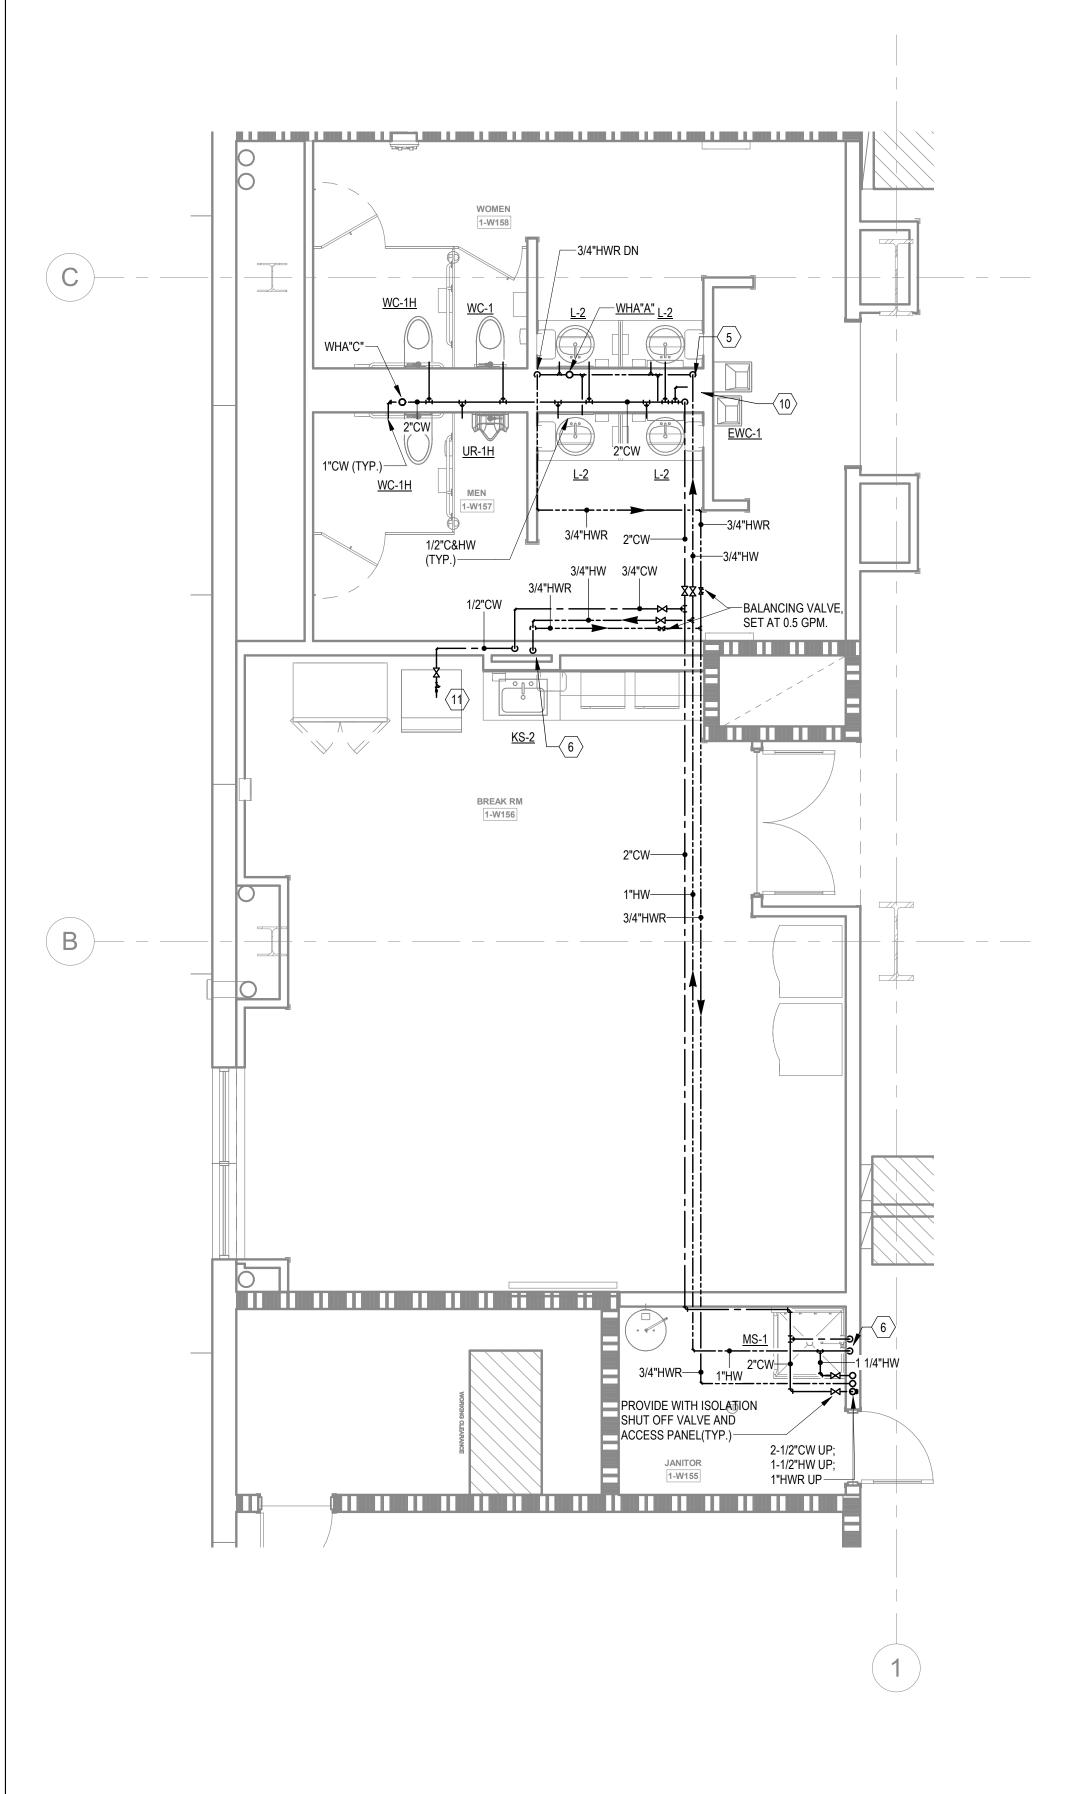

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01/21/22 BID SET

PROJECT INFORMATION

**PROJECT WHALE** 

WILMINGTON, NC

DATE PROJECT NO 2021-136 SHEET TITLE


ENLARGED RESTROOM PLANS - WATER

P-405B

NOT FOR CONSTRUCTION

1/4" = 1'-0"

1/4" = 1'-0"

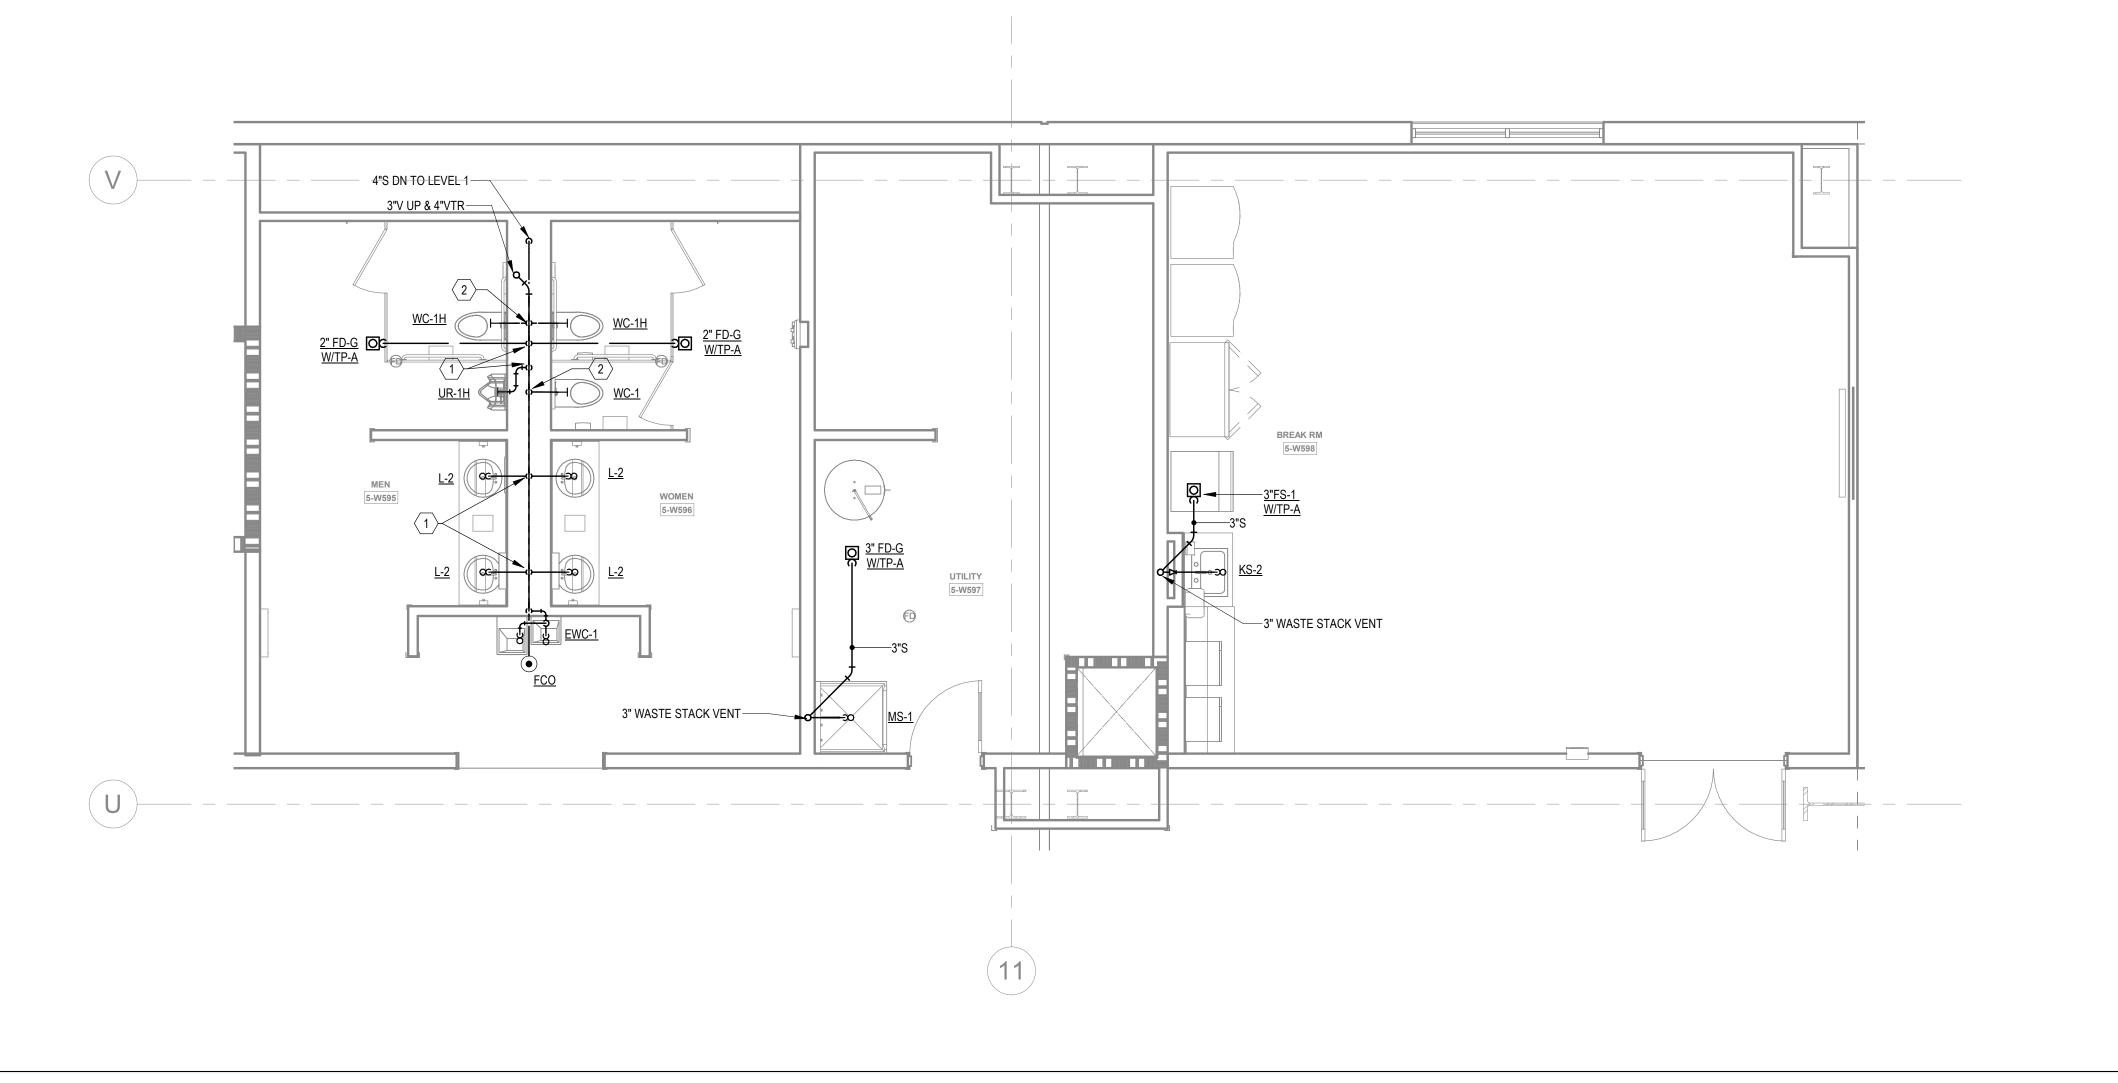

**KEYNOTES** 

- 1 2" W DN & 2" V UP
- 2 2" V UP 3 1/2" CW TO EWH & 1/2"CW TO LAV(KS). PROVIDE 1/2" HW FOR EWH TO LAV(KS).
- 4 2" CW DN TO HEADER, PROVIDE 1" CW TO EACH WC AND 3/4" CW TO UR.
- 5 2" CW DN TO HEADER. 3/4" HW DN TO HEADER. PROVIDE 1" CW TO EACH WC, 3/4" TO EACH UR & 1/2"H&CW TO EACH LAV.
- 6 1/2" H & CW DN. 7 1" H & CW DN TO HEADER, PROVIDE 1/2" H & CW TO EACH LAV & KS.
- 8 1" H & CW DN TO HEADER, PROVIDE 1/2" H & CW TO EACH LAV.
- 9 1-1/2" CW & 3/4"HW DN TO HEADER. PROVIDE 1" CW TO EACH WC, 1/2"H&CW TO LAV(KS).
- 10 PROVIDE 2" WASTE AND 1/2" CW FOR DRINKING FOUNTAINS. 11 1/2" CW. PROVIDE 1/2" SHUT-OFF VALVE & WATTS #SD-3 BACKFLOW PREVENTER, ASSE 1022.
- 12 2-1/2" CW DN TO HEADER, CONNECT 1" CW TO EACH WC. 13 1-1/2" CW DN TO HEADER. PROVIDE 1" CW TO WC AND 1/2" TO LAV. PROVIDE 1/2" WATER TAP WITH BALL VALVE AND COPPER
- MANIFOLD. ROUTE 1/2" COPPER PIPING FROM TAP TO EACH OWNER PROVIDED WATER COOLER. STUB COPPER PIPING 24"
- ABOVE FLOOR AT WATER COOLER LOCATION. PROVIDE 1/2" X 3/8" ANGLE STOP SUPPLY VALVE. ALL LOCATIONS TO BE REVIEWED BY TENANT PRIOR TO INSTALLATION.

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01/21/22 BID SET

PROJECT INFORMATION

**PROJECT** 

WILMINGTON, NC

**WHALE** 


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ENLARGED RESTROOM PLANS -SANITARY


P-406A NOT FOR CONSTRUCTION

**ENLARGED RESTROOMS NORTH - LEVEL 5 - SANITARY** 1/4" = 1'-0"




RESTROOMS NORTH - SANITARY RISER

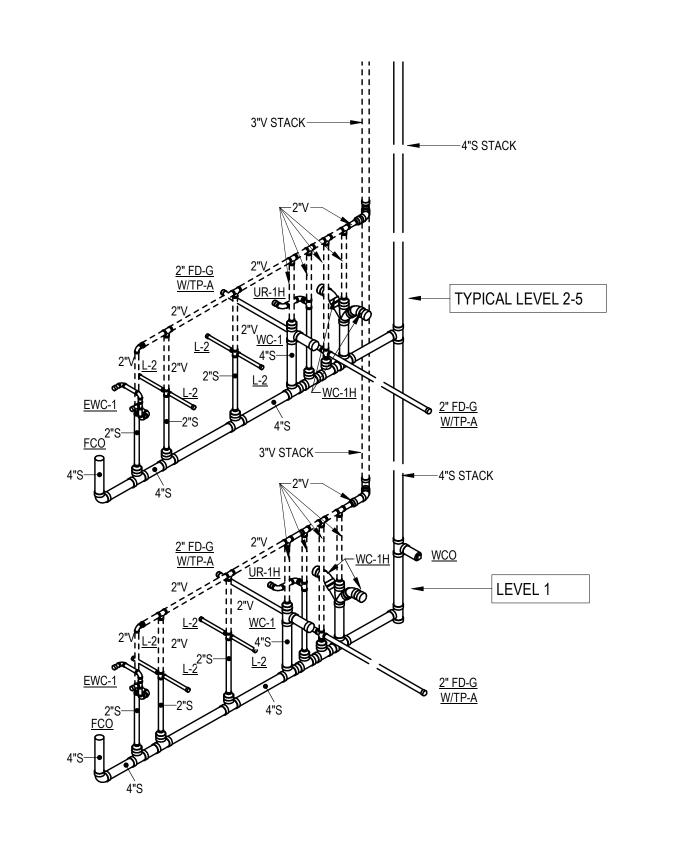Scale:

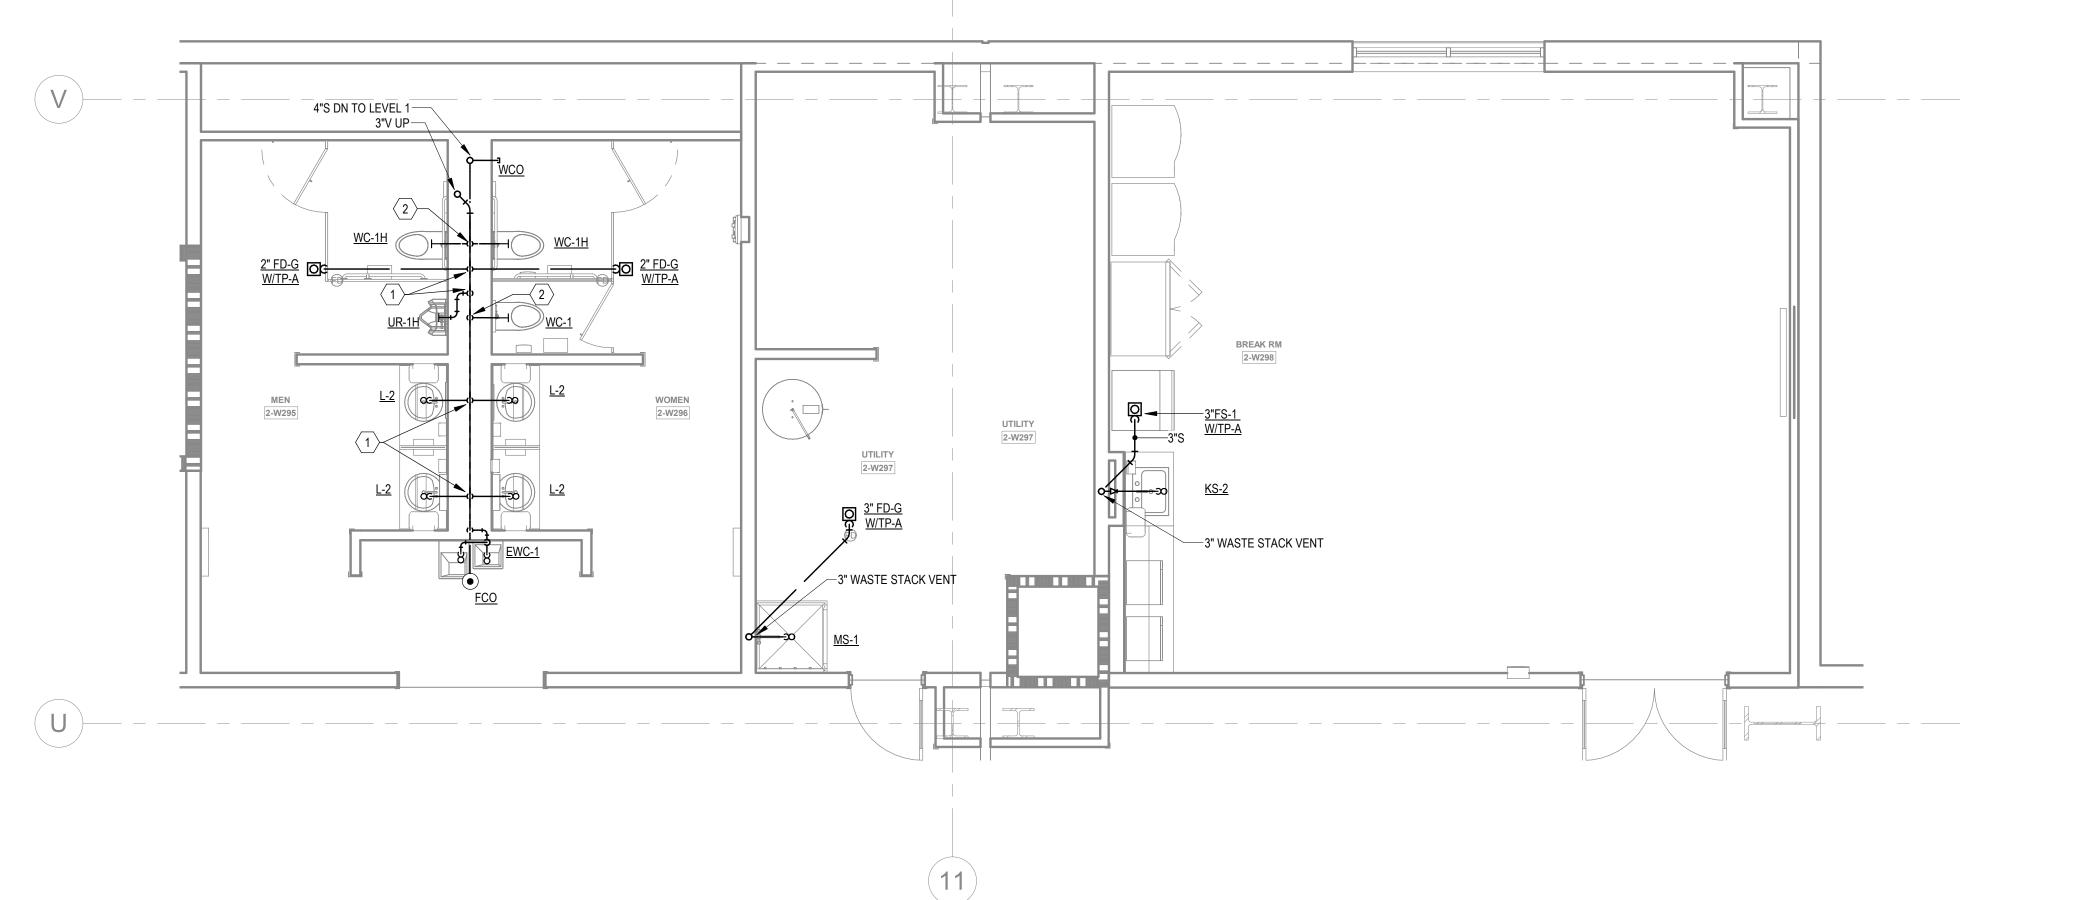


1/4" = 1'-0"

**ENLARGED RESTROOMS NORTH - LEVEL 2-4 - SANITARY** 

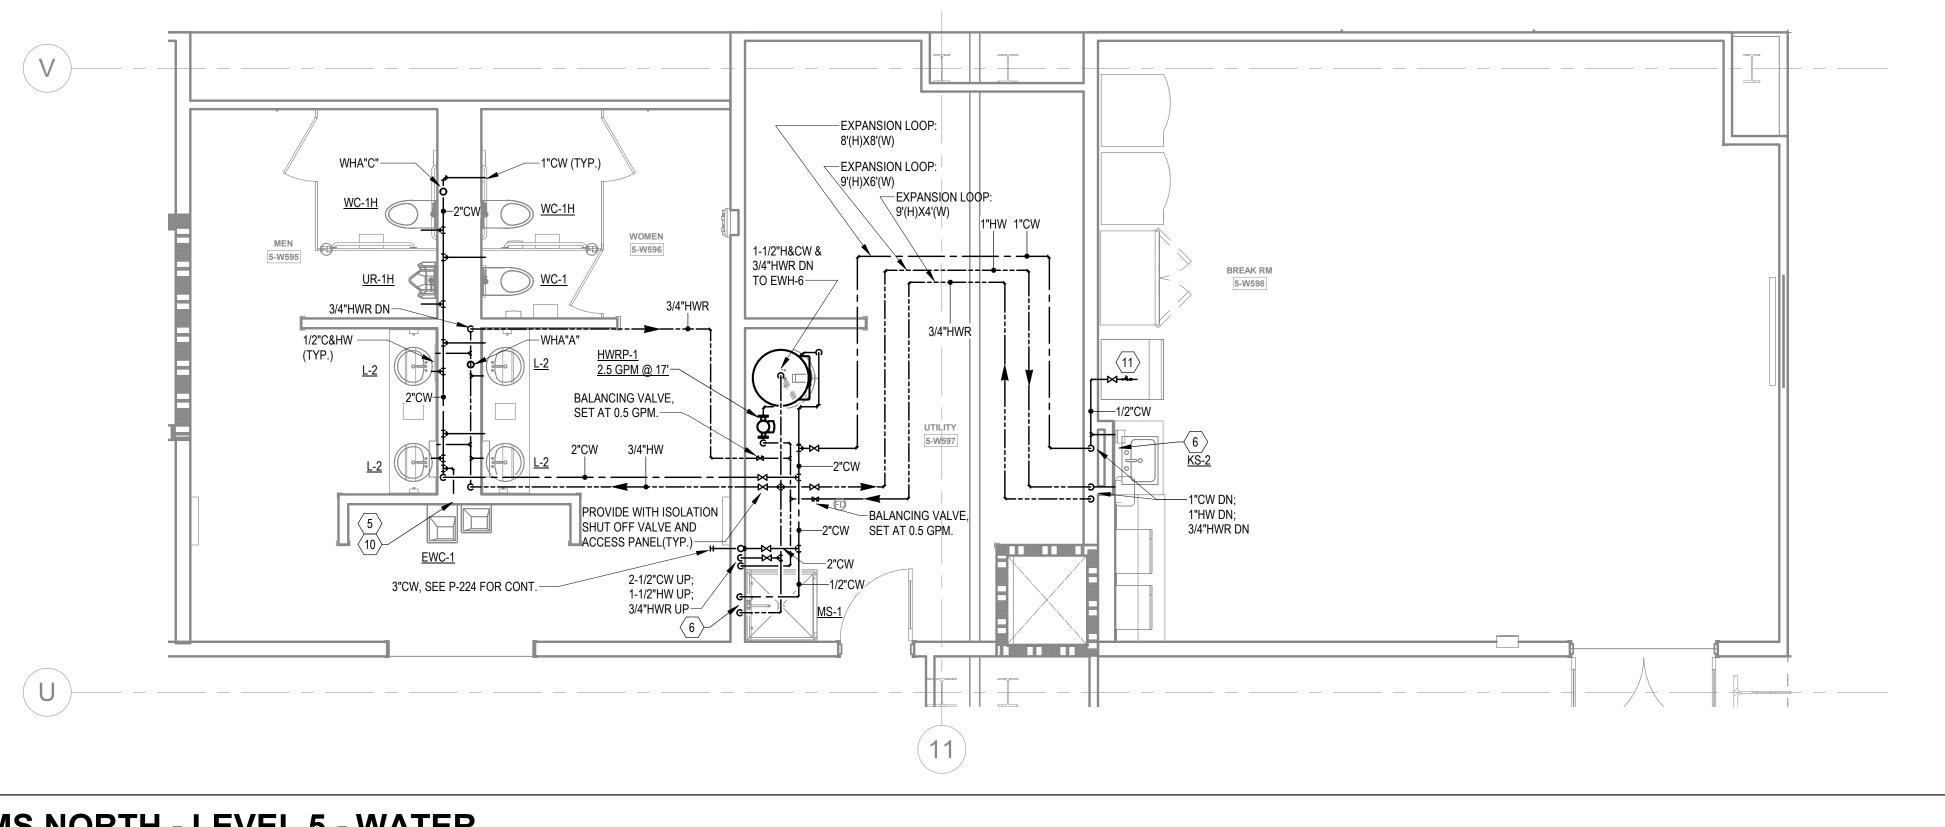


# **ENLARGED RESTROOMS NORTH - LEVEL 5 - WATER**

1/4" = 1'-0"

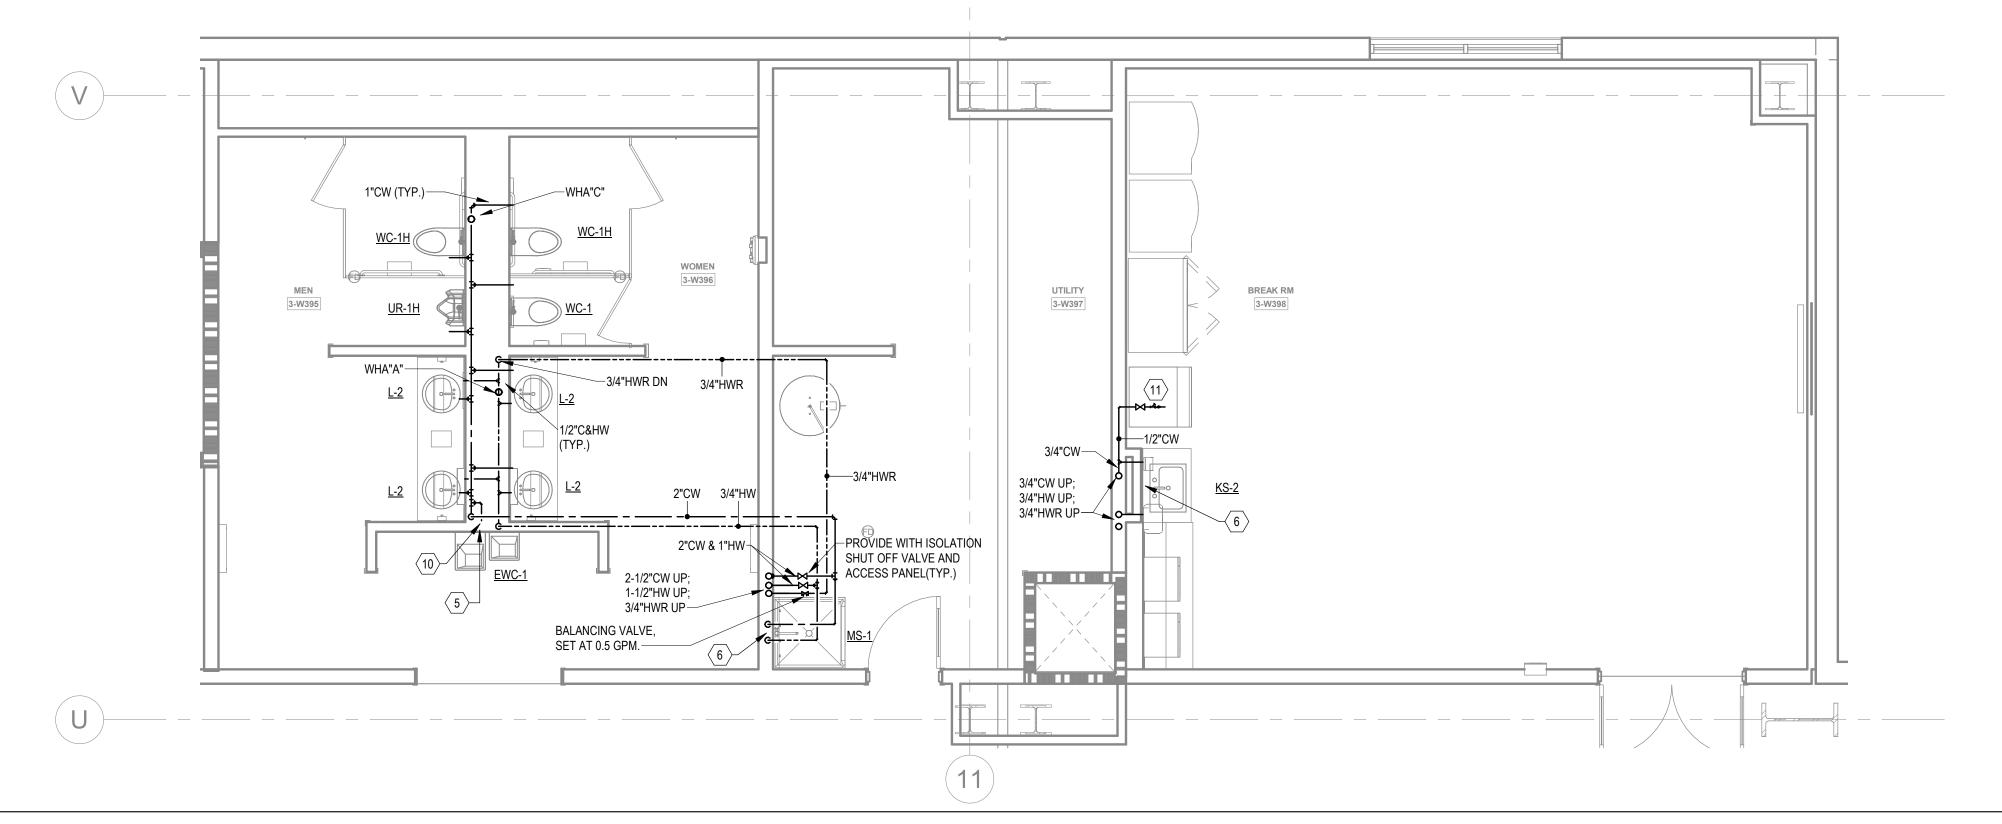

# 2 ENLARGED RESTROOMS NORTH - LEVEL 3-4 - WATER

1/4" = 1'-0"

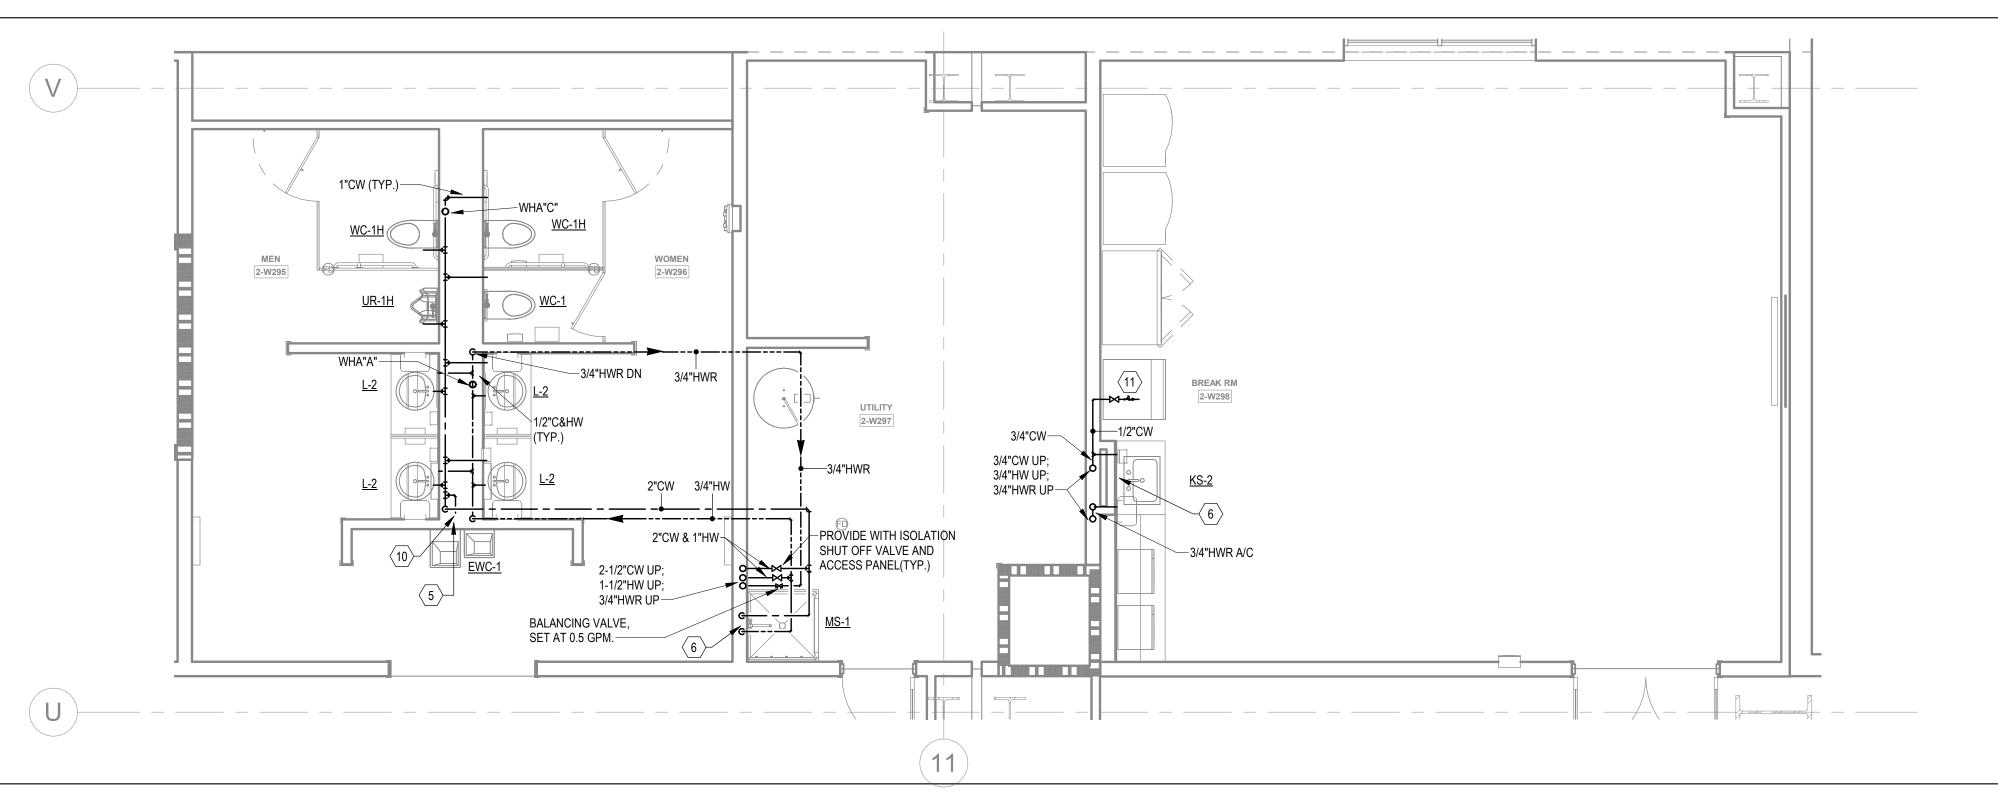

**KEYNOTES** 

1 2" W DN & 2" V UP

- 2 2" V UP

  1/2" CW TO EWH & 1/2"CW TO LAV(KS). PROVIDE 1/2" HW FOR EWH TO LAV(KS).
  - TO LAV(KS).

    2" CW DN TO HEADER, PROVIDE 1" CW TO EACH WC AND 3/4" CW TO UR.
- 5 2" CW DN TO HEADER. 3/4" HW DN TO HEADER. PROVIDE 1" CW TO EACH WC, 3/4" TO EACH UR & 1/2"H&CW TO EACH LAV.
- 6 1/2" H & CW DN.
  7 1" H & CW DN TO HEADER, PROVIDE 1/2" H & CW TO EACH LAV & KS.
- 8 1" H & CW DN TO HEADER, PROVIDE 1/2" H & CW TO EACH LAV.
- 9 1-1/2" CW & 3/4"HW DN TO HEADER. PROVIDE 1" CW TO EACH WC, 1/2"H&CW TO LAV(KS).
- 10 PROVIDE 2" WASTE AND 1/2" CW FOR DRINKING FOUNTAINS.
- 11 1/2" CW. PROVIDE 1/2" SHUT-OFF VALVE & WATTS #SD-3 BACKFLOW PREVENTER, ASSE 1022.
  12 2-1/2" CW DN TO HEADER, CONNECT 1" CW TO EACH WC.
- 13 1-1/2" CW DN TO HEADER. PROVIDE 1" CW TO WC AND 1/2" TO LAV.
  PROVIDE 1/2" WATER TAP WITH BALL VALVE AND COPPER
  MANIFOLD. ROUTE 1/2" COPPER PIPING FROM TAP TO EACH
- OWNER PROVIDED WATER COOLER. STUB COPPER PIPING 24"
  ABOVE FLOOR AT WATER COOLER LOCATION. PROVIDE 1/2" X 3/8"
  ANGLE STOP SUPPLY VALVE. ALL LOCATIONS TO BE REVIEWED BY TENANT PRIOR TO INSTALLATION.

JSE
Jordan & Skala

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Project Number:2110820
Drawn By:Author Checked By:Checker

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PROJECT INFORMATION

PROJECT WHALE

WILMINGTON, NC

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01/21/22 2021-136

SHEET TITLE

ENLARGED

RESTROOM PLANS - WATER


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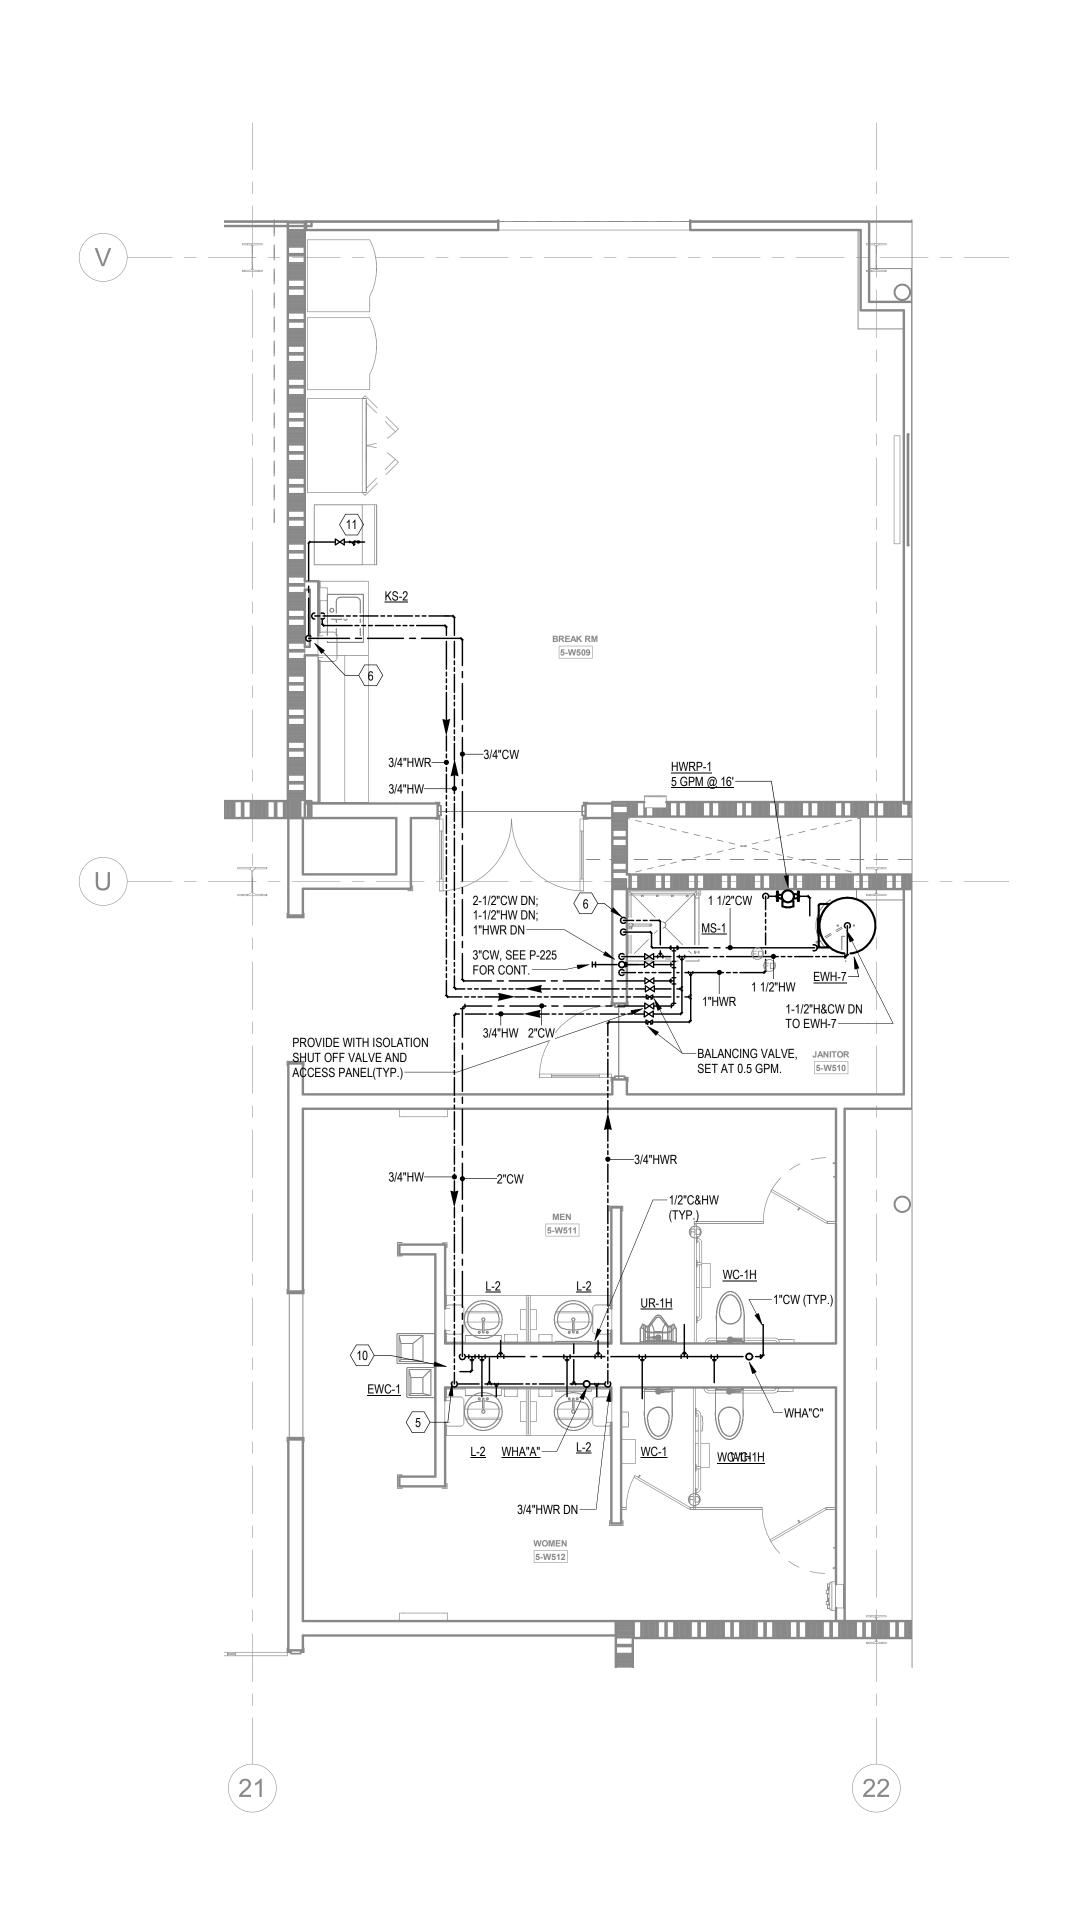
P-406B


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**ENLARGED RESTROOMS & BREAKROOM NORTH - LEVEL 2 - WATER** 

1/4" = 1'-0"





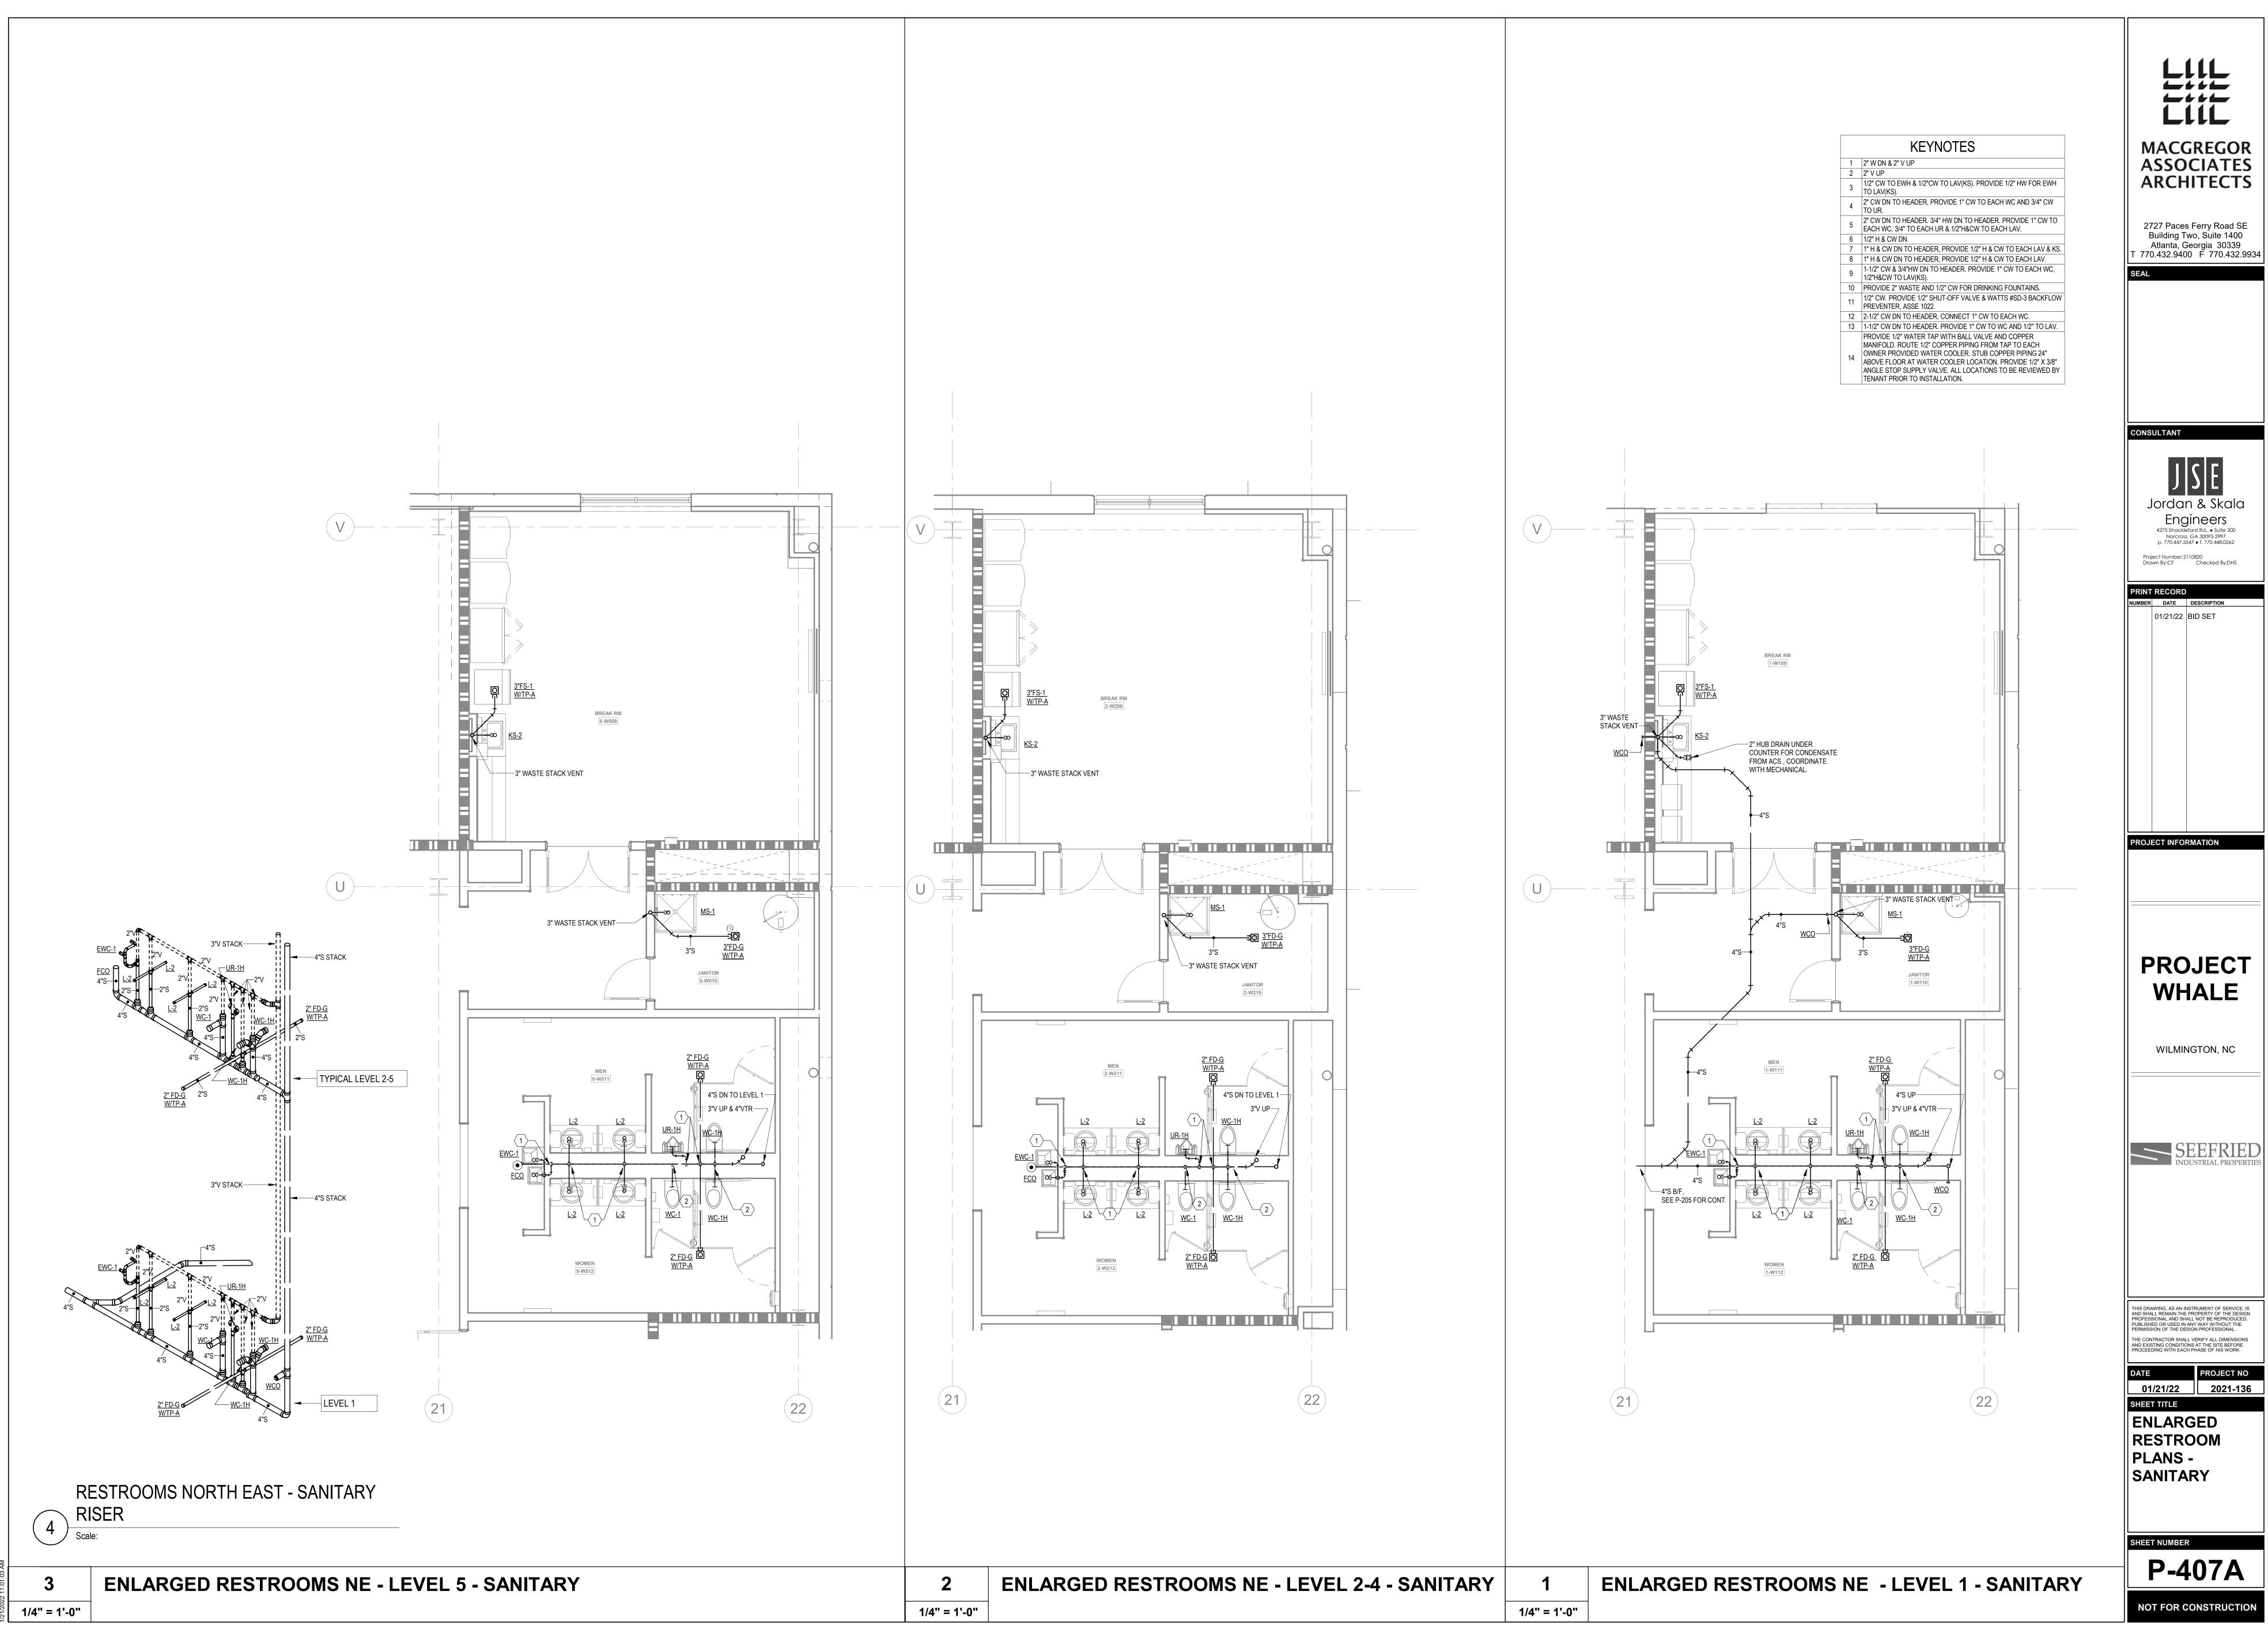

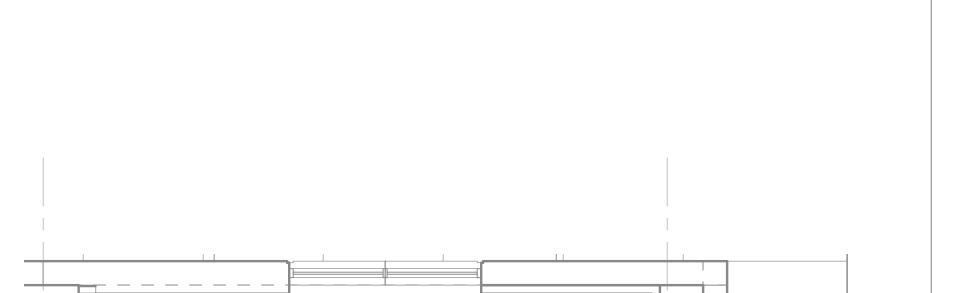SHUT OFF VALVE AND ACCESS PANEL(TYP.)

2"CW DN TO SECONDARY GUARDHOUSE, SEE CIVIL FOR CONT.

BALANCING VALVE, SET AT 0.5 GPM.

1-W109

### KEYNOTES

- 1 2" W DN & 2" V UP
- 2 2" V UP 3 1/2" CW TO EWH & 1/2"CW TO LAV(KS). PROVIDE 1/2" HW FOR EWH TO LAV(KS).
- 4 2" CW DN TO HEADER, PROVIDE 1" CW TO EACH WC AND 3/4" CW TO UR.
- 2" CW DN TO HEADER. 3/4" HW DN TO HEADER. PROVIDE 1" CW TO EACH WC, 3/4" TO EACH UR & 1/2"H&CW TO EACH LAV.
- 6 1/2" H & CW DN. 7 1" H & CW DN TO HEADER, PROVIDE 1/2" H & CW TO EACH LAV & KS.
- 8 1" H & CW DN TO HEADER, PROVIDE 1/2" H & CW TO EACH LAV. 9 1-1/2" CW & 3/4"HW DN TO HEADER. PROVIDE 1" CW TO EACH WC, 1/2"H&CW TO LAV(KS).
- 10 PROVIDE 2" WASTE AND 1/2" CW FOR DRINKING FOUNTAINS.
- 11 1/2" CW. PROVIDE 1/2" SHUT-OFF VALVE & WATTS #SD-3 BACKFLOW PREVENTER, ASSE 1022. 12 2-1/2" CW DN TO HEADER, CONNECT 1" CW TO EACH WC.
- 13 1-1/2" CW DN TO HEADER. PROVIDE 1" CW TO WC AND 1/2" TO LAV. PROVIDE 1/2" WATER TAP WITH BALL VALVE AND COPPER MANIFOLD. ROUTE 1/2" COPPER PIPING FROM TAP TO EACH
- OWNER PROVIDED WATER COOLER. STUB COPPER PIPING 24"
- ABOVE FLOOR AT WATER COOLER LOCATION. PROVIDE 1/2" X 3/8" ANGLE STOP SUPPLY VALVE. ALL LOCATIONS TO BE REVIEWED BY TENANT PRIOR TO INSTALLATION.

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ENLARGED RESTROOM PLANS - WATER

SHEET NUMBER

P-407B

NOT FOR CONSTRUCTION

**ENLARGED RESTROOMS NORTH EAST - LEVEL 1-4 - WATER** 

<u>wha"a"</u>

<u>WC-1</u>

