

THE LINE SHOWN ABOVE IS
BASED ON THE FOLLOWING SIZE
THIS DRAWING IS NOT TO SCALE

E

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C

B

A

GENERAL SHEET NOTES

- DIMENSIONS TO FACE OF PARTITIONS ARE TO FACE OF STUD. FINISHES DEPICTED IN FINISH PLANS AND ELEVATIONS ARE NOT SHOWN ON PARTIAL FLOOR PLANS. REFER TO ENLARGED PLANS, ELEVATIONS, AND DETAILS.
- LOCATE DOOR OPENINGS 4" FROM NEAREST PERPENDICULAR WALL.
- FIRE AND SOUND RATED WALLS/PARTITIONS TO BE CONSTRUCTED TIGHT TO STRUCTURE, PIPING, DUCTWORK AND OTHER PENETRATIONS. ALL WORK IS TO BE BRACED TO STRUCTURE ABOVE.
- WHERE PARTITIONS OF DIFFERENT FIRE RATINGS INTERSECT, THE HIGHEST RATED PARTITION SHALL CONTINUE THROUGH. MAINTAIN PARTITION FIRE RATING BEHIND RECESSED FIRE EXTINGUISHER CABINETS.
- SEE LIFE SAFETY PLANS FOR REQUIRED FIRE SEPARATION WALLS. CONSTRUCTION SUBSYSTEMS ARE TAGGED ON OVERALL PLANS.
- SEE AREA PLANS FOR PARTITION TAGS. SEE SHEET A-002 FOR CONSTRUCTION SUBSYSTEMS AND PARTITION SCHEDULE.

1/8/2021 3:42:19 PM
A1
A-101

OVERALL FLOOR PLAN- LEVEL 1

1


2

3

4

5

6

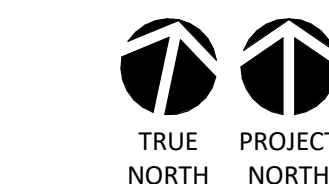

3/32" = 1'-0"

SHEET NAME:
FLOOR PLAN- LEVEL
1

ORIG SUBMISSION: 2020.12.16
CURRENT: 2021.01.08
ADDENDUM #2

SHEET:

A-101

GMP SET

NEW HANOVER COUNTY GOVERNMENT CENTER

GOVERNMENT CENTER DRIVE
WILMINGTON, NC 28403

LS3P PROJECT: 7702-190810

NHC Government Center 7702-190810

NOT FOR
CONSTRUCTION

101 NORTH THIRD STREET, SUITE 500
WILMINGTON, NORTH CAROLINA 28401
TEL. 910.790.9901 FAX. 910.790.3111
WWW.LS3P.COM



CAPE FEAR FD STONEWATER



THE LINE SHOWN ABOVE IS
BASED ON THE FOLLOWING SIZE
THESE DIMENSIONS ARE FOR
REFERENCE ONLY

E

D

C


B

A

1/8/2021 3:42:36 PM
A1
A-101C

FLOOR PLAN- PARTIAL- LEVEL 1- AREA C

1/8" = 1'-0"

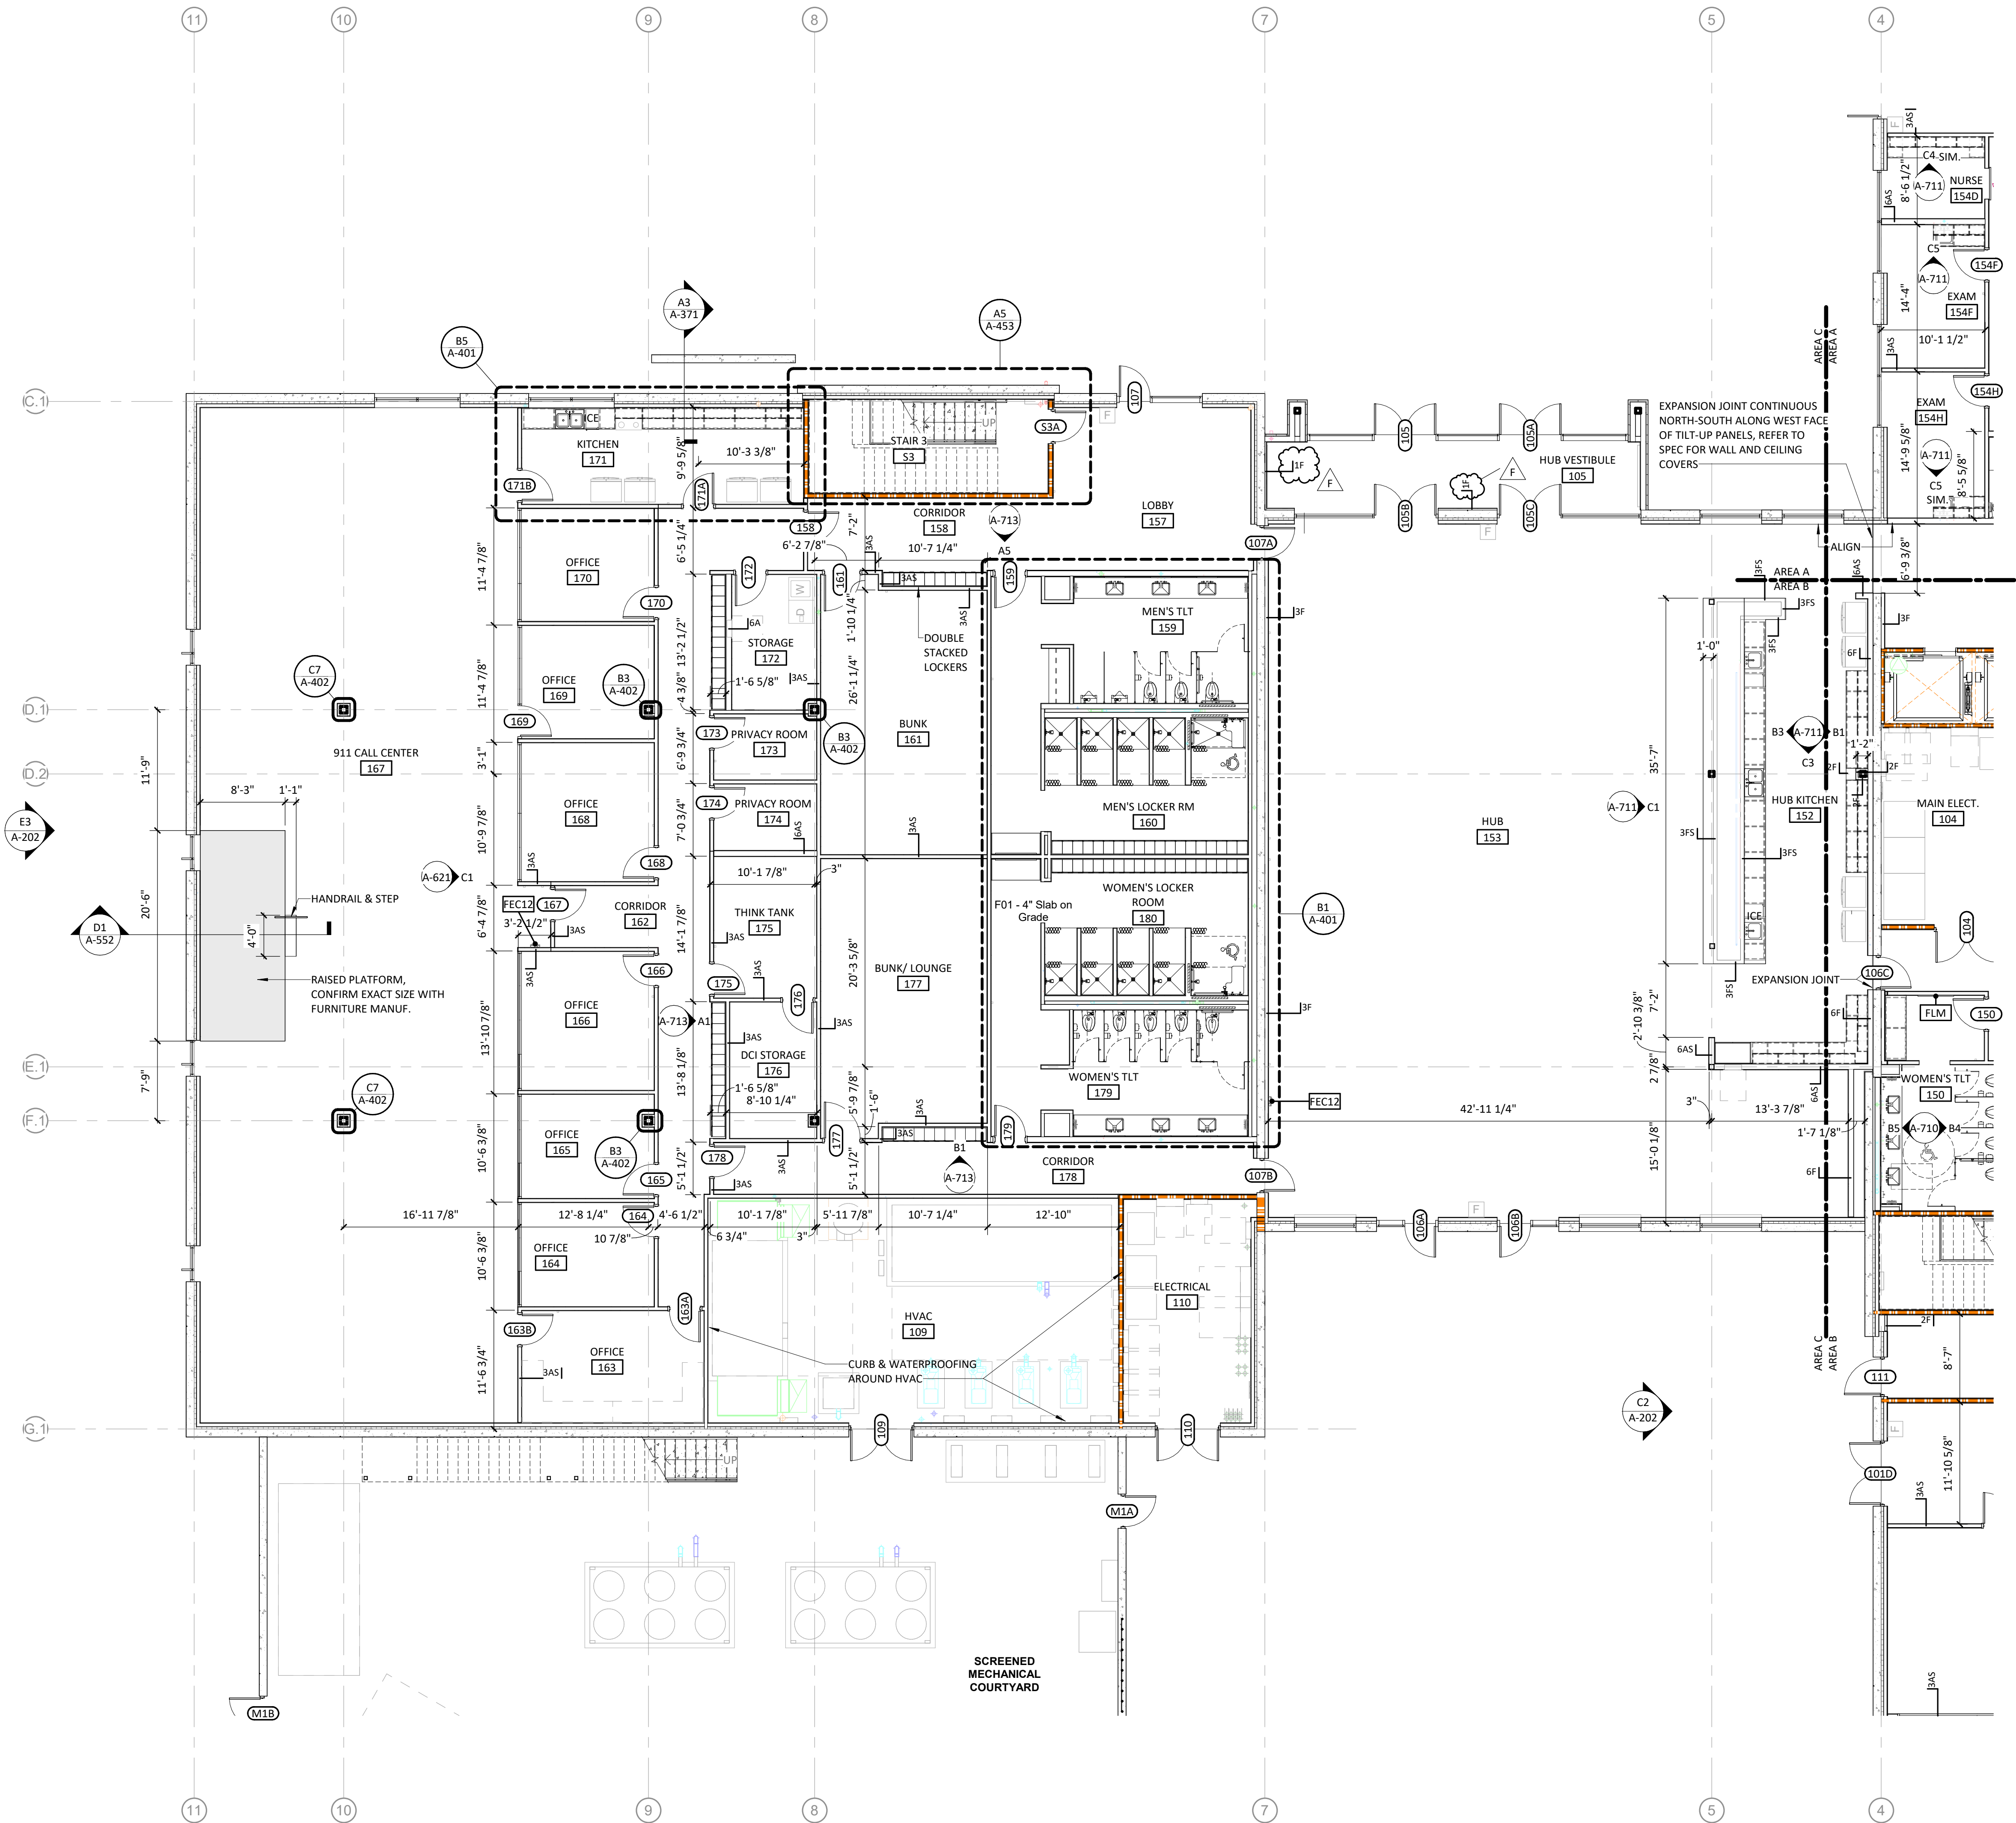

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- INSTALL BLOCKING IN PARTITIONS FOR CASEWORK, WALL MOUNTED EQUIPMENT, TRIM AND RELATED CONSTRUCTION.
- AT ANY LOCATION WHERE AN INTERIOR WALL TERMINATES AT AN EXTERIOR STOREFRONT, INSTALL MULLION MATE AT INTERSECTION OF WALL AND STOREFRONT.
- SEE LIFE SAFETY PLANS FOR REQUIRED FIRE SEPARATION WALLS.
- PARTITION TYPES ARE TAGGED ON AREA PLANS. SEE GENERAL PLANS FOR CONSTRUCTION SUBSYSTEMS. SEE SHEET A-202 FOR CONSTRUCTION SUBSYSTEMS AND PARTITION SCHEDULE.
- SEE SHEET A-710 THROUGH A-713 FOR INTERIOR ELEVATIONS.
- SEE SHEETS A-801 THROUGH A-804 FOR FINISH FLOORING, TRANSITIONS, PATTERNS AND WALL PROTECTION.
- SEE SHEETS A-401 & A-402 FOR ENLARGED PLANS INDICATING ADDITIONAL DIMENSIONS AND PARTITION TYPES, ACCESSORIES AND MOUNTING HEIGHTS.
- SEE STRUCTURAL DRAWINGS FOR SLAB DEPRESSIONS AND CUTOUTS.
- WHERE STRUCTURAL STEEL MEMBERS ARE EXPOSED AND NOT CONCEALED W/OTHER CONSTRUCTION, PAINT FINISH TO MATCH STOREFRONT/ CURTAIN WALL FRAME SYSTEMS, TYP.
- GYPSUM WALL BOARD ON EXTERIOR WALLS IS PART OF CORE & SHELL PHASE.
- INSTALL PT WOOD BLOCKING IN WALLS AT ALL SCREEN LOCATIONS. SEE AV DRAWINGS.

PARTITION TYPE NOTES

- ALL NON-DESIGNATED PARTITIONS SHALL BE TYPE 3A.
- TILE BACKER BOARD SHALL BE USED IN ALL LOCATIONS TO RECEIVE TILE FINISHES. REFER TO FINISH SCHEDULE AND INTERIOR ELEVATIONS FOR LOCATIONS.
- CONTRACTOR SHALL COORDINATE WITH MECHANICAL DUCTWORK PRIOR TO FABRICATION OF PARTITION WALLS.
- SHOULD CONDITIONS OCCUR WHERE A WALL IS UNABLE TO GO STRAIGHT UP TO STRUCTURE DUE TO PIPING, DUCTWORK, ETC., THE PARTITION (GYPSUM BOARD AND FRAMING) MAY JOG HORIZONTALLY ABOVE THE CEILING TO AVOID THE PROBLEM. RATED WALL INTEGRITY SHALL BE MAINTAINED.
- WHERE STUDS EXTEND TO STRUCTURE AND GYPSUM WALLBOARD AND SOUND ATTENUATION BLANKETS EXTEND JUST ABOVE THE FINISH CEILING, CAP OFF PARTITION FINISHES WITH A RUNNER CHANNEL WHEN CEILING PLENUM IS USED AS A RETURN AIR PLENUM.
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- SEE LIFE SAFETY PLANS FOR THE LOCATIONS OF SMOKE BARRIERS, SMOKE PARTITIONS AND FIRE-RATED PARTITIONS.
- REFER TO UNDERWRITERS LABORATORIES, INC. FIRE RESISTANCE VOLUMES - CURRENT EDITION FOR SPECIFIC CONSTRUCTION REQUIREMENTS OF U.L. LISTED ASSEMBLIES. REFER TO MECHANICAL, ELECTRICAL AND PLUMBING DRAWINGS FOR TYPICAL U.L. LISTED PENETRATIONS THROUGH FIRE-RATED ASSEMBLIES. CONTRACTOR SHALL BE RESPONSIBLE FOR PROVIDING APPROPRIATE PROJECT-SPECIFIC U.L. LISTED ASSEMBLIES FOR PENETRATIONS.
- REFER TO DETAIL MECH. DWGS. FOR TYPICAL WALL FRAMING FOR FIRE DAMPERS IN RATED WALLS. COORDINATE EXACT FRAMING REQUIREMENTS WITH FIRE DAMPER MANUFACTURER. (COORDINATE ALL PARTITION CONSTRUCTION WITH MECHANICAL PRIME CONTRACTOR PRIOR TO COMMENCING PARTITION CONSTRUCTION).



CAPE FEAR FD STONEWATER



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WILMINGTON, NORTH CAROLINA 28401
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NOT FOR
CONSTRUCTION


NHC Government Center 7702-190810

NEW HANOVER COUNTY
GOVERNMENT CENTER
GOVERNMENT CENTER DRIVE
WILMINGTON, NC 28403

LS3P PROJECT: 7702-190810

| A | DATE | DESCRIPTION |
|---|------------|------------------------|
| A | 2020.08.18 | T1- SCHEMATIC DESIGN |
| B | 2020.10.16 | T1- DESIGN DEVELOPMENT |
| C | 2020.11.20 | T1 GMP SET |
| D | 2020.12.16 | GMP SET |
| E | 2020.12.22 | ADDENDUM #1 |
| F | 2021.01.08 | ADDENDUM #2 |

KEY PLAN:

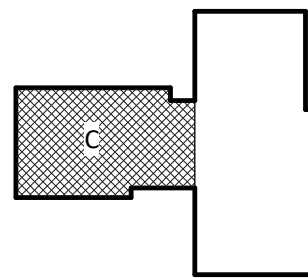

SHEET NAME:
FLOOR PLAN- LEVEL
1- AREA C

ORIG SUBMISSION: 2020.12.16
CURRENT: 2021.01.08
ADDENDUM #2

SHEET:

A-101C

GMP SET

THE LINE SHOWN ABOVE IS
BACK TO FACE OF PARTITION. SEE
THIS SHEET FOR PARTITION SCHEDULE.

E

D

C

B

A

GENERAL SHEET NOTES

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- SEE LIFE SAFETY PLANS FOR REQUIRED FIRE SEPARATION WALLS.
- CONSTRUCTION SUBSYSTEMS ARE TAGGED ON OVERALL PLANS. SEE AREA PLANS FOR PARTITION TAGS. SEE SHEET A-002 FOR CONSTRUCTION SUBSYSTEMS AND PARTITION SCHEDULE.

A1
A-102

OVERALL FLOOR PLAN- LEVEL 2

1

2

3

4

5

6



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NHC Government Center 7702-190810

NEW HANOVER COUNTY GOVERNMENT CENTER GOVERNMENT CENTER DRIVE WILMINGTON, NC 28403

LS3P PROJECT: 7702-190810

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| C | 2020.12.16 | GMP SET |
| D | 2021.01.08 | ADDENDUM #2 |


SHEET NAME:
FLOOR PLAN- LEVEL
2

ORIG SUBMISSION: 2020.12.16
CURRENT: 2021.01.08
ADDENDUM #2

SHEET:

A-102


GMP SET

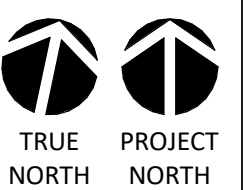

3/32" = 1'-0"

PARTITION TYPE NOTES

1. ALL NON-DESIGNATED PARTITIONS SHALL BE TYPE 3A.
2. THE BACKER BOARD SHALL BE USED IN ALL LOCATIONS TO RECEIVE THE FINISHES.
3. REFER TO FINISH SCHEDULE AND INTERIOR ELEVATIONS FOR LOCATIONS.
4. CONTRACTOR SHALL COORDINATE WITH MECHANICAL DUCTWORK PRIOR TO FABRICATION OF PARTITION WALLS.
5. SHOULD CONDITIONS OCCUR WHERE A WALL IS UNABLE TO GO STRAIGHT UP TO STRUCTURE DUE TO PIPING, DUCTWORK, ETC., THE PARTITION (GYPSUM BOARD AND FINISH) MAY JOG HEREIN TO FOLLOW WALL AND CEILING TO AVOID THE PROBLEM.
6. RATED WALL INTEGRITY SHALL BE MAINTAINED.
7. WHERE STUDS EXTEND TO STRUCTURE AND GYPSUM WALLBOARD AND SOUND ATTENTION BLANKETS EXTEND JUST ABOVE THE FINISH CEILING, CAP OFF PARTITION WITH A RUNNER CHANNEL. WHEN CEILING PLENUM IS USED AS A RETURN AIR PLENUM.
8. DIMENSIONAL CONFLICTS BETWEEN PARTITION TYPES AND THE ARCHITECTURAL FLOOR PLAN SHALL BE RESOLVED BY THE CONTRACTOR.
9. SEE LIFE SAFETY PLANS FOR THE LOCATIONS OF SMOKE BARRIERS, SMOKE PARTITIONS AND FIRE-RATED PARTITIONS.
10. REFER TO UNDERWRITERS LABORATORIES, INC. FIRE RESISTANCE VOLUMES - CURRENT EDITION FOR SPECIFIC RATING REQUIREMENTS OF U.L. LISTED ASSEMBLIES.
11. REFER TO MECHANICAL, ELECTRICAL AND PLUMBING DRAWINGS FOR TYPICAL U.L. LISTED PENETRATIONS THROUGH FIRE-RATED ASSEMBLIES. CONTRACTOR SHALL BE RESPONSIBLE FOR PROVIDING APPROPRIATE PROJECT-SPECIFIC U.L. LISTED ASSEMBLY DETAILATIONS.
12. REFER TO DETAIL MECH. DWGS. FOR TYPICAL WALL FRAMING FOR FIRE DAMPERS IN RATED WALLS. COORDINATE EXACT FRAMING REQUIREMENTS WITH FIRE DAMPER MANUFACTURER. COORDINATE WITH MECHANICAL CONTRACTOR FOR MECHANICAL PRIME CONTRACTOR PRIOR TO COMMENCING PARTITION CONSTRUCTION.

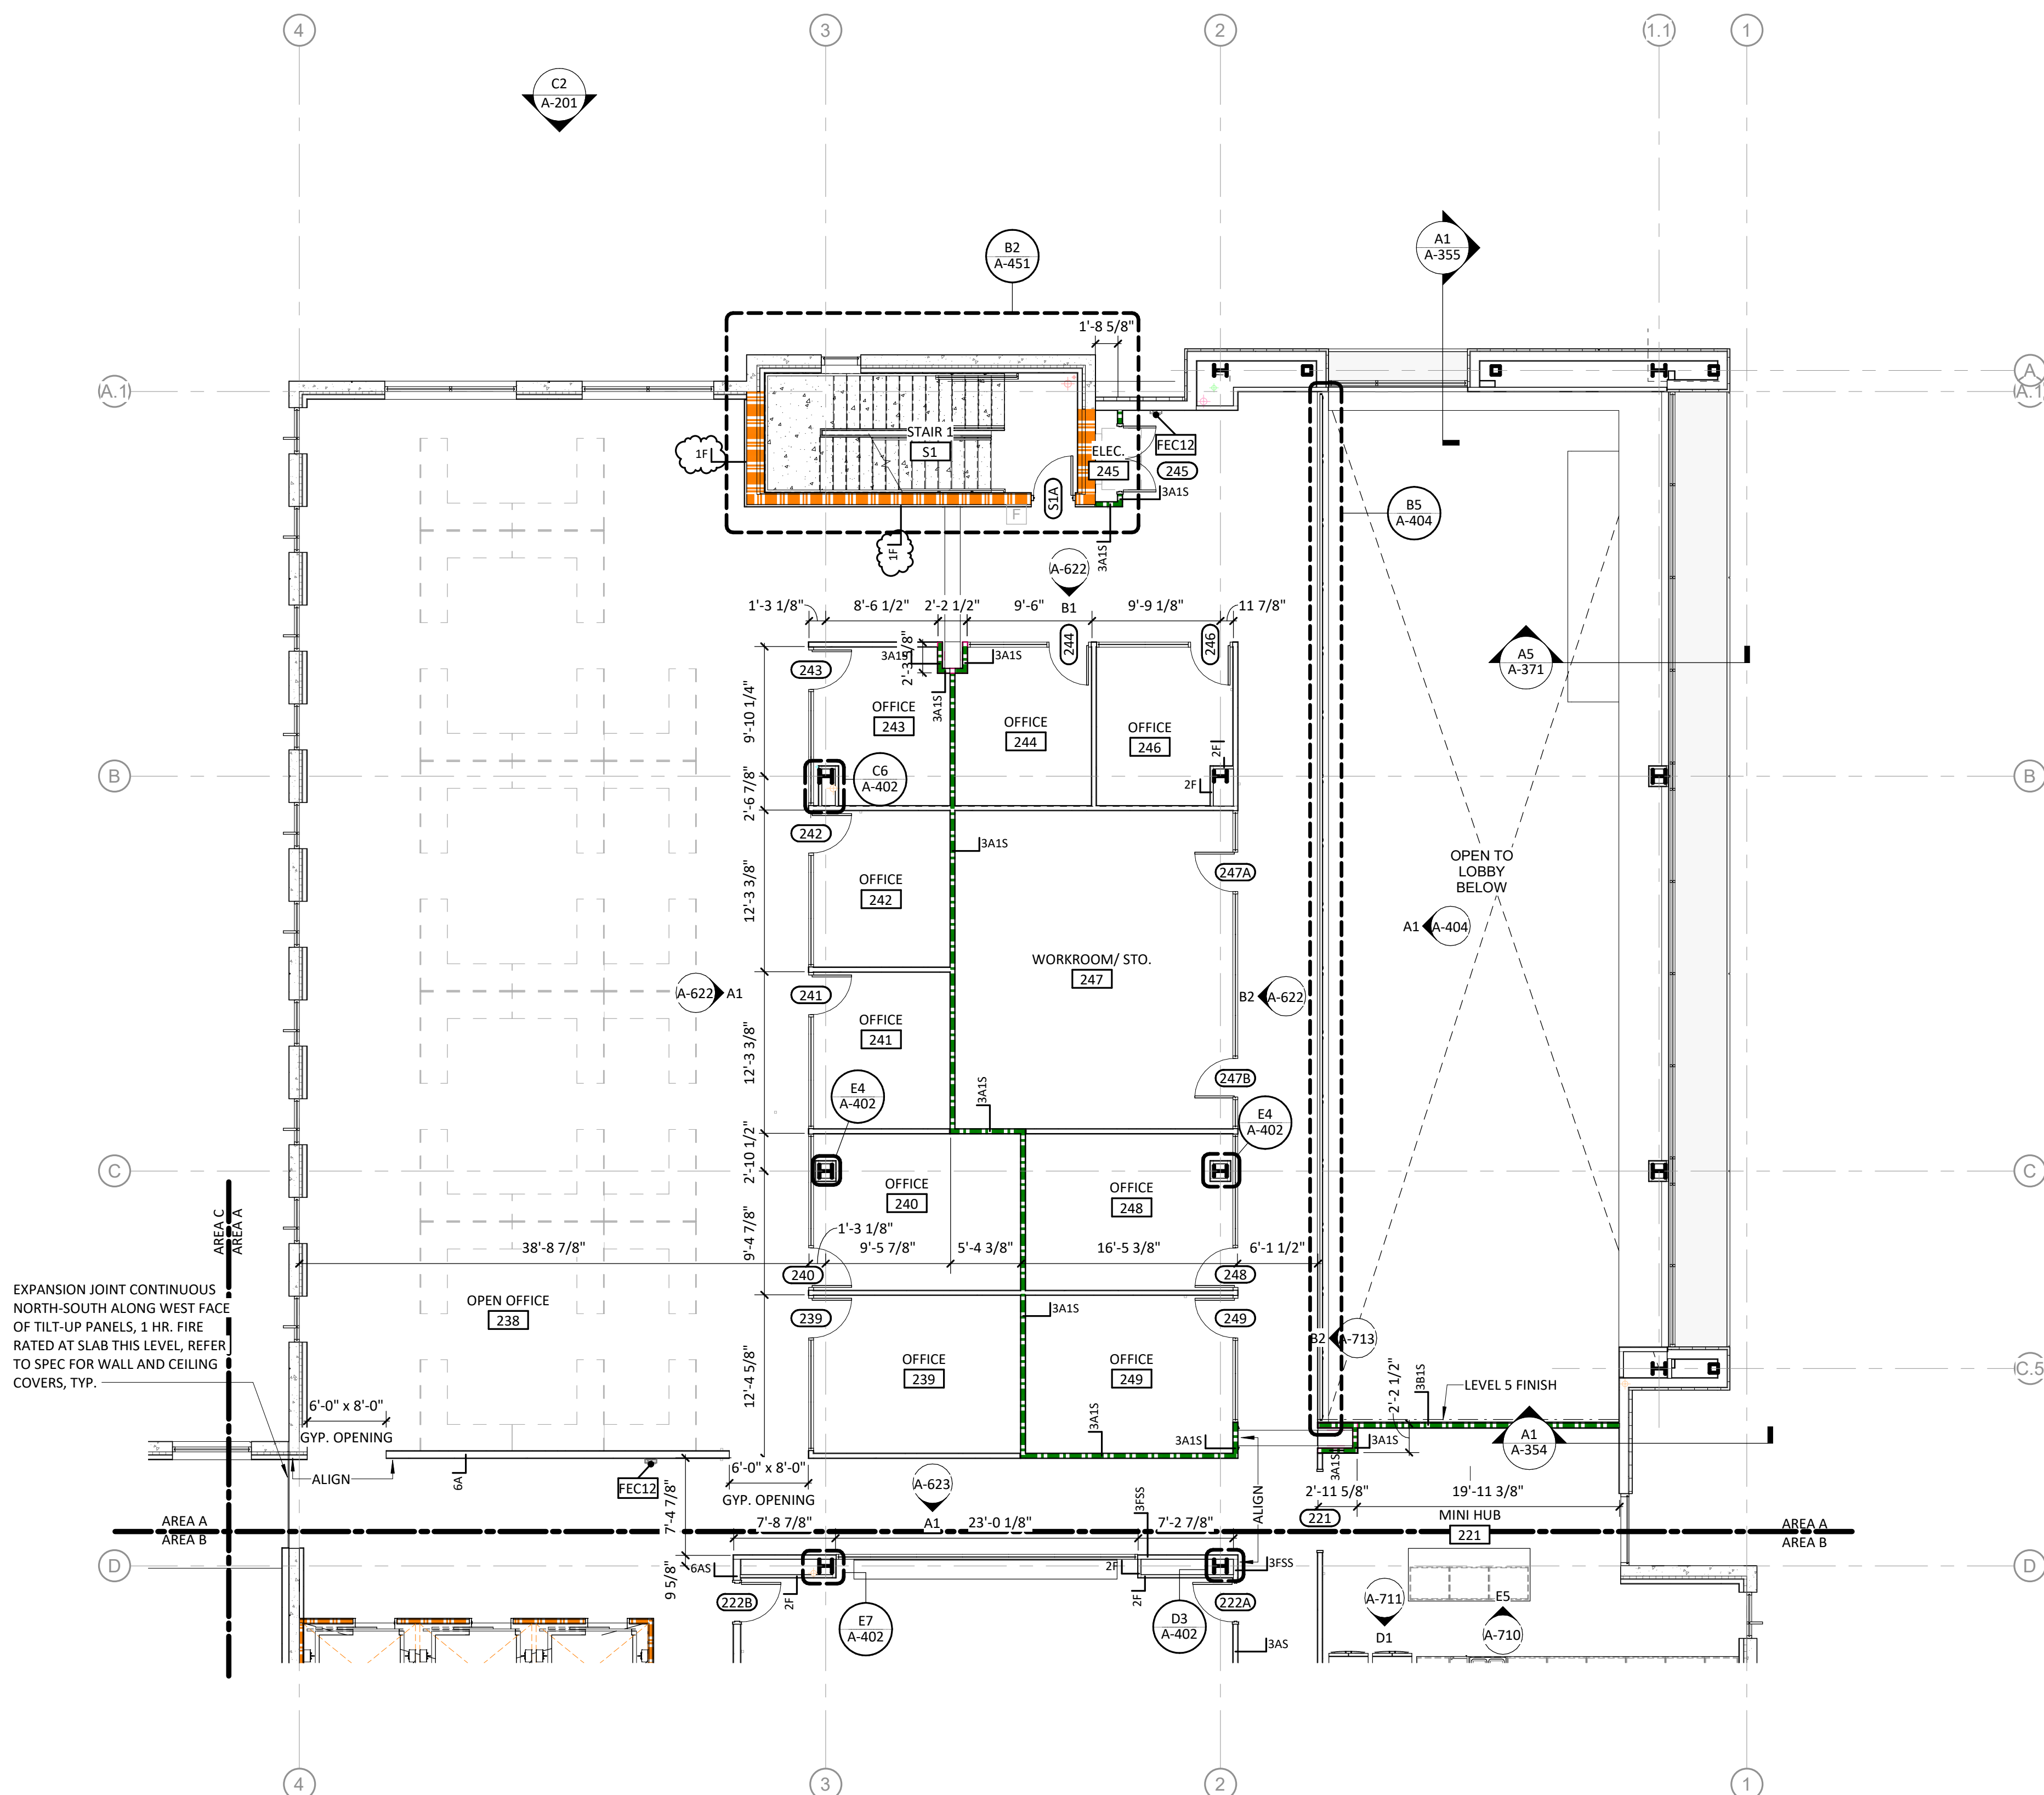

EXPANSION JOINT CONTINUOUS NORTH-SOUTH ALONG WEST FACE OF TILT-UP PANELS, 1 HR. FIRE RATED AT SLAB THIS LEVEL, REFER TO SPEC FOR WALL AND CEILING COVERS, TYP.

OPEN TO
LOBBY
BELOW

LEVEL

1

19'-11 3

MINI HUB
224

221

(A-)

10

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BASED ON THE FOLLOWING SIZE
THIS DRAWING IS FOR INFORMATION ONLY

E

D

C

B

A

1/8/2021 3:42:58 PM

A1
A-102C FLOOR PLAN- PARTIAL- LEVEL 2 - AREA C

1

2

3

4

5

6

1/8" = 1'-0"

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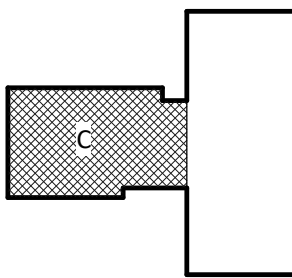
NHC Government Center 7702-190810

NEW HANOVER COUNTY
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| D | 2020.12.16 | GMP SET |
| E | 2020.12.22 | ADDENDUM #1 |
| F | 2021.01.08 | ADDENDUM #2 |

KEY PLAN:



SHEET NAME:
FLOOR PLAN- LEVEL
2- AREA C

ORIG SUBMISSION: 2020.12.16
CURRENT: 2021.01.08
ADDENDUM #2


SHEET:

A-102C

GMP SET



1/8/2021 3:43:17 PM
A1
A-103
OVERALL FLOOR PLAN- LEVEL 3
3/32" = 1'-0"
TRUE NORTH PROJECT NORTH

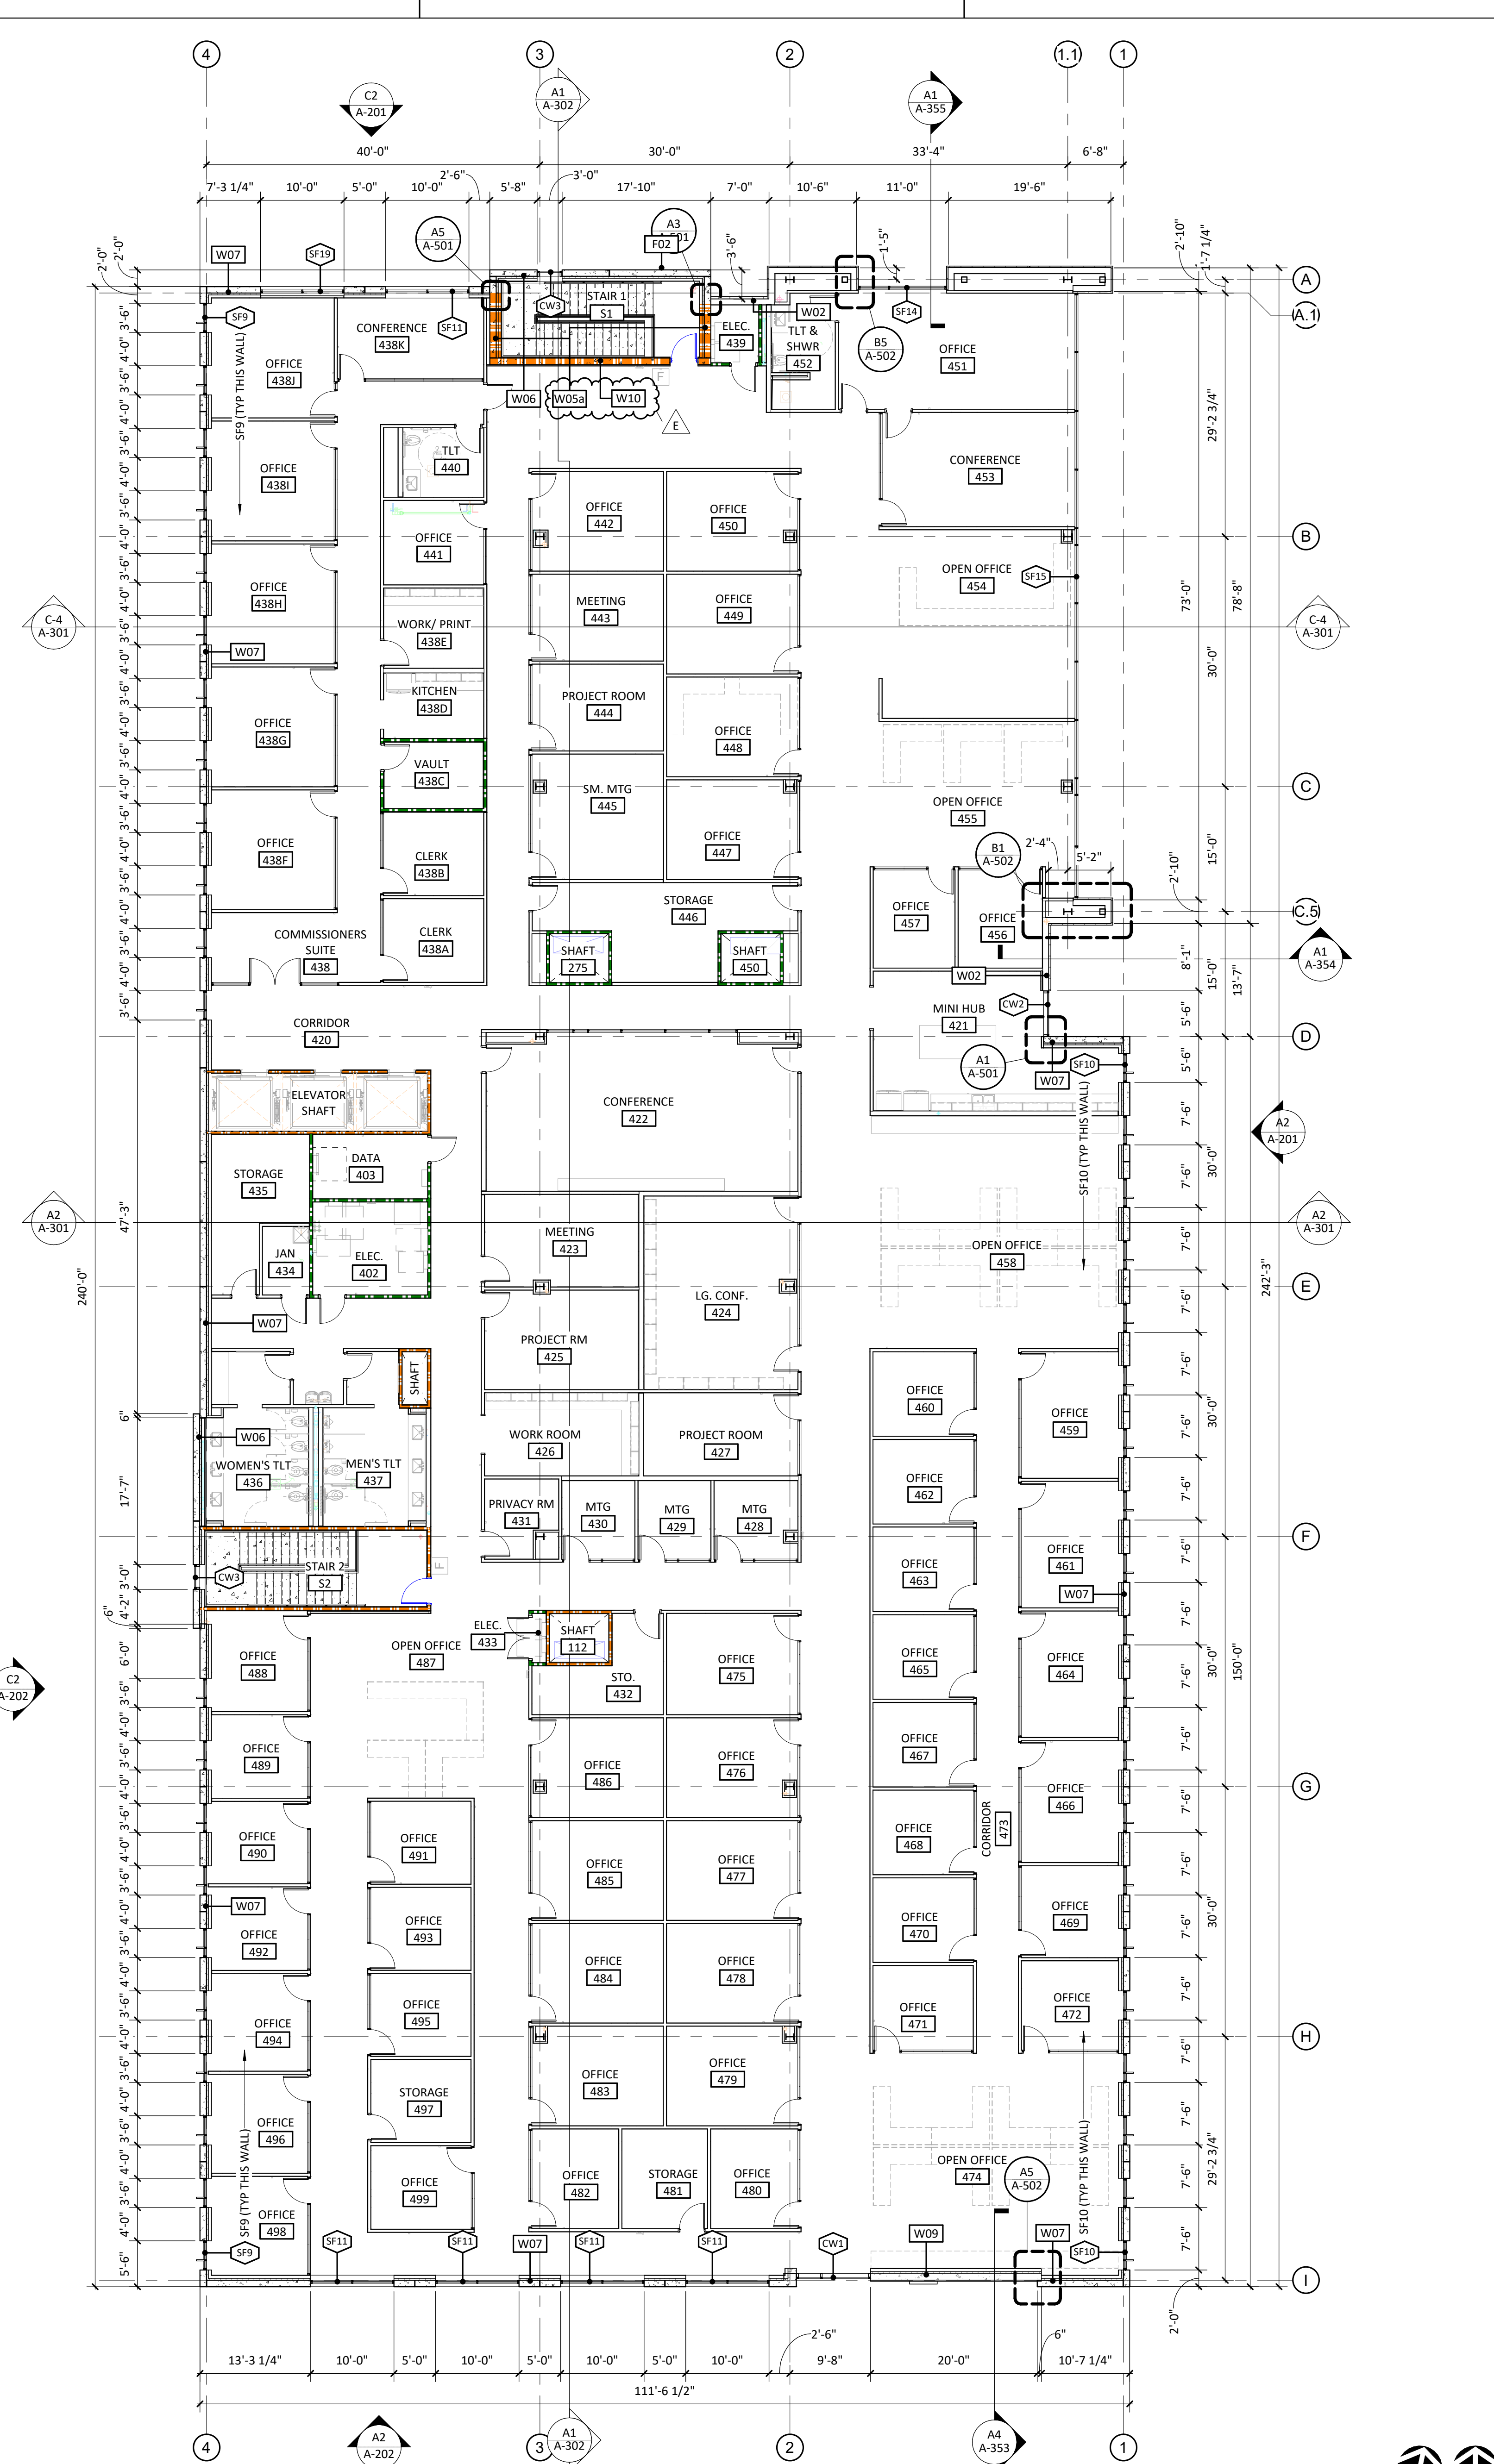

4
A4
A-103
OVERALL FLOOR PLAN- LEVEL 4
3/32" = 1'-0"
TRUE NORTH PROJECT NORTH



NEW HANOVER COUNTY • NORTH CAROLINA
ESTABLISHED 1710

CAPE FEAR FD STONEWATER



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LS3P ASSOCIATES, INC.
CERT. NO. 3417
WILMINGTON, NORTH CAROLINA

NOT FOR CONSTRUCTION

NHC Government Center 7702-190810

**NEW HANOVER COUNTY
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GOVERNMENT CENTER DRIVE
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KEY PLAN:



SHEET NAME:
FLOOR PLAN- LEVEL
3 & 4

ORIG SUBMISSION: 2020.12.16
CURRENT: 2021.01.08
ADDENDUM #2

SHEET:
A-103

GMP SET

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THIS DRAWING IS NOT TO BE
USED FOR CONSTRUCTION

E

D

C

B

A

1/8/2021 3:43:23 PM
A1
A-104A

FLOOR PLAN- PARTIAL- LEVEL 4 - AREA A

1/8" = 1'-0"

1

2

3

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5


6

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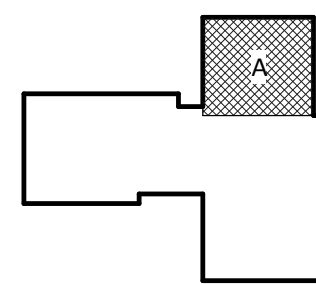
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SHEET NAME:
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4- AREA A

ORIG SUBMISSION: 2020.12.16
CURRENT: 2021.01.08
ADDENDUM #2

SHEET:

A-104A

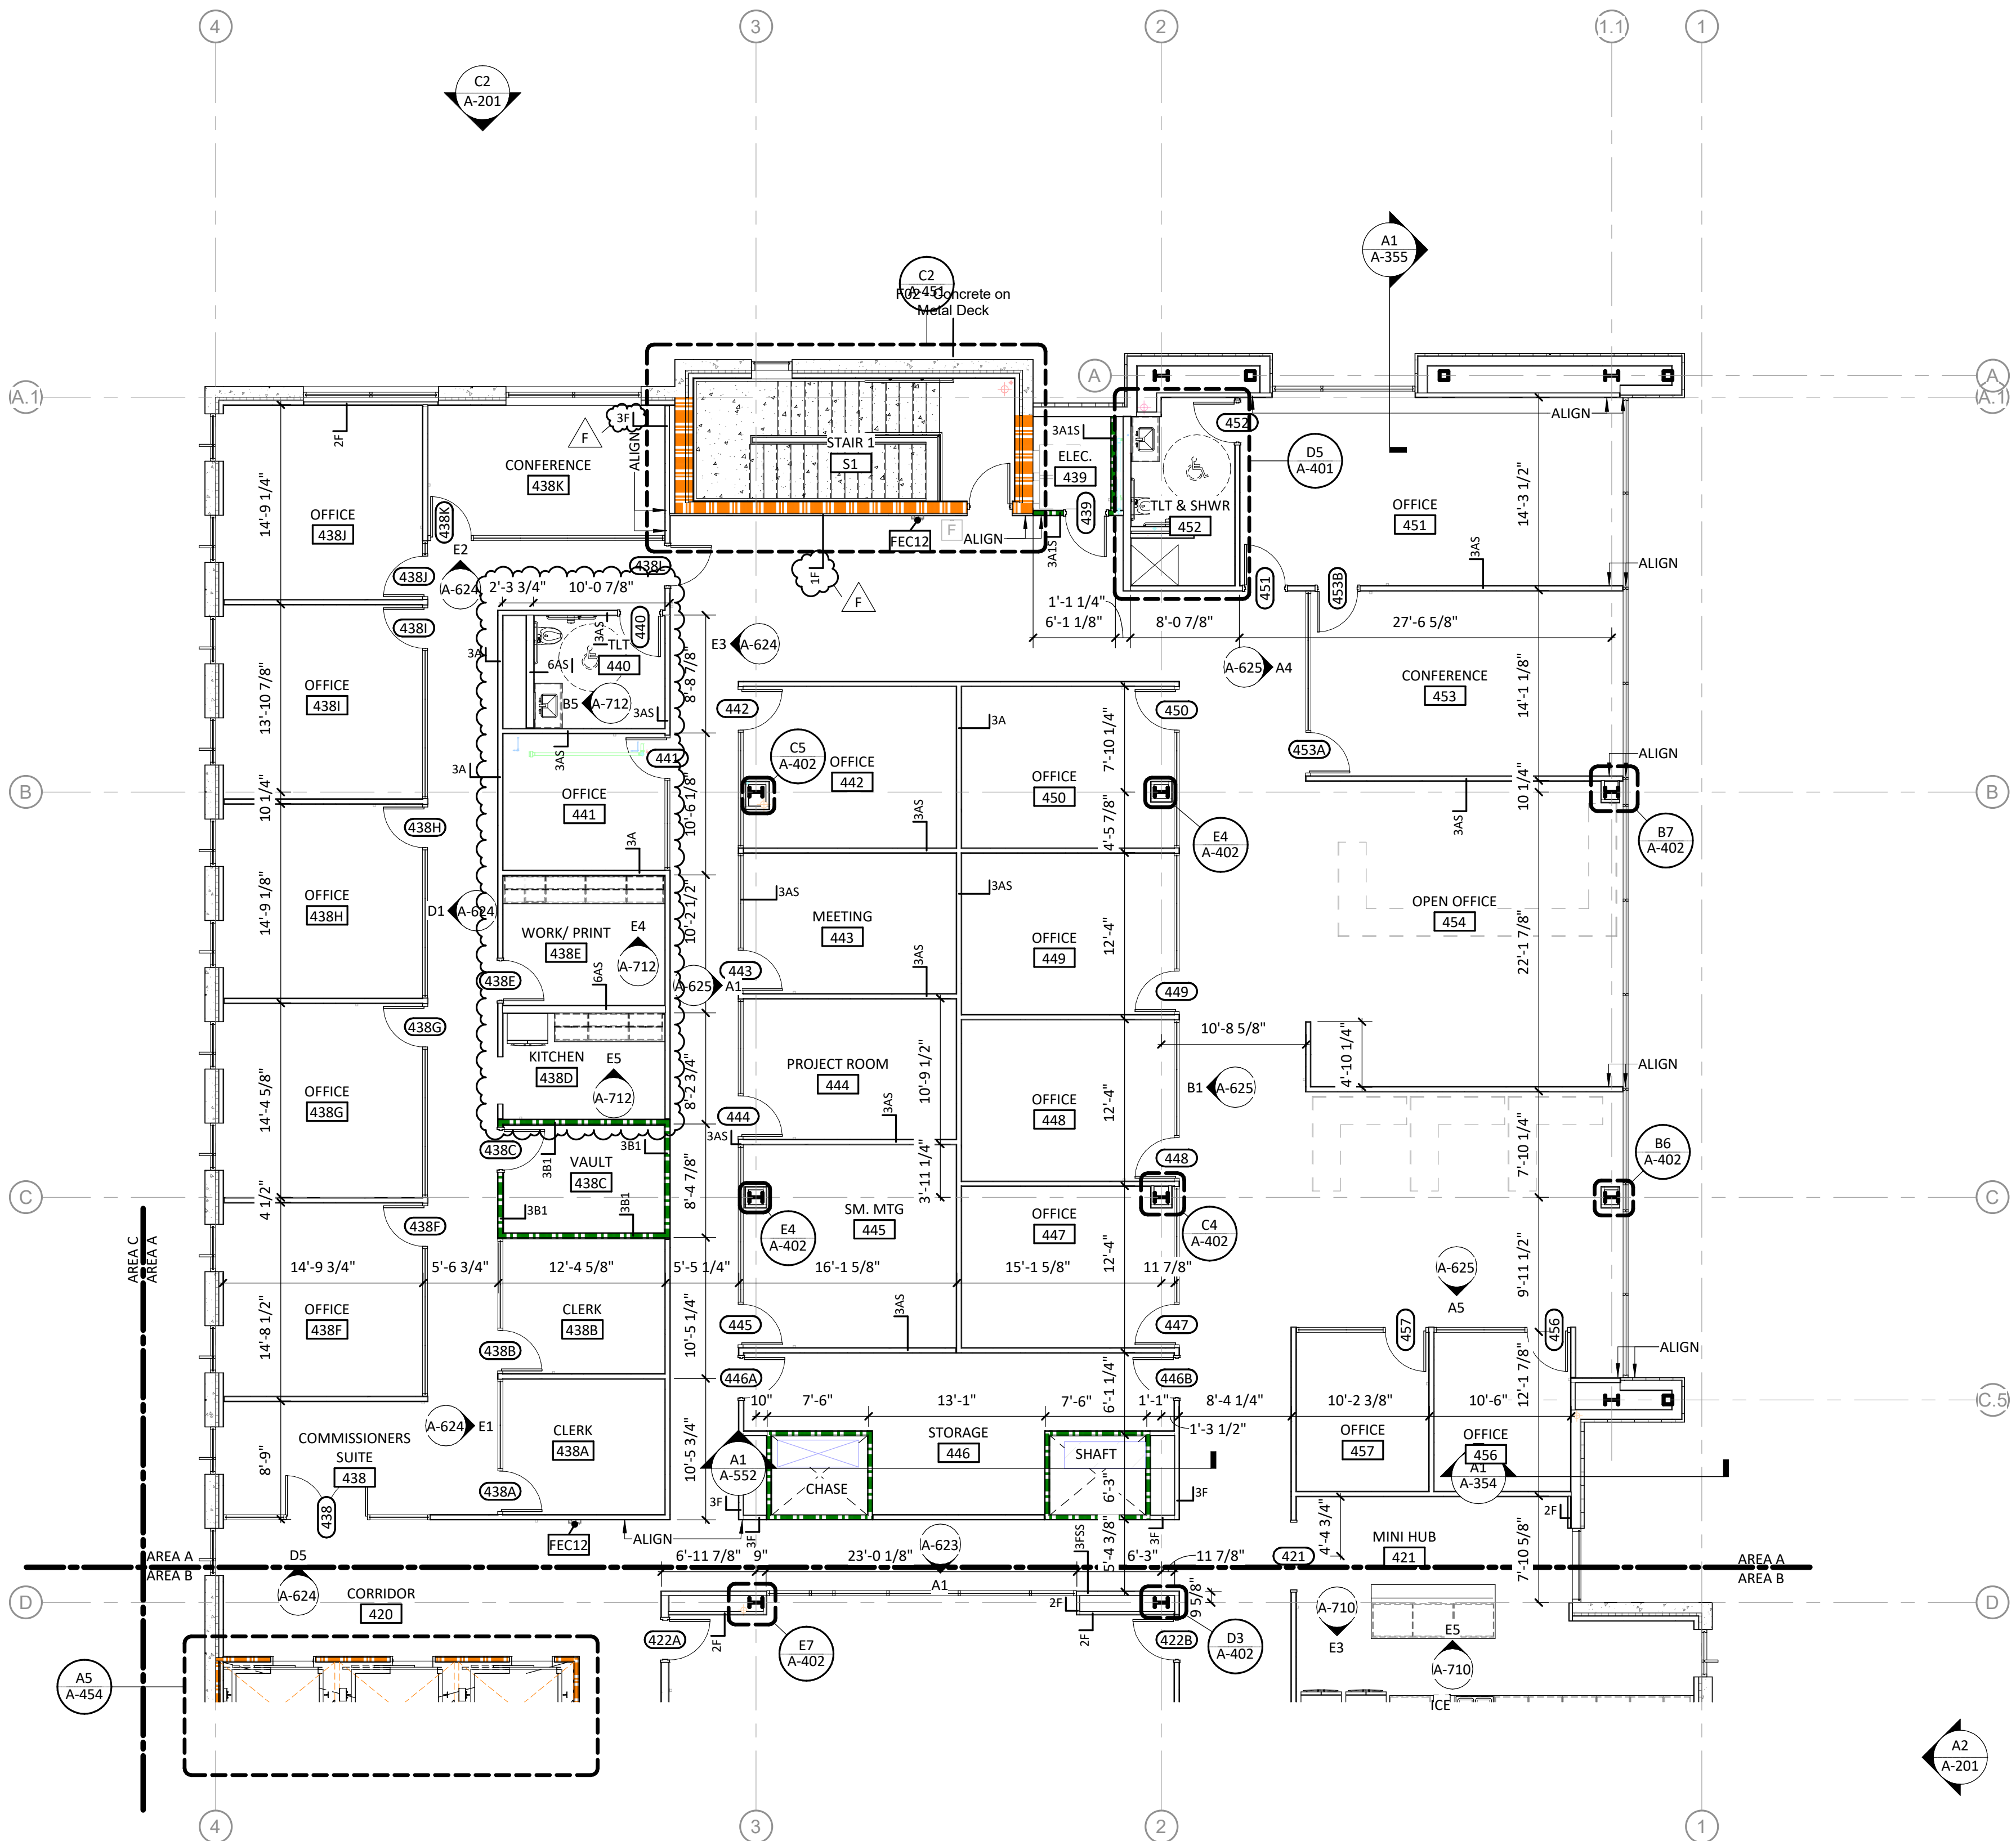GMP SET

THE LINE DRAWING(S) IS/ARE TO BE CONSIDERED AS A REFERENCE ONLY. THE CONTRACTOR SHALL BE RESPONSIBLE FOR THE ACCURACY OF THE INFORMATION PROVIDED.

E

D

C

B

A

1/8/2021 3:43:32 PM

A1
A-121

OVERALL RCP-LEVEL 1

1


2

3

4

5

6

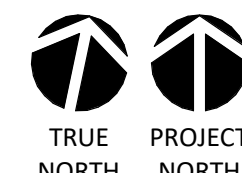

3/32" = 1'-0"

RCP LEGEND

1/8" = 1'-0"

RCP SHEET NOTES

- SEE SHEET A001 FOR PARTITION TYPES AND TERMINATION ABOVE CEILING
- SEE FINISH SCHEDULE FOR CEILING TYPES & MATERIALS IN EACH ROOM / AREA
- DIMENSIONS ARE TO FACE OF STUD, TYPICAL
- ALL CEILINGS TO BE 8'-6" AFF. U.N.O. CEILING HEIGHTS SHOWN ON THE REFLECTED CEILING PLANS ARE NON-TYPICAL AND SPECIFIC TO THE AREA INDICATED. REFER TO INTERIOR ELEVATIONS FOR THE HEIGHTS OF SOFFITS ABOVE CASEWORK.
- CEILING GRID/TILES TO BE CENTERED IN ALL ROOMS UNLESS NOTED OTHERWISE. PARTIAL TILES AT ROOM PERIMETERS SHALL NOT BE LESS THAN 6" IN EITHER DIMENSION.
- SEE ELECTRICAL, FIRE ALARM AND FIRE PROTECTION DRAWINGS FOR SPECIAL SYSTEMS, SMOKE DETECTORS, LIGHTING AND WALL MOUNTED FIXTURES NOT SHOWN ON THIS SHEET. COORDINATE LOCATIONS OF ALL FIXTURES NOT INDICATED WITH LAYOUT INDICATED ON THIS SHEET.
- LIGHT FIXTURES AND MECHANICAL DIFFUSERS ARE SHOWN FOR POSITIONING IN FINISH CEILING SYSTEM. COORDINATE WITH MECHANICAL AND ELECTRICAL DRAWINGS FOR FIXTURE TYPES, MECHANICAL DIFFUSERS, WALL MOUNTED FIXTURES AND INSTALLATION OF FIXTURES IN SPACES WITHOUT CEILINGS. (LIGHTING AND HVAC DIFFUSERS ARE SHOWN FOR COORDINATION ONLY - SEE MECHANICAL AND ELECTRICAL DRAWINGS FOR SPECIFIC INFORMATION)
- SEE MECHANICAL FLOOR PLANS FOR EXTENT OF EXPOSED DUCTWORK IN EXPOSED STRUCTURE AREAS WITHOUT CEILINGS.
- EXTEND PERIMETER WALLS AND FINISH TO STRUCTURE ABOVE AT EXPOSED STRUCTURE AREAS. PAINT ALL EXPOSED DUCTWORK, PIPING, HANGERS, ETC...
- SEE MECHANICAL AND ELECTRICAL DRAWINGS FOR MOUNTING LOCATIONS OF ITEMS WHERE NO CEILING IS INDICATED.
- CENTER LIGHTS, DIFFUSERS, EXIT SIGNS SMOKE DETECTORS, SPEAKERS, GENERAL ALARM SPEAKERS/STROBES & MISC DEVICES IN CEILING TILES WHERE THEY ARE LOCATED. ALIGN MULTIPLE ITEM CENTER OR EDGES.
- LOCATE MECHANICAL GRILLES AND DIFFUSERS SHOWN IN CORNERS OR NEAR WALL TO 12" OFF WALLS, UNO.
- INSTALL ACCESS PANELS IN GYPSUM BOARD CEILINGS AT DUCT DAMPER CONTROLS, DUCT MOUNTED SMOKE DETECTORS, MANUAL DUCT CONTROLS, ETC.
- ALL SINGLE LIGHT FIXTURES SHALL BE CENTERED IN THE CEILING WITHIN WHICH THEY OCCUR.
- LIGHTS LOCATED IN STAIRS SHALL OCCUR AT EACH FLOOR AND INTERMEDIATE LANDINGS.
- LOCATE SPRINKLER HEADS IN THE CENTER ZONE OF THE CEILING TILE. ALIGN CORRIDOR SPRINKLER HEADS IN THE SAME LINE PARALLEL TO THE WALL WITHIN EACH SPECIFIC CEILING CONSTRUCTION.
- SPRINKLER HEADS, OTHER THAN CONCEALED, SHALL BE SEMI RECESSED (CENTER IN CEILING TILE).
- ALL GWB CEILINGS TO RECEIVE CONCEALED SPRINKLER HEADS.
- WHERE ACT CEILINGS OVERLAP, LOWER CEILING SHALL OVERLAP BY ATLEAST 8 INCHES. LOWER ACT CEILING TO RECEIVE 6" KNIFE EDGE AROUND THE PERIMETER U.N.O.
- SOUND ATTENUATE BATT ABOVE CEILING IN ALL OFFICES, CONFERENCE ROOMS, TRAINING ROOMS & EOC, ENTIRE CEILING.



CAPE FEAR FD STONEWATER

LS3P

101 NORTH THIRD STREET, SUITE 500
WILMINGTON, NORTH CAROLINA 28401
TEL. 910.790.9901 FAX. 910.790.3111
WWW.LS3P.COM



NOT FOR
CONSTRUCTION

NHC Government Center 7702-190810


NEW HANOVER COUNTY
GOVERNMENT CENTER
GOVERNMENT CENTER DRIVE
WILMINGTON, NC 28403

LS3P PROJECT: 7702-190810

LEGEND- REFLECTED CEILING PLAN

- | | |
|--|--|
| ACT-1 24"x24" LAY-IN ACOUSTIC CEILING TILE | 2 X 2 LED RECESSED TROFFER |
| ACT-2 24"x48" LAY-IN ACOUSTIC CEILING TILE | 2 X 4 LED RECESSED TROFFER |
| ACT-3 48"x96" LAY-IN ACOUSTIC CEILING W/ INTEGRATED LIGHTING AND HVAC | 4" SQUARE RECESSED LED LIGHTS |
| ACT-4 48"x96" LAY-IN ACOUSTIC CEILING W/ INTEGRATED LIGHTING AND HVAC | RECESSED LED STRIP LIGHT, LENGTH VARIES |
| ACT-5 48"x96" LAY-IN ACOUSTIC CEILING W/ INTEGRATED LIGHTING AND HVAC | DECORATIVE PENDANT |
| 3'-0"x3'-0" PIPE GRID SYSTEM STRUCTURE ABOVE EXPOSED & PNT BLACK | CONTINUOUS LINEAR SUSPENSION INDIRECT/ DIRECT LED, LENGTH VARIES |
| WPP-1 WOOD SOFFIT | 1"x4" LED SUSPENDED LINEAR UTILITY FIXTURE |
| GYPSUM BOARD | LED PENDANT, MULTI HEIGHT/ SHAPE/ DIAMETER, TBD |
| EXPOSED STRUCTURE - NO CEILING | WAC LIGHTING WALL SCONCE, EXACT FIXTURE TBD |
| EXPOSED STRUCTURE - DRYFALL PAINTED ABOVE | RETURN AIR DIFFUSER |
| | EXHAUST FAN |
| | SUPPLY AIR DIFFUSER |
| | LINEAR AIR DIFFUSER |
| | HEIGHT ABOVE FINISHED FLOOR 8'-6" U.N.O. |
| | LIGHT COVE |

KEY PLAN:

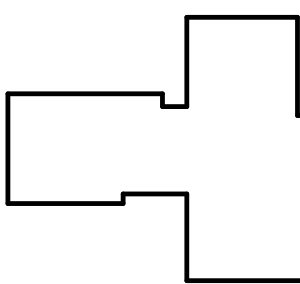

SHEET NAME:
REFLECTED CEILING
PLAN- LEVEL 1

ORIG SUBMISSION: 2020.12.16

CURRENT: 2020.12.16

GMP SET

SHEET:

A-121

GMP SET

THE USER SHALL MAINTAIN THE
PROJECT INFORMATION AND
NOT FOR CONSTRUCTION
THIS INFORMATION IS NOT
FOR CONSTRUCTION

E

D

C

B

A

1/8/2021 3:43:38 PM

A1
A-124A RCP- PARTIAL- LEVEL 4 - AREA A

1


2

3

4

5

6

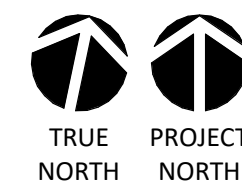

1/8" = 1'-0"

RCP LEGEND

1/8" = 1'-0"

RCP SHEET NOTES

- SEE SHEET A001 FOR PARTITION TYPES AND TERMINATION ABOVE CEILING
- SEE FINISH SCHEDULE FOR CEILING TYPES & MATERIALS IN EACH ROOM / AREA
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- LOCATE MECHANICAL GRILLES AND DIFFUSERS SHOWN IN CORNERS OR NEAR WALL TO 12" OFF WALLS, UNO.
- INSTALL ACCESS PANELS IN GYPSUM BOARD CEILINGS AT DUCT DAMPER CONTROLS, DUCT MOUNTED SMOKE DETECTORS, MANUAL DUCT CONTROLS, ETC.
- ALL SINGLE LIGHT FIXTURES SHALL BE CENTERED IN THE CEILING WITHIN WHICH THEY OCCUR.
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- WHERE ACT CEILINGS OVERLAP, LOWER CEILING SHALL OVERLAP BY ATLEAST 8 INCHES. LOWER ACT CEILING TO RECEIVE 6" KNIFE EDGE AROUND THE PERIMETER U.N.O.
- SOUND ATTENUATE BATT ABOVE CEILING IN ALL OFFICES, CONFERENCE ROOMS, TRAINING ROOMS & EOC, ENTIRE CEILING.



LEGEND- REFLECTED CEILING PLAN

| | | | |
|--|--|--|--|
| | ACT-1 2'x2' LAY-IN ACOUSTIC CEILING TILE | | 2'x2' LED RECESSED TROFFER |
| | ACT-2 2'x4' LAY-IN ACOUSTIC CEILING TILE | | 2'x4' LED RECESSED TROFFER |
| | ACT-3 48'x96' LAY-IN ACOUSTIC CEILING W/ INTEGRATED LIGHTING AND HVAC | | 4' SQUARE RECESSED LED LIGHTS |
| | ACT-4 48'x96' LAY-IN ACOUSTIC CEILING W/ INTEGRATED LIGHTING AND HVAC | | RECESSED LED STRIP LIGHT, LENGTH VARIES |
| | ACT-5 48'x96' LAY-IN ACOUSTIC CEILING W/ INTEGRATED LIGHTING AND HVAC | | DECORATIVE PENDANT |
| | 3'-0"X3'-0" PIPE GRID SYSTEM STRUCTURE ABOVE EXPOSED & PNT BLACK | | CONTINUOUS LINEAR SUSPENSION INDIRECT/ DIRECT LED, LENGTH VARIES |
| | WPP-1 WOOD SOFFIT | | 1'x4' LED SUSPENDED LINEAR UTILITY FIXTURE |
| | GYPSUM BOARD | | LED PENDANT, MULTI HEIGHT/ SHAPE/ DIAMETER; TBD |
| | EXPOSED STRUCTURE - NO CEILING | | WAC LIGHTING WALL SCONCE, EXACT FIXTURE TBD |
| | EXPOSED STRUCTURE - DRYFALL PAINTED ABOVE | | RETURN AIR DIFFUSER |
| | | | EXHAUST FAN |
| | | | SUPPLY AIR DIFFUSER |
| | | | LINEAR AIR DIFFUSER |
| | | | HEIGHT ABOVE FINISHED FLOOR 8'-0" U.N.O. |
| | | | LIGHT COVE |



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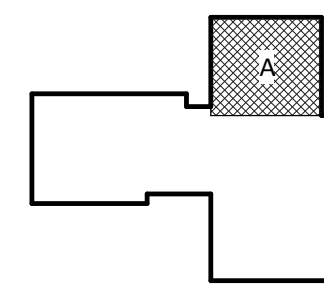
NOT FOR
CONSTRUCTION

NHC Government Center 7702-190810

**NEW HANOVER COUNTY
GOVERNMENT CENTER**
GOVERNMENT CENTER DRIVE
WILMINGTON, NC 28403
LS3P PROJECT: 7702-190810

| A | DATE | DESCRIPTION |
|---|------------|------------------------|
| A | 2020.08.18 | T1- SCHEMATIC DESIGN |
| B | 2020.10.16 | T1- DESIGN DEVELOPMENT |
| C | 2020.11.20 | T1 GMP SET |
| D | 2020.12.16 | GMP SET |
| E | 2020.12.22 | ADDENDUM #1 |
| F | 2021.01.08 | ADDENDUM #2 |

KEY PLAN:



SHEET NAME:
REFLECTED CEILING
PLAN- LEVEL 4 AREA
A

ORIG SUBMISSION: 2020.12.16
CURRENT: 2021.01.08
ADDENDUM #2

SHEET:

A-124A

GMP SET

THE LINE SHOWN ABOVE IS
BASED ON THE FOLLOWING SIZE
THIS DRAWING IS FOR INFORMATION ONLY

E


D

C


B

A


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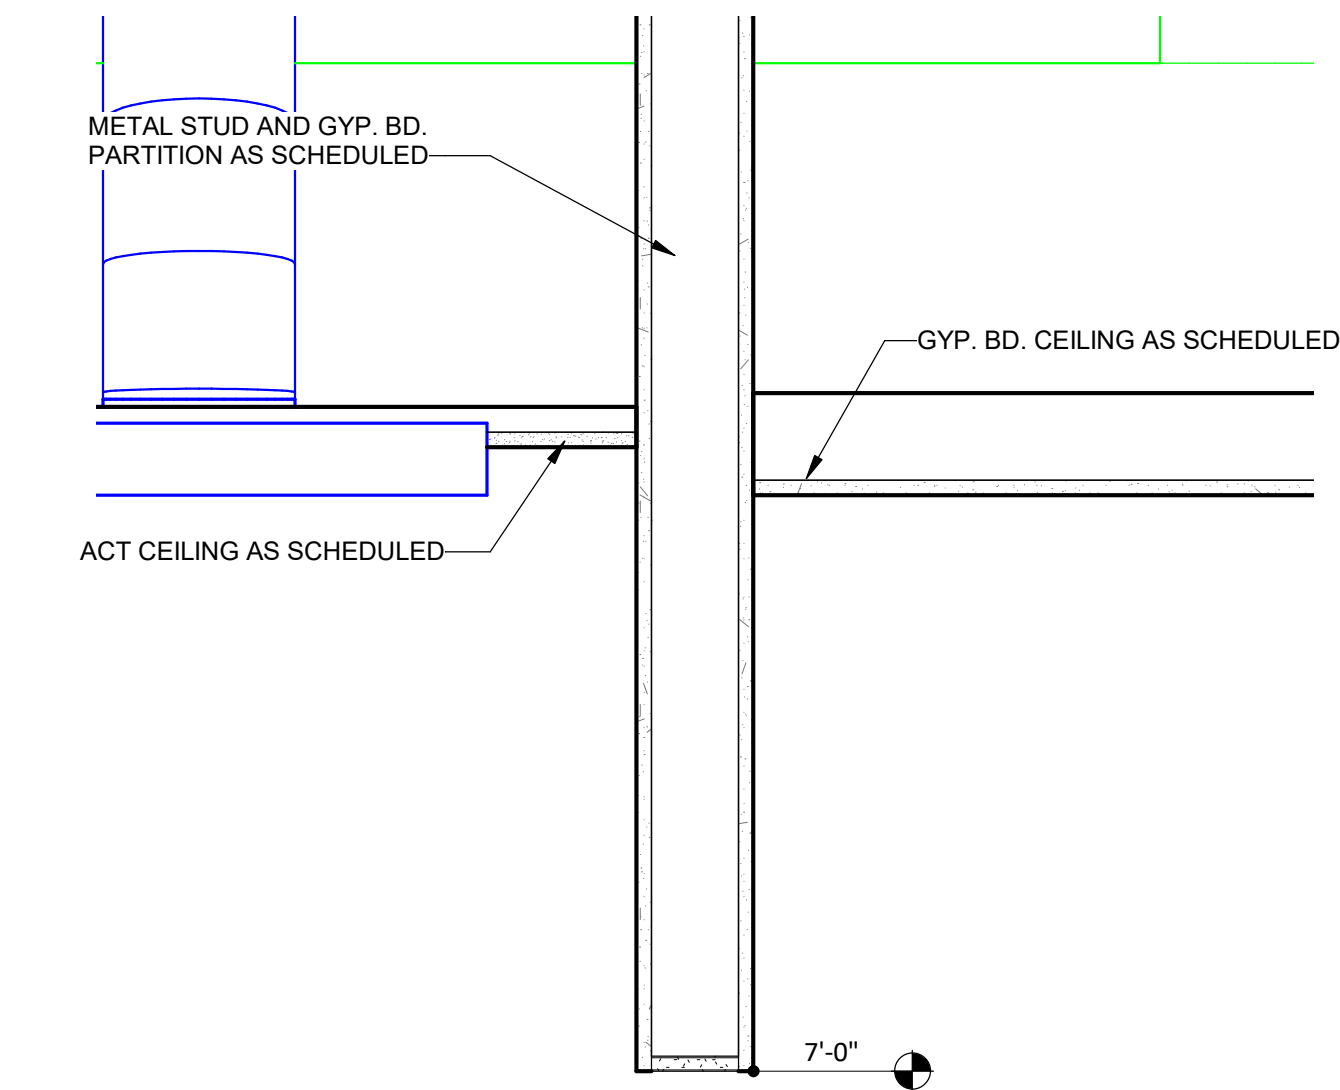
D1 SECTION - WOOD SLAT SOFFIT
1 1/2\"/>

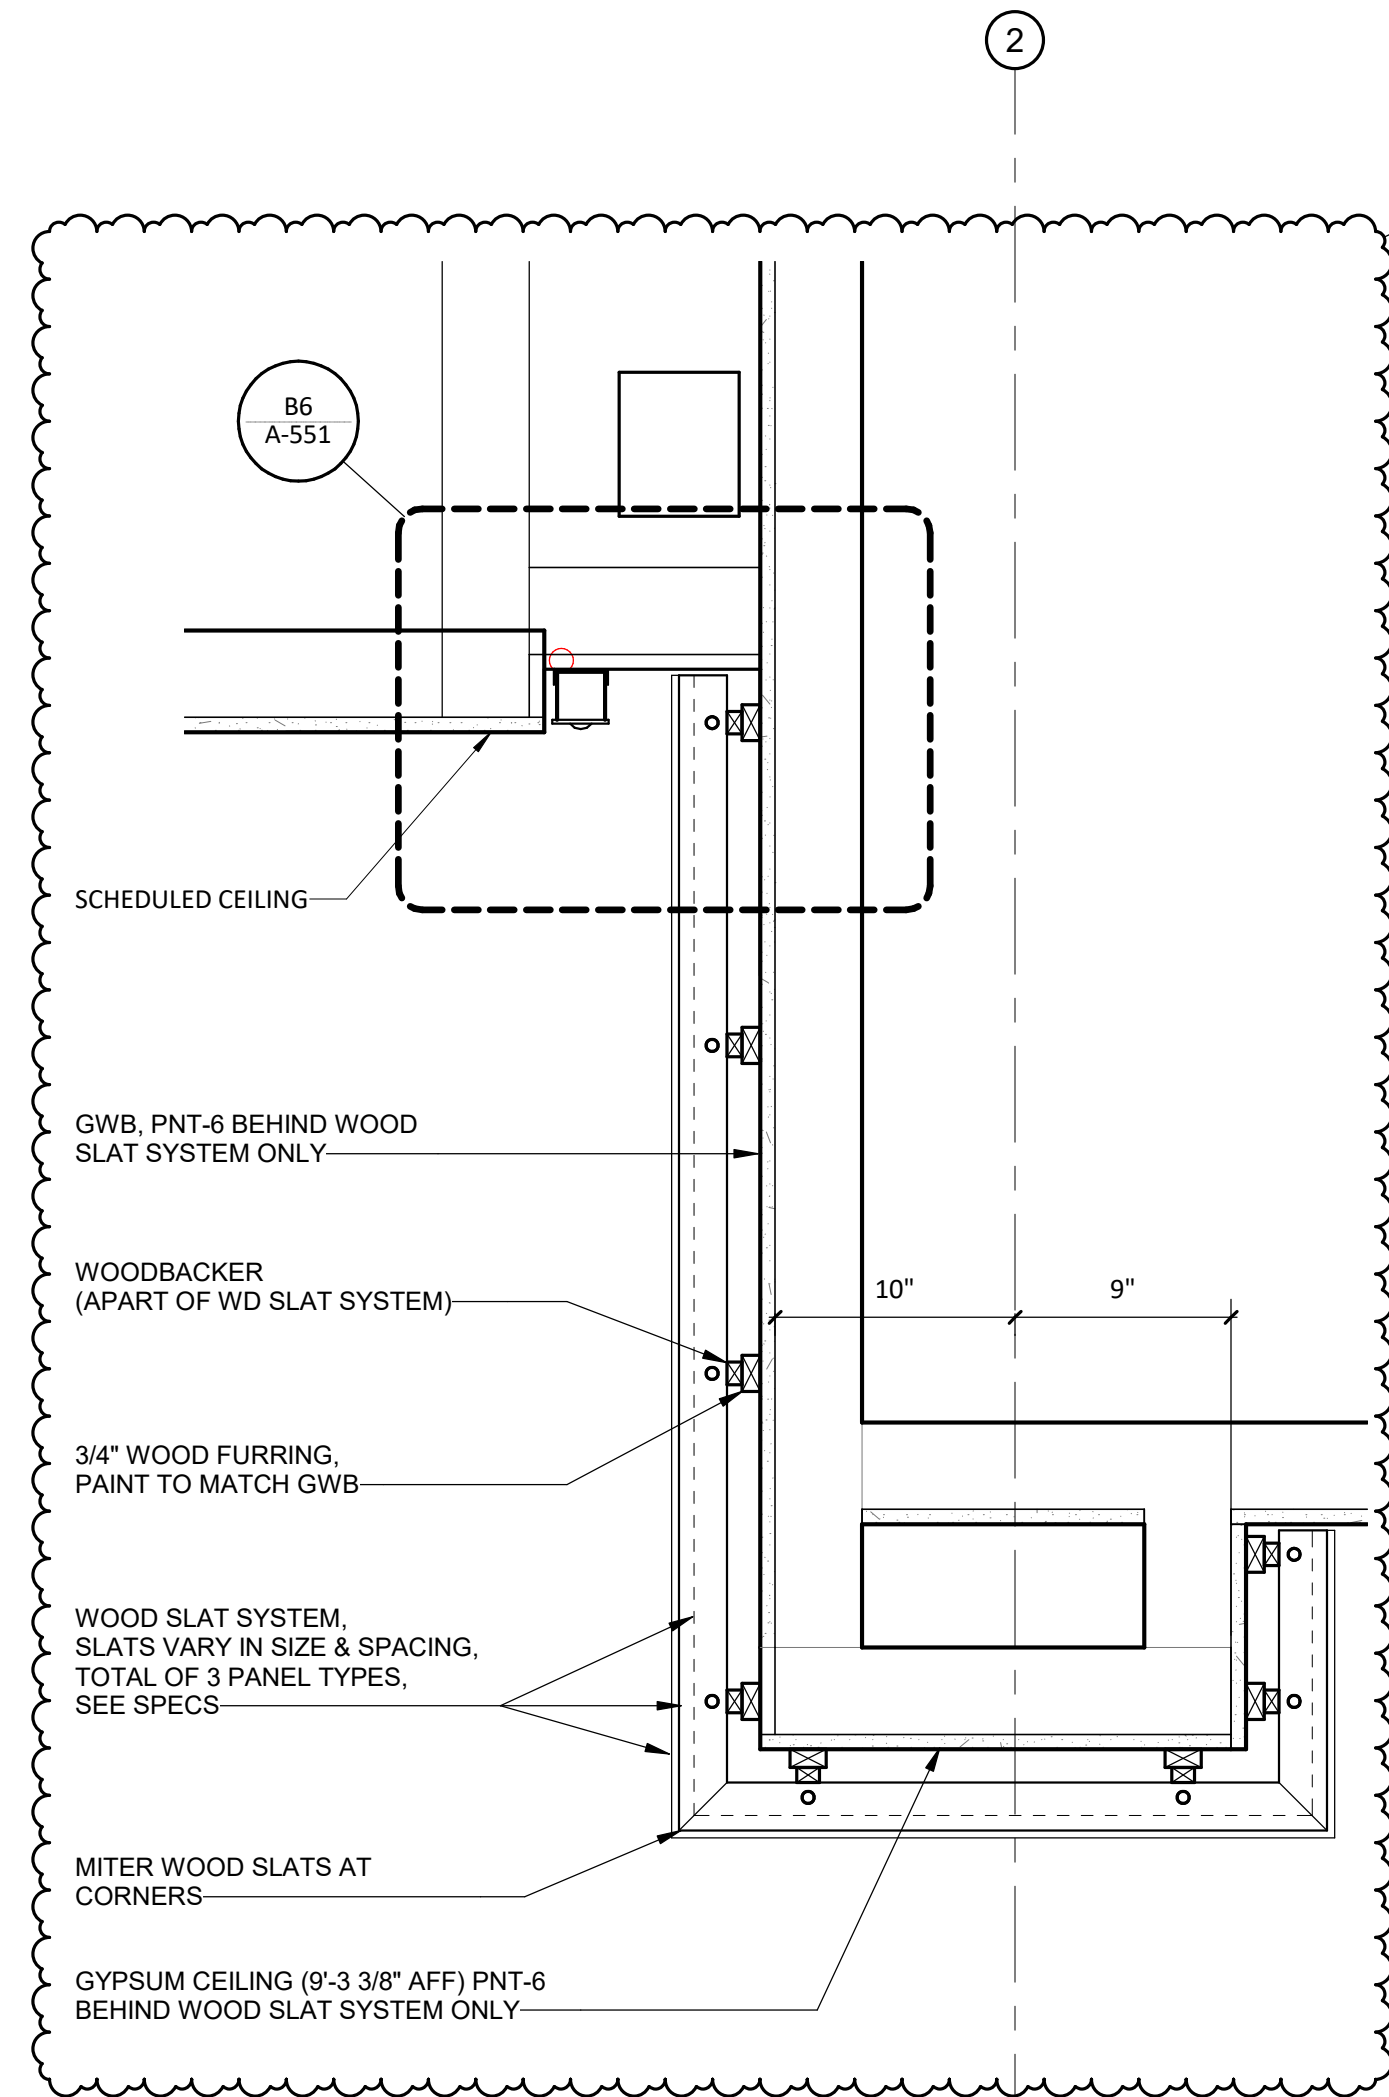


D2 SECTION - TYPICAL WINDOW POCKET
1 1/2\"/>

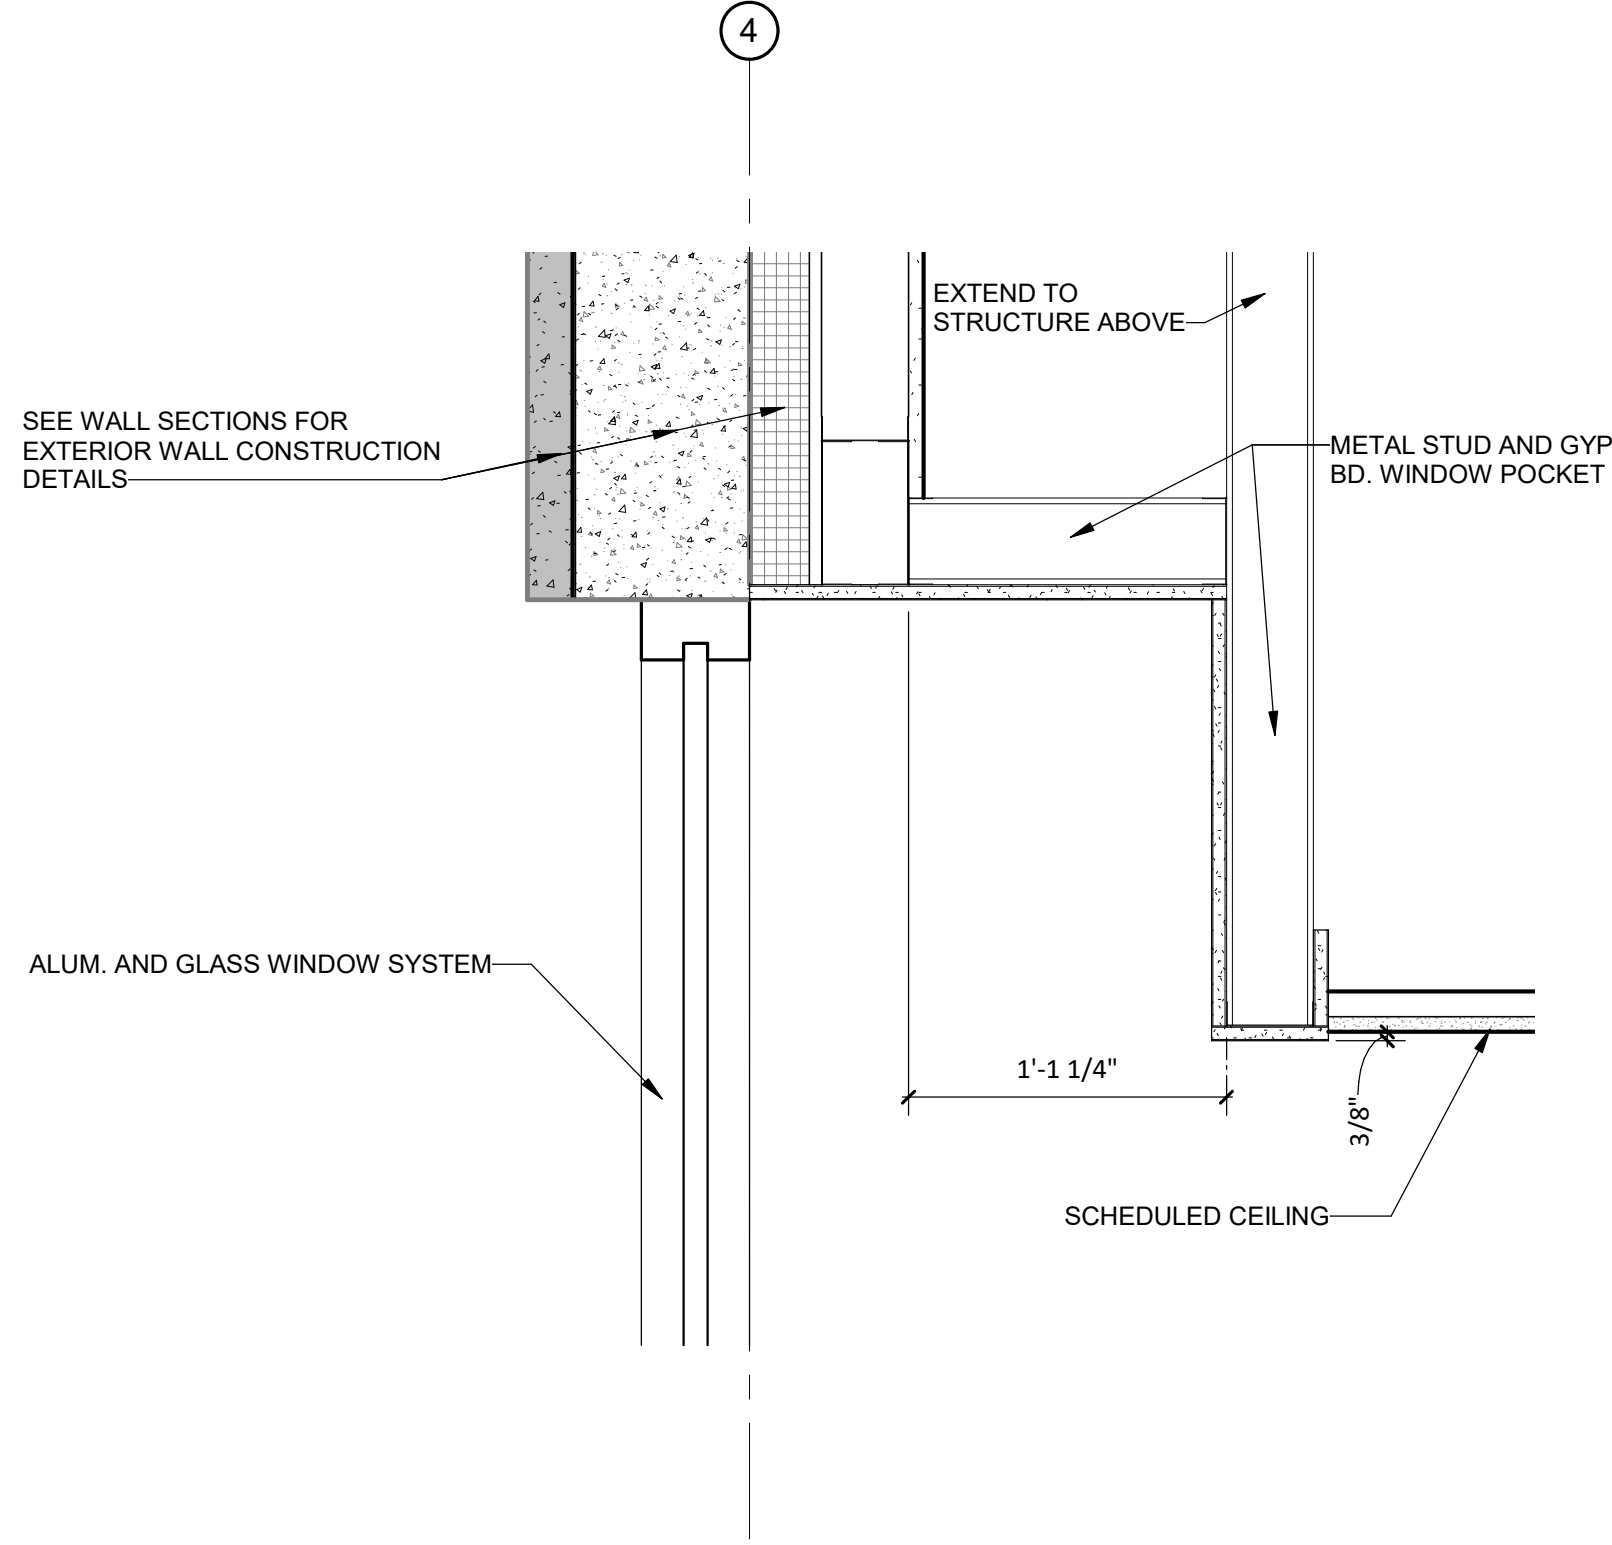


D3 SECTION - ACCORDION FIRE DOORS
1 1/2\"/>

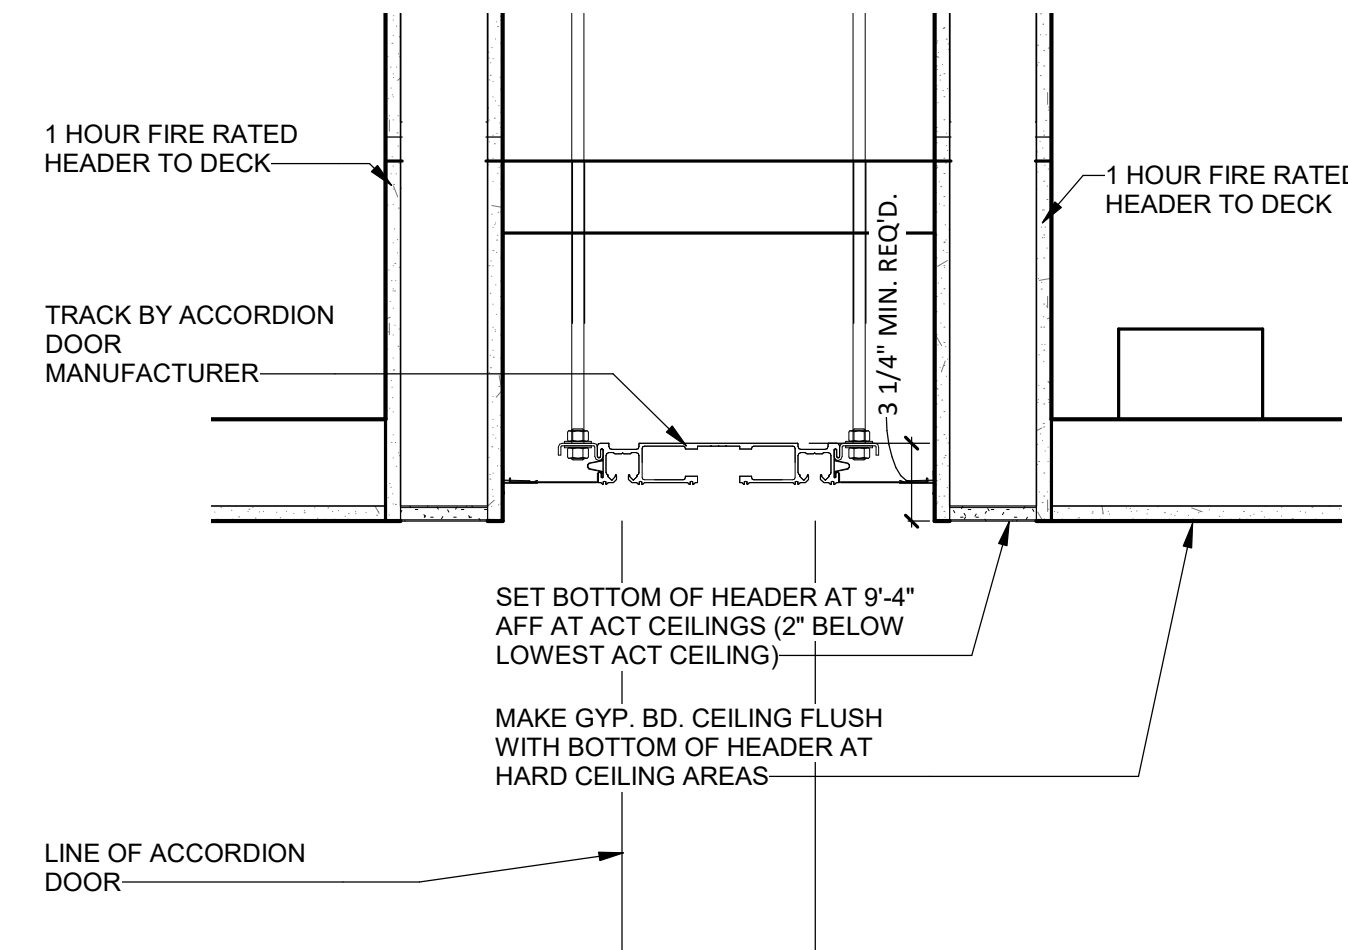


B1 SECTION - TLTRooms 149, 150, 236, 237, 336, 337, 436, 437
1 1/2\"/>

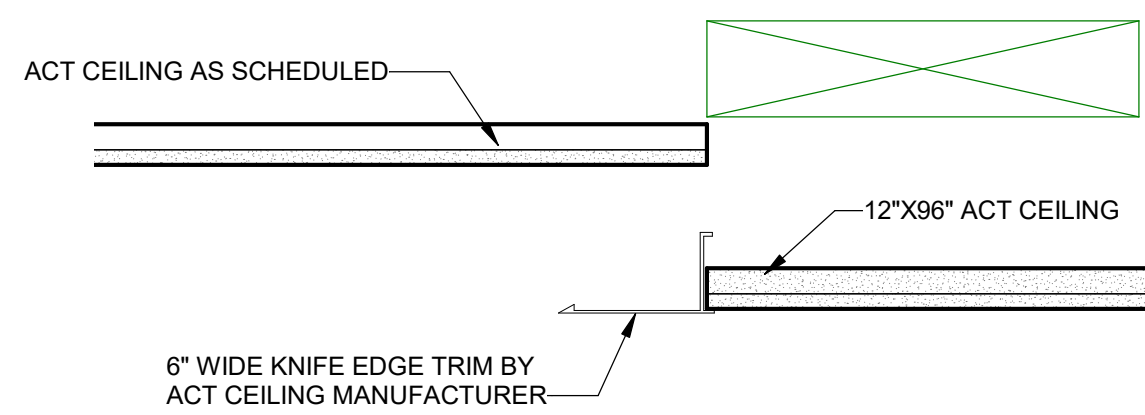


B2 SECTION - COLLABORATION CORE
1 1/2\"/>

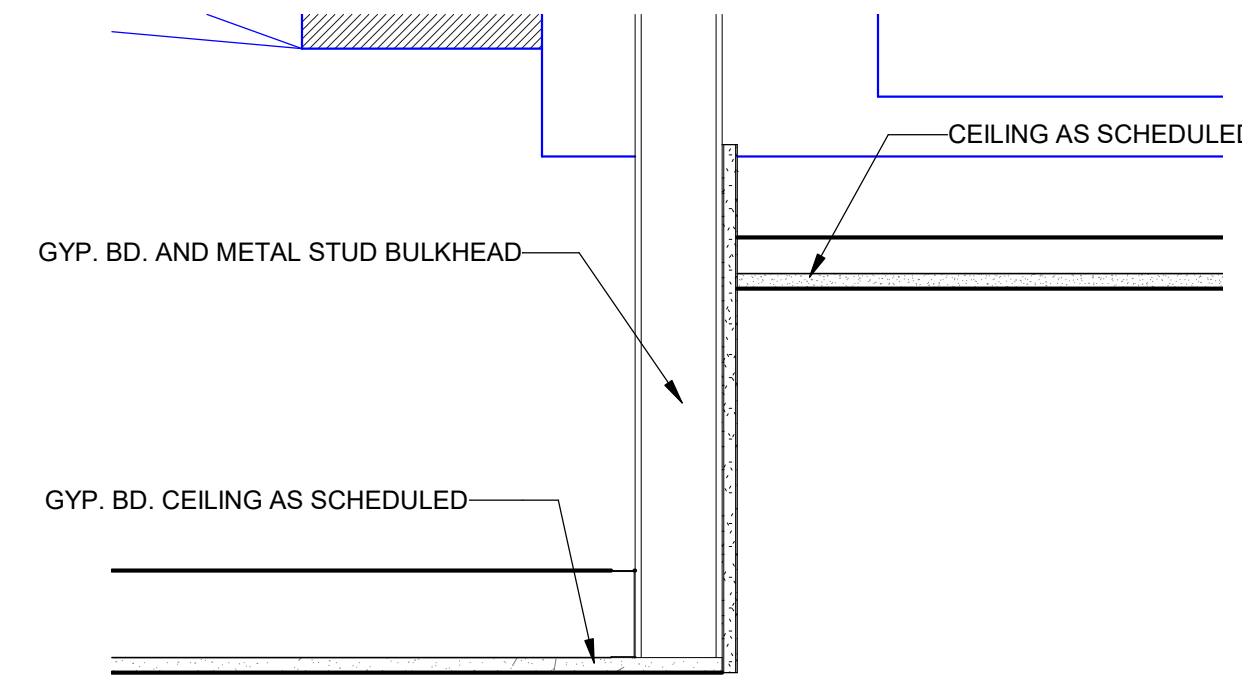


B3 SECTION - CEILING TO CEILING
1 1/2\"/>

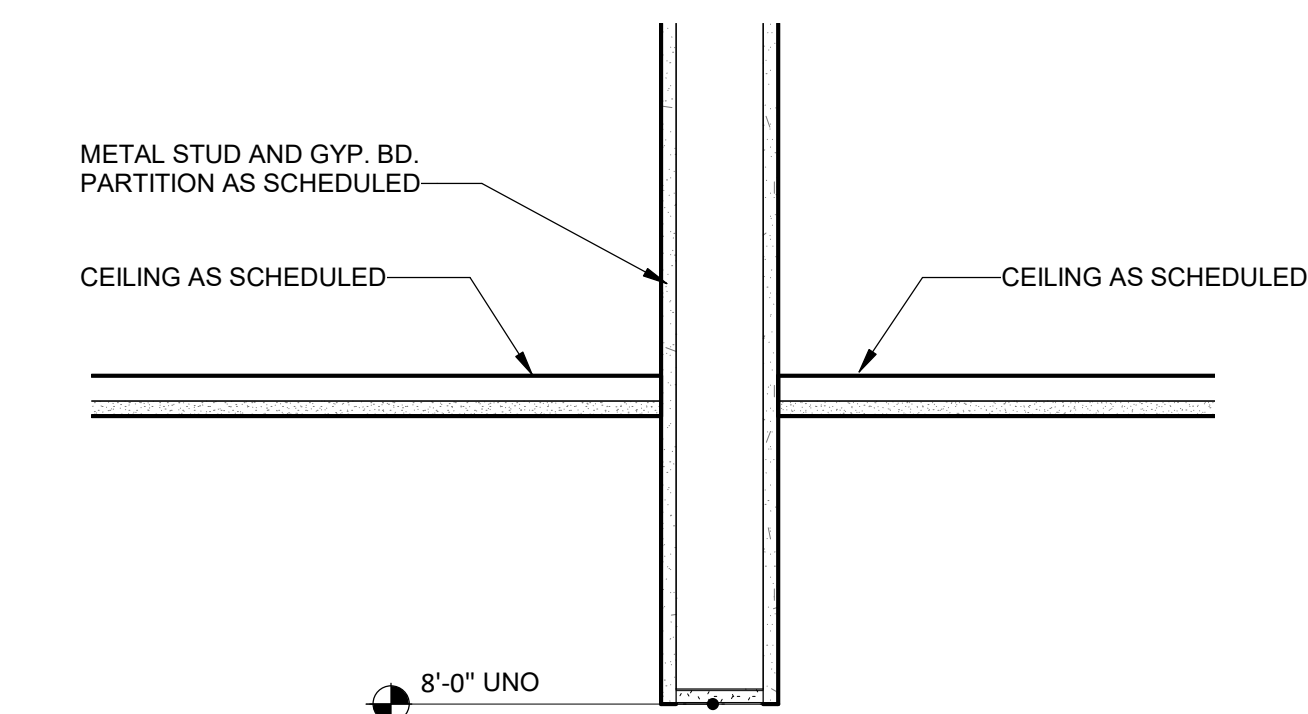


A1 SECTION - CEILING TO CEILING AT OPNG
1 1/2\"/>

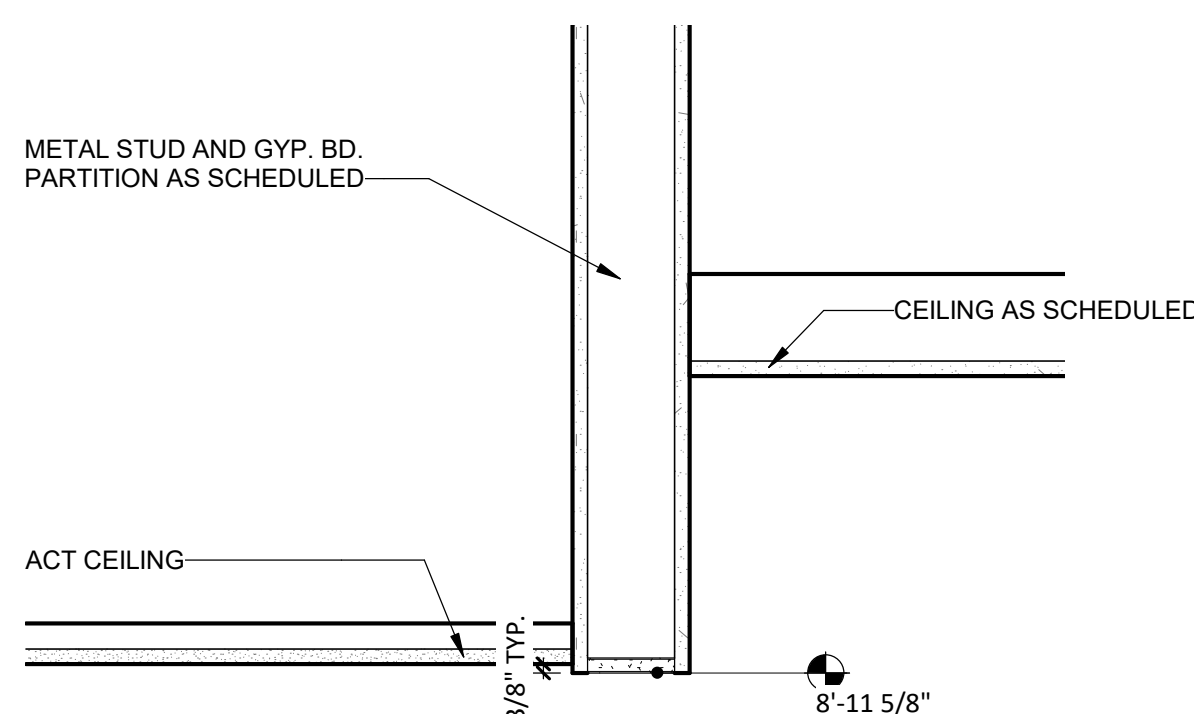


A2 SECTION - REGISTER OF DEEDS
1 1/2\"/>

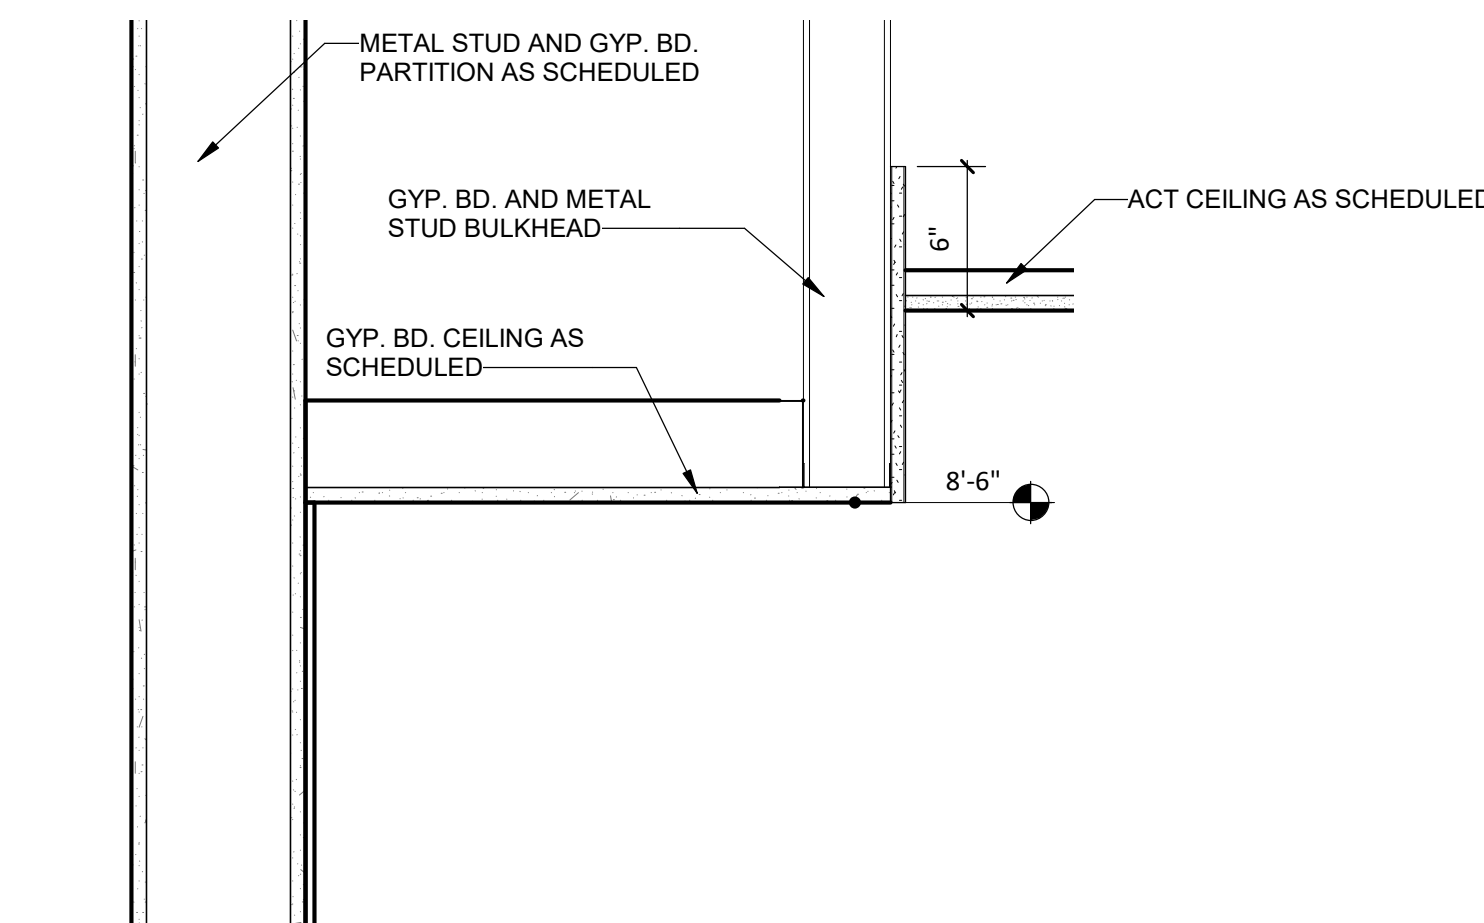


A3 TYPICAL SECTION AT TOILET ROOM LAVS
1 1/2\"/>

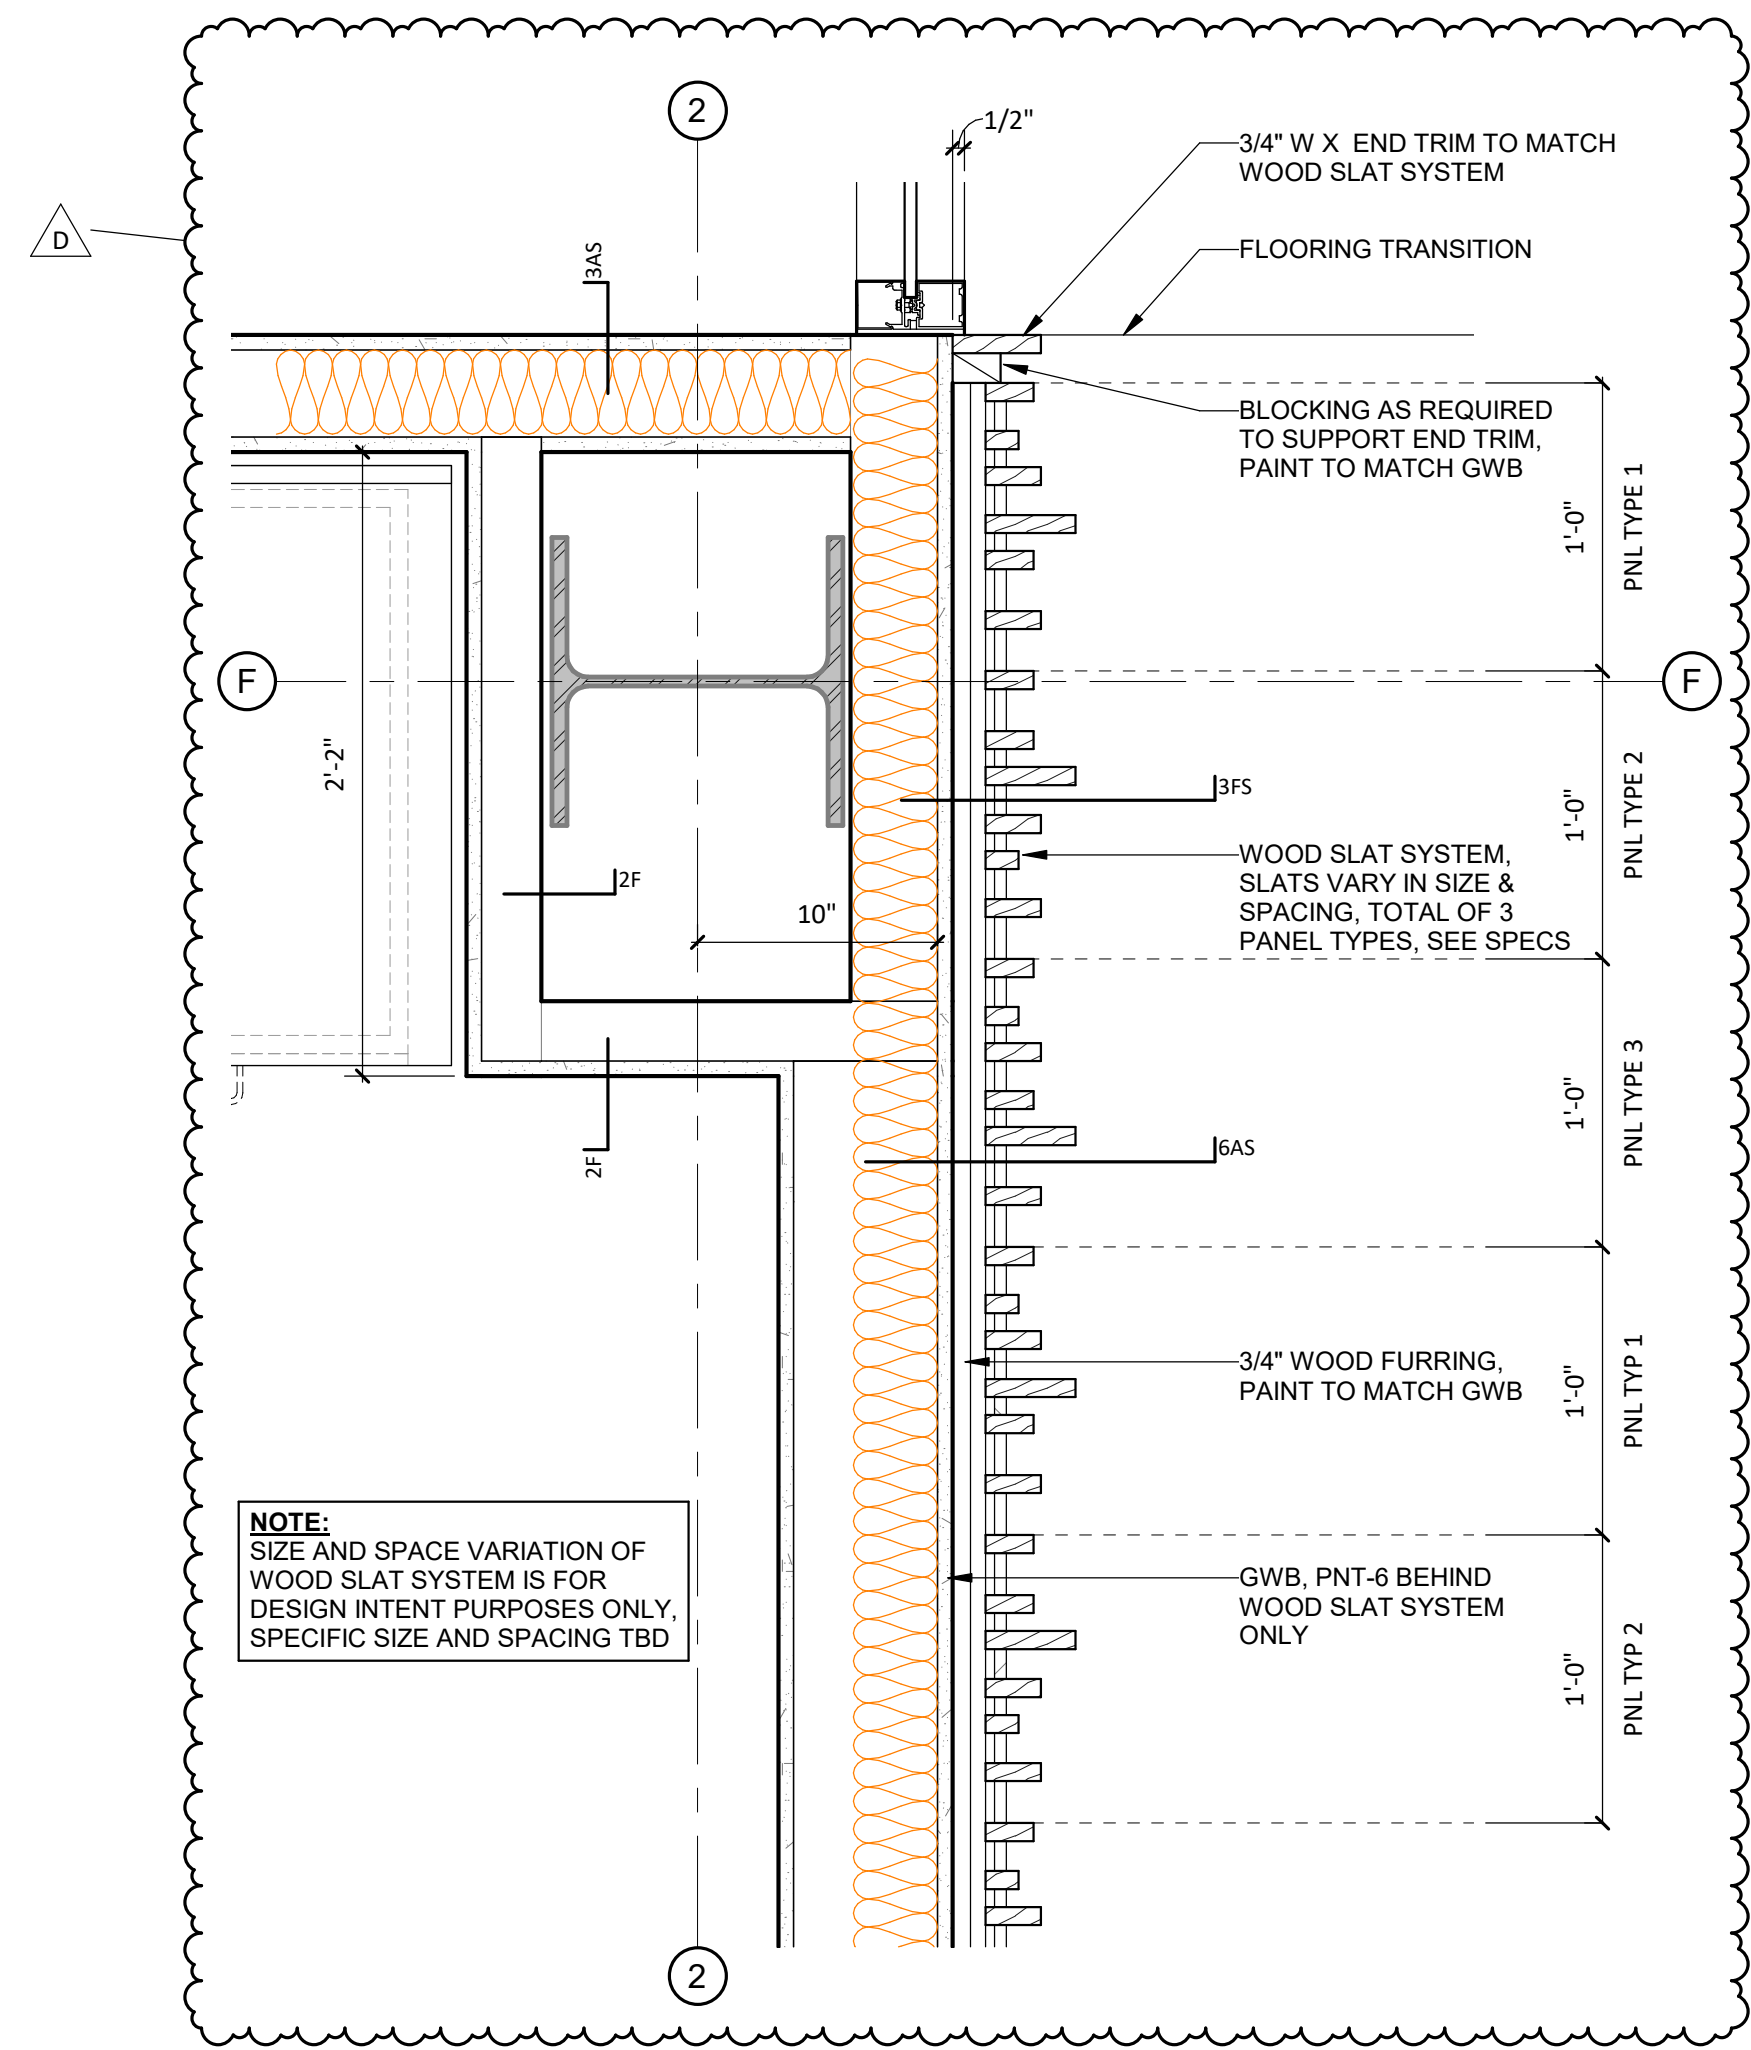

D6 PLAN DETAIL - WOOD SLAT WALL
1 1/2\"/>

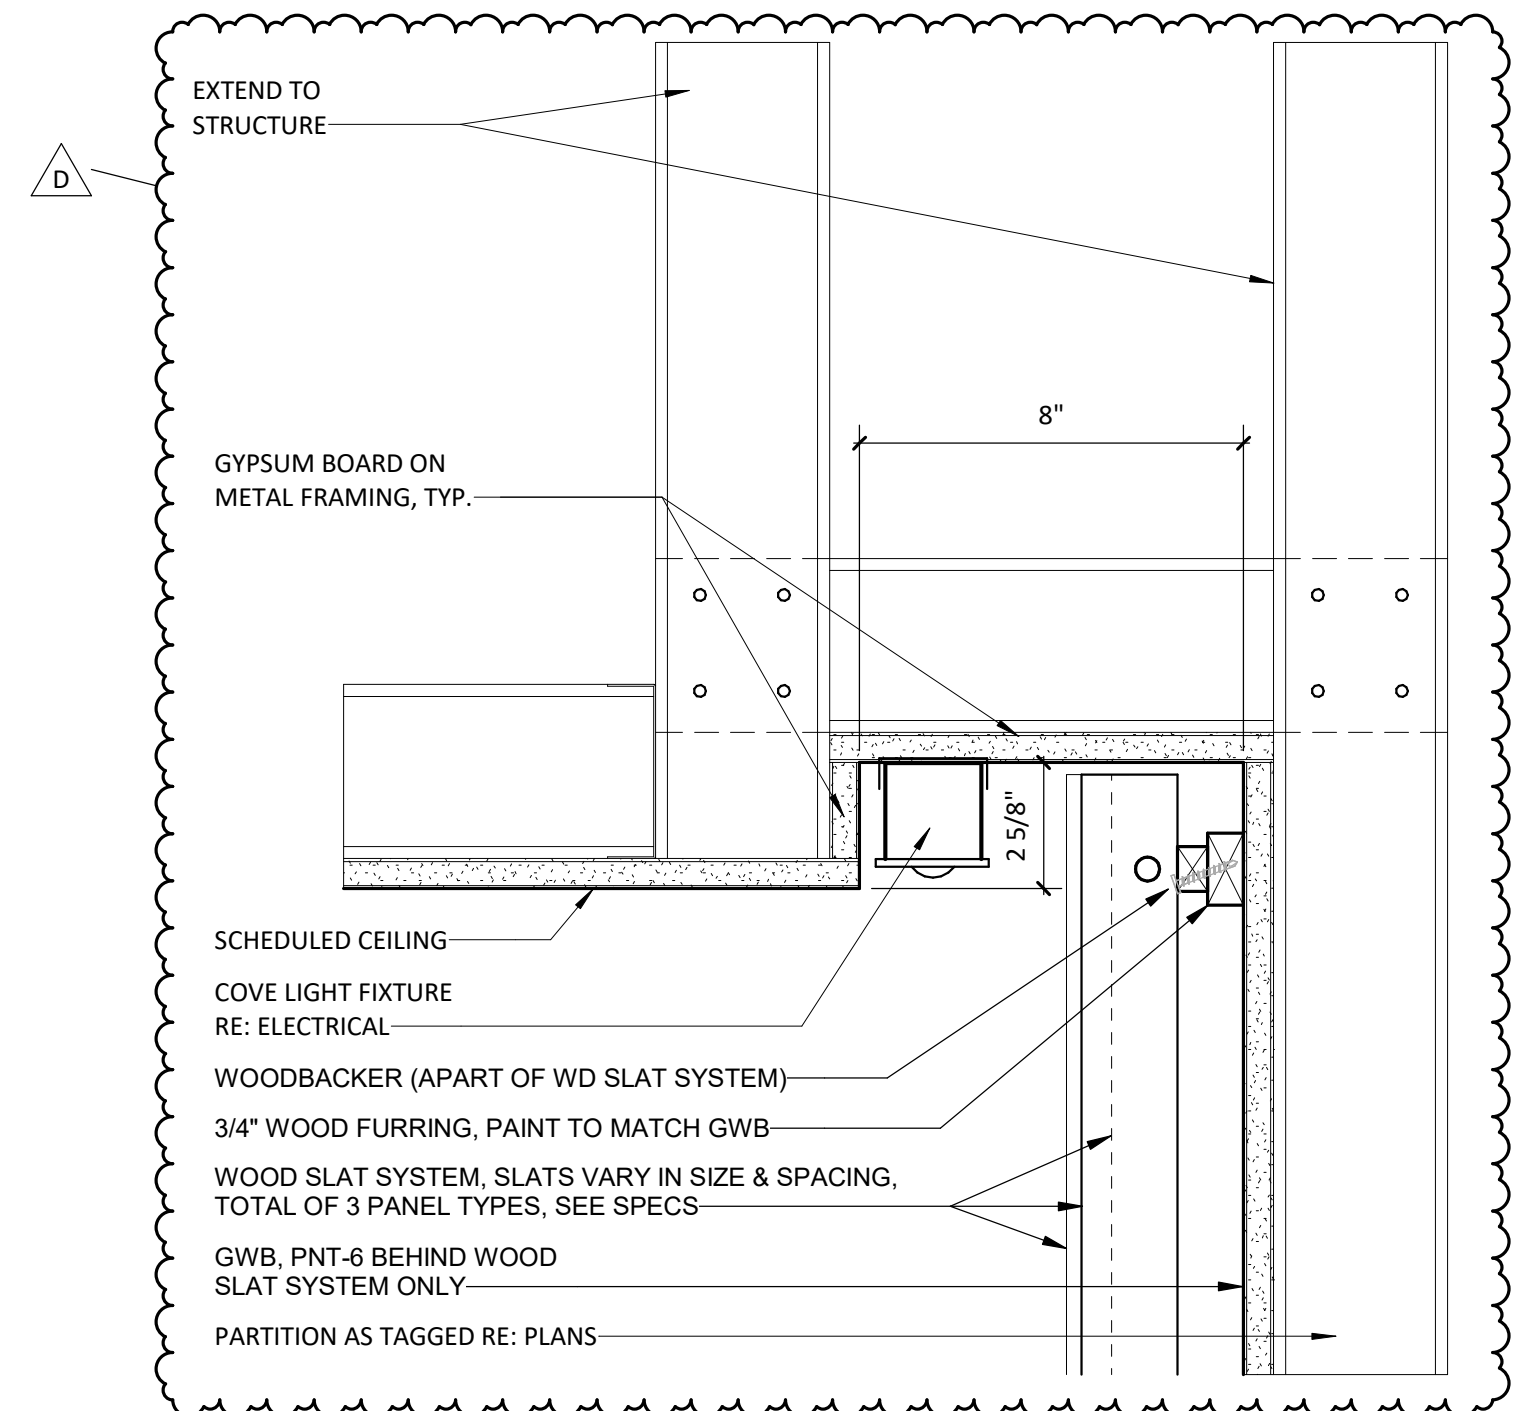

B6 LIGHT COVE - @ LOBBY W/ WOOD SLAT WALL
3\"/>

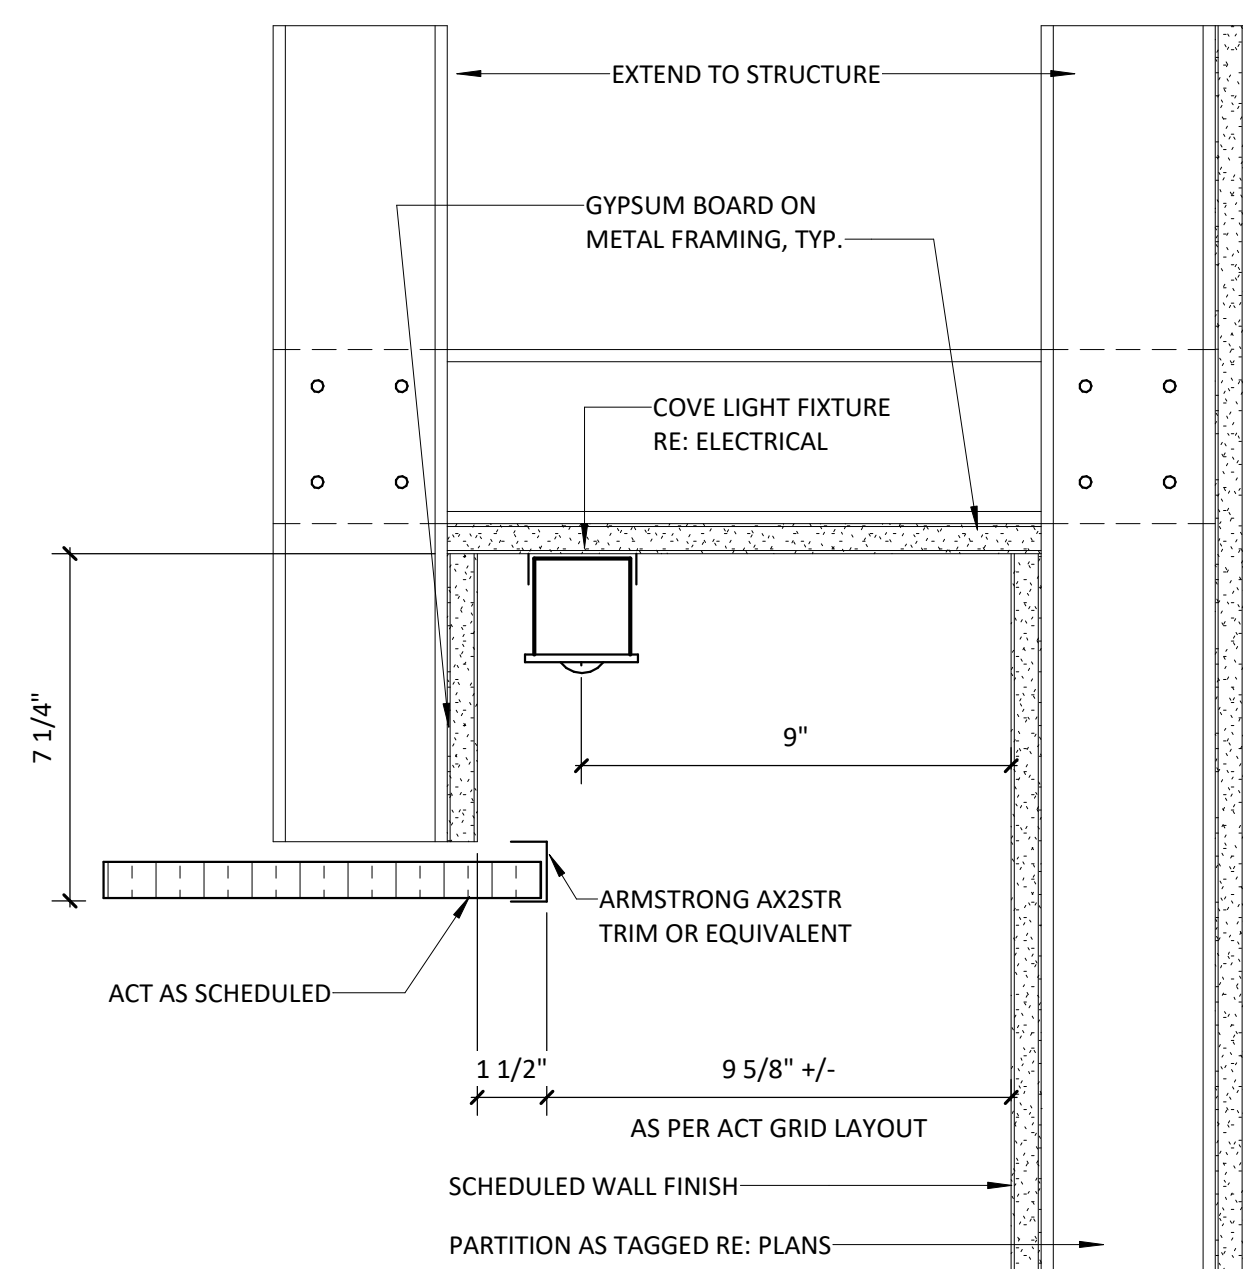

A6 LIGHT COVE - TYPICAL
3\"/>



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CONSTRUCTION

NHC Government Center 7702-190810

NEW HANOVER COUNTY
GOVERNMENT CENTER
GOVERNMENT CENTER DRIVE
WILMINGTON, NC 28403

LS3P PROJECT: 7702-190810

| A | DATE | DESCRIPTION |
|---|------------|-------------|
| A | 2020.11.20 | T1 GMP SET |
| B | 2020.12.16 | GMP SET |
| C | 2020.12.22 | ADDENDUM #1 |
| D | 2021.01.08 | ADDENDUM #2 |

SHEET NAME:
INTERIOR CEILING
AND WOOD SLAT
SYSTEM DETAILS

ORIG SUBMISSION: 2020.12.16


CURRENT: 2021.01.08

ADDENDUM #2

SHEET:

A-551

GMP SET

| E | ARCH- DOOR SCHEDULE | | | | | | | | | | | | | | | | |
|---------|---------------------|----------------|------------|-----------|---------------|-------|------------------|--------|---------------|---------------|---------|-----------|------|--|--------------------------------|----------|--|
| | DOOR | | PANEL TYPE | | DOOR PANEL | | PANEL DIMENSIONS | | | DOOR FRAME | | FACE DIM. | |  | SIGN | COMMENTS | |
| | NUMBER | FIRE RTG (MIN) | PANEL 1 | PANEL 2 | PANEL FINISH | WIDTH | | HEIGHT | FRAME TYPE | FRAME FINISH | JAMB WD | HEAD HT | | | | | |
| | | | | | | PNL 1 | PNL 2 | | | | | | | | | | |
| LEVEL 1 | | | | | | | | | | | | | | | | | |
| 101A | | | PNL-FG-AL | PNL-FG-AL | DARK BRONZE | 3'-0" | 3'-0" | 8'-0" | FRM-00AL(CW) | DARK BRONZE | 0" | 0" | #17 | -- | | | |
| 101B | | | PNL-FG-AL | PNL-FG-AL | DARK BRONZE | 3'-0" | 3'-0" | 8'-0" | FRM-00AL(CW) | DARK BRONZE | 0" | 0" | #17 | -- | | | |
| 101C | | | PNL-FG-AL | PNL-FG-AL | DARK BRONZE | 3'-0" | 3'-0" | 8'-0" | FRM-00AL(CW) | DARK BRONZE | 0" | 0" | #17 | -- | | | |
| 101D | | | PNL-F-HM | PNL-F-HM | PAINTED METAL | 3'-0" | 3'-0" | 7'-0" | FRM-00HM1 | PAINTED METAL | 2" | 2" | #19 | -- | | | |
| 101E | | | PNL-FG-AL | | DARK BRONZE | 3'-0" | | 8'-0" | FRM-00AL(CW) | DARK BRONZE | 0" | 0" | #17A | -- | | | |
| 101J | | | PNL-FG-AL | | DARK BRONZE | 3'-0" | | 8'-0" | FRM-00AL(CW) | DARK BRONZE | 0" | 0" | #17A | -- | | | |
| 101K | | | PNL-FG-AL | | DARK BRONZE | 3'-0" | | 8'-0" | FRM-00AL(CW) | DARK BRONZE | 0" | 0" | #17A | -- | | | |
| 102 | | | PNL-FG-AL | PNL-FG-AL | DARK BRONZE | 3'-0" | 3'-0" | 8'-0" | FRM-00AL(CW) | DARK BRONZE | 0" | 0" | #17 | -- | ACCESS CONTROL | | |
| 102A | | | PNL-FG-AL | PNL-FG-AL | DARK BRONZE | 3'-0" | 3'-0" | 8'-0" | FRM-00AL(CW) | DARK BRONZE | 0" | 0" | #17 | -- | ACCESS CONTROL | | |
| 102B | | | PNL-FG-AL | PNL-FG-AL | DARK BRONZE | 3'-0" | 3'-0" | 8'-0" | FRM-00AL(CW) | DARK BRONZE | 0" | 0" | #17 | -- | | | |
| 102C | | | PNL-FG-AL | PNL-FG-AL | DARK BRONZE | 3'-0" | 3'-0" | 8'-0" | FRM-00AL(CW) | DARK BRONZE | 0" | 0" | #17 | -- | | | |
| 103 | 45 | | PNL-F-WD | | STAINED WOOD | 3'-0" | | 7'-0" | FRM-00HM1 | PAINTED METAL | 2" | 2" | #01A | G | ACCESS CONTROL | | |
| 104 | 90 | | PNL-F-WD | PNL-F-WD | STAINED WOOD | 3'-0" | 3'-0" | 7'-0" | FRM-00HM1 | PAINTED METAL | 2" | 2" | #20 | G | ACCESS CONTROL | | |
| 105 | | | PNL-FG-AL | PNL-FG-AL | DARK BRONZE | 3'-0" | 3'-0" | 8'-0" | FRM-00AL(CW) | DARK BRONZE | 0" | 0" | #17 | -- | ACCESS CONTROL, IMPACT GLAZING | | |
| 105A | | | PNL-FG-AL | PNL-FG-AL | DARK BRONZE | 3'-0" | 3'-0" | 8'-0" | FRM-00AL(CW) | DARK BRONZE | 0" | 0" | #17 | -- | ACCESS CONTROL, IMPACT GLAZING | | |
| 105B | | | PNL-FG-AL | PNL-FG-AL | DARK BRONZE | 3'-0" | 3'-0" | 8'-0" | FRM-00AL(CW) | DARK BRONZE | 0" | 0" | #17 | -- | | | |
| 105C | | | PNL-FG-AL | PNL-FG-AL | DARK BRONZE | 3'-0" | 3'-0" | 8'-0" | FRM-00AL(CW) | DARK BRONZE | 0" | 0" | #17 | -- | | | |
| 106A | | | PNL-FG-AL | | DARK BRONZE | 3'-0" | | 8'-0" | FRM-00AL(CW) | DARK BRONZE | 0" | 0" | #17A | -- | IMPACT GLAZING | | |
| 106B | | | PNL-FG-AL | | DARK BRONZE | 3'-0" | | 8'-0" | FRM-00AL(CW) | DARK BRONZE | 0" | 0" | #17A | -- | IMPACT GLAZING | | |
| 106C | | | PNL-F-WD | | STAINED WOOD | 3'-0" | | 7'-0" | FRM-00HM1 | PAINTED METAL | 2" | 2" | #03 | G | | | |
| 107 | | | PNL-F-HM | | DARK BRONZE | 3'-0" | | 8'-0" | FRM-00AL(CW) | DARK BRONZE | 0" | 0" | #17A | -- | IMPACT GLAZING | | |
| 107A | | | PNL-F-WD | | STAINED WOOD | 3'-0" | | 7'-0" | FRM-00HM1 | PAINTED METAL | 2" | 2" | #01 | G | ACCESS CONTROL | | |
| 107B | | | PNL-F-WD | | STAINED WOOD | 3'-0" | | 7'-0" | FRM-00HM1 | PAINTED METAL | 2" | 2" | #03 | -- | | | |
| 109 | | | PNL-F-HM | PNL-F-HM | PAINTED METAL | 3'-0" | 3'-0" | 7'-0" | FRM-00HM1 | PAINTED METAL | 2" | 2" | #21 | -- | | | |
| 110 | | | PNL-F-HM | PNL-F-HM | PAINTED METAL | 3'-0" | 3'-0" | 7'-0" | FRM-00HM1 | PAINTED METAL | 2" | 2" | #21 | -- | | | |
| 111 | | | PNL-F-HM | | PAINTED METAL | 3'-6" | | 7'-0" | FRM-00HM1 | PAINTED METAL | 2" | 2" | #22 | -- | ACCESS CONTROL | | |
| 111A | 90 | | PNL-F-WD | PNL-F-HM | STAINED WOOD | 3'-0" | 3'-0" | 7'-0" | FRM-00HM1 | PAINTED METAL | 2" | 2" | #25 | E | | | |
| 111B | | | PNL-NP | | N/A | | 4'-0" | 7'-0" | FRM-00HM2 | PAINTED METAL | 2" | 2" | -- | -- | | | |
| 112 | | | PNL-F-HM | | PAINTED METAL | 3'-0" | | 7'-0" | FRM-00HM1 | PAINTED METAL | 2" | 2" | #23 | -- | ACCESS CONTROL | | |
| 121 | | | PNL-F-WD | | STAINED WOOD | 3'-0" | | 7'-0" | FRM-00HM1 | PAINTED METAL | 2" | 2" | #03 | G.2 | | | |
| 122A | | | PNL-F-WD | | STAINED WOOD | 3'-0" | | 7'-0" | FRM-00HM1 | PAINTED METAL | 2" | 2" | #02 | -- | | | |
| 122B | | | PNL-F-WD | | STAINED WOOD | 3'-0" | | 7'-0" | FRM-00HM1 | PAINTED METAL | 2" | 2" | #01 | G | ACCESS CONTROL | | |
| 123B | | | PNL-F-WD | | STAINED WOOD | 3'-0" | | 7'-0" | FRM-00HM1 | PAINTED METAL | 2" | 2" | #01 | G | ACCESS CONTROL | | |
| 124 | | | PNL-F-WD | | STAINED WOOD | 3'-0" | | 7'-0" | FRM-00HM1 | PAINTED METAL | 2" | 2" | #01 | G | ACCESS CONTROL | | |
| 125 | | | PNL-F-WD | | STAINED WOOD | 3'-0" | | 7'-0" | FRM-00AL(CW) | DARK BRONZE | 0" | 0" | #01 | G | ACCESS CONTROL | | |
| 126A | | | PNL-F-WD | | STAINED WOOD | 3'-0" | | 7'-0" | FRM-00HM1 | PAINTED METAL | 2" | 2" | #03 | J.2 | ACCESS CONTROL | | |
| 126B | 45 | | PNL-F-WD | | STAINED WOOD | 3'-0" | | 7'-0" | FRM-00HM1 | PAINTED METAL | 2" | 2" | #03 | G.2 | ACCESS CONTROL | | |
| 128 | | | PNL-F-WD | | STAINED WOOD | 3'-0" | | 7'-0" | FRM-00HM1 | PAINTED METAL | 2" | 2" | #07 | E.2 | | | |
| 129 | | | PNL-F-WD | | STAINED WOOD | 3'-0" | | 7'-0" | FRM-00HM1 | PAINTED METAL | 2" | 2" | #08 | E.2 | | | |
| 130 | | | PNL-F-WD | | STAINED WOOD | 3'-0" | | 7'-0" | FRM-00HM1 | PAINTED METAL | 2" | 2" | #07 | E.2 | | | |
| 131 | | | PNL-F-GL | | FULL GLASS | 3'-0" | | 7'-0" | FRM-50HM6(CW) | DARK BRONZE | 0" | 0" | #09A | J.2 | SLIDING DOOR SYSTEM | | |
| 132 | | | PNL-F-GL | | FULL GLASS | 3'-0" | | 7'-0" | FRM-50HM6(CW) | DARK BRONZE | 0" | 0" | #09A | J.2 | SLIDING DOOR SYSTEM | | |
| 133 | | | PNL-F-GL | | FULL GLASS | 3'-0" | | 7'-0" | FRM-50HM6(CW) | DARK BRONZE | 0" | 0" | #09A | J.2 | SLIDING DOOR SYSTEM | | |
| 134 | | | PNL-F-GL | | FULL GLASS | 3'-0" | | 7'-0" | FRM-50HM6(CW) | DARK BRONZE | 0" | 0" | #09A | J.2 | SLIDING DOOR SYSTEM | | |
| 135 | | | PNL-F-GL | | FULL GLASS | 3'-0" | | 7'-0" | FRM-50HM6(CW) | DARK BRONZE | 0" | 0" | #09A | J.2 | SLIDING DOOR SYSTEM | | |
| 136A | | | PNL-F-WD | PNL-F-WD | STAINED WOOD | 3'-0" | 3'-0" | 7'-0" | FRM-00AL(CW) | DARK BRONZE | 0" | 0" | #10 | J.2 | | | |
| 136B | 45 | | PNL-F-WD | | STAINED WOOD | 3'-0" | | 7'-0" | FRM-00HM1 | PAINTED METAL | 2" | 2" | #04 | G | | | |
| 137A | | | PNL-F-WD | PNL-F-WD | STAINED WOOD | 3'-0" | 3'-0" | 7'-0" | FRM-00AL(CW) | DARK BRONZE | 0" | 0" | #10 | J.2 | | | |
| 137B | 45 | | PNL-F-WD | | STAINED WOOD | 3'-0" | | 7'-0" | FRM-00HM1 | PAINTED METAL | 2" | 2" | #04 | G | | | |
| 138 | | | PNL-F-WD | PNL-F-WD | STAINED WOOD | 3'-0" | 3'-0" | 8'-0" | FRM-00AL(CW) | DARK BRONZE | 0" | 0" | #10 | J.2 | | | |
| 139A | | | PNL-F-WD | PNL-F-WD | STAINED WOOD | 3'-0" | 3'-0" | 8'-0" | FRM-00AL(CW) | DARK BRONZE | 0" | 0" | #10 | J.2 | | | |
| 139B | 45 | | PNL-F-WD | | STAINED WOOD | 3'-0" | | 7'-0" | FRM-00HM1 | PAINTED METAL | 2" | 2" | #04 | G | | | |
| 140 | | | PNL-F-WD | | STAINED WOOD | 3'-0" | | 7'-0" | FRM-00HM1 | PAINTED METAL | 2" | 2" | #03 | G | | | |
| 141 | 45 | | PNL-F-WD | PNL-F-WD | STAINED WOOD | 3'-0" | 3'-0" | 7'-0" | FRM-00HM1 | PAINTED METAL | 2" | 2" | #11 | G | | | |
| 142 | | | PNL-F-WD | | STAINED WOOD | 3'-0" | | 7'-0" | FRM-00HM1 | PAINTED METAL | 2" | 2" | #03 | G | | | |
| 143 | | | PNL-FG-WD | | STAINED WOOD | 3'-0" | | 7'-0" | FRM-00HM1 | PAINTED METAL | 2" | 2" | #03 | G | | | |
| 144 | | | PNL-F-WD | PNL-F-WD | STAINED WOOD | 3'-0" | 3'-0" | 7'-0" | FRM-00HM1 | PAINTED METAL | 2" | 2" | #12 | G | | | |
| 145 | | | PNL-F-WD | | STAINED WOOD | 3'-0" | | 7'-0" | FRM-00HM1 | PAINTED METAL | 2" | 2" | #05 | G | | | |
| 146 | 45 | | PNL-F-WD | PNL-F-WD | STAINED WOOD | 3'-0" | 3'-0" | 7'-0" | FRM-00HM1 | PAINTED METAL | 2" | 2" | #11 | G | | | |
| 147A | 45 | | PNL-N-WD | PNL-N-WD | STAINED WOOD | 3'-0" | 3'-0" | 7'-0" | FRM-01HM4 | PAINTED METAL | 2" | 2" | #18 | -- | ACCESS CONTROL | | |
| 147B | | | PNL-N-WD | | STAINED WOOD | 3'-0" | | 7'-0" | FRM-00HM1 | PAINTED METAL | 2" | 2" | #01 | -- | ACCESS CONTROL | | |
| 148 | 45 | | PNL-F-WD | | STAINED WOOD | 3'-0" | | 7'-0" | FRM-00HM1 | PAINTED METAL | 2" | 2" | #05 | G | | | |
| 149 | | | PNL-F-WD | | STAINED WOOD | 3'-0" | | 7'-0" | FRM-00HM1 | PAINTED METAL | 2" | 2" | #07 | E.2 | | | |
| 150 | | | PNL-F-WD | | STAINED WOOD | 3'-0" | | 7'-0" | FRM-00HM1 | PAINTED METAL | 2" | 2" | #07 | E.2 | | | |
| 151 | | | PNL-F-WD | | STAINED WOOD | 3'-0" | | 7'-0" | FRM-00HM1 | PAINTED METAL | 2" | 2" | #05 | G | | | |
| 154B | | | PNL-F-WD | | STAINED WOOD | 3'-0" | | 7'-0" | FRM-00HM1 | PAINTED METAL | 2" | 2" | #13 | H | | | |
| 154C | | | PNL-F-WD | | STAINED WOOD | 3'-0" | | 7'-0" | FRM-00HM1 | PAINTED METAL | 2" | 2" | #13 | -- | | | |
| 154D | | | PNL-F-WD | | STAINED WOOD | 3'-2" | | 7'-0" | FRM-50HM6 | N/A | 1" | 2" | #09A | H | SLIDING DOOR SYSTEM | | |
| 154E | | | PNL-F-WD | | STAINED WOOD | 3'-2" | | 7'-0" | FRM-50HM6 | N/A | 1" | 2" | #09A | H | SLIDING DOOR SYSTEM | | |
| 154F | | | PNL-F-WD | | STAINED WOOD | 3'-0" | | 7'-0" | FRM-00HM1 | PAINTED METAL | 2" | 2" | #14 | G | | | |
| 154G | | | PNL-F-WD | | STAINED WOOD | 3'-0" | | 7'-0" | FRM-00HM1 | PAINTED METAL | 2" | 2" | #14 | G | | | |
| 154H | | | PNL-F-WD | | STAINED WOOD | 3'-0" | | 7'-0" | FRM-00HM1 | PAINTED METAL | 2" | 2" | #14 | G | | | |
| 154I | | | PNL-F-WD | | STAINED WOOD | 3'-0" | | 7'-0" | FRM-00HM1 | PAINTED METAL | 2" | 2" | #08 | E.2 | | | |
| 154J | | | PNL-F-WD | | STAINED WOOD | 3'-0" | | 7'-0" | FRM-00HM1 | PAINTED METAL | 2" | 2" | #14 | G | | | |
| 155 | 45 | | PNL-F-WD | | STAINED WOOD | 3'-0" | | 7'-0" | FRM-00HM1 | PAINTED METAL | 2" | 2" | #01A | G | ACCESS CONTROL | | |
| 156 | | | PNL-F-WD | | STAINED WOOD | 3'-0" | | 7'-0" | FRM-00HM1 | PAINTED METAL | 2" | 2" | #08 | E.2 | | | |
| 158 | | | PNL-N-WD | | STAINED WOOD | 3'-0" | | 7'-0" | FRM-00HM1 | PAINTED METAL | 2" | 2" | #01 | -- | ACCESS CONTROL | | |
| 159 | | | PNL-F-WD | | STAINED WOOD | 3'-0" | | 7'-0" | FRM-00HM1 | PAINTED METAL | 2" | 2" | #07 | E.2 | | | |
| 161 | | | PNL-F-WD | | STAINED WOOD | 3'-6" | | 7'-0" | FRM-00HM1 | PAINTED METAL | 2" | 2" | #01 | G | ACCESS CONTROL | | |
| 163A | | | PNL-FG-WD | | STAINED WOOD | 3'-0" | | 7'-0" | FRM-00HM1 | PAINTED METAL | 2" | 2" | #01 | H | ACCESS CONTROL | | |
| 163B | | | PNL-FG-WD | | STAINED WOOD | 3'-0" | | 7'-0" | FRM-00HM1 | PAINTED METAL | 2" | 2" | #13 | H | | | |
| 164 | | | PNL-FG-WD | | STAINED WOOD | 3'-0" | | 7'-0" | FRM-00HM1 | PAINTED METAL | 2" | 2" | #02 | H | | | |
| 165 | | | PNL-FG-WD | | STAINED WOOD | 3'-0" | | 7'-0" | FRM-00HM1 | PAINTED METAL | 2" | 2" | #02 | H | | | |
| 166 | | | PNL-F-WD | | STAINED WOOD | 3'-0" | | 7'-0" | FRM-00HM1 | PAINTED METAL | 2" | 2" | #01 | H | | | |
| 167 | | | PNL-F-WD | | STAINED WOOD | 3'-0" | | 7'-0" | FRM-00HM1 | PAINTED METAL | 2" | 2" | #01 | G.2 | ACCESS CONTROL | | |
| 168 | | | PNL-FG-WD | | STAINED WOOD | 3'-0" | | 7'-0" | FRM-00HM1 | PAINTED METAL | 2" | 2" | #02 | H | | | |
| 169 | | | PNL-FG-WD | | STAINED WOOD | | | | | | | | | | | | |

- A. INSTALL ALL INTERIOR SIGN TYPES NOT AT GLASS WITH 1/32" THICK FOAM TAPE.
- B. AT ALL GLASS LOCATIONS, PROVIDE A MATCHING BACK COVERPLATE FOR OPPOSING SIDE OF GLASS.
- C. OWNER SHALL APPROVAL FINAL SCHEDULE COPY, COLOR SELECTIONS AND FINAL LOCATIONS. ALL DESIGN, COLOR, AND COPY ELEMENTS TO BE APPROVED BY OWNER PRIOR TO ORDER ENTRY. ROOM NAMES AND NUMBERS LISTED IN THESE DOCUMENTS MAY DIFFER FROM FINAL NAMES AND NUMBERS.

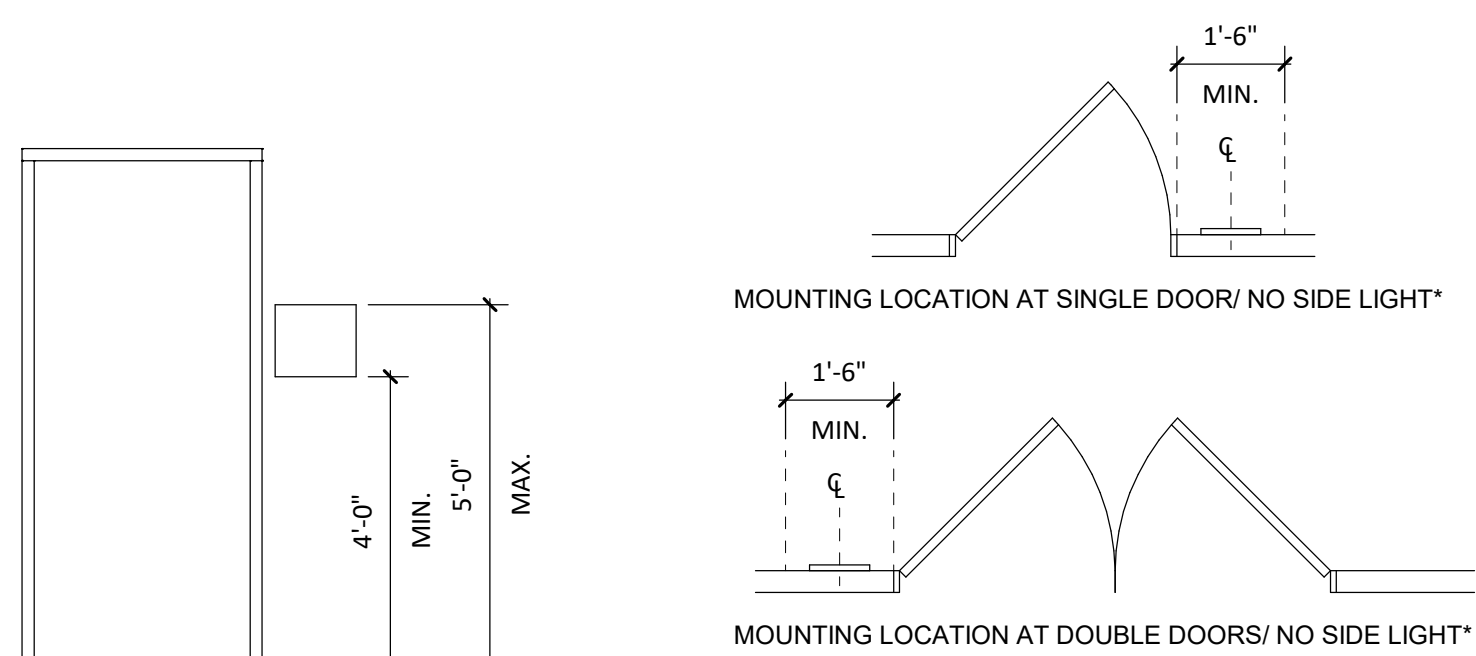


Diagram illustrating the components and dimensions of a sliding door system:

- TOTAL PNL WIDTH**: The overall width of the panel.
- SLIDING DOOR SYSTEM**: The mechanism allowing the panel to move horizontally.
- ALUMINUM STOREFRONT OPENING**: The opening in the storefront through which the panel slides.
- PANEL HEIGHT**: The vertical dimension of the panel.

| | | | | | | | | | | | | | | | |
|---------------|--------------|-------------|-----------|---------------|-----------|-------------|-----------|---------------|-----------|-------------|-----------|---------------|---------------|-------------|---------------|
| A2.5 A-602 | FRM-00AL(CW) | A3 A-602 | FRM-00AL2 | A3.5 A-602 | FRM-00HM1 | A4 A-602 | FRM-00HM2 | A4.5 A-602 | FRM-01HM4 | A5 A-602 | FRM-50HM6 | A5.5 A-602 | FRM-50HM6(CW) | A6 A-602 | FRM-52HM6(CW) |
|---------------|--------------|-------------|-----------|---------------|-----------|-------------|-----------|---------------|-----------|-------------|-----------|---------------|---------------|-------------|---------------|

[illegible]

SHEET NAME:
DOOR & FRAME
TYPES AND DETAILS
& SIGNAGE

ADDENDUM #2

SHEET:


A-602

THE LINE SHOWN ABOVE IS
A FACILITY OVERHANGING THE
PROPERTY LINE AND SHALL BE
THE PROPERTY OF THE OWNER

E


D

C

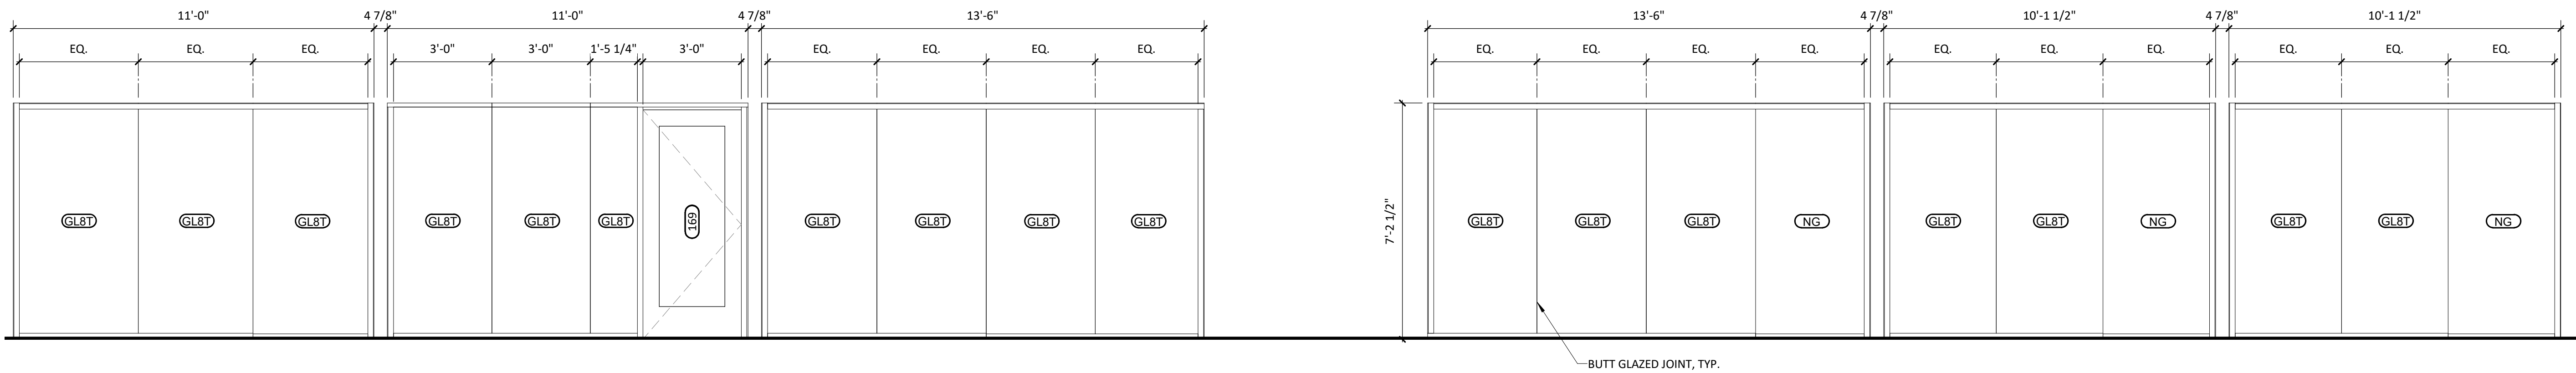

C1 LEVEL 01 AREA C OFFICES 163, 164, 165, 166, 168, 169, 170
3/8" = 1'-0"

B

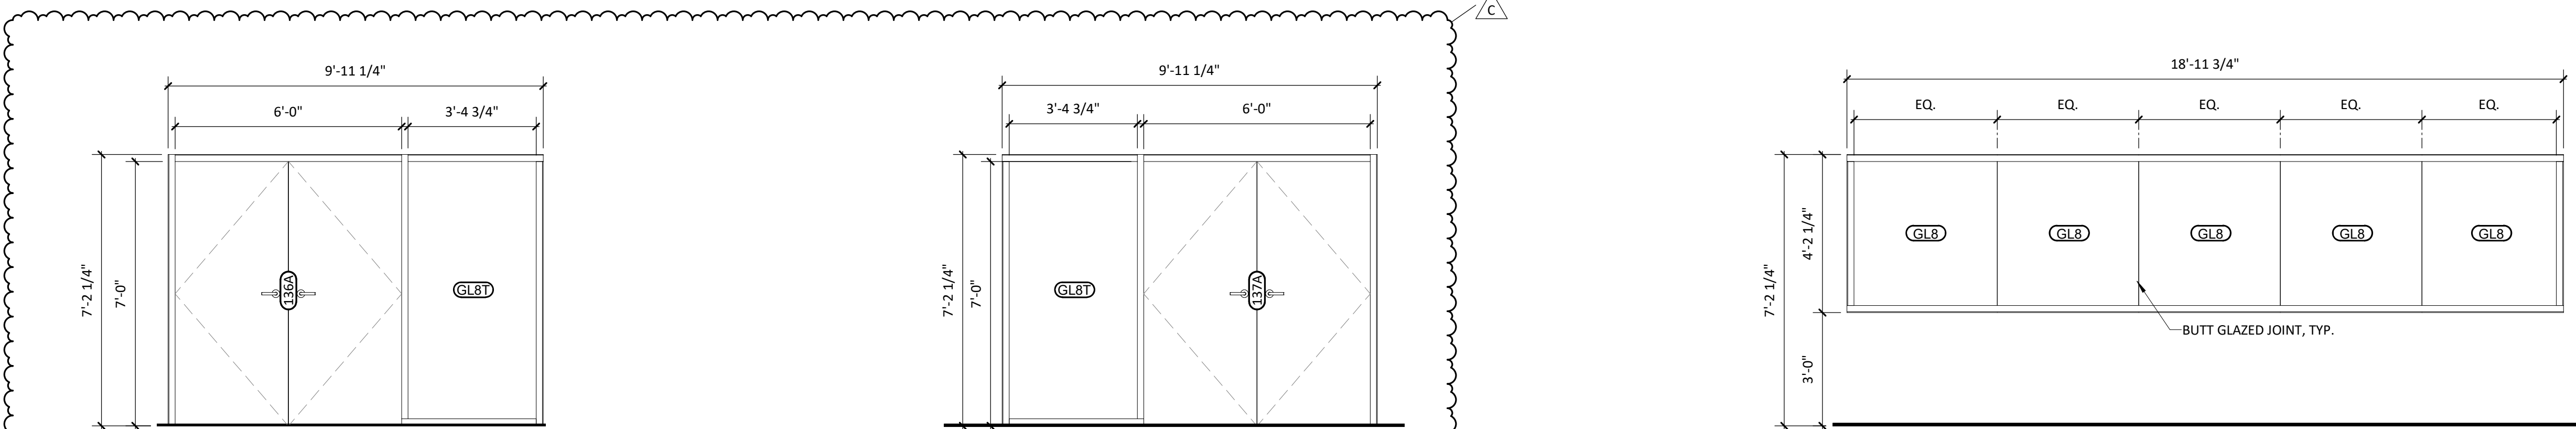


B1 LEVEL 01 AREA B TRAINING 136
3/8" = 1'-0"

B2 LEVEL 01 AREA B TRAINING 137
3/8" = 1'-0"

B3 LEVEL 01 AREA B MEDIA 143
3/8" = 1'-0"

A

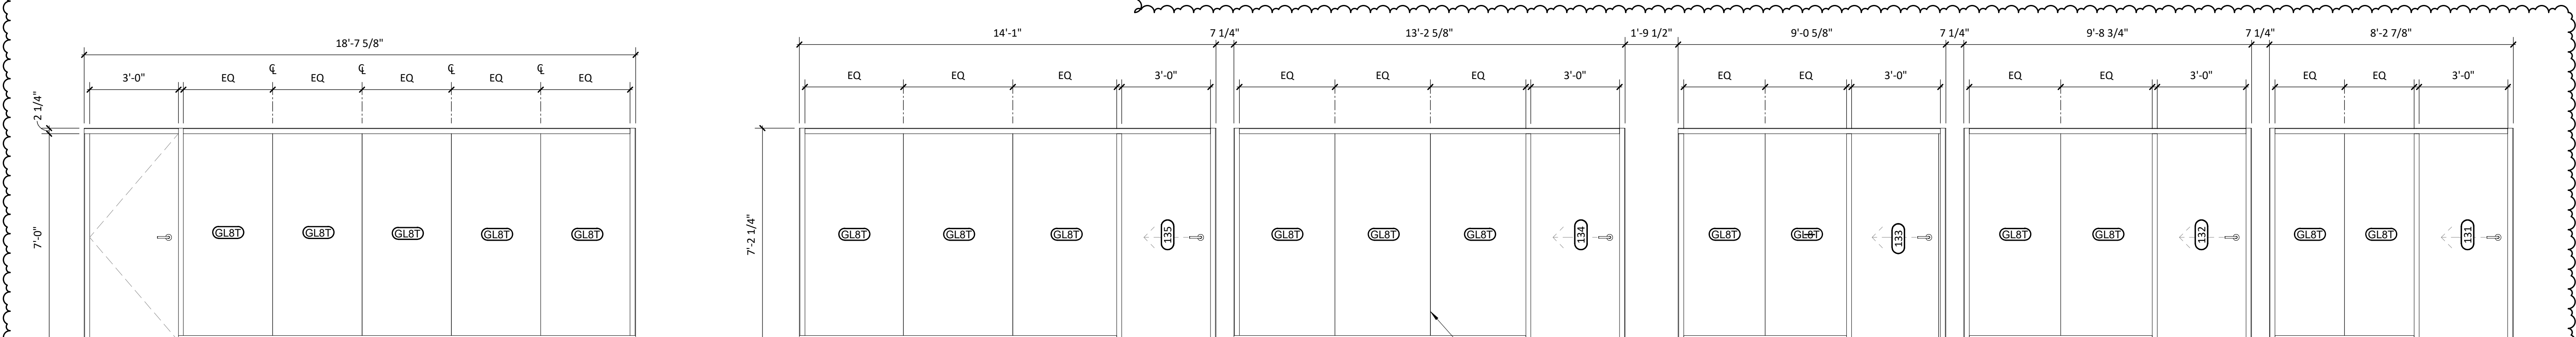

A1 LEVEL 01 AREA A VAULT 125
3/8" = 1'-0"

A2 LEVEL 01 AREA B CONF 131, 132, 133, 134, 135
3/8" = 1'-0"

GLAZING TYPES LEGEND

| TYPE | DESCRIPTION |
|------|--|
| GL1 | 1" INSULATED GLAZING |
| GL2 | 1" INSULATED GLAZING - IMPACT RESISTANT |
| GL3 | 1/4" NON-INSULATED GLAZING |
| GL4 | 1/4" NON-INSULATED GLAZING - IMPACT RESISTANT |
| GL5 | SPANDREL GLAZING |
| GL6 | SPANDREL GLAZING - IMPACT RESISTANT |
| GL7 | 1" INSULATED CERAMIC FRITTED GLAZING (ALTERNATE BID) |
| GL8 | 1/2" NON-INSULATED GLAZING |
| ACM1 | ACM SOLID PANEL |
| ---T | "T" DENOTES TEMPERED GLASS LOCATION |



CAPE FEAR FD STONEWATER



101 NORTH THIRD STREET, SUITE 500
WILMINGTON, NORTH CAROLINA 28401
TEL. 910.790.9901 FAX. 910.790.3111
WWW.LS3P.COM



NOT FOR
CONSTRUCTION

NHC Government Center 7702-190810

NEW HANOVER COUNTY
GOVERNMENT CENTER
GOVERNMENT CENTER DRIVE
WILMINGTON, NC 28403

LS3P PROJECT: 7702-190810

| A | DATE | DESCRIPTION |
|---|------------|-------------|
| A | 2020.11.20 | T1 GMP SET |
| B | 2020.12.16 | GMP SET |
| C | 2021.01.08 | ADDENDUM #2 |

SHEET NAME:
INTERIOR
STOREFRONT

ORIG SUBMISSION: 2020.12.16
CURRENT: 2021.01.08
ADDENDUM #2

SHEET:

A-621

GMP SET


1/8/2021 3:44:03 PM

E5 INT ELEV - TYP. MINI HUB ISLAND
3/8" = 1'-0"




THE LINE SHOWN ABOVE IS
BACKSPLASH INCLUDING 1/4" PLEXI GLASS BACKSPLASH
THAT IS 1/4" THICK


E

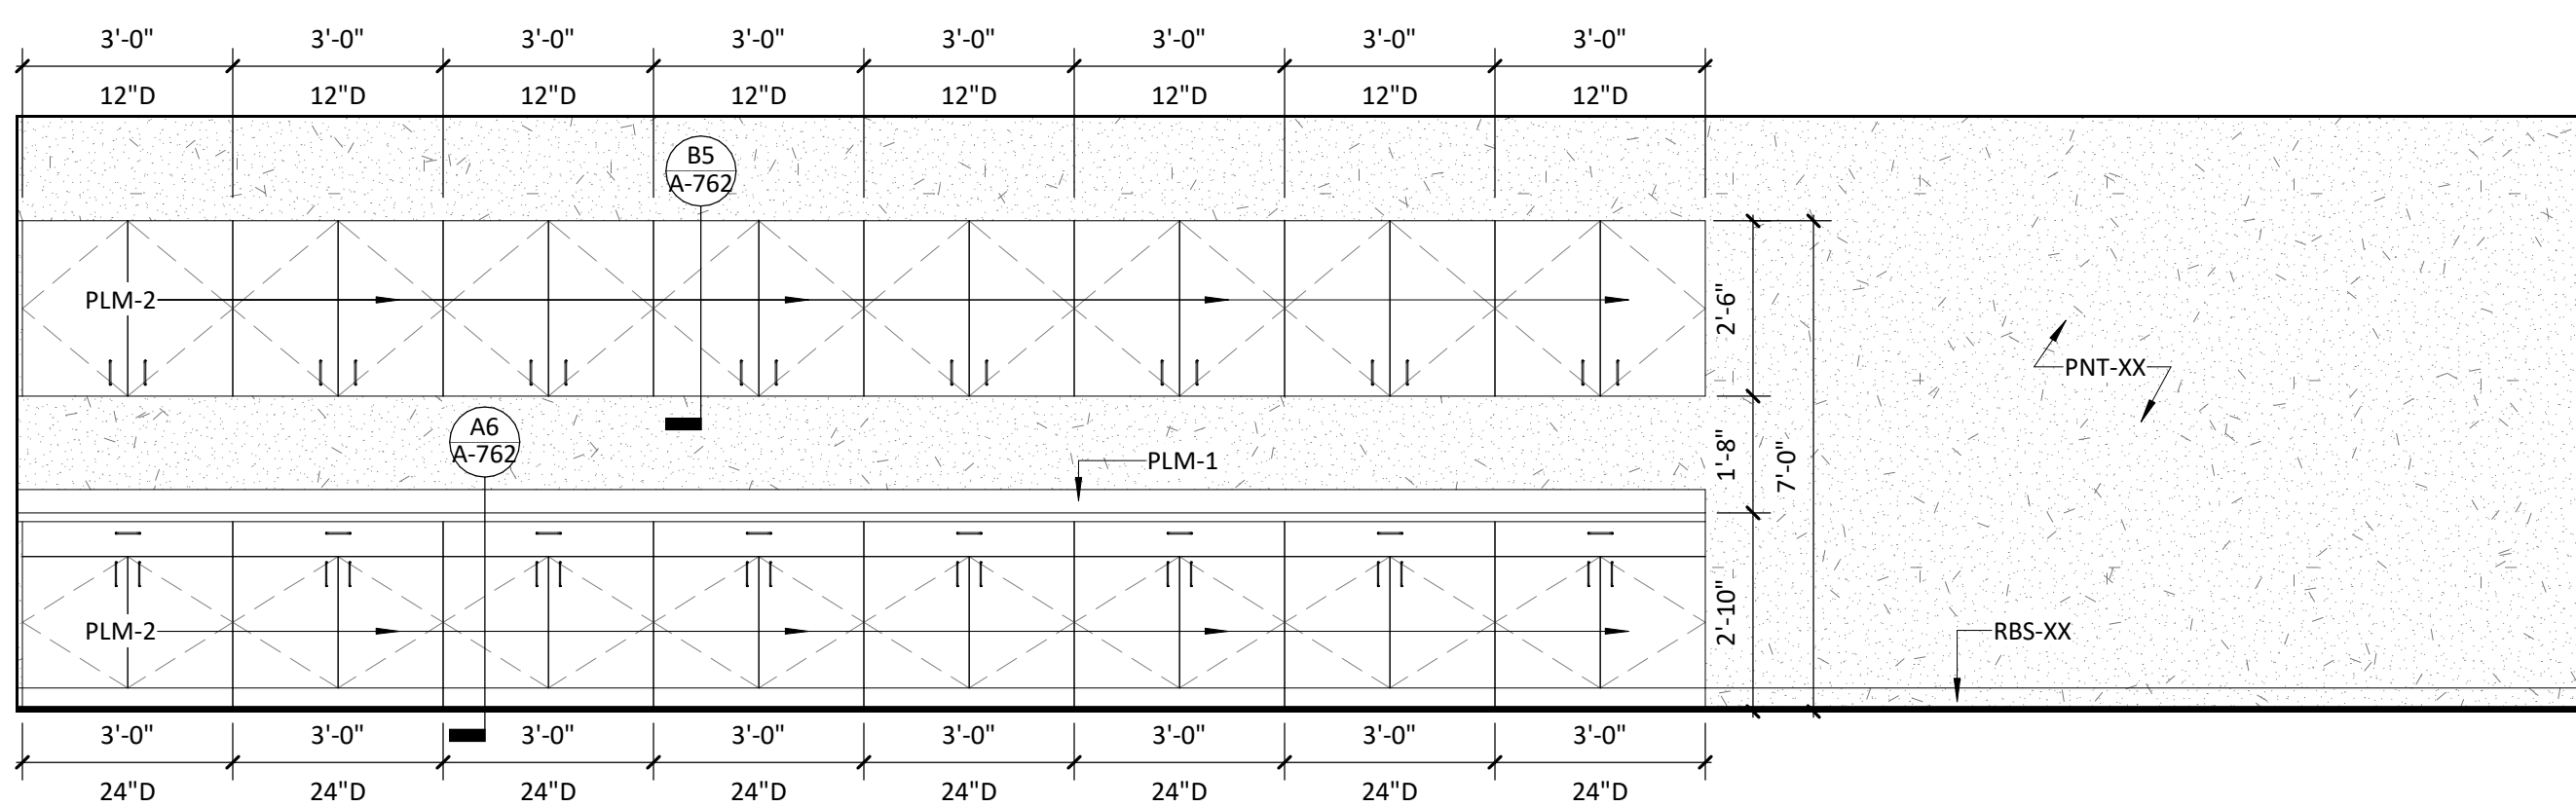


E1 INT ELEV - WORKROOM/ STORAGE 259
3/8" = 1'-0"

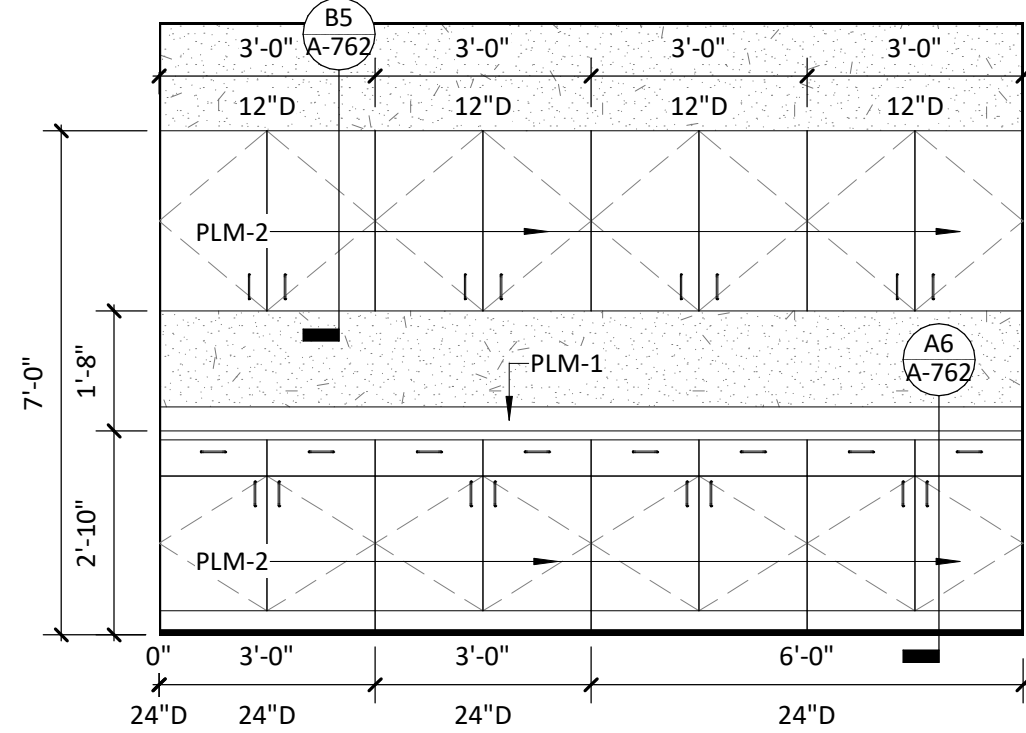

E3 INT ELEV - PLOTTER/ COPY 343
3/8" = 1'-0"

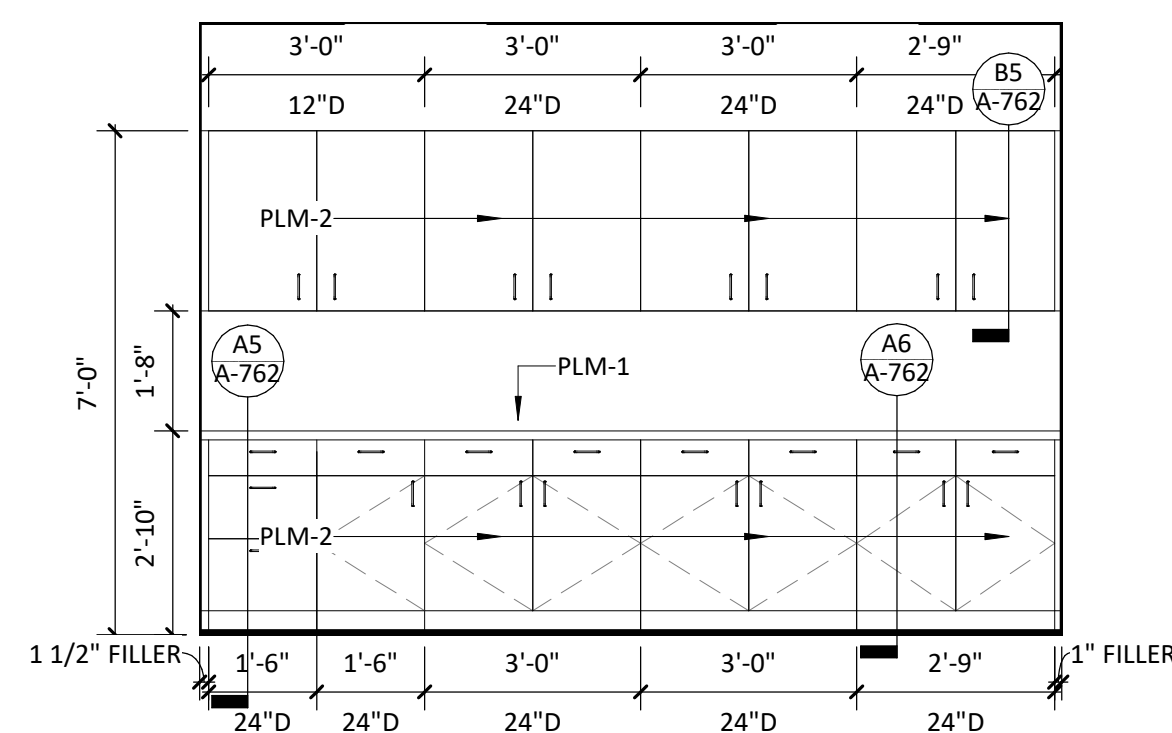

E4 INT ELEV - WORK/PRINT 438E
3/8" = 1'-0"

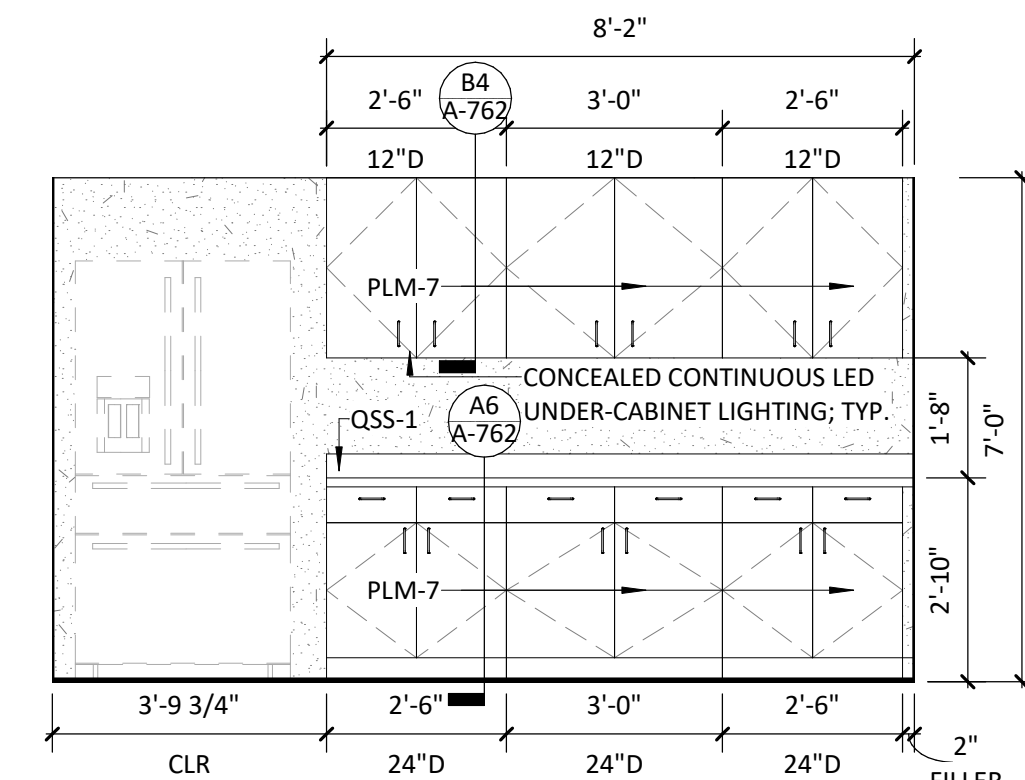

E5 INT ELEV - KITCHEN 438D
3/8" = 1'-0"

SEE SHEET
A-401 FOR
MOUNTING
HEIGHTS



CAPE FEAR FD STONEWATER

LS3P


101 NORTH THIRD STREET, SUITE 500
WILMINGTON, NORTH CAROLINA 28401
TEL. 910.790.9901 FAX. 910.790.3111
WWW.LS3P.COM





NOT FOR
CONSTRUCTION

NHC Government Center 7702-190810

D

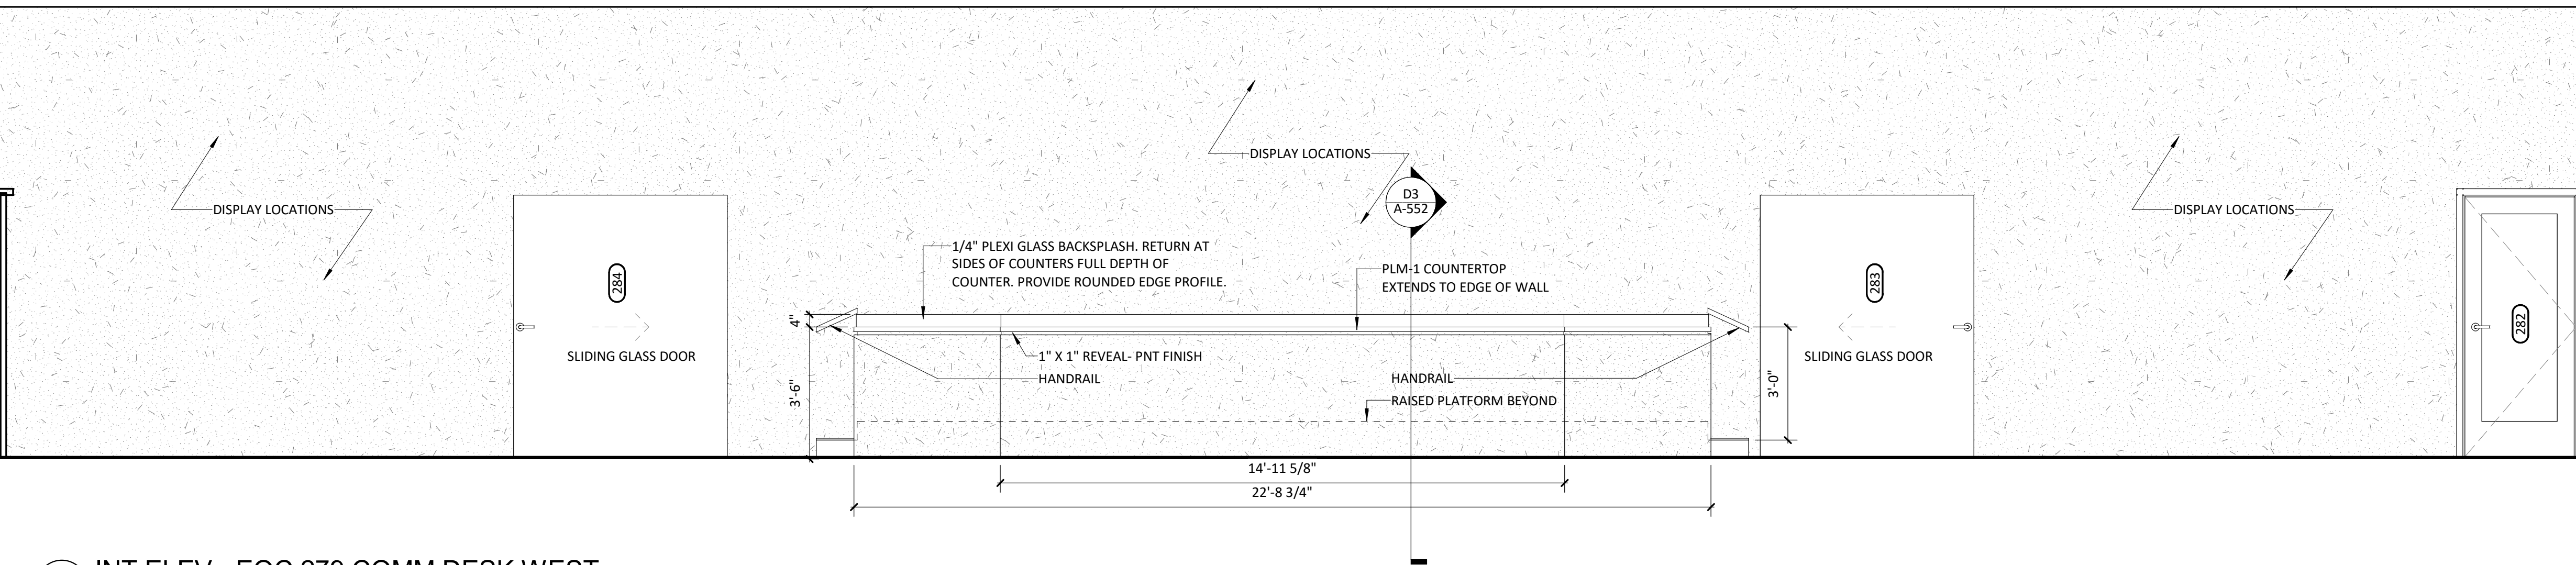


D1 INT ELEV - EOC 279 COMM DESK WEST
3/8" = 1'-0"

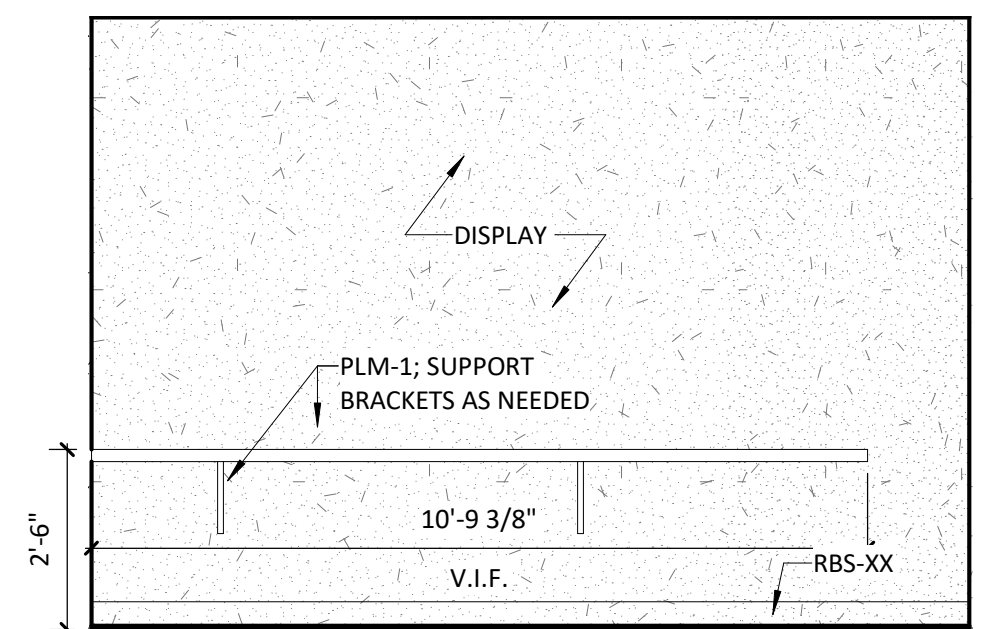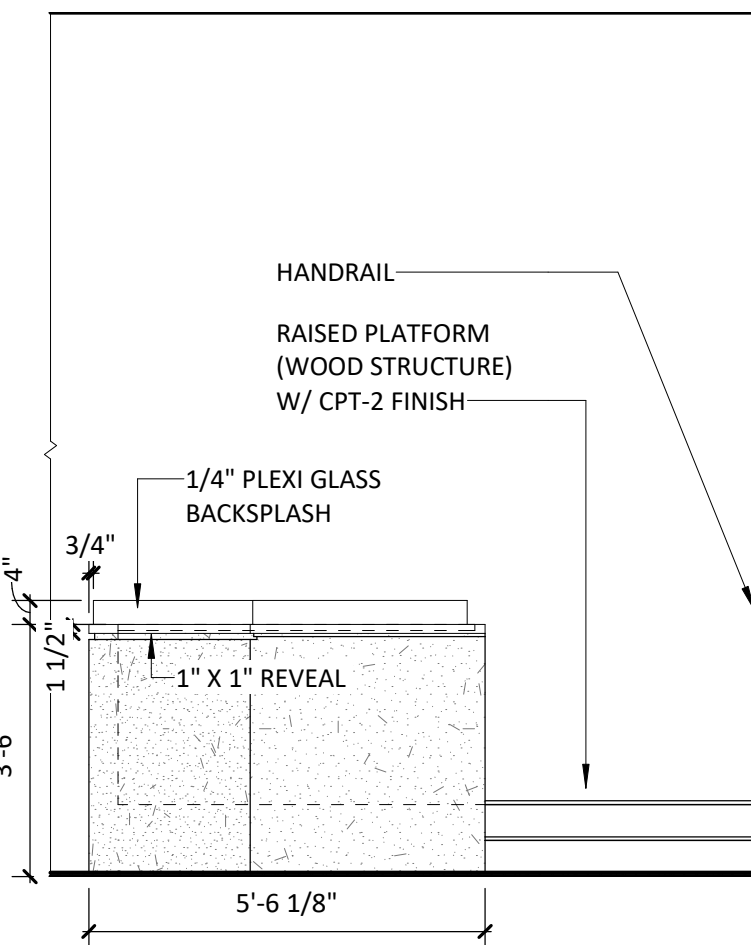


D4 INT ELEV - EOC 279 COMM DESK S
3/8" = 1'-0"

D5 INT ELEV - JIC 280 SOUTH
3/8" = 1'-0"


C

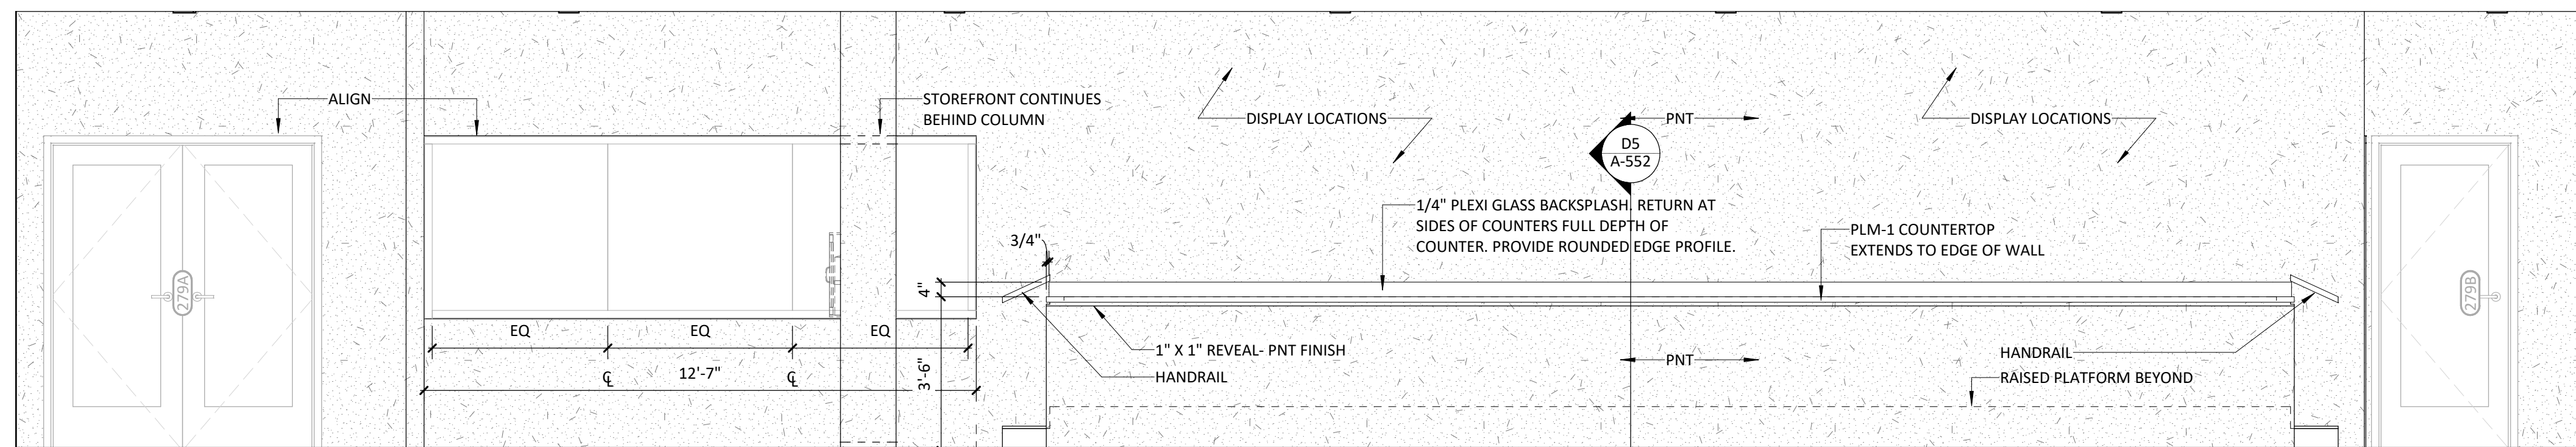

C1 INT ELEV - EOC 279 PLATFORM EAST
3/8" = 1'-0"

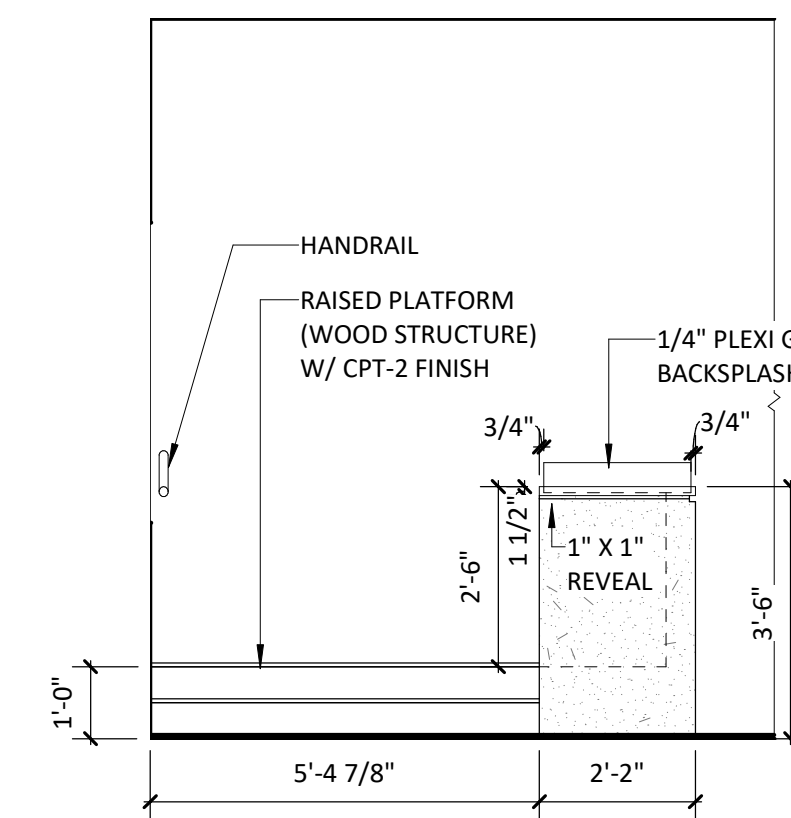


C4 INT ELEV - EOC 279 PLATFORM S
3/8" = 1'-0"

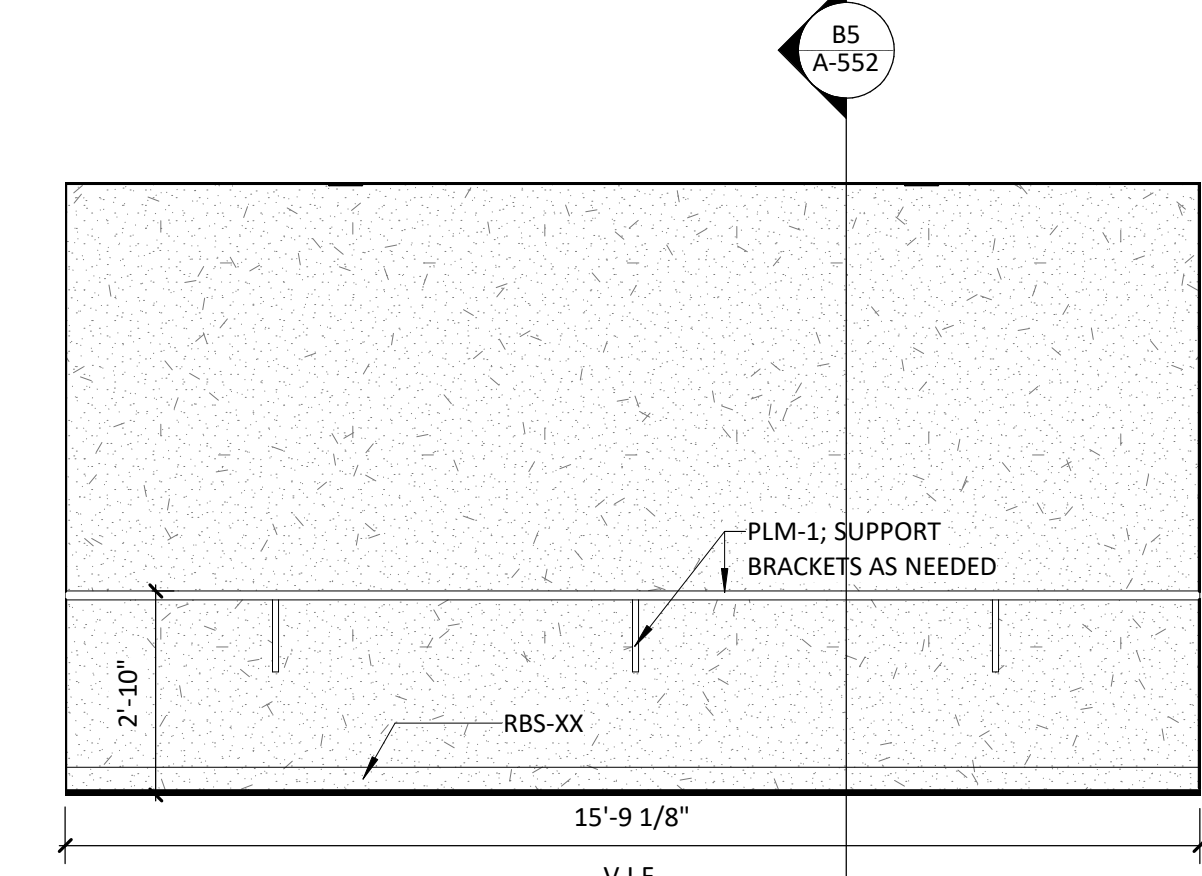


C5 INT ELEV - JCC 287 SOUTH
3/8" = 1'-0"


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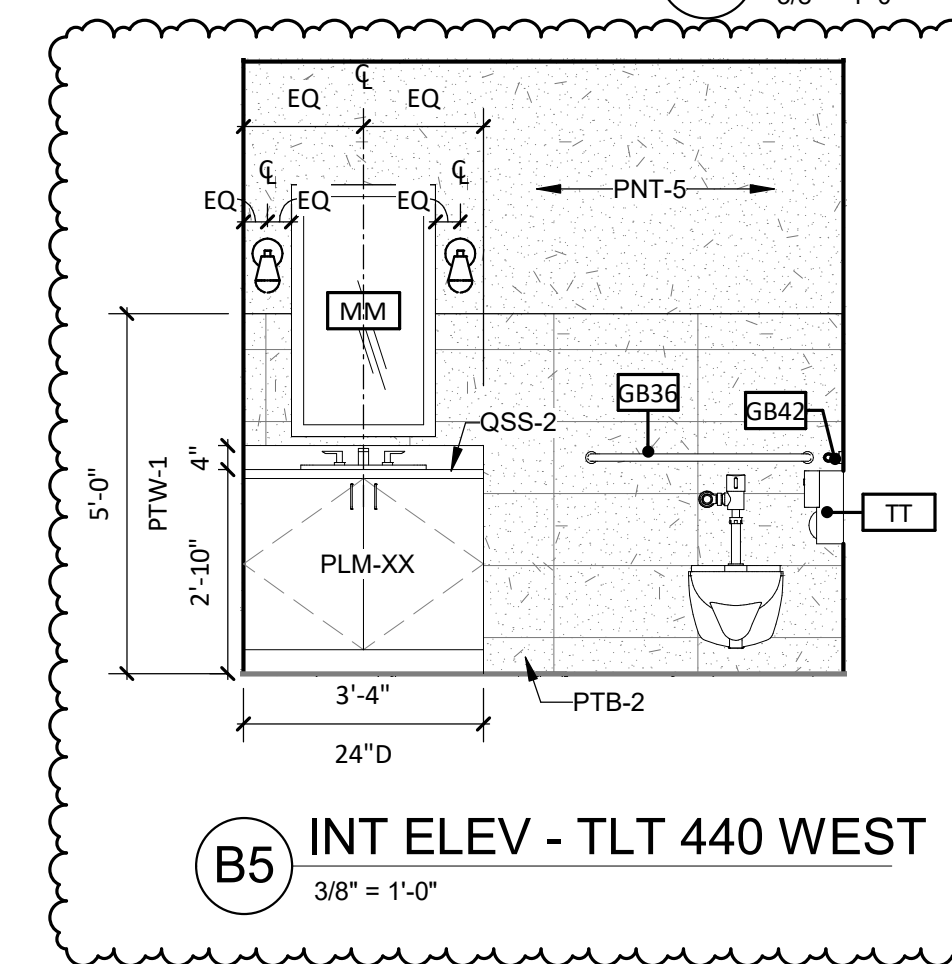
B1 INT ELEV - KITCHEN 171 NORTH
3/8" = 1'-0"

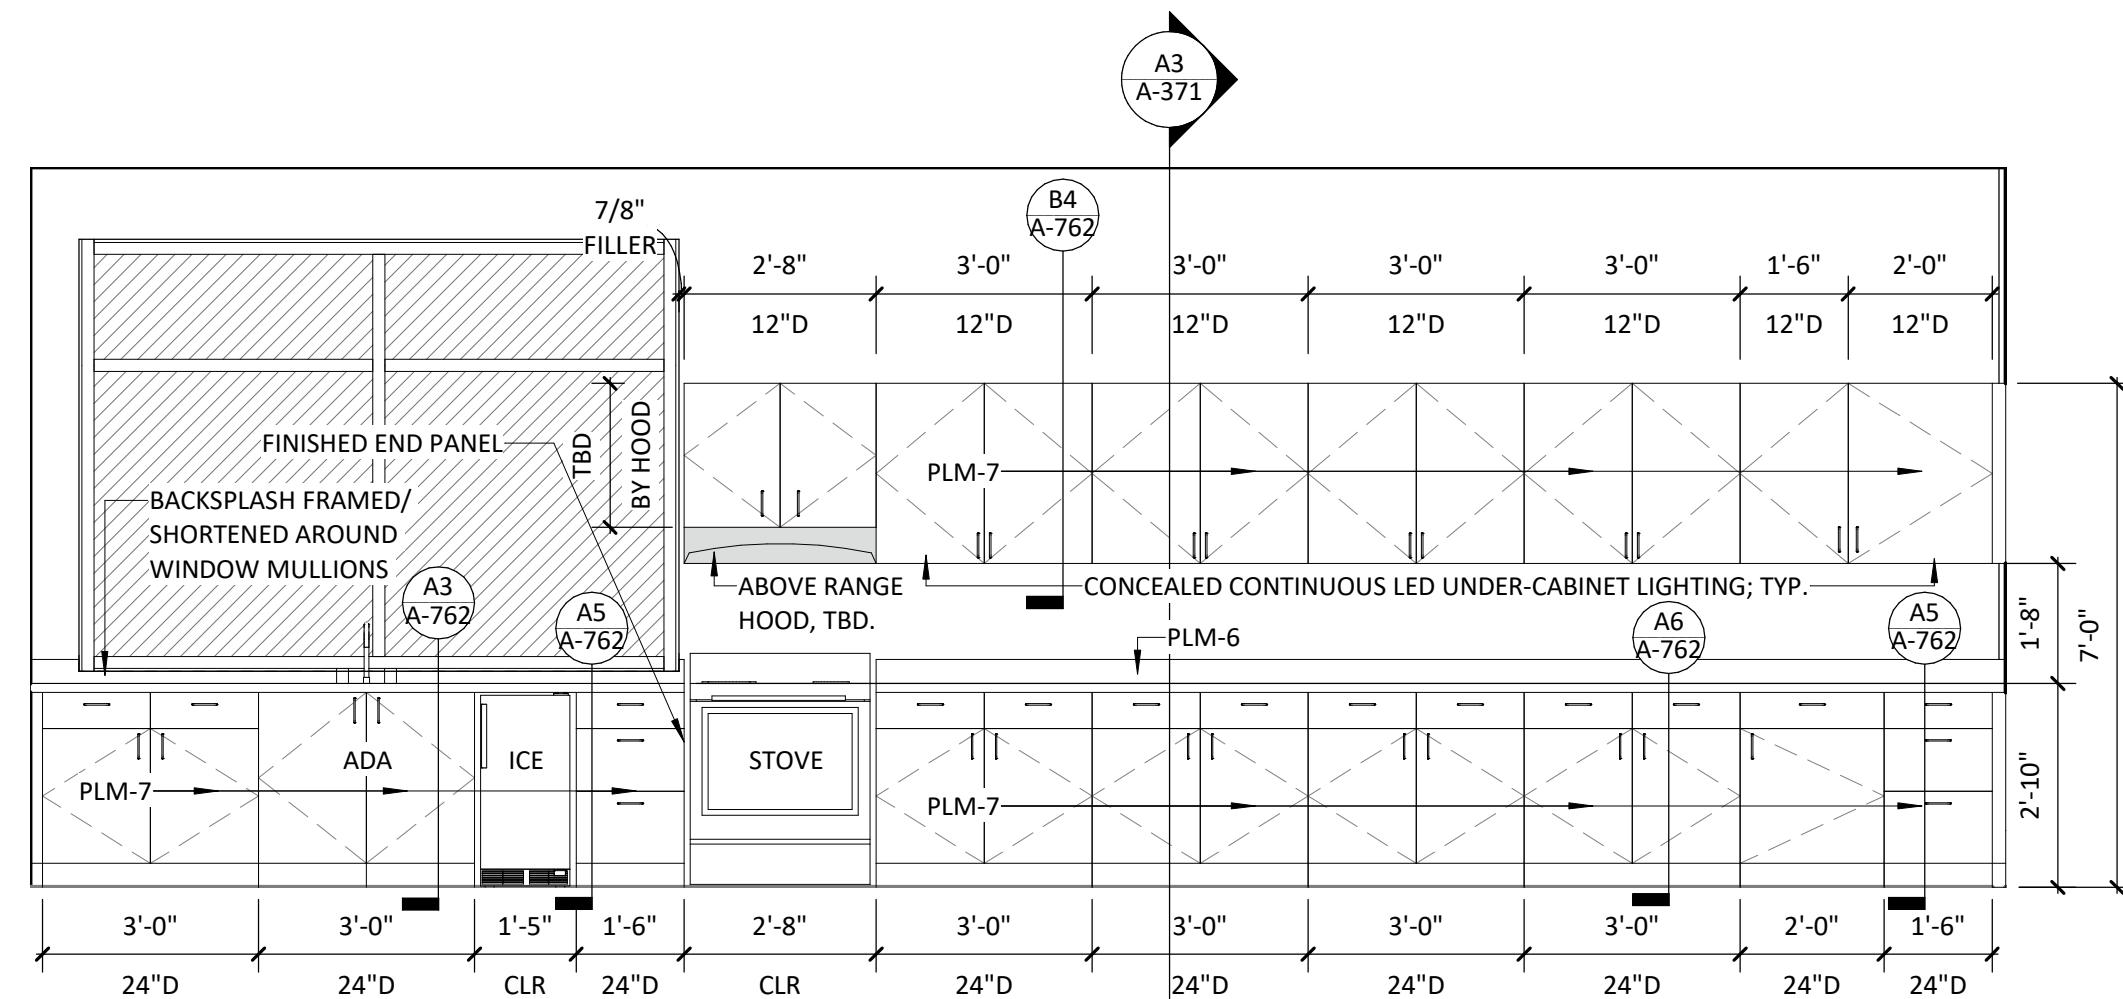

B2 INT ELEV - COPY/PRINT 278 EAST
3/8" = 1'-0"

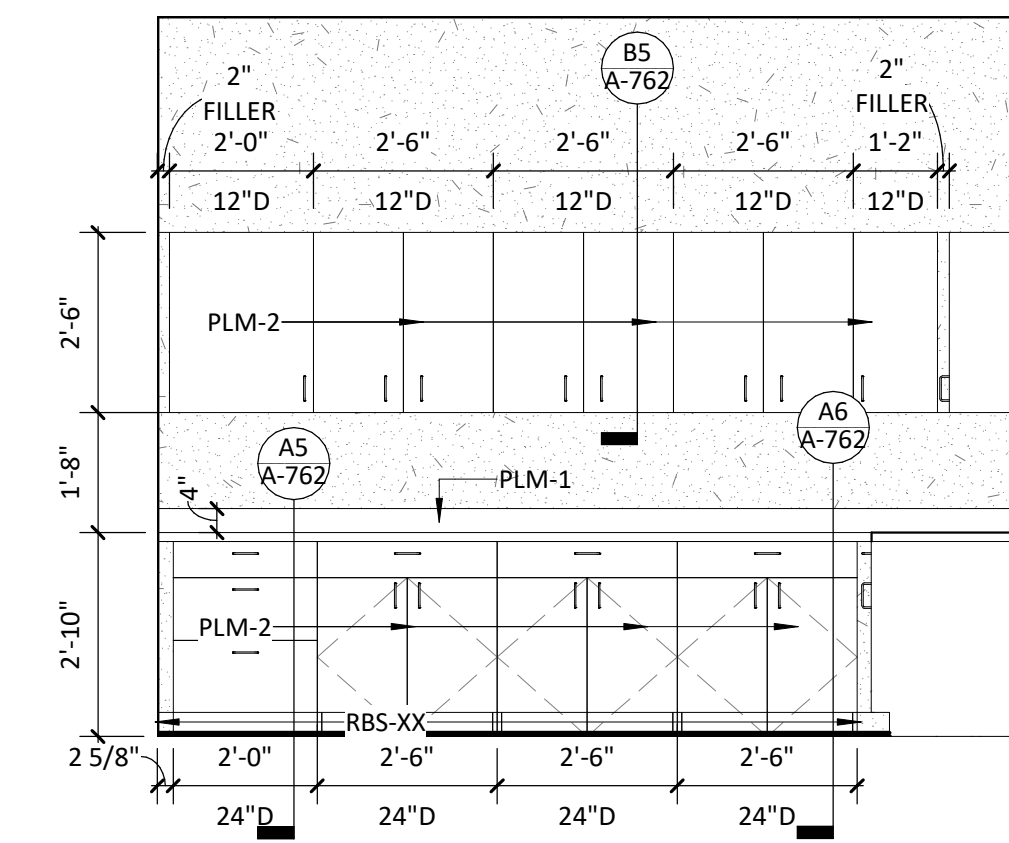


B3 INT ELEV - COPY/PRINT 278 SOUTH
3/8" = 1'-0"

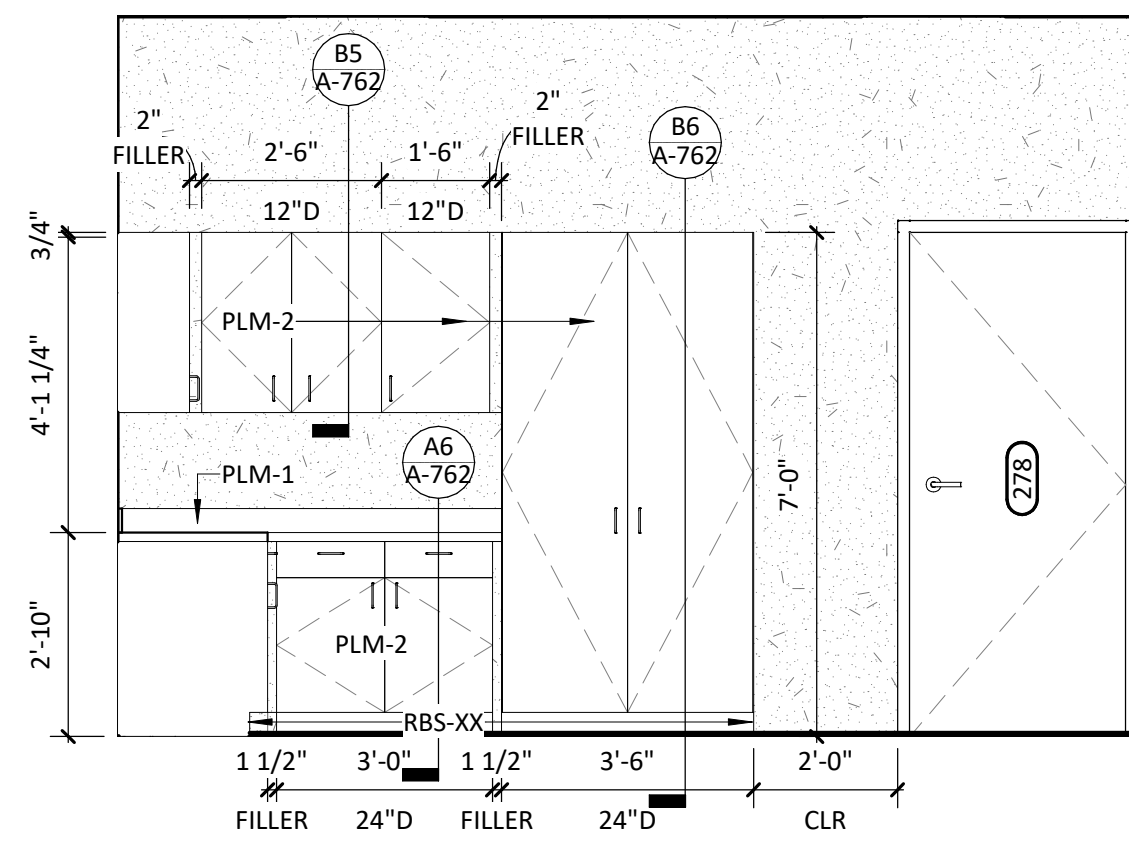


B5 INT ELEV - TLT 440 WEST
3/8" = 1'-0"

A

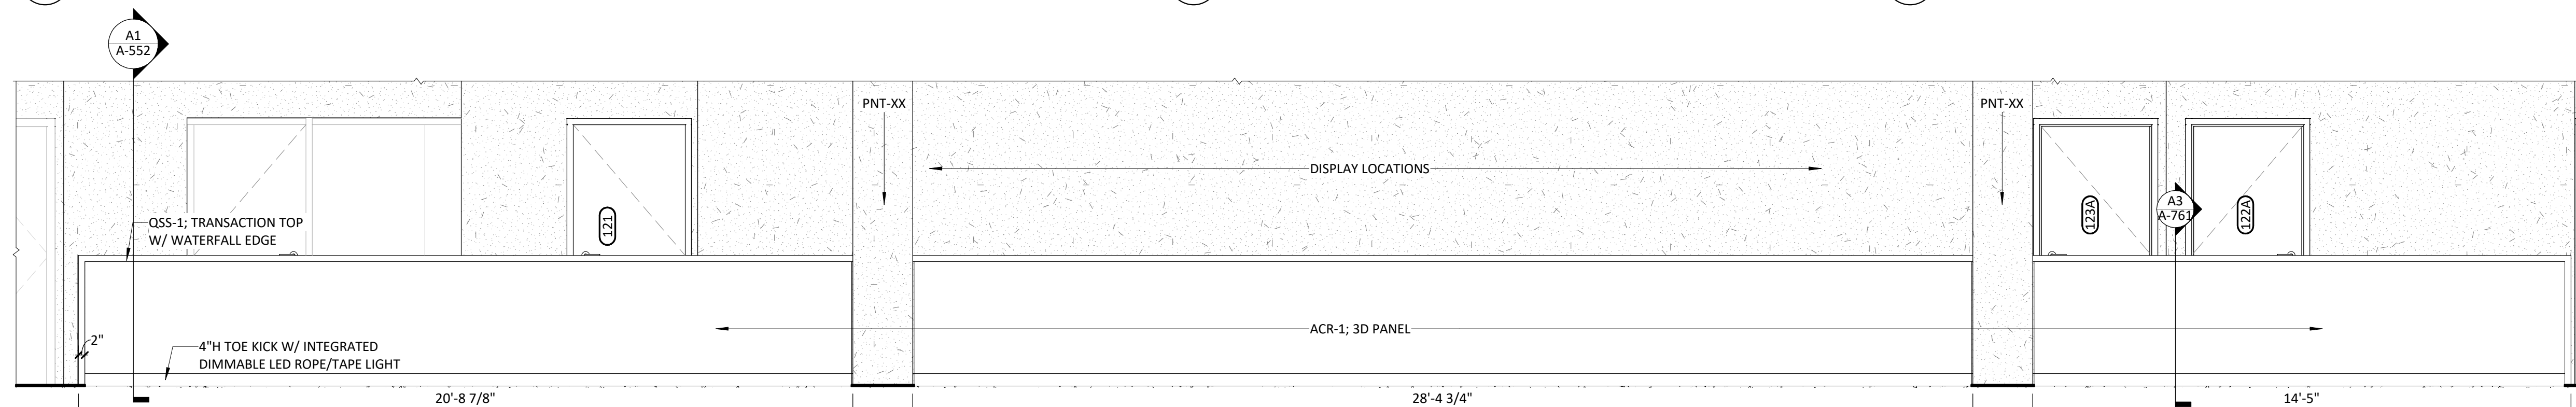

A1 INT ELEV - LOBBY A 120 WEST
3/8" = 1'-0"

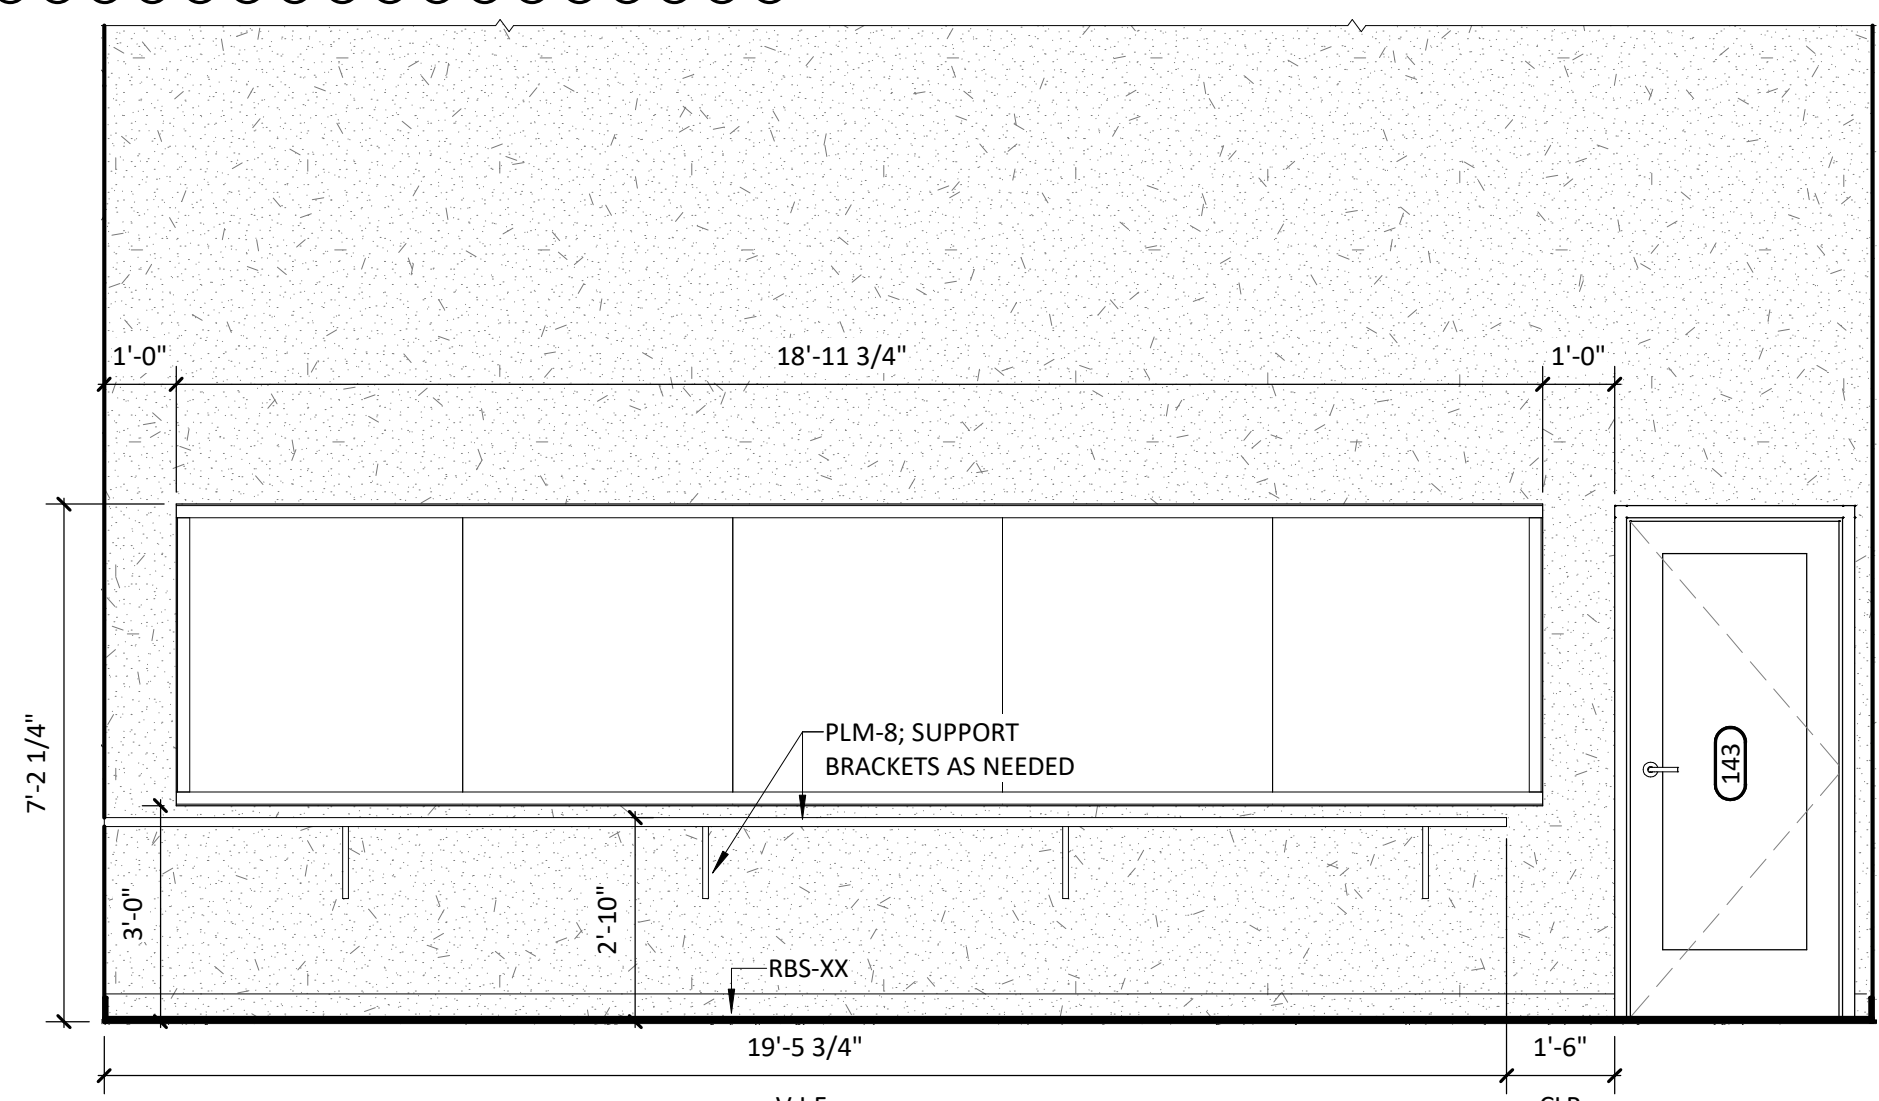

A5 INT ELEV - PRODUCTION 142 NORTH
3/8" = 1'-0"

NEW HANOVER COUNTY
GOVERNMENT CENTER
GOVERNMENT CENTER DRIVE
WILMINGTON, NC 28403

LS3P PROJECT: 7702-190810

| A | DATE | DESCRIPTION |
|---|------------|------------------------|
| A | 2020.10.16 | T1- DESIGN DEVELOPMENT |
| B | 2020.11.20 | T1- GMP SET |
| C | 2020.12.16 | GMP SET |
| D | 2021.01.08 | ADDENDUM #2 |

SHEET NAME:
INTERIOR
ELEVATIONS

ORIG SUBMISSION: 2020.12.16
CURRENT: 2021.01.08
ADDENDUM #2

SHEET:

A-712

GMP SET

1/8/2021 3:44:34 PM