

THE NEW HANOVER COUNTY, NORTH CAROLINA, HAS A LONG HISTORY OF EXCELLENCE IN THE DESIGN AND CONSTRUCTION OF PUBLIC WORKS.

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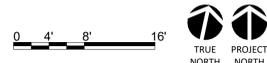
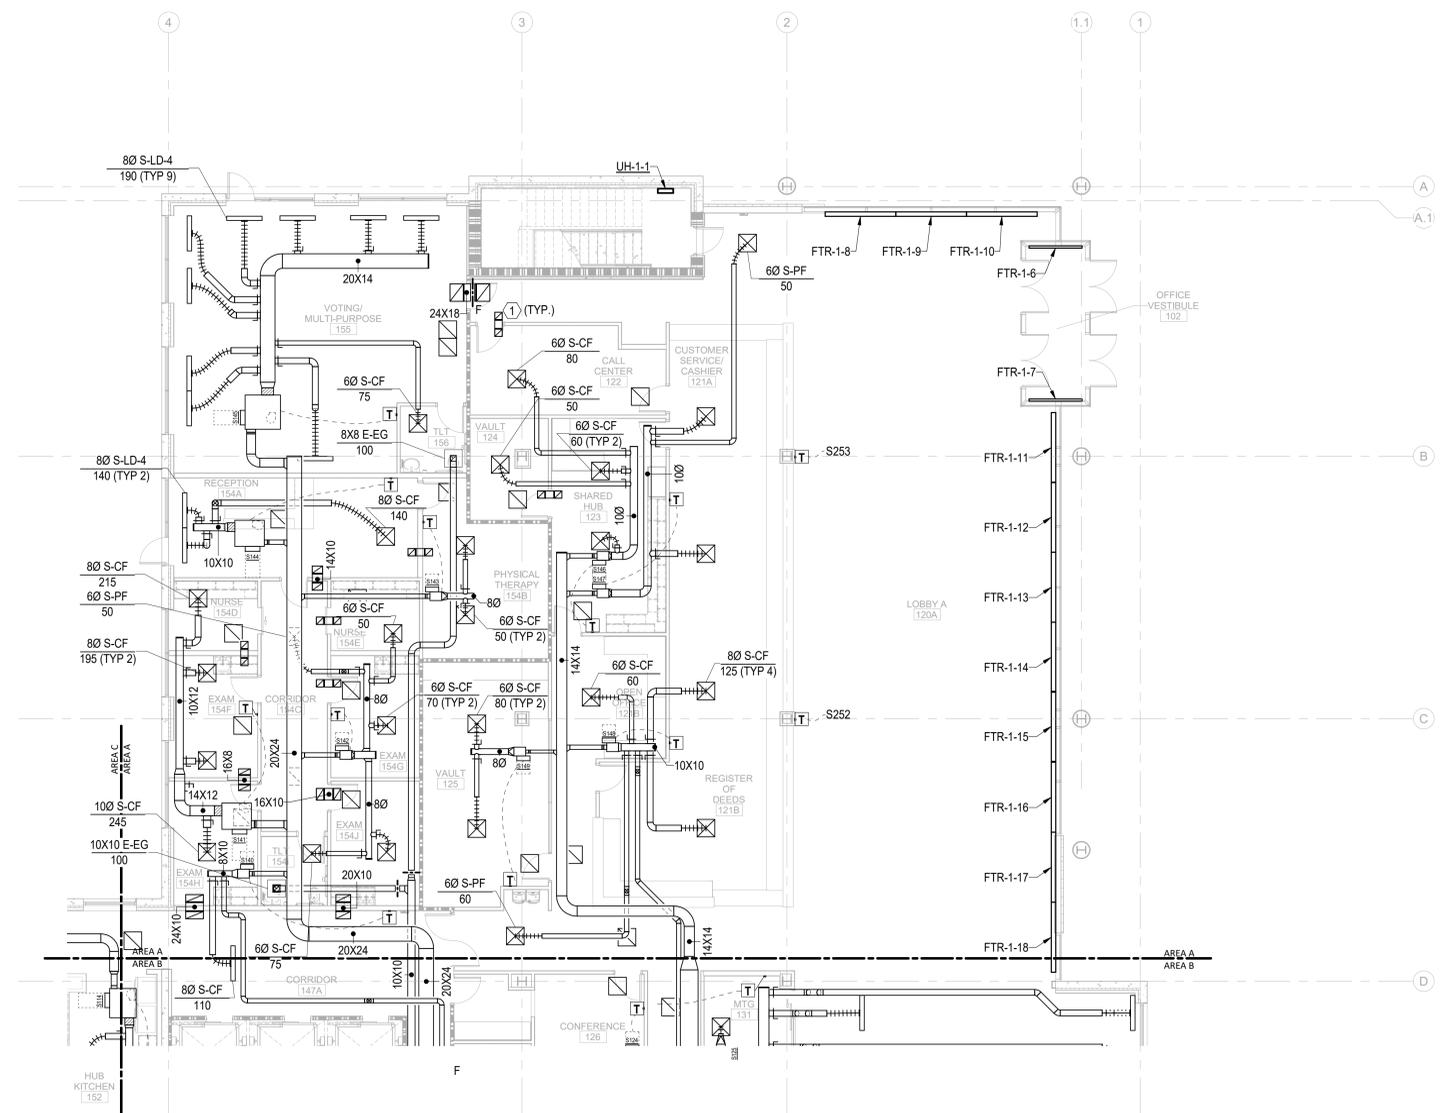
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1 M-101A HVAC TI FLOOR PLAN - PARTIAL - LEVEL 1 - AREA A



KEY NOTES:
 ① 10X10 TRANSFER DUCT (UNO). SEE DETAIL 4/M602.



CAPE FEAR FD STONEWATER



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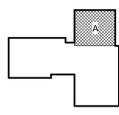
NOT FOR
 CONSTRUCTION

NHC Government Center 7702-190810

**NEW HANOVER COUNTY
 GOVERNMENT CENTER**
 GOVERNMENT CENTER DRIVE
 WILMINGTON, NC 28403
 LS3P PROJECT: 7702-190810

DATE	DESCRIPTION
A 2020.08.18	TI-SCHEMATIC DESIGN
B 2020.10.16	TI-DESIGN DEVELOPMENT
C 2020.12.16	GMP SET
D 2020.12.22	ADDENDUM #1
E 2021.01.08	ADDENDUM #2

KEY PLAN:



SHEET NAME:
 HVAC FLOOR PLAN -
 LEVEL 1 - AREA A

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 N&B PROJECT: 19N342
 Firm License No. F-0312

DATE: 2020.12.16
 CURRENT: 2021.01.08
 ADDENDUM #2

SHEET:
M-101A

GMP SET

AIR-COOLED CHILLER SCHEDULE										
NO.	CAPACITY, TONS (NOTES 1 & 2)	MAXIMUM POWER INPUT KW AT FULL LOAD	MINIMUM EER	MINIMUM NPLV	EVAPORATOR				EVAPORATOR MAXIMUM PRESS. DROP, FT. WG	NOTES
					EWT °F	LWT °F	DESIGN GPM	MINIMUM GPM		
CH-1-1	120	142	10.8	15.7	58	44	200	100	13.6	3
CH-1-2	120	142	10.8	15.7	58	44	200	100	13.6	3

- NOTES:
- CAPACITY BASED ON 95°F AMBIENT TEMPERATURE.
 - PROVIDE LOW AMBIENT OPERATION DOWN TO 30°F.
 - REFER TO THE ELECTRICAL DRAWINGS FOR EQUIPMENT ELECTRICAL CHARACTERISTICS.
 - FULLY REDUNDANT CHILLER.
 - PROVIDE EMERGENCY POWER.

ENERGY RECOVERY UNIT SCHEDULE																															
NO.	SUPPLY SIDE										GENERAL EXHAUST SIDE								VIBRATION ISOLATION												
	SUPPLY FAN					ENERGY RECOVERY WHEEL (NOTE 3)					EXHAUST FAN				ENERGY RECOVERY WHEEL (NOTE 6)				MIN. STATIC DEFLECTION IN.	NOTES											
	CFM (NOTE 7)	MAXIMUM RPM	TYPE (NOTE 1)	ESP. IN. WG (NOTE 2)	MOTOR MINIMUM HP	MAXIMUM BHP	CFM	TOTAL ENERGY EFFECTIVENESS	SUMMER	WINTER	EAT °F DB	LAT °F WB	EAT °F DB	LAT °F WB	CFM	MAXIMUM RPM	TYPE (NOTE 1)	ESP. IN. WG (NOTE 5)			MOTOR MINIMUM HP	MAXIMUM BHP									
ERU-1-1	8,000	5,400	C-AF	4.0	10	8.5	8,000	62	65	93	78	81	68	10	8	49	58	8,000	5,400	C-AF	4.0	10	8.5	8,000	75	62	70	58	FS	1.5	8

1. FAN TYPE:
 FAN:
 C CENTRIFUGAL AF AIRFOIL WHEEL:
 AF AIRFOIL
2. EXTERNAL STATIC PRESSURE DOES NOT INCLUDE UNIT CASING, OR ENERGY RECOVERY WHEELS, BUT DOES INCLUDE FILTERS.
3. OUTSIDE AIR SUPPLY SIDE OF ENERGY RECOVERY WHEELS SHALL HAVE MAXIMUM 1.0" WG APD.
4. PROVIDE VARIABLE FREQUENCY DRIVE FOR ALL FAN MOTORS.
5. EXTERNAL STATIC PRESSURE DOES NOT INCLUDE UNIT CASING OR ENERGY RECOVERY WHEELS, BUT DOES NOT INCLUDE FILTERS.
6. EXHAUST SIDE OF ENERGY RECOVERY WHEELS SHALL HAVE MAXIMUM 1.0" WG APD.
7. CFM DOES NOT INCLUDE PURGE FOR WHEEL.
8. REFER TO ELECTRICAL DRAWINGS FOR THE EQUIPMENT ELECTRICAL CHARACTERISTICS.

AIR HANDLING UNIT SCHEDULE																										
NO.	AREA SERVED (NOTE 1)	TYPE (NOTE 2)	FAN					COOLING COIL					ELECTRIC HEATING SECTION							VIBRATION ISOLATION						
			CFM	MAXIMUM RPM	TYPE (NOTE 3)	ESP. IN. WG (NOTE 4)	MOTOR MINIMUM HP	MAXIMUM BRAKE HP	MINIMUM OA CFM	CFM (NOTE 5)	MAXIMUM CHILLED WATER GPM (NOTE 6)	EAT °F DB	LAT °F WB	CONTROL VALVE TYPE (NOTE 7)	COIL SECTION AIRFLOW DURING MAXIMUM COOLING DEMAND, CFM (NOTE 8)	CONDITIONS DURING MAXIMUM HEATING DEMAND			TYPE-POSITION (NOTE 9)	CONTROL TYPE	TYPE	MIN. STATIC DEFLECTION, IN.	NOTES			
							(4) @ 20	16.22	8,000	24,000	150	82	68	52.2	52.0	2	24,000	CFM	KW	EAT °F	LAT °F	S-P	SCR	FS	0.75	11
AHU-1-1	EOC/911	DT-HZ-VV	24,000	3,500	P-AF	3.0	(4) @ 20	16.22	8,000	24,000	150	82	68	52.2	52.0	2	24,000	12,000	48	43	55.5	S-P	SCR	FS	0.75	11

- NOTES:
- DESIGN CONDITIONS:
 OUTSIDE EOC/911/HUB
 SUMMER 94°F DB, 78°F WB
 WINTER 25°F DB, 50% RH
 - TYPE:
 DT DRAW-THROUGH
 HZ HORIZONTAL
 VV VARIABLE VOLUME
 - FAN TYPE:
 P PLENUM AF AIRFOIL WHEEL:
 AF AIRFOIL
 - EXTERNAL STATIC PRESSURE DOES NOT INCLUDE UNIT CASING, PLENUMS, DIFFUSER SECTION, OR UNIT MOUNTED HEATING AND COOLING COILS, BUT DOES INCLUDE FILTERS.
 - MAXIMUM FOR VARIABLE VOLUME UNITS: 550 FPM COIL FACE VELOCITY, 1.7" WG APD.
 - CHILLED WATER BASED ON 44°F EWT AND MAXIMUM 36" WPD.
 - CONTROL VALVE TYPE:
 2 2-WAY
 - COIL FACE AREA SHALL BE BASED ON THIS CFM WITH MAXIMUM 0.4" WG AIR PRESSURE DROP.
 - TYPE:
 S STANDARD POSITION:
 P PREHEAT
 - PROVIDE VARIABLE FREQUENCY DRIVE FOR ALL FAN MOTORS.
 - REFER TO THE ELECTRICAL DRAWINGS FOR EQUIPMENT ELECTRICAL CHARACTERISTICS.
 - SUPPLY FANS TO BE FULLY REDUNDANT.
 - AHU SIZED FOR BROKEN ERU.
 - PROVIDE EMERGENCY POWER

ROOFTOP AIR CONDITIONING UNIT SCHEDULE																										
NO.	AREA SERVED (NOTE 1)	SUPPLY FAN					RELIEF FAN					COOLING SECTION (NOTE 4)							COOLING SECTION (NOTE 4)	HEATING CAPACITY		VIBRATION ISOLATION		MAXIMUM REQUIRED CIRCUIT AMPERES	NOTES	
		CFM	RPM	TYPE (NOTE 2)	ESP. IN. WG (NOTE 3)	MOTOR MINIMUM HP	MAXIMUM BRAKE HP	CFM	RPM	TYPE (NOTE 2)	ESP. IN. WG (NOTE 3)	MOTOR MINIMUM HP	MAXIMUM BRAKE HP	MINIMUM OA, CFM	COIL EAT °F DB	COIL LAT °F WB	TOTAL COOLING (MBH)	SENSIBLE COOLING (MBH)	IEER	KW	CONTROL TYPE	TYPE	MIN. STATIC DEFLECTION, IN.			
						(2) @ 15	26.2	19,000	600	AF-VV	0.5	(1) @ 15	12.15	4,900	78.9	65.4	52.5	52.4	1100	710	14.7	190	SCR	SC	2	302
RTU-R-1	LEVEL 1	25,000	1,160	AF-VV	2.5	(2) @ 15	26.2	19,000	600	AF-VV	0.5	(1) @ 15	12.15	4,900	78.9	65.4	52.5	52.4	1100	710	14.7	190	SCR	SC	2	302
RTU-R-2	LEVEL 2	20,000	1,970	AF-VV	2.5	(2) @ 10	17.9	16,000	950	AF-VV	0.5	(2) @ 8	1.76	4,200	79.6	66.0	52.5	52.4	810	520	16.7	90	SCR	SC	1	175
RTU-R-3	LEVEL 3	20,000	1,970	AF-VV	2.5	(2) @ 10	17.9	16,000	950	AF-VV	0.5	(2) @ 8	1.76	4,200	79.2	65.7	52.5	52.4	810	520	16.7	90	SCR	SC	1	175
RTU-R-4	LEVEL 4	20,000	1,970	AF-VV	2.5	(2) @ 10	17.9	16,000	950	AF-VV	0.5	(2) @ 8	1.76	4,200	79.1	65.5	52.5	52.4	810	520	16.7	90	SCR	SC	1	175

- NOTES:
- DESIGN CONDITIONS:
 OUTSIDE OFFICE
 SUMMER 94°F DB, 78°F WB
 WINTER 25°F DB, 50% RH
 - FAN TYPE:
 AF AIRFOIL VV VARIABLE VOLUME
 - EXTERNAL STATIC PRESSURE DOES NOT INCLUDE UNIT CASING, UNIT-MOUNTED COOLING AND HEAT SECTION, OR UNIT-MOUNTED DAMPERS, BUT DOES INCLUDE FILTERS.
 - UNITS SHALL START AND OPERATE DOWN TO 0°F. CAPACITY IS BASED ON 95°F CONDENSER EAT.
 - REFER TO THE ELECTRICAL DRAWINGS FOR THE EQUIPMENT ELECTRICAL CHARACTERISTICS.
 - PROVIDE VARIABLE FREQUENCY DRIVE FOR ALL FAN MOTORS.

DUCTLESS SPLIT SYSTEM SCHEDULE								
NO.	AREA SERVED	TYPE (NOTE 2)	INDOOR UNIT NOMINAL CFM (NOTE 3)	COOLING (NOTE 4)			INDOOR UNIT MOUNTING HEIGHT	NOTES
				SENSIBLE CAPACITY, MBH	TOTAL CAPACITY, MBH	MINIMUM EER		
SSAC-1-1	EOC LEVEL 1 ELECTRICAL	AC	700	18	24	13	8'	
SSAC-1-2	TOWER LEVEL 1 SERVER	AC	700	18	24	13	8'	
SSAC-1-3	TOWER LEVEL 1 COMM	AC	700	18	24	13	8'	
SSAC-1-4	TOWER LEVEL 1 AV	AC	700	18	24	13	8'	
SSAC-2-1	EOC LEVEL 2 ELECTRICAL	AC	800	42	48	10	8'	
SSAC-2-2	EOC LEVEL 2 COMM	AC	700	18	24	13	8'	
SSAC-2-3	EOC LEVEL 2 COMM	AC	700	18	24	13	8'	
SSAC-2-4	TOWER LEVEL 2 COMM	AC	700	18	24	13	8'	
SSAC-3-1	TOWER LEVEL 3 COMM	AC	700	18	24	13	8'	
SSAC-4-1	TOWER LEVEL 4 COMM	AC	700	18	24	13	8'	

- NOTES:
- DESIGN CONDITIONS:
 OUTSIDE ELECTRICAL ROOM COMMUNICATIONS ROOM
 SUMMER 94°F DB, 78°F WB
 WINTER 25°F DB, 50% RH
 - TYPE:
 AC COOLING ONLY
 - INDOOR UNIT CFM IS BASED ON MEDIUM FAN SPEED.
 - BASED ON 76°F DB 63°F WB ENTERING INDOOR COIL, AND 105°F DB ENTERING OUTSIDE COIL.
 - INTEGRAL CONDENSATE PUMP

PUMP SCHEDULE													
NO.	SERVICE	TYPE (NOTE 1)	GPM	TOTAL DYNAMIC HEAD, FT. WG	MINIMUM EFFICIENCY, %	RPM	MOTOR		VIBRATION ISOLATION				NOTES
							MINIMUM HP	MAXIMUM BRAKE HP	TYPE	MINIMUM STATIC DEFLECTION, IN.	INERTIA BASE		
PCHP-1-1	PRIMARY CHILLED WATER	E	200	90	70	1760	10	8.5	FS	1	Y	2	
PCHP-1-2	PRIMARY CHILLED WATER	E	200	90	70	1760	10	8.5	FS	1	Y	2	
SCHP-1-1	PRIMARY CHILLED WATER	E	200	75	70	1760	10	6.8	FS	1	Y	2	
SCHP-1-2	PRIMARY CHILLED WATER	E	200	75	70	1760	10	6.8	FS	1	Y	2	

- NOTES:
- TYPE:
 E END-SUCTION
 - REFER TO THE ELECTRICAL DRAWINGS FOR THE EQUIPMENT ELECTRICAL CHARACTERISTICS.
 - FULLY REDUNDANT PUMPS.
 - PROVIDE VARIABLE FREQUENCY DRIVE FOR ALL MOTORS.
 - PROVIDE EMERGENCY POWER

GENERAL SCHEDULE NOTES:
 1. ALL SCHEDULE NOTES APPLY TO SCHEDULES. NOTES SPECIFIC TO INDIVIDUAL EQUIPMENT ARE INDICATED IN "NOTES" COLUMN.

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SHEET NAME:
 HVAC SCHEDULES

DATE: 2020.12.16
 CURRENT: 2021.01.08
 ADDENDUM #2
 SHEET:

M-501

GMP SET



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NOT FOR CONSTRUCTION

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NEW HANOVER COUNTY
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 GOVERNMENT CENTER DRIVE
 WILMINGTON, NC 28403

LS3P PROJECT: 7702-190810

A	DATE	DESCRIPTION
A	2020.08.18	T1-SCHEMATIC DESIGN
B	2020.10.16	T1-DESIGN DEVELOPMENT
C	2020.12.16	GMP SET
E	2021.01.08	ADDENDUM #2



CAPE FEAR FD STONEWATER



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NHC Government Center 7702-190810

NEW HANOVER COUNTY
GOVERNMENT CENTER
GOVERNMENT CENTER DRIVE
WILMINGTON, NC 28403
LS3P PROJECT: 7702-190810

A	DATE	DESCRIPTION
A	2020.08.18	TI- SCHEMATIC DESIGN
B	2020.10.16	TI- DESIGN DEVELOPMENT
C	2020.12.16	GMP SET
D	2020.12.22	ADDENDUM #1
E	2021.01.08	ADDENDUM #2

SHEET NAME:
HVAC CONTROLS AHU

DATE: 2020.12.16
CURRENT: 2021.01.08
ADDENDUM #2

SHEET: M-701

GMP SET


SEQUENCES OF OPERATION

THE CONTROLS FOR SYSTEM AHU-1-1 SHALL FUNCTION AS FOLLOWS:

- SYSTEM START-UP:** THE SYSTEM SHALL BE AUTOMATICALLY STARTED AND STOPPED BY THE BCS CONTROLLER WHENEVER THE HAND-OFF-AUTOMATIC SWITCH IS IN THE AUTOMATIC POSITION, AND MANUALLY STARTED AND STOPPED BY THE HAND AND OFF POSITIONS.
- DAMPER POSITIONS:** PRIOR TO FAN STARTING, THE RETURN AIR DAMPER, SUPPLY FAN ISOLATION DAMPER AND ALL COMBINATION FIRE AND SMOKE DAMPERS SHALL OPEN. ONCE THE DAMPERS ARE 100% OPEN, AS SENSED BY FEEDBACK FROM THE END SWITCHES, THE OUTSIDE AIR DAMPER SHALL OPEN, AND SUPPLY FANS SHALL START.
- UNIT START-UP:** ON UNIT START-UP, THE SYSTEM SHALL RUN. IF OUTSIDE AIR TEMPERATURE IS BELOW 55°F (ADJUSTABLE) CLOSE THE CHILLED WATER VALVE AND MODULATE THE PREHEAT COIL CONTROLLER TO MAINTAIN A SYSTEM DISCHARGE AIR TEMPERATURE SETPOINT OF 55°F. IF OUTSIDE AIR TEMPERATURE IS 55°F (ADJUSTABLE) OR HIGHER, TURN OFF THE ELECTRIC HEATER, AND MODULATE THE CHILLED WATER VALVE TO MAINTAIN A SYSTEM DISCHARGE AIR TEMPERATURE SETPOINT OF 55°F. MODULATE THE SUPPLY FAN VARIABLE FREQUENCY DRIVE TO MAINTAIN SUPPLY DUCT STATIC PRESSURE AT OR ABOVE SETPOINT, AS DETERMINED DURING THE TESTING, ADJUSTING AND BALANCING PROCESS.
- PREHEAT COIL CONTROL:** MODULATE THE PREHEAT COIL CONTROLLER TO MAINTAIN A PREHEAT COIL DISCHARGE TEMPERATURE SETPOINT OF 55°F (ADJUSTABLE).
- SUPPLY AIR TEMPERATURE RESET:** MODULATE THE CHILLED WATER VALVE IN SEQUENCE TO MAINTAIN SYSTEM DISCHARGE AIR TEMPERATURE SETPOINT. VARY THE SUPPLY AIR TEMPERATURE BETWEEN 50°F AND 55°F IN 1" INCREMENTS EVERY 30 MINUTES TO MAINTAIN SUPPLY AIR TEMPERATURE SETPOINT. OVERRIDE OTHER CONTROLS AND MODULATE THE PREHEAT COIL VALVE TO MAINTAIN COIL DISCHARGE TEMPERATURE SETPOINT SENSED BY AN AVERAGING ELEMENT LOCATED IMMEDIATELY DOWNSTREAM OF THE PREHEAT COIL. THIS CONTROL SHALL REMAIN ACTIVE AT ALL TIMES, INCLUDING UNIT SHUTDOWN.
- SUPPLY DUCT STATIC PRESSURE CONTROL:** MODULATE BOTH SUPPLY FANS VARIABLE FREQUENCY DRIVES TO MAINTAIN SUPPLY DUCT STATIC PRESSURE AT OR ABOVE SETPOINT, AS DETERMINED DURING THE TESTING, ADJUSTING AND BALANCING PROCESS.
- SUPPLY DUCT STATIC PRESSURE CONTROL:** UPON SYSTEM START-UP, THE SUPPLY DUCT STATIC PRESSURE SETPOINT SHALL BE EQUAL TO 75% (ADJUSTABLE) OF THE MAXIMUM DUCT STATIC PRESSURE SETPOINTS FOR SUPPLY DUCT STATIC PRESSURES. THE MAXIMUM AND MINIMUM DUCT STATIC PRESSURE SETPOINT SHALL BE AS DETERMINED DURING THE TESTING, ADJUSTING AND BALANCING PROCESS. THE MINIMUM SETPOINT SHALL BE EQUAL TO 1.25 TIMES THE DUCT STATIC PRESSURES WHEN ALL VARIABLE AIR VOLUME TERMINAL UNITS ARE AT MINIMUM AIRFLOW AND AT LEAST ONE TERMINAL UNIT DAMPER IS GREATER THAN 90% OPEN. THE MAXIMUM SETPOINT SHALL CORRESPOND TO MAXIMUM DESIGN AIRFLOW.
- OUTSIDE AIR CONTROL:** MODULATE THE OUTSIDE AIR DAMPER TO MAINTAIN MINIMUM AIRFLOW AS MEASURED BY OUTSIDE AIR FLOW STATION. EVALUATE THE MINIMUM OUTSIDE AIR BALANCING DAMPER ON 5-MINUTE INTERVALS (ADJUSTABLE). ADJUST THE MINIMUM OUTSIDE AIRFLOW SETPOINT BETWEEN THE LOWER AND UPPER LIMITS IN 10% INCREMENTS EVERY 10 MINUTES. IF THE AVERAGE SPACE CARBON DIOXIDE CONCENTRATIONS ARE BELOW 800 PPM (ADJUSTABLE), REDUCE MINIMUM OUTSIDE AIRFLOW SETPOINT. IF THE AVERAGE SPACE CARBON DIOXIDE CONCENTRATIONS ARE ABOVE 900 PPM (ADJUSTABLE) INCREASE MINIMUM OUTSIDE AIRFLOW SETPOINT. IF ANY SPACE CARBON DIOXIDE CONCENTRATION IS ABOVE 1000 PPM FOR 5 MINUTES (ADJUSTABLE), INCREASE MINIMUM OUTSIDE AIRFLOW SETPOINT. IF ANY SPACE CARBON DIOXIDE CONCENTRATION IS ABOVE 1000 PPM FOR LONGER THAN 1 HOUR (ADJUSTABLE), INITIATE AN ALARM THROUGH THE BCS.
- HIGH PRESSURE SAFETY:** A HIGH PRESSURE SAFETY SENSING DISCHARGE STATIC PRESSURE SET AT 80% OF THE DUCT PRESSURE RATING SHALL STOP THE FAN.
- LOW PRESSURE SAFETY:** A LOW PRESSURE SAFETY SENSING INLET STATIC PRESSURE SET AT 80% OF THE DUCT PRESSURE RATING SHALL STOP THE FAN.
- NIGHT SETBACK OVERRIDE:** A DROP IN SPACE TEMPERATURE BELOW NIGHT SETBACK SETPOINT SHALL OVERRIDE THE SUPPLY FAN INTERLOCK AND ALLOW THE TERMINAL UNITS SYSTEM TO OPERATE UNDER NORMAL CONTROL IN START-UP UNTIL SPACE TEMPERATURE RISES ABOVE NIGHT SETBACK SETPOINT.
- SHUTDOWN:** ON POWER INTERRUPTION OR FAN SHUTDOWN, THE MINIMUM AND MAXIMUM OUTSIDE AIR, RETURN DAMPERS, COMBINATION FIRE AND SMOKE DAMPER AND CHILLED WATER VALVES SHALL CLOSE. AND THE TERMINAL UNITS ELECTRIC HEATING COILS SHALL BE DEACTIVATED.
- EMERGENCY SHUT DOWN:** A MANUAL PUSH BUTTON LOCATED IN THE MECHANICAL ROOM SHALL SHUT THE AIR HANDLING UNIT DOWN.
- FIRE ALARM SYSTEM:** ON ACTIVATION OF THE FIRE ALARM SYSTEM RELAY OR SMOKE DETECTOR, THE CORRESPONDING FIRE SMOKE DAMPER SHALL CLOSE AND THE AIR HANDLING UNIT SHALL SHUT DOWN.

BCS PANEL INPUT/OUTPUT SUMMARY AIR HANDLING UNIT	OUTPUTS		INPUTS		SOFTWARE		NOTES
	DIGITAL	ANALOG	DIGITAL	ANALOG	ALARM	BCS	
AIR HANDLING UNIT (AHU)	X						
OUTSIDE AIR DAMPER		X					C
RETURN AIR DAMPER		X					O
SUPPLY FAN ISOLATION DAMPER		X					O
HEATING COIL DISCHARGE TEMPERATURE				X			
MIXED AIR TEMPERATURE				X			
ELECTRIC PREHEAT COIL		X					5
CHILLED WATER CONTROL VALVE			X				O
COOLING COIL HUMIDITY				X			
COOLING COIL LEAVING AIR TEMPERATURE				X			
SF-1, SF-2, SF-3 AND SF-4 START/STOP	X						O 4
SF-1, SF-2, SF-3 AND SF-4 VFD SPEED		X					
SF-1, SF-2, SF-3 AND SF-4 STATUS			X				
SF-1, SF-2, SF-3 AND SF-4 AIRFLOW MEASUREMENT SYSTEM				X		X	
SYSTEM DISCHARGE AIR TEMPERATURE				X		X	
HIGH PRESSURE SAFETY			X				
LOW PRESSURE SAFETY			X				
FILTER DIFFERENTIAL PRESSURE				X		X	
SUPPLY DUCT STATIC PRESSURE				X		X	
RETURN AIR SPACE TEMPERATURE			X			X	
RETURN AIR RELATIVE HUMIDITY			X			X	
OA TEMPERATURE			X			X	3

- NOTES:
- FAILURE MODE
O - ON OR OPEN
C - OFF OR CLOSE
L - LAST COMMAND
 - WHERE FAILURE MODE IS INDICATED, THE INDICATED POSITION SHALL OCCUR ON FAILURE OF THE BCS CONTROLLER OR ITS OUTPUT FOR ANY REASON.
 - LOCATE OUTSIDE AIR TEMPERATURE SENSOR ON A NORTH FACING WALL OUT OF DIRECT SUNLIGHT.
 - FAN SHALL FAIL TO 50% SPEED.
 - PROVIDE SCR ELECTRIC HEAT CONTROL.

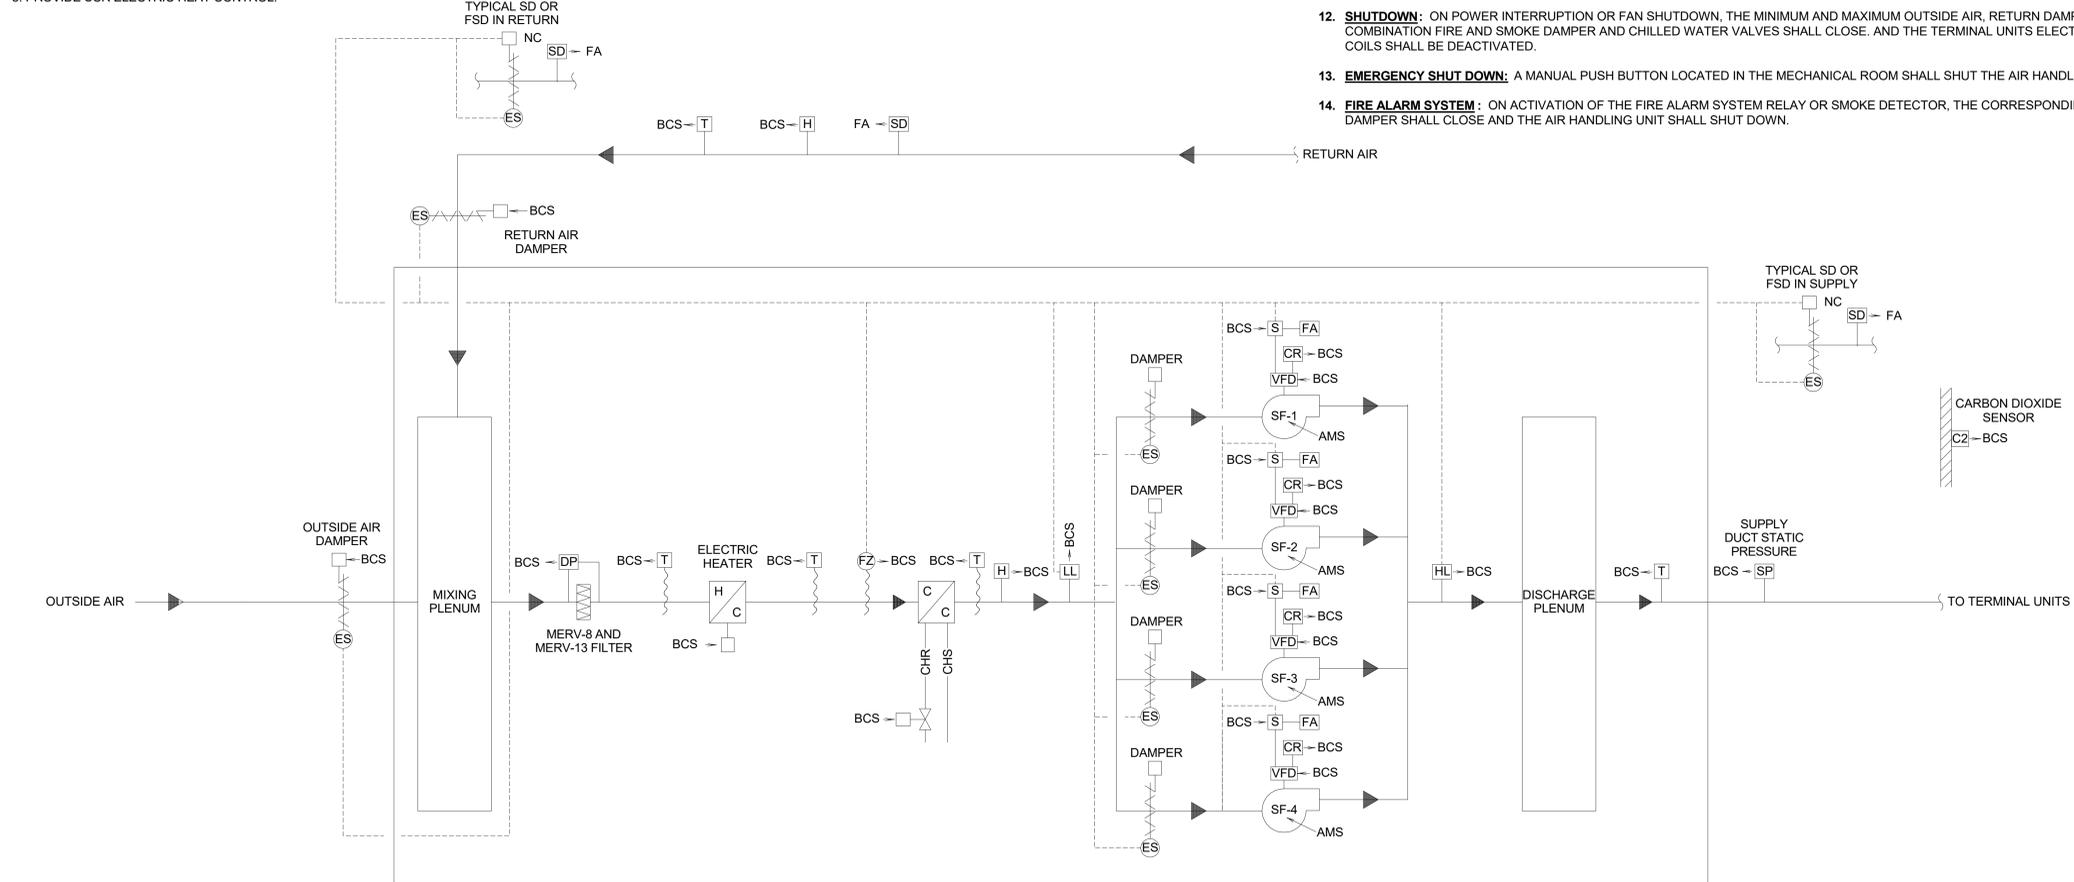

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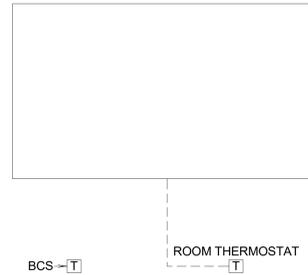
BCS PANEL INPUT/OUTPUT SUMMARY DUCTLESS SPLIT SYSTEM	OUTPUTS		INPUTS		SOFTWARE			NOTES
	DIGITAL	ANALOG	DIGITAL	ANALOG	ALARM	BCS	ENERGY MGMT.	
DUCTLESS SPLIT SYSTEM	X							
ROOM AIR INLET TEMPERATURE				X				

NOTES:
 1. FAILURE MODE
 O - ON OR OPEN
 C - OFF OR CLOSE
 L - LAST COMMAND
 2. WHERE FAILURE MODE IS INDICATED, THE INDICATED POSITION SHALL OCCUR ON FAILURE OF THE BCS CONTROLLER OR ITS OUTPUT FOR ANY REASON.
 3. FAN SHALL FAIL TO 50% SPEED.

SEQUENCE OF OPERATION:

THE CONTROLS FOR DUCTLESS SPLIT SYSTEMS SHALL FUNCTION AS FOLLOWS:

1. PROVIDE CONTROL WIRING BETWEEN WALL-MOUNTED THERMOSTATS, INDOOR FAN-COIL UNITS, AND OUTDOOR CONDENSING UNITS.
2. PROVIDE TEMPERATURE SENSOR IN ROOM TO MONITOR FROM BAS.



1 CONTROLS SCHEMATIC FOR DUCTLESS SPLIT SYSTEM **NTS**


BCS PANEL INPUT/OUTPUT SUMMARY ROOFTOP AIR CONDITIONING UNIT	OUTPUTS		INPUTS		SOFTWARE			NOTES
	DIGITAL	ANALOG	DIGITAL	ANALOG	ALARM	BCS	ENERGY MGMT.	
ROOFTOP AIR CONDITIONING UNIT	X							
SUPPLY FAN START/STOP	X							O
SUPPLY FAN STATUS			X					
RELIEF FAN START/STOP	X							O
RELIEF FAN STATUS			X					
BUILDING DIFFERENTIAL PRESSURE				X				
DISCHARGE AIR TEMPERATURE				X				
ROOM AIR INLET TEMPERATURE				X				
SPACE CARBON DIOXIDE LEVEL					X	X		

NOTES:
 1. FAILURE MODE
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 C - OFF OR CLOSE
 L - LAST COMMAND
 2. WHERE FAILURE MODE IS INDICATED, THE INDICATED POSITION SHALL OCCUR ON FAILURE OF THE BCS CONTROLLER OR ITS OUTPUT FOR ANY REASON.
 3. FAN SHALL FAIL TO 50% SPEED.

SEQUENCE OF OPERATION :

THE CONTROLS FOR ROOFTOP AIR CONDITIONING UNITS RTU-R-1 THROUGH RTU-R-4 SHALL EACH FUNCTION AS FOLLOWS:

1. THIS IS A STANDALONE PACKAGE UNIT. UNIT SHALL OPERATE PER MANUFACTURER'S PROGRAMMED CONTROL SEQUENCE.
2. INSTALL THE STATIC PRESSURE SENSOR IN THE DUCTWORK WHERE RECOMMENDED BY THE UNIT MANUFACTURER, AND CONNECT TO THE STATIC PRESSURE CONTROLLER IN THE UNIT.
3. INSTALL THE REMOTE READOUT PANEL AND CONNECTING WIRING.
4. INSTALL THE NIGHT SETBACK THERMOSTAT AND CONNECTING WIRING.
5. PROVIDE BACNET INTEGRATION CARD.
6. MODULATE THE OUTSIDE AIR TO MAINTAIN MINIMUM AIRFLOW AS MEASURED BY OUTSIDE AIR FLOW STATION. EVALUATE THE MINIMUM OUTSIDE AIR ON 5-MINUTE INTERVALS (ADJUSTABLE). ADJUST THE MINIMUM OUTSIDE AIRFLOW SETPOINT BETWEEN THE LOWER AND UPPER LIMITS IN 10% INCREMENTS EVERY 10 MINUTES. IF THE AVERAGE SPACE CARBON DIOXIDE CONCENTRATIONS ARE BELOW 800 PPM (ADJUSTABLE), REDUCE MINIMUM OUTSIDE AIRFLOW SETPOINT. IF THE AVERAGE SPACE CARBON DIOXIDE CONCENTRATIONS ARE ABOVE 900 PPM (ADJUSTABLE) INCREASE MINIMUM OUTSIDE AIRFLOW SETPOINT. IF ANY SPACE CARBON DIOXIDE CONCENTRATION IS ABOVE 1000 PPM FOR 5 MINUTES (ADJUSTABLE), INCREASE MINIMUM OUTSIDE AIRFLOW SETPOINT. IF ANY SPACE CARBON DIOXIDE CONCENTRATION IS ABOVE 1000 PPM FOR LONGER THAN 1 HOUR (ADJUSTABLE), INITIATE AN ALARM THROUGH THE BCS.
7. ON ACTIVATION OF THE FIRE ALARM SYSTEM RELAY OR SMOKE DETECTOR, THE CORRESPONDING FIRE SMOKE DAMPER SHALL CLOSE AND THE ROOFTOP AIR CONDITIONING UNIT SHALL SHUT DOWN.
8. RELIEF FAN TO MODULATE BUILDING PRESSURE SENSOR SETPOINT. INITIAL SETPOINT TO BE DETERMINED DURING TAB.

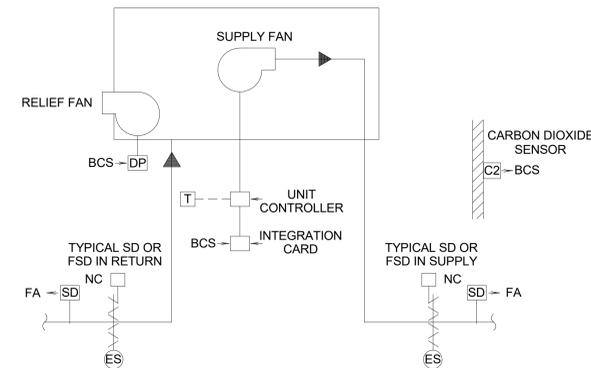

2 CONTROLS SCHEMATIC FOR ROOFTOP AIR CONDITIONING UNIT **NTS**



CAPE FEAR FD STONEWATER



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 CONSTRUCTION

NHC Government Center 7702-190810

NEW HANOVER COUNTY
GOVERNMENT CENTER
 GOVERNMENT CENTER DRIVE
 WILMINGTON, NC 28403
 LS3P PROJECT: 7702-190810

A	DATE	DESCRIPTION
A	2020.08.18	TI- SCHEMATIC DESIGN
B	2020.10.16	TI- DESIGN DEVELOPMENT
C	2020.12.16	GMP SET
E	2021.01.08	ADDENDUM #2

SHEET NAME:
 HVAC CONTROLS RTU
 & DUCTLESS SPLIT
 SYSTEM

DATE: 2020.12.16
CURRENT: 2021.01.08

ADDENDUM #2

SHEET:

M-704

GMP SET

Newcomb & Boyd
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 N&B PROJECT: 19N342
 Firm License No. F-0312

THE NEW HANOVER ARCHIVES
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B

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PLUMBING LEGEND

SYMBOLS

	SOIL (S) OR WASTE (W) ABOVE FLOOR OR GRADE
	SOIL (S) OR WASTE (W) BELOW FLOOR OR GRADE
	VENT (V)
	RAINWATER (RW) ABOVE FLOOR OR GRADE
	RAINWATER (RW) BELOW FLOOR OR GRADE
	OVERFLOW RAINWATER (ORW) ABOVE FLOOR OR GRADE
	OVERFLOW RAINWATER (ORW) BELOW FLOOR OR GRADE
	COLD WATER (CW)
	HOT WATER (HW)
	HOT WATER CIRCULATING (HWC)
	TRAP PRIMER (T)

	DRAIN
	ROOF DRAIN (RD)
	FLOOR CLEANOUT (FCO)
	GROUND CLEANOUT (GCO)
	CLEANOUT (CO)
	STRAINER
	UNION OR FLANGE
	HOSE BIB
	WALL HYDRANT
	PRESSURE REDUCING VALVE
	CHECK VALVE
	GLOBE VALVE
	AUTOMATIC OR MANUAL FLOW CONTROL FITTING
	BALANCING VALVE
	GAS PRESSURE REGULATOR
	GAS VALVE
	GATE VALVE OR BUTTERFLY VALVE
	GATE VALVE IN VERTICAL RISE
	BALL VALVE
	BALL VALVE IN VERTICAL RISE
	MIXING VALVE
	TEMPERATURE AND PRESSURE RELIEF VALVE
	PRESSURE RELIEF VALVE
	VACUUM BREAKER
	VACUUM RELIEF VALVE
	THERMOMETER
	PRESSURE GAUGE
	WATER HAMMER ARRESTER
	TRAP PRIMER
	TRAP PRIMER WITH DISTRIBUTION UNIT
	FLOW BALANCING ASSEMBLY
	FLOW METER
	WATER METER
	BACKFLOW PREVENTER
	PUMP

ABBREVIATIONS

AAV	AIR ADMITTANCE VALVE	SD	SHOWER DRAIN
ABV	ABOVE	SEC	SECURITY
AFF/AFG/ARF	ABOVE FINISHED FLOOR/GRADE/RAISED FLOOR	SHR	SHOWER
AP	ACCESS PANEL	SHT	SHEET
AR	ACID-RESISTING	SM	SHEET METAL
ARCH	ARCHITECT/ARCHITECTURAL	SPEC	SPECIFICATION
ARCO	ACID-RESISTING CLEANOUT	SS	SERVICE SINK
AS	ALLOY STEEL	SSTL	STAINLESS STEEL
ATTP (#)	AUTOMATIC TRAP PRIMER PANEL (# INDICATES THE NUMBER OF OUTLETS)	TD	TRENCH DRAIN
BEL	BELOW	TEMP	TEMPERATURE
BF	BELOW FLOOR	TP	TRAP PRIMER
CB	CATCH BASIN	TR	THROUGH ROOF
CI	CURB INLET	TS	TIGHT TO STRUCTURE
CLG	CEILING	UC	UNDERCOUNTER
COL	COLUMN	UG	UNDERGROUND
CONC	CONCRETE	UR	URINAL
CONN	CONNECT/CONNECTION	VB	VACUUM BREAKER
CONT	CONTINUATION/CONTINUOUS	VTR	VENT THROUGH ROOF
CSS	CLINICAL SERVICE SINK	WC	WATER CLOSET
CTE	CONNECT TO EXISTING	WG	WATER GAUGE
DI	DROPPED INLET	WM	WASHING MACHINE
DN	DOWN		
DS	DOWNSPOUT		
DW	DISHWASHER		
DWG	DRAWING		
ELE	ELEVATOR		
ELEC	ELECTRICAL/ELECTRIC		
EWC	ELECTRIC WATER COOLER		
EX	EXISTING		
EXP	EXPOSED		
FPWH	FREEZE PROOF WALL HYDRANT		
FD	FLOOR DRAIN		
FDN	FOUNDATION		
FS	FLOOR SINK		
FTG	FOOTING		
GR	GRADE		
HC	HANDICAPPED		
HD	HUB DRAIN		
IE	INVERT ELEVATION		
IM	ICE MACHINE/ICE MAKER		
LAV	LAVATORY		
MAP	MASTER ALARM PANEL (MEDICAL GAS)		
MECH	MECHANICAL		
MH	MANHOLE		
PDI	PLUMBING AND DRAINAGE INSTITUTE		
PL	PLANTER		
PS	PIPE STAND SUPPORT		
RD	ROOF DRAIN		
REL	RELOCATE		
REM	REMOVE		

GENERAL NOTES:

1. THE CONTRACTOR SHALL PROVIDE AND INSTALL ALL PLUMBING PIPING, FITTINGS, ACCESSORIES, AND EQUIPMENT, ETC. IN ACCORDANCE WITH THE FOLLOWING CONSTRUCTION DOCUMENT FLOOR PLANS.
2. THE PLUMBING CONTRACTOR SHALL COORDINATE PLUMBING TRADE WORK WITH THE GENERAL, ELECTRICAL, AND MECHANICAL CONTRACTORS PRIOR TO BEGINNING THE NEW WORK.
3. PLUMBING PIPING SHALL NOT BE ROUTED OVER ELECTRICAL OR TELECOM ROOMS UNLESS SHOWN ON THE PLUMBING FLOOR PLANS. WHERE PIPING IS SHOWN ROUTED ABOVE ELECTRICAL AND TELECOM ROOMS THE CONTRACTOR SHALL PROVIDE GALVANIZED STEEL, FIELD FABRICATED, SHEET METAL DRIP PANS WITH A DRAIN ROUTED TO A NEARBY FLOOR DRAIN AS INDICATED ON THE PLUMBING FLOOR PLANS.
4. ALL RAINWATER AND WASTE/SOIL STACKS SHALL BE INSTALLED WITH BASE OF STACK CLEANOUTS AT THE LOWEST LEVEL OF THE STACK PRIOR TO THE PIPING TRANSITIONING BELOW GROUND. INSTALL CLEANOUT 1'-6" ABOVE FINISHED GRADE.
5. FIXTURES UTILIZING QUICK CLOSING VALVES SUCH AS DRINKING FOUNTAINS, FLUSH VALVES, SENSOR FAUCETS, SHOWER FAUCETS, ETC., SHALL HAVE WATER HAMMER ARRESTORS INSTALLED ON THE COLD AND HOT WATER PIPING SERVING THE FIXTURE. WATER HAMMER ARRESTORS SHALL BE ENCLOSED PISTON TYPE WHICH HAVE NO MAINTANENCE REQUIREMENT. THEREOFRE AN ACCESS PANEL IS NOT REQUIRED FOR SERVICE. WATER HAMMER ARRESTORS ARE NOT SHOWN ON THE PLUMBING FLOOR PLANS FOR CLARITY. WATER HAMMER ARRESTORS SHALL NOT BE INSTALLED WITHIN CONSTRUCTION MASONRY UNIT WALLS. WHERE FIXTURES ARE INSTALLED ON CONSTRUCTION MASONRY UNIT WALLS, INSTALL THE WATER HAMMER ARRESTORS ABOVE THE CEILING PRIOR TO THE PIPING DROP WITHIN THE WALL TO SERVE THE FIXTURE. WATER HAMMER ARRESTORS SHALL BE INSTALLED IN AN UPRIGHT, VERTICAL POSITION.
6. AIR ADMITTANCE VALVES SHALL BE INSTALLED WHERE INDICATED ON THE PLUMBING FLOOR PLANS. VALVES SHALL BE INSTALLED PER THE MANUFACTURER'S INSTALLATION INSTRUCTIONS AND CONFORM TO ASSE 1050 & 1051.

Plumbing Legend

1/8" = 1'-0"



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NHC Government Center 7702-190810

NEW HANOVER COUNTY
GOVERNMENT CENTER
GOVERNMENT CENTER DRIVE
WILMINGTON, NC 28403
LS3P PROJECT: 7702-190810

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A	2020.08.18	TI- SCHEMATIC DESIGN
B	2020.10.16	TI- DESIGN DEVELOPMENT
C	2020.12.16	GMP SET
E	2021.01.08	ADDENDUM #2

SHEET NAME:
PLUMBING LEGEND

DATE: 2020.12.16
CURRENT: 2021.01.08
ADDENDUM #2

SHEET:
P-001

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N&B PROJECT: 19N342
Firm License No. F-0312

1/7/2021 2:35:01 PM

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GMP SET



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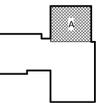
NEW HANOVER COUNTY GOVERNMENT CENTER

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WILMINGTON, NC 28403

LS3P PROJECT: 7702-190810

A	DATE	DESCRIPTION
A	2020.08.18	TI-SCHEMATIC DESIGN
B	2020.10.16	TI-DESIGN DEVELOPMENT
C	2020.12.16	GMP SET
D	2020.12.22	ADDENDUM #1
E	2021.01.08	ADDENDUM #2

KEY PLAN:



SHEET NAME:
PLUMBING PRESSURE
FLOOR PLAN - LEVEL 1
- AREA A

DATE: 2020.12.16
CURRENT: 2021.01.08

ADDENDUM #2


SHEET:

P-101A

GMP SET

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5425 Page Rd
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T 919 783-7812
Contact: Paul J. Kitchens
N&B PROJECT: 19N342
Firm License No. F-0312

KEYNOTES THIS SHEET:
① 0.5 GPM FBA

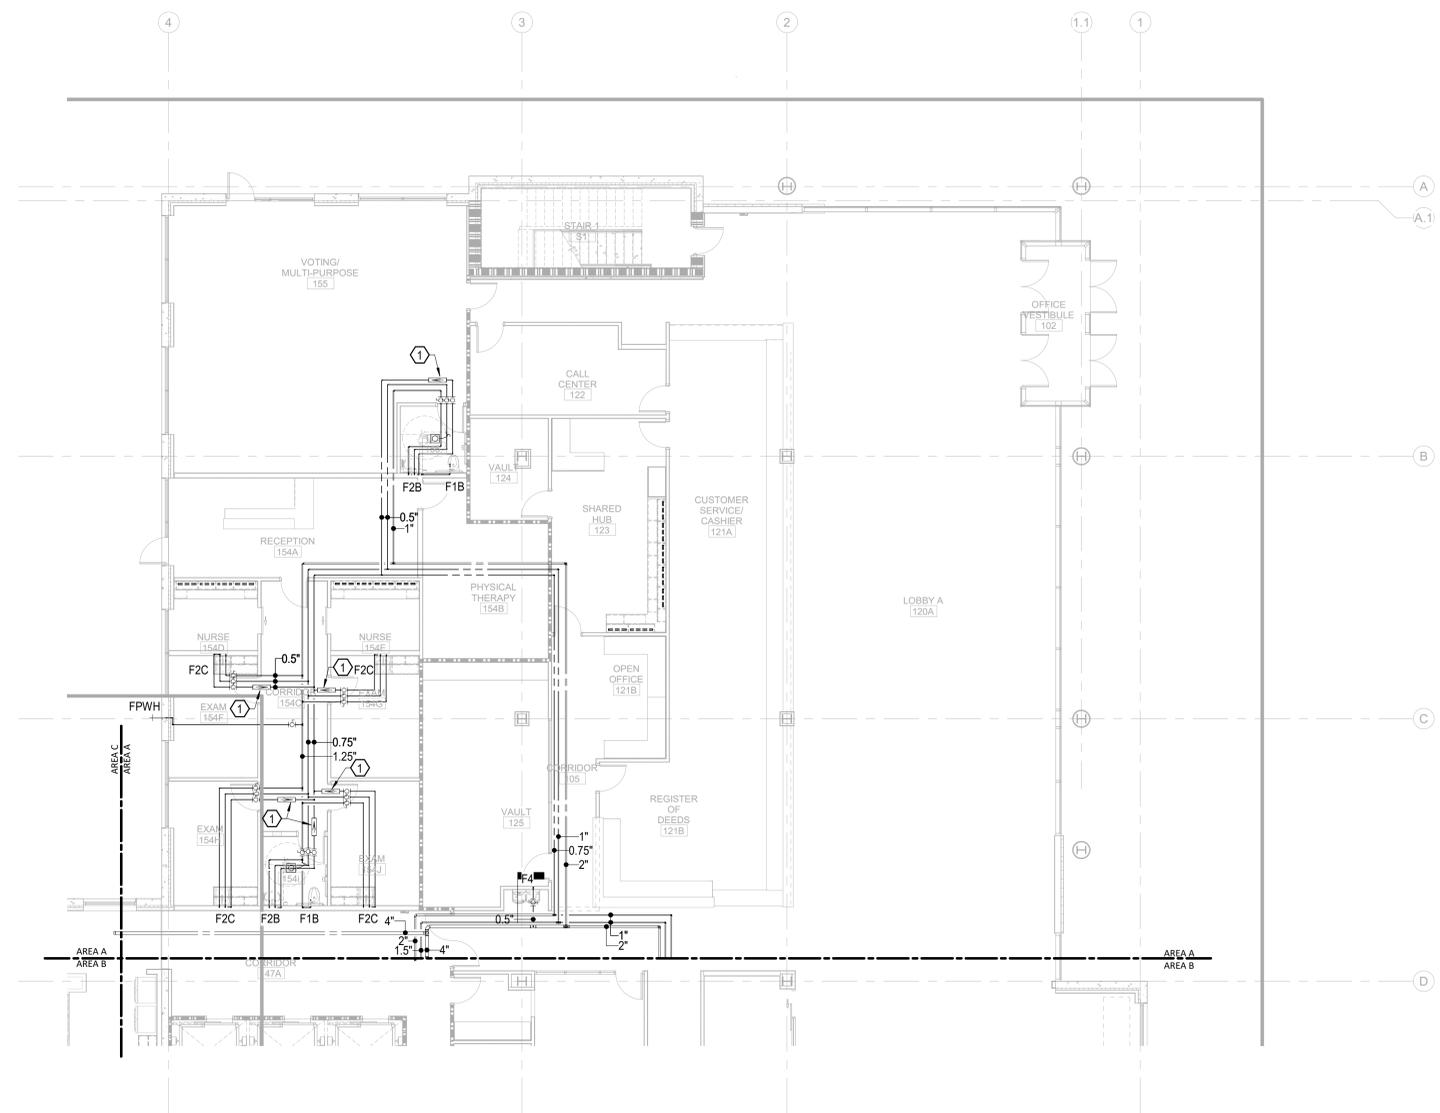

THE DATE SHOWN ABOVE IS
BASED ON THE INFORMATION
PROVIDED TO US BY THE
OWNER AND DOES NOT
NECESSARILY REPRESENT THE
DATE OF PLOTTING.

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P-101A
PLUMBING PRESSURE TI FLOOR PLAN - PARTIAL - LEVEL 1 - AREA A

1/8" = 1'-0"

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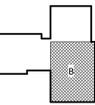
NHC Government Center 7702-190810

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LS3P PROJECT: 7702-190810

DATE	DESCRIPTION
A 2020.08.18	TI- SCHEMATIC DESIGN
B 2020.10.16	TI- DESIGN DEVELOPMENT
C 2020.12.16	GMP SET
D 2020.12.22	ADDENDUM #1
E 2021.01.08	ADDENDUM #2

KEY PLAN:



SHEET NAME:
PLUMBING PRESSURE
FLOOR PLAN - LEVEL 1
- AREA B

DATE: 2020.12.16
CURRENT: 2021.01.08

ADDENDUM #2


SHEET:

P-101B

GMP SET

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CONSULTANTS AND ENGINEERS
Consulting Engineering Group
5425 Page Rd
Suite 215
Durham, NC 27703
T 919 783-7812
Contact: Paul J. Kitchens
N&B PROJECT: 19N342
Firm License No. F-0312

- KEYNOTES THIS SHEET:
- ① 0.5 GPM FBA
 - ② EXTEND CW UC TO ICE MAKER FROM CW SUPPLY TO SINK. SEE DETAIL 1/P-802.
 - ③ 0.5" CW TO MECHANICAL EQUIPMENT. COORDINATE FINAL LOCATION WITH MECHANICAL CONTRACTOR PRIOR TO INSTALLATION.
 - ④ 1" CW, HW, & 0.5" HWC DN TO BEL FL. ROUTE TO BEL COUNTER AND RACK PIPING VERTICALLY ON CASEWORK TO SERVE SINKS IN HUB KITCHEN 152.
 - ⑤ 4" CW SERVICE FROM CIVIL. I.E. 3'-0" BEL FF.
 - ⑥ 4" CW, 1.25" HW, & 2" HWC UP.
 - ⑦ 4" CW UP.

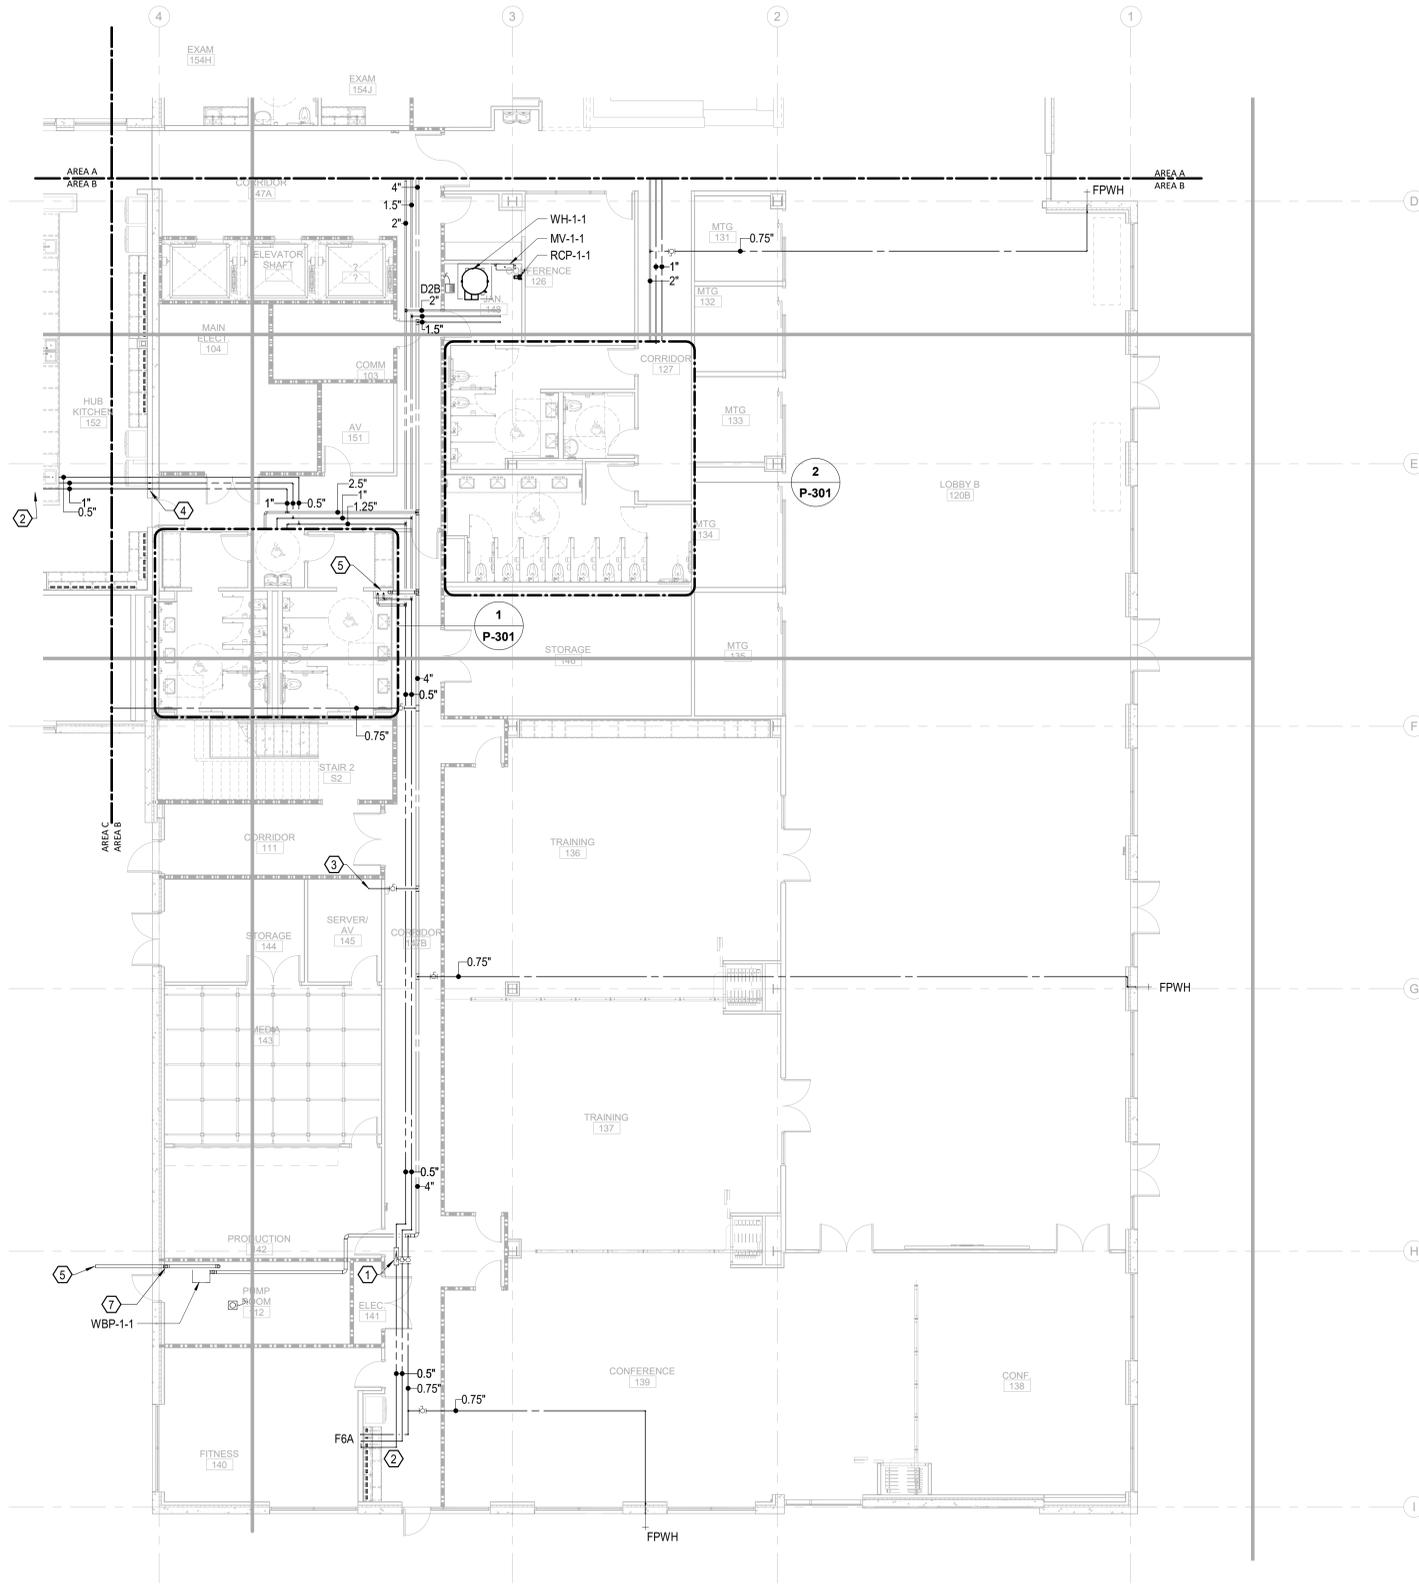

1
P-101B PLUMBING PRESSURE TI FLOOR PLAN - PARTIAL - LEVEL 1 - AREA B

1/8" = 1'-0"

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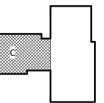
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GOVERNMENT CENTER**
GOVERNMENT CENTER DRIVE
WILMINGTON, NC 28403

LS3P PROJECT: 7702-190810

A	DATE	DESCRIPTION
A	2020.08.18	TI-SCHEMATIC DESIGN
B	2020.10.16	TI-DESIGN DEVELOPMENT
C	2020.12.16	GMP SET
D	2020.12.22	ADDENDUM #1
E	2021.01.08	ADDENDUM #2

KEY PLAN:



SHEET NAME:
**PLUMBING PRESSURE
FLOOR PLAN - LEVEL 1
- AREA C**


DATE: 2020.12.16
CURRENT: 2021.01.08

ADDENDUM #2

SHEET:
P-101C


GMP SET

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T 919 783-7812
Contact: Paul J. Kitchens
N&B PROJECT: 19N342
Firm License No. F-0312

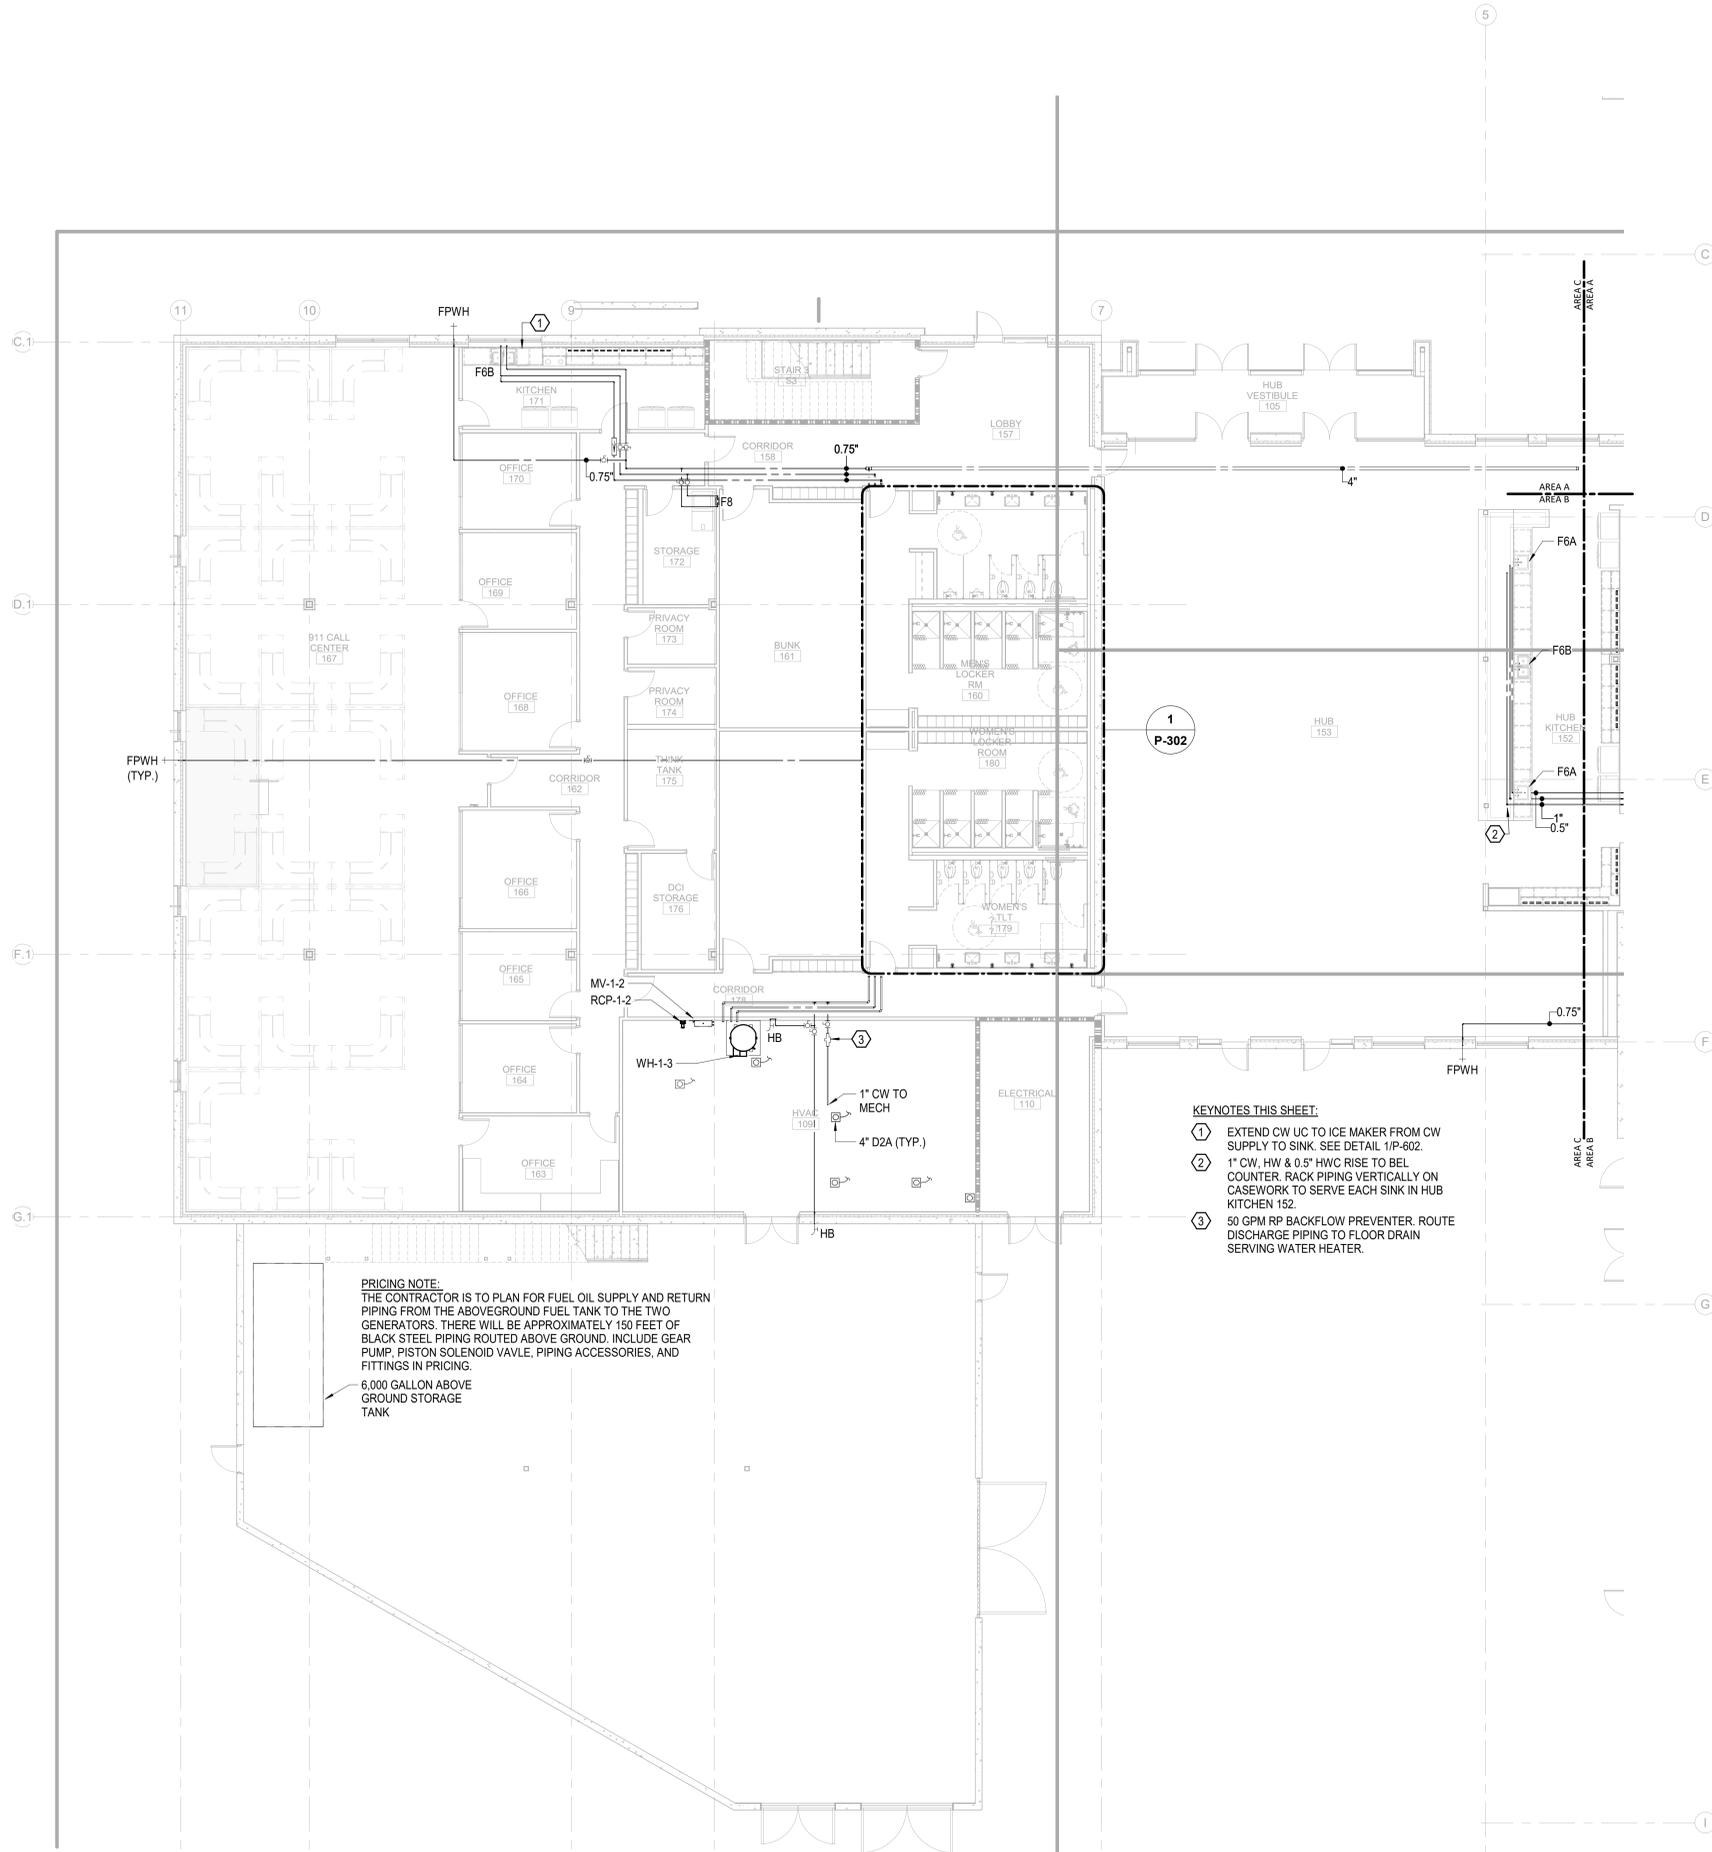

- KEYNOTES THIS SHEET:**
- ① EXTEND CW UC TO ICE MAKER FROM CW SUPPLY TO SINK. SEE DETAIL 1/P-602.
 - ② 1" CW, HW & 0.5" HWC RISE TO BEL COUNTER. RACK PIPING VERTICALLY ON CASEWORK TO SERVE EACH SINK IN HUB KITCHEN 152.
 - ③ 50 GPM RP BACKFLOW PREVENTER. ROUTE DISCHARGE PIPING TO FLOOR DRAIN SERVING WATER HEATER.

PRICING NOTE:
THE CONTRACTOR IS TO PLAN FOR FUEL OIL SUPPLY AND RETURN PIPING FROM THE ABOVEGROUND FUEL TANK TO THE TWO GENERATORS. THERE WILL BE APPROXIMATELY 150 FEET OF BLACK STEEL PIPING ROUTED ABOVE GROUND. INCLUDE GEAR PUMP, PISTON SOLENOID VALVE, PIPING ACCESSORIES, AND FITTINGS IN PRICING.
6,000 GALLON ABOVE GROUND STORAGE TANK

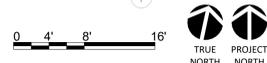

1/7/2021 2:35:55 PM
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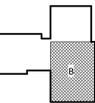
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GOVERNMENT CENTER DRIVE
WILMINGTON, NC 28403

LS3P PROJECT: 7702-190810

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A	2020.08.18	TI-SCHEMATIC DESIGN
B	2020.10.16	TI-DESIGN DEVELOPMENT
C	2020.12.16	GMP SET
D	2020.12.22	ADDENDUM #1
E	2021.01.08	ADDENDUM #2

KEY PLAN:



SHEET NAME:
PLUMBING PRESSURE
FLOOR PLAN - LEVEL 2
- AREA B

DATE: 2020.12.16
CURRENT: 2021.01.08

ADDENDUM #2

SHEET:


P-102B

GMP SET

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T 919 783-7812
Contact: Paul J. Kitchens
N&B PROJECT: 19N342
Firm License No. F-0312

KEYNOTES THIS SHEET:

- ① 0.5 GPM FBA
- ② EXTEND CW UC TO ICE MAKER FROM CW SUPPLY TO SINK. SEE DETAIL 1/P-602.

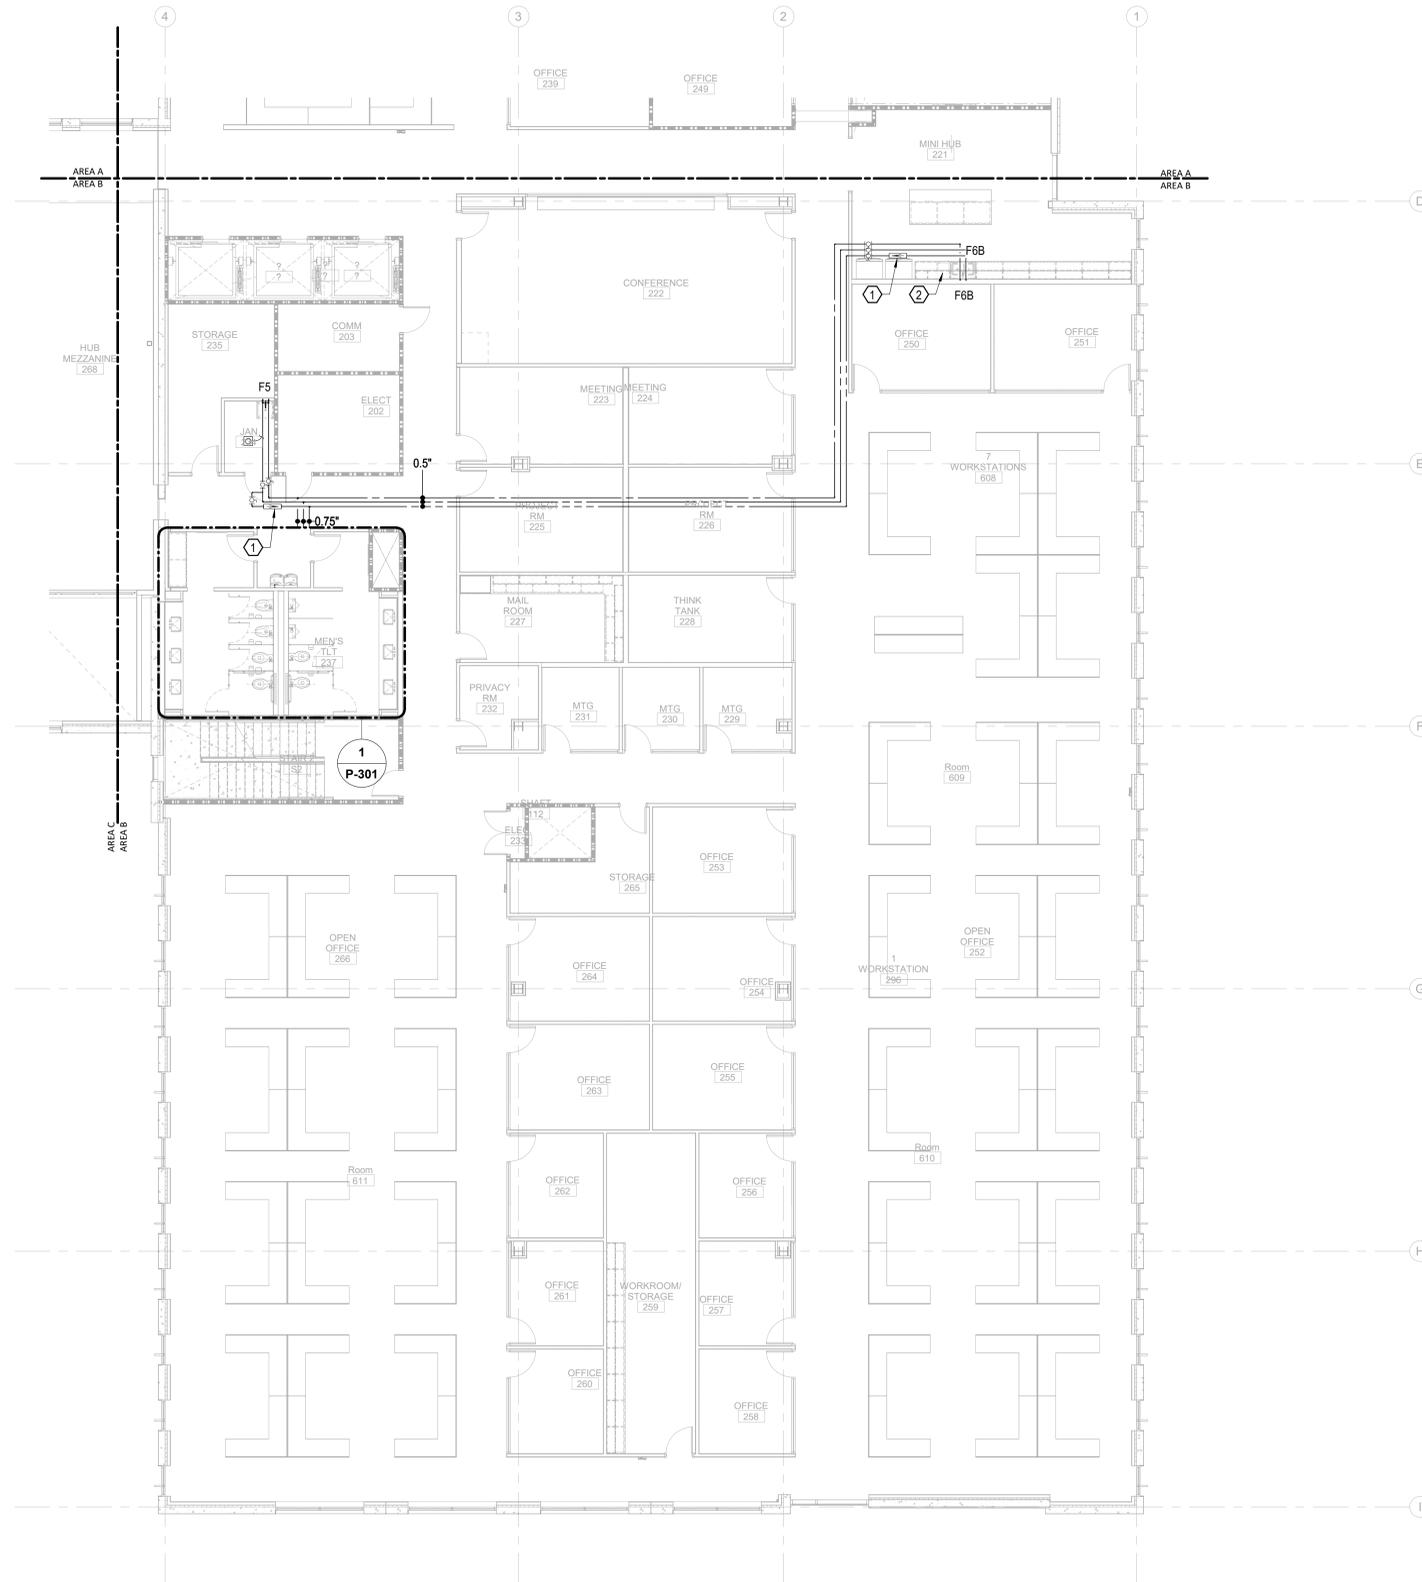

THE NEW HANOVER COUNTY, N.C. PLUMBING PRESSURE FLOOR PLAN IS THE PROPERTY OF LS3P.

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1/7/2021 2:38:45 PM
1
P-102B

PLUMBING PRESSURE TI FLOOR PLAN - PARTIAL - LEVEL 2 - AREA B

1/8" = 1'-0"

1 2 3 4 5 6



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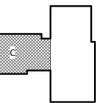
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LS3P PROJECT: 7702-190810

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C	2020.12.16	GMP SET
D	2020.12.22	ADDENDUM #1
E	2021.01.08	ADDENDUM #2

KEY PLAN:



SHEET NAME:
PLUMBING PRESSURE
FLOOR PLAN - LEVEL 2
- AREA C

DATE: 2020.12.16
CURRENT: 2021.01.08



ADDENDUM #2

SHEET:

P-102C

GMP SET

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N&B PROJECT: 19N342
Firm License No. F-0312

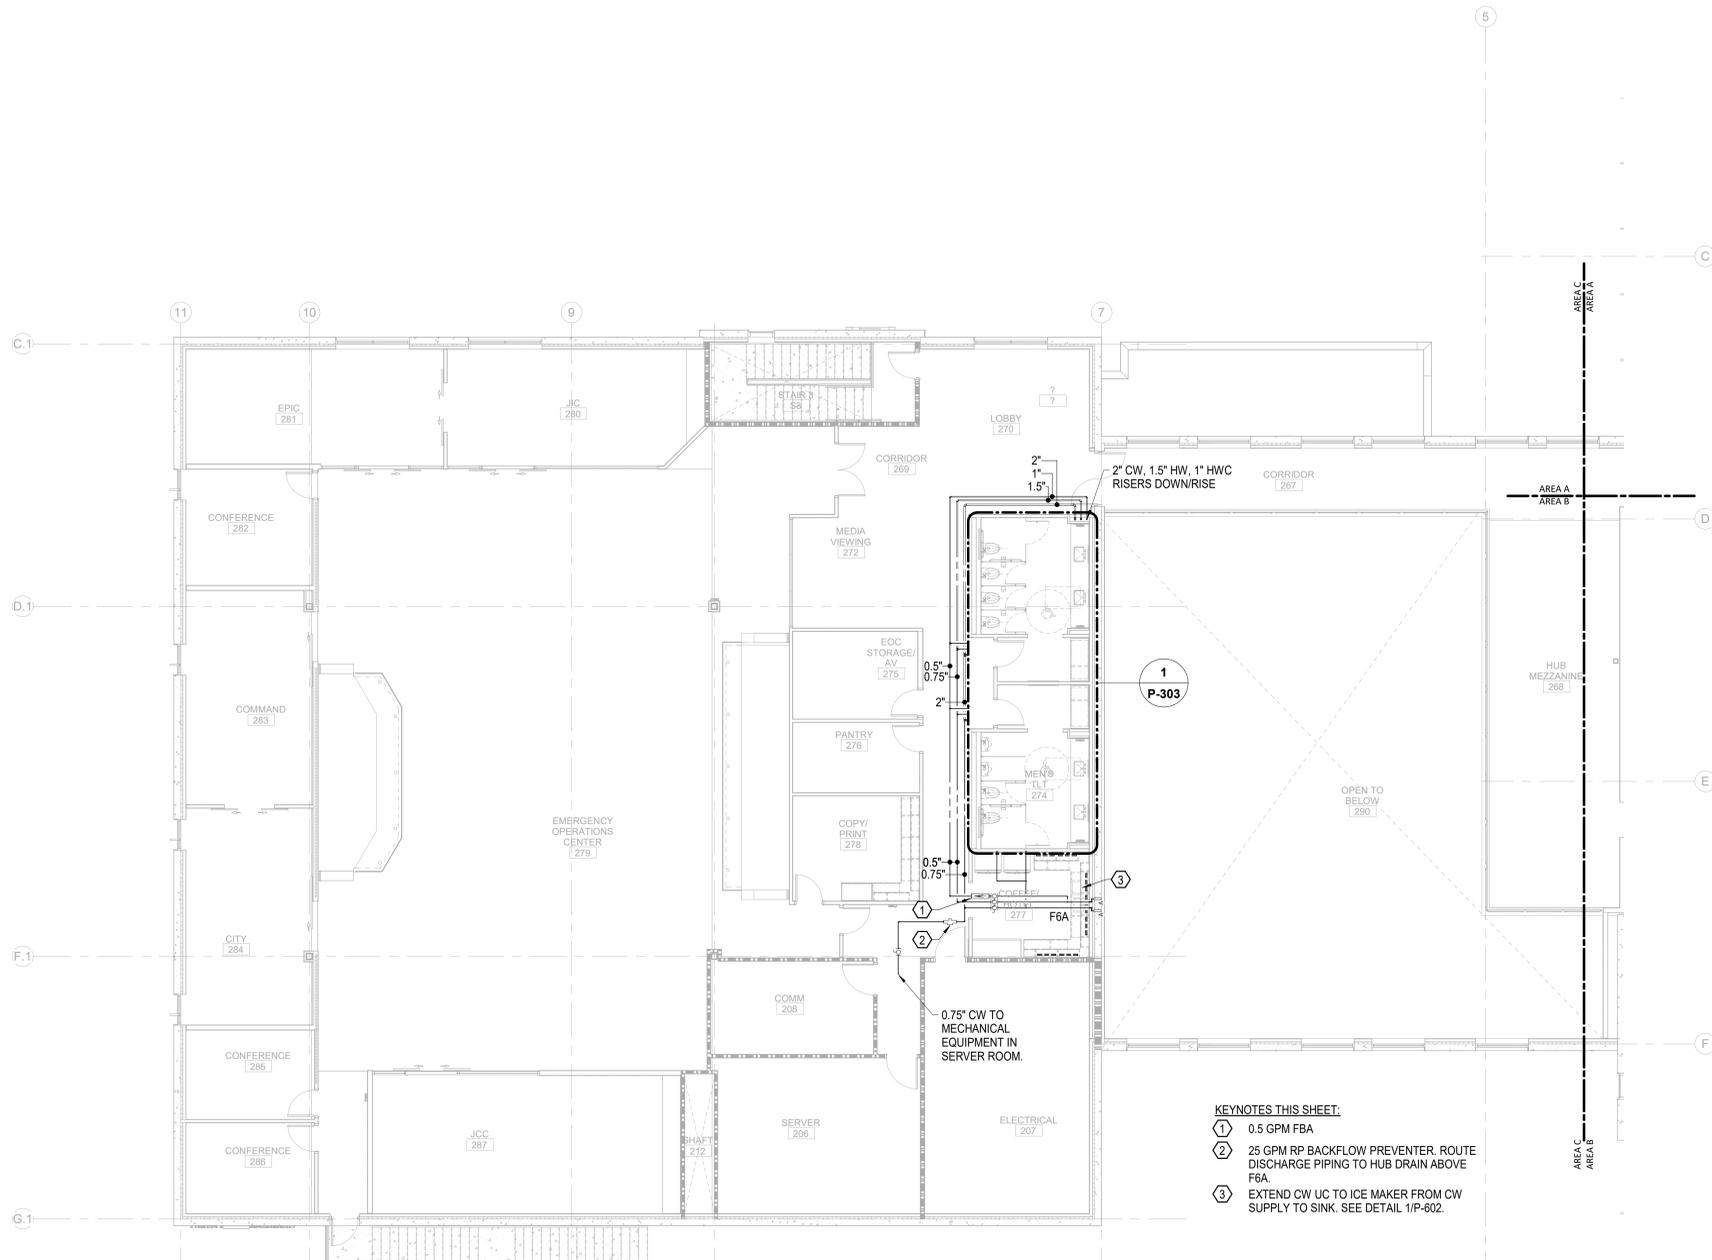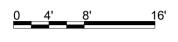

KEYNOTES THIS SHEET:

- ① 0.5 GPM FBA
- ② 25 GPM RP BACKFLOW PREVENTER. ROUTE DISCHARGE PIPING TO HUB DRAIN ABOVE F6A.
- ③ EXTEND CW UC TO ICE MAKER FROM CW SUPPLY TO SINK. SEE DETAIL 1/P-802.

1/7/2021 2:35:53 PM
THE USER ASSUMES ALL RESPONSIBILITY FOR THE ACCURACY OF THE INFORMATION SHOWN ON THIS DRAWING.
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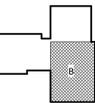
NEW HANOVER COUNTY GOVERNMENT CENTER

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LS3P PROJECT: 7702-190810

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C	2020.12.16	GMP SET
D	2020.12.22	ADDENDUM #1
E	2021.01.08	ADDENDUM #2

KEY PLAN:



SHEET NAME:
PLUMBING PRESSURE
FLOOR PLAN - LEVEL 3
- AREA B

DATE: 2020.12.16
CURRENT: 2021.01.08

ADDENDUM #2

SHEET:

P-103B


GMP SET

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T 919 783-7812
Contact: Paul J. Kitchens
N&B PROJECT: 19N342
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- KEYNOTES THIS SHEET:
- ① 0.5 GPM FBA
 - ② EXTEND CW UC TO ICE MAKER FROM CW SUPPLY TO SINK. SEE DETAIL 1/P-602.



1/8" = 1'-0"

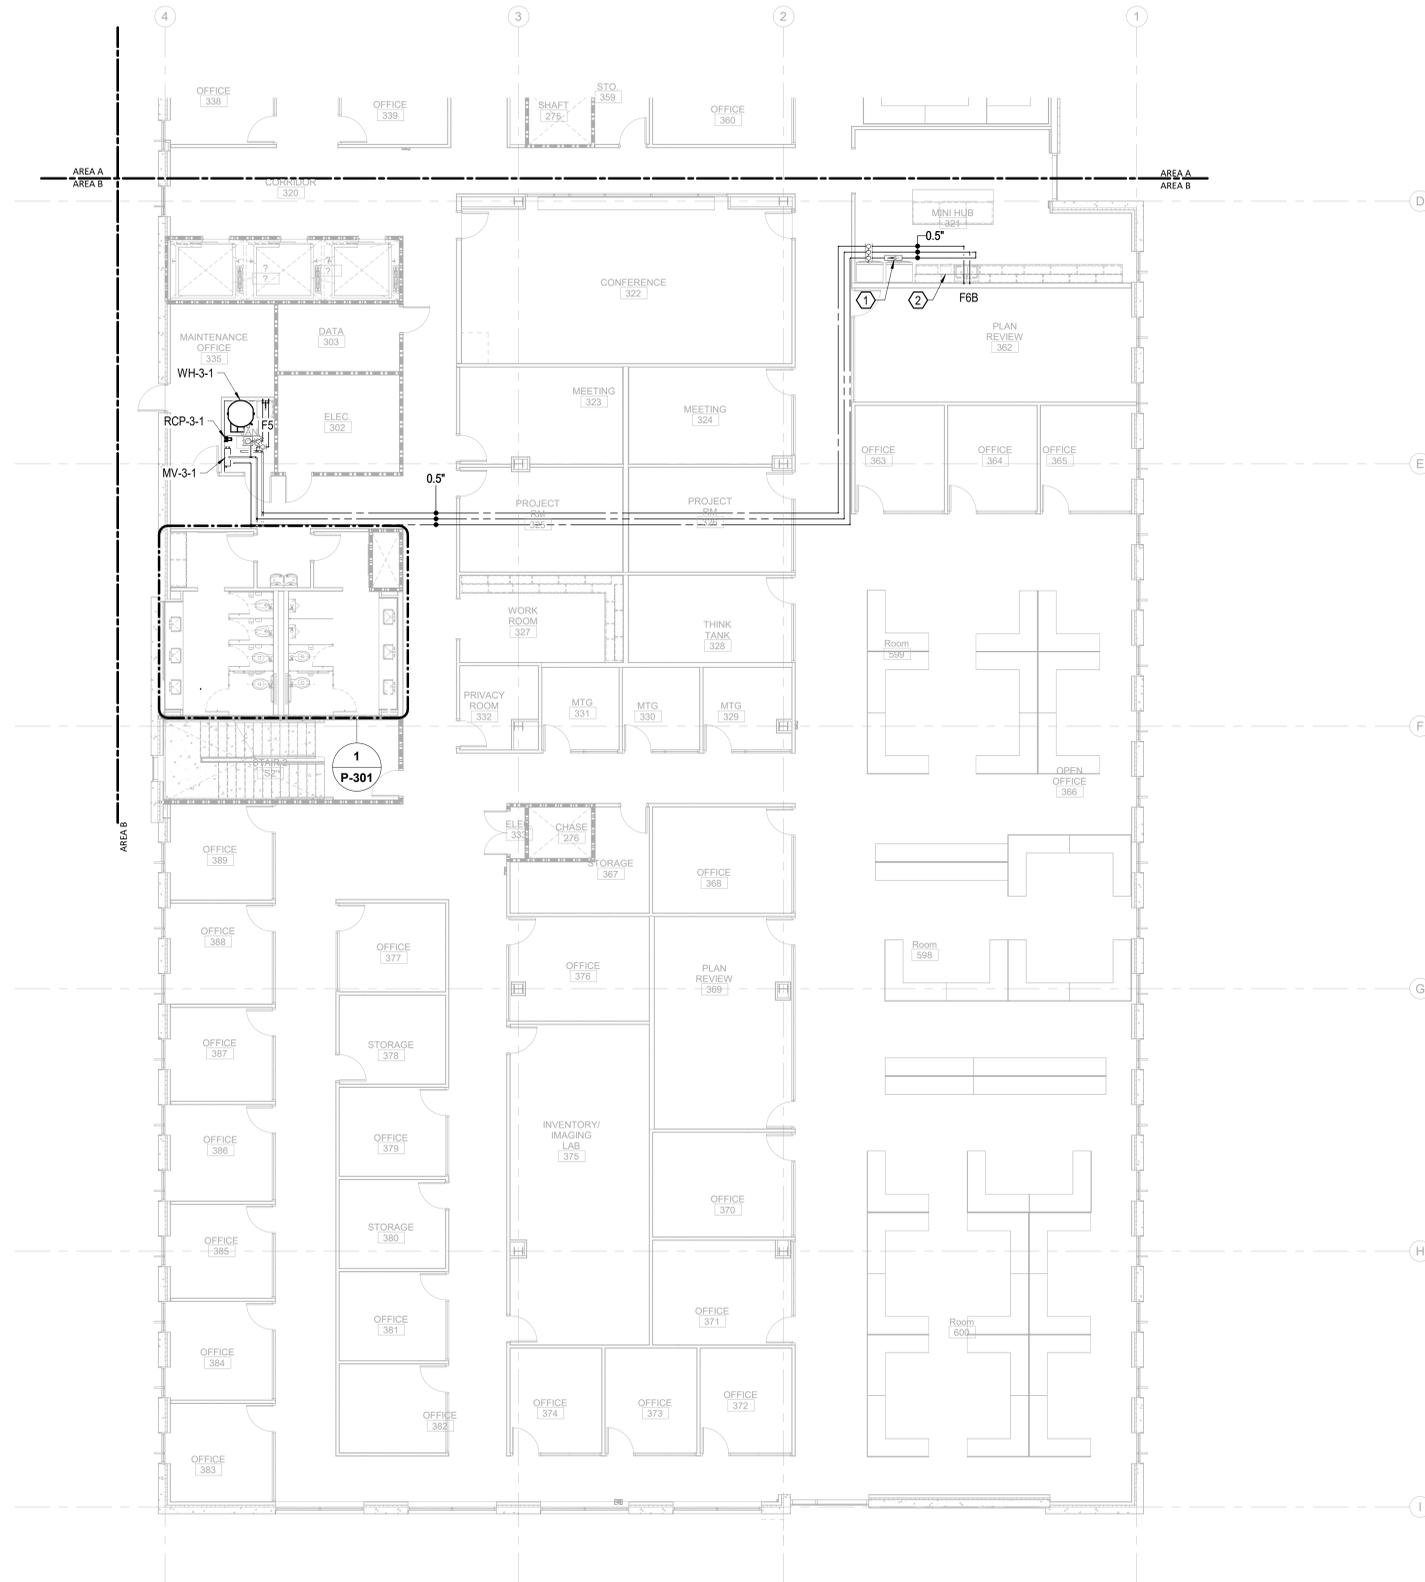

THE NEW HANOVER COUNTY BOARD OF COMMISSIONERS HAS REVIEWED AND APPROVED THIS PLAN FOR CONSTRUCTION.

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1/7/2021 2:36:04 PM
1
P-103B

PLUMBING PRESSURE TI FLOOR PLAN - PARTIAL - LEVEL 3 - AREA B

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CONSTRUCTION

NHC Government Center 7702-190810


NEW HANOVER COUNTY GOVERNMENT CENTER

GOVERNMENT CENTER DRIVE
WILMINGTON, NC 28403

LS3P PROJECT: 7702-190810

A	DATE	DESCRIPTION
A	2020.08.18	TI- SCHEMATIC DESIGN
B	2020.10.16	TI- DESIGN DEVELOPMENT
C	2020.12.16	GMP SET
D	2020.12.22	ADDENDUM #1
E	2021.01.08	ADDENDUM #2

KEY PLAN:

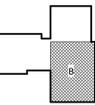

SHEET NAME:
PLUMBING PRESSURE
FLOOR PLAN - LEVEL 4
- AREA B

DATE: 2020.12.16
CURRENT: 2021.01.08

ADDENDUM #2

SHEET:

P-104B


GMP SET

Newcomb & Boyd
CONSULTANTS AND ENGINEERS
Consulting Engineering Group
5425 Page Rd
Suite 215
Durham, NC 27703
T 919 783-7812
Contact: Paul J. Kitchens
N&B PROJECT: 19N342
Firm License No. F-0312

- KEYNOTES THIS SHEET:
- ① 0.5 GPM FBA
 - ② EXTEND CW UC TO ICE MAKER FROM CW SUPPLY TO SINK. SEE DETAIL 1/P-602.
 - ③ 0.75" CW UP TO ROOF HYDRANT.



1/8" = 1'-0"

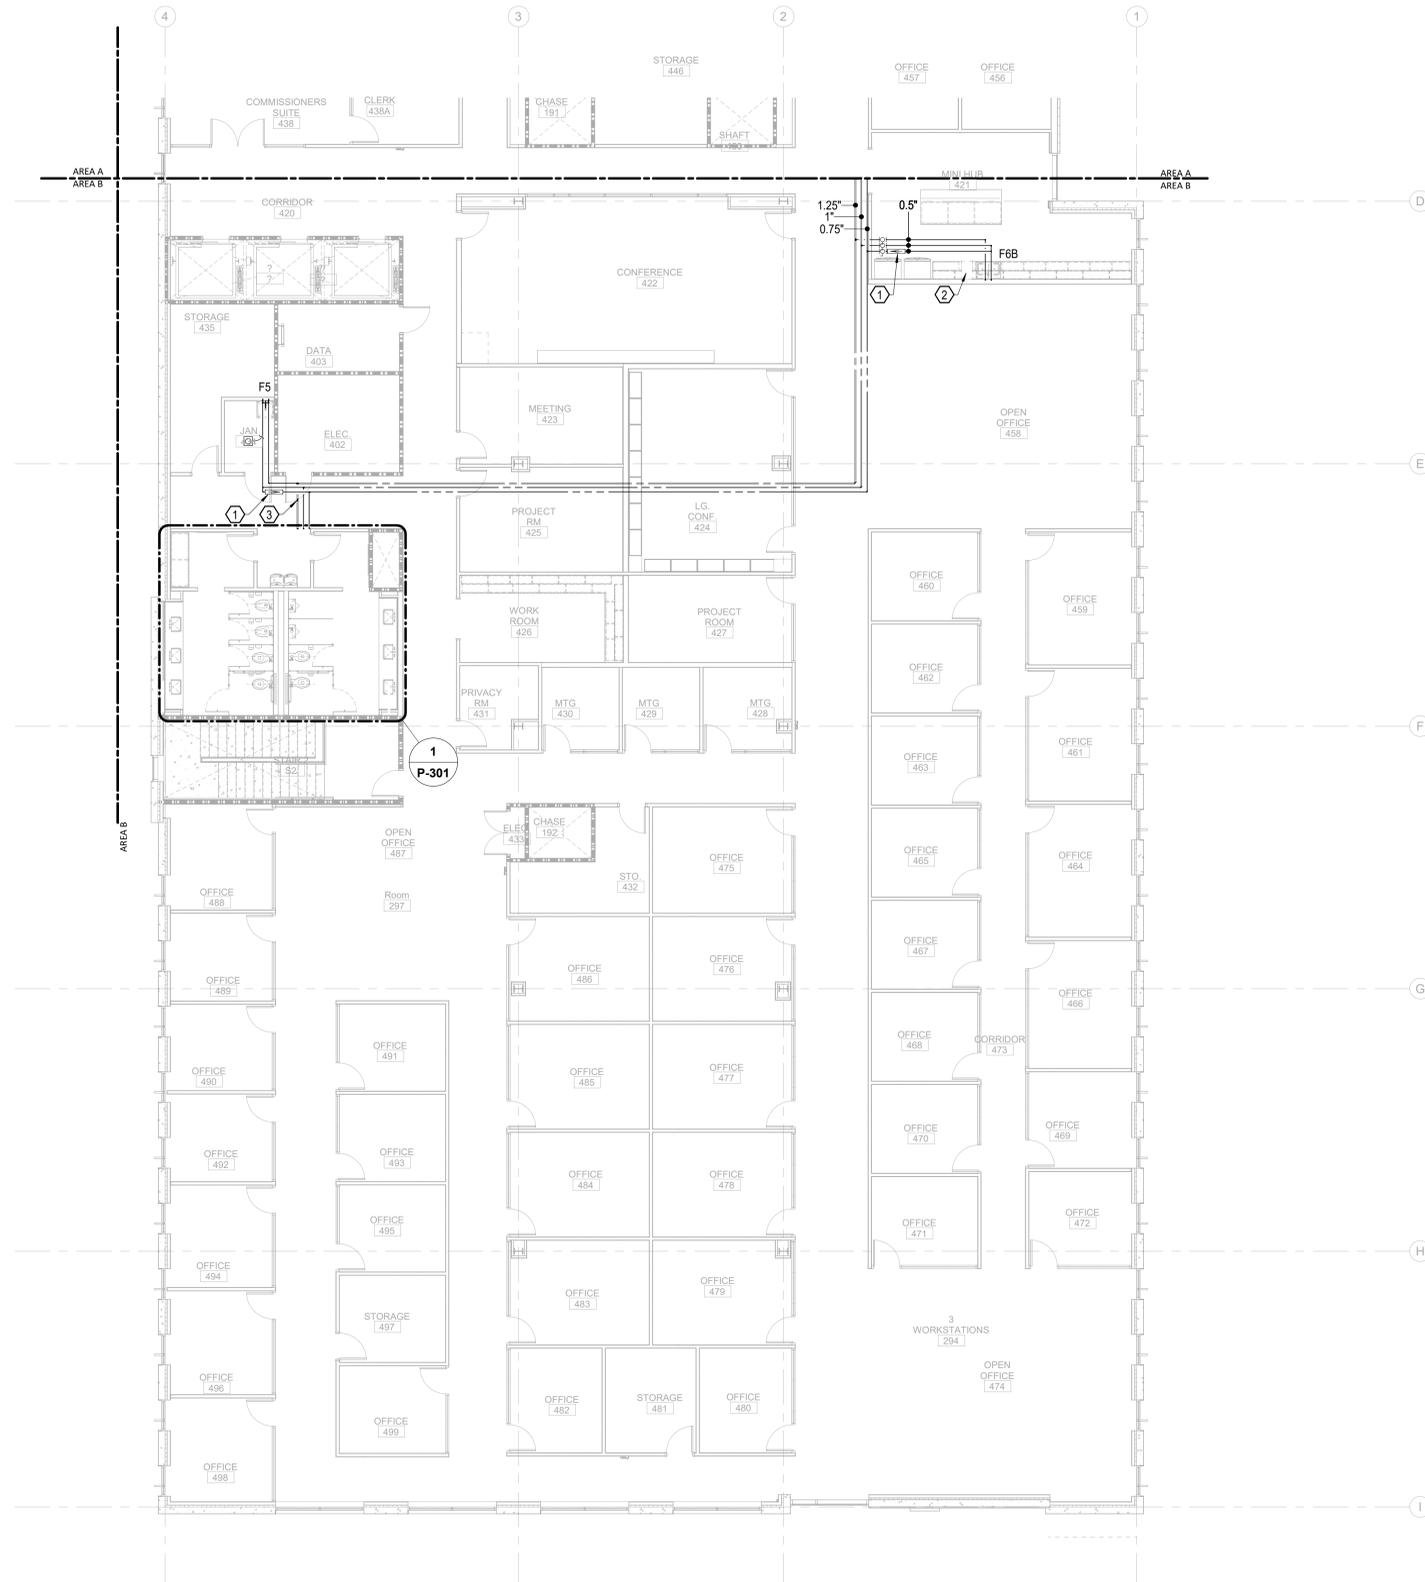

THE USER ASSUMES ALL RESPONSIBILITY FOR THE ACCURACY OF THE INFORMATION SHOWN ON THIS DRAWING.

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P-104B

PLUMBING PRESSURE TI FLOOR PLAN - PARTIAL - LEVEL 4 - AREA B

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CAPE FEAR FD STONEWATER



101 NORTH THIRD STREET, SUITE 500
WILMINGTON, NORTH CAROLINA 28401
TEL. 910.790.3111 FAX. 910.790.9901
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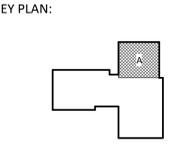
NOT FOR
CONSTRUCTION

NHC Government Center 7702-190810

NEW HANOVER COUNTY GOVERNMENT CENTER GOVERNMENT CENTER DRIVE WILMINGTON, NC 28403

LS3P PROJECT: 7702-190810

DATE	DESCRIPTION
A 2020.08.18	TI-SCHEMATIC DESIGN
B 2020.10.16	TI-DESIGN DEVELOPMENT
C 2020.12.16	GMP SET
E 2021.01.08	ADDENDUM #2





SHEET NAME:
PLUMBING WASTE
FLOOR PLAN - LEVEL 1
- AREA A

DATE: 2020.12.16
CURRENT: 2021.01.08
ADDENDUM #2

SHEET:
P-201A

GMP SET

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Consulting Engineering Group
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Contact: Paul J. Kitchens
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Firm License No. F-0312

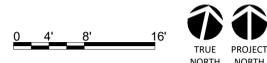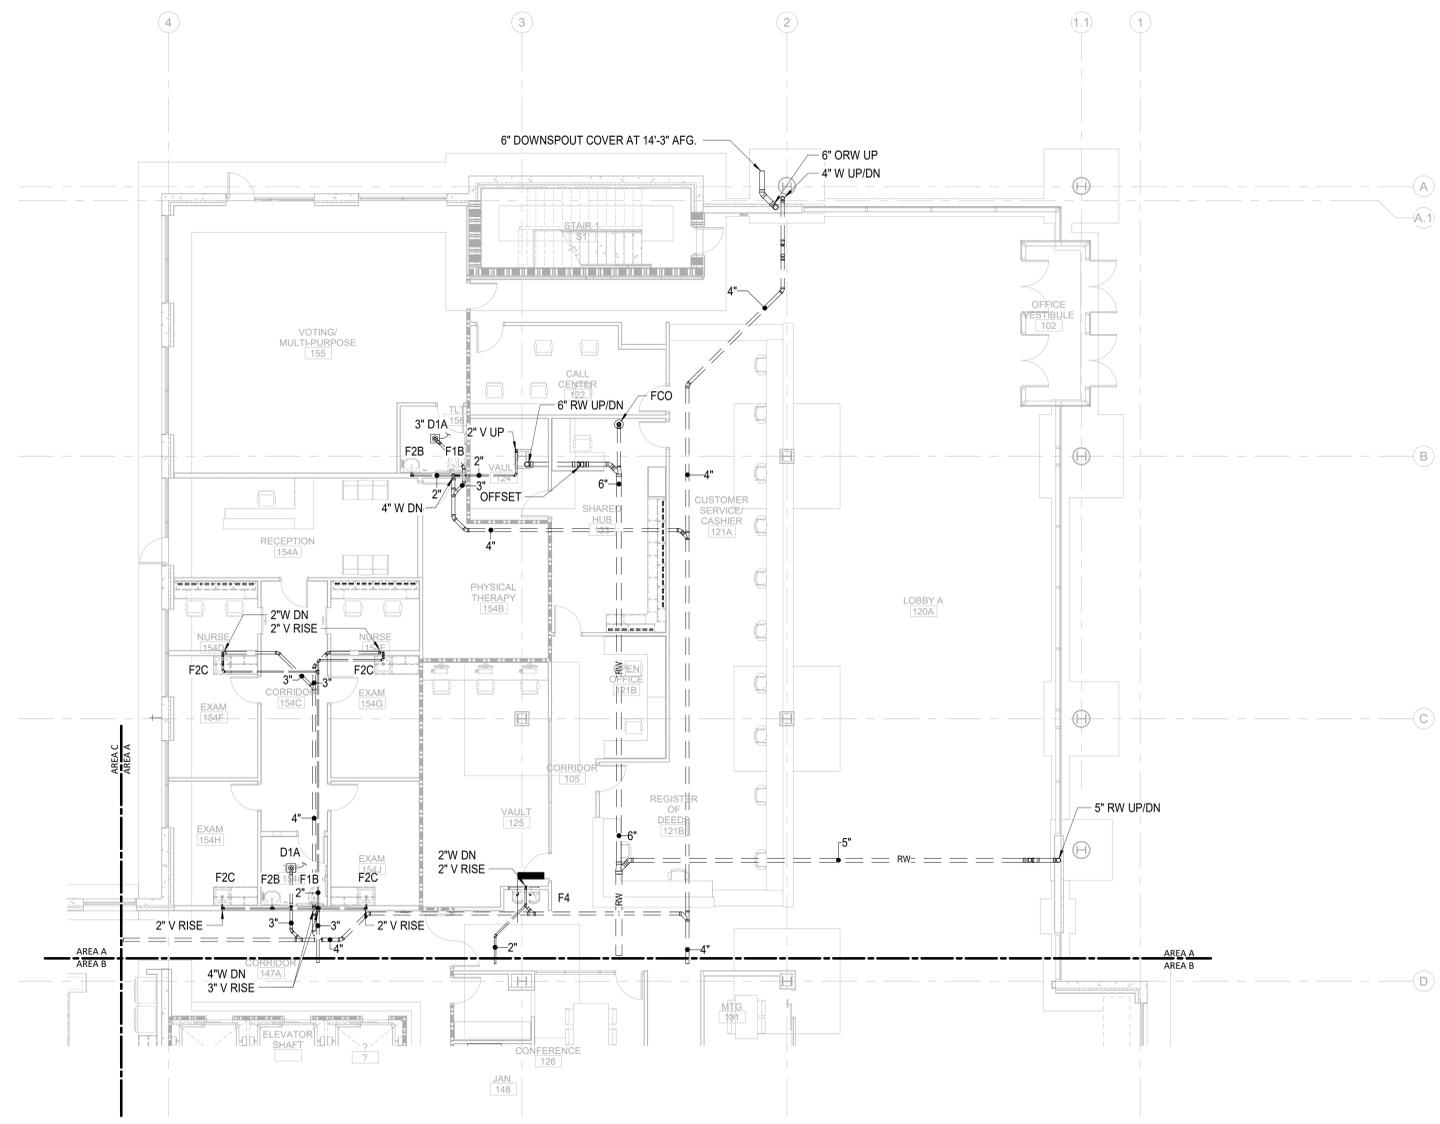

1/8" = 1'-0"

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P-201A
PLUMBING WASTE TI FLOOR PLAN - PARTIAL - LEVEL 1 - AREA A

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CONSTRUCTION


NHC Government Center 7702-190810

NEW HANOVER COUNTY GOVERNMENT CENTER GOVERNMENT CENTER DRIVE WILMINGTON, NC 28403

LS3P PROJECT: 7702-190810

A	DATE	DESCRIPTION
A	2020.08.18	TI-SCHEMATIC DESIGN
B	2020.10.16	TI-DESIGN DEVELOPMENT
C	2020.12.16	GMP SET
E	2021.01.08	ADDENDUM #2

KEY PLAN:

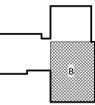


SHEET NAME:
PLUMBING WASTE
FLOOR PLAN - LEVEL 1
- AREA B

DATE: 2020.12.16
CURRENT: 2021.01.08

ADDENDUM #2

SHEET:
P-201B

GMP SET

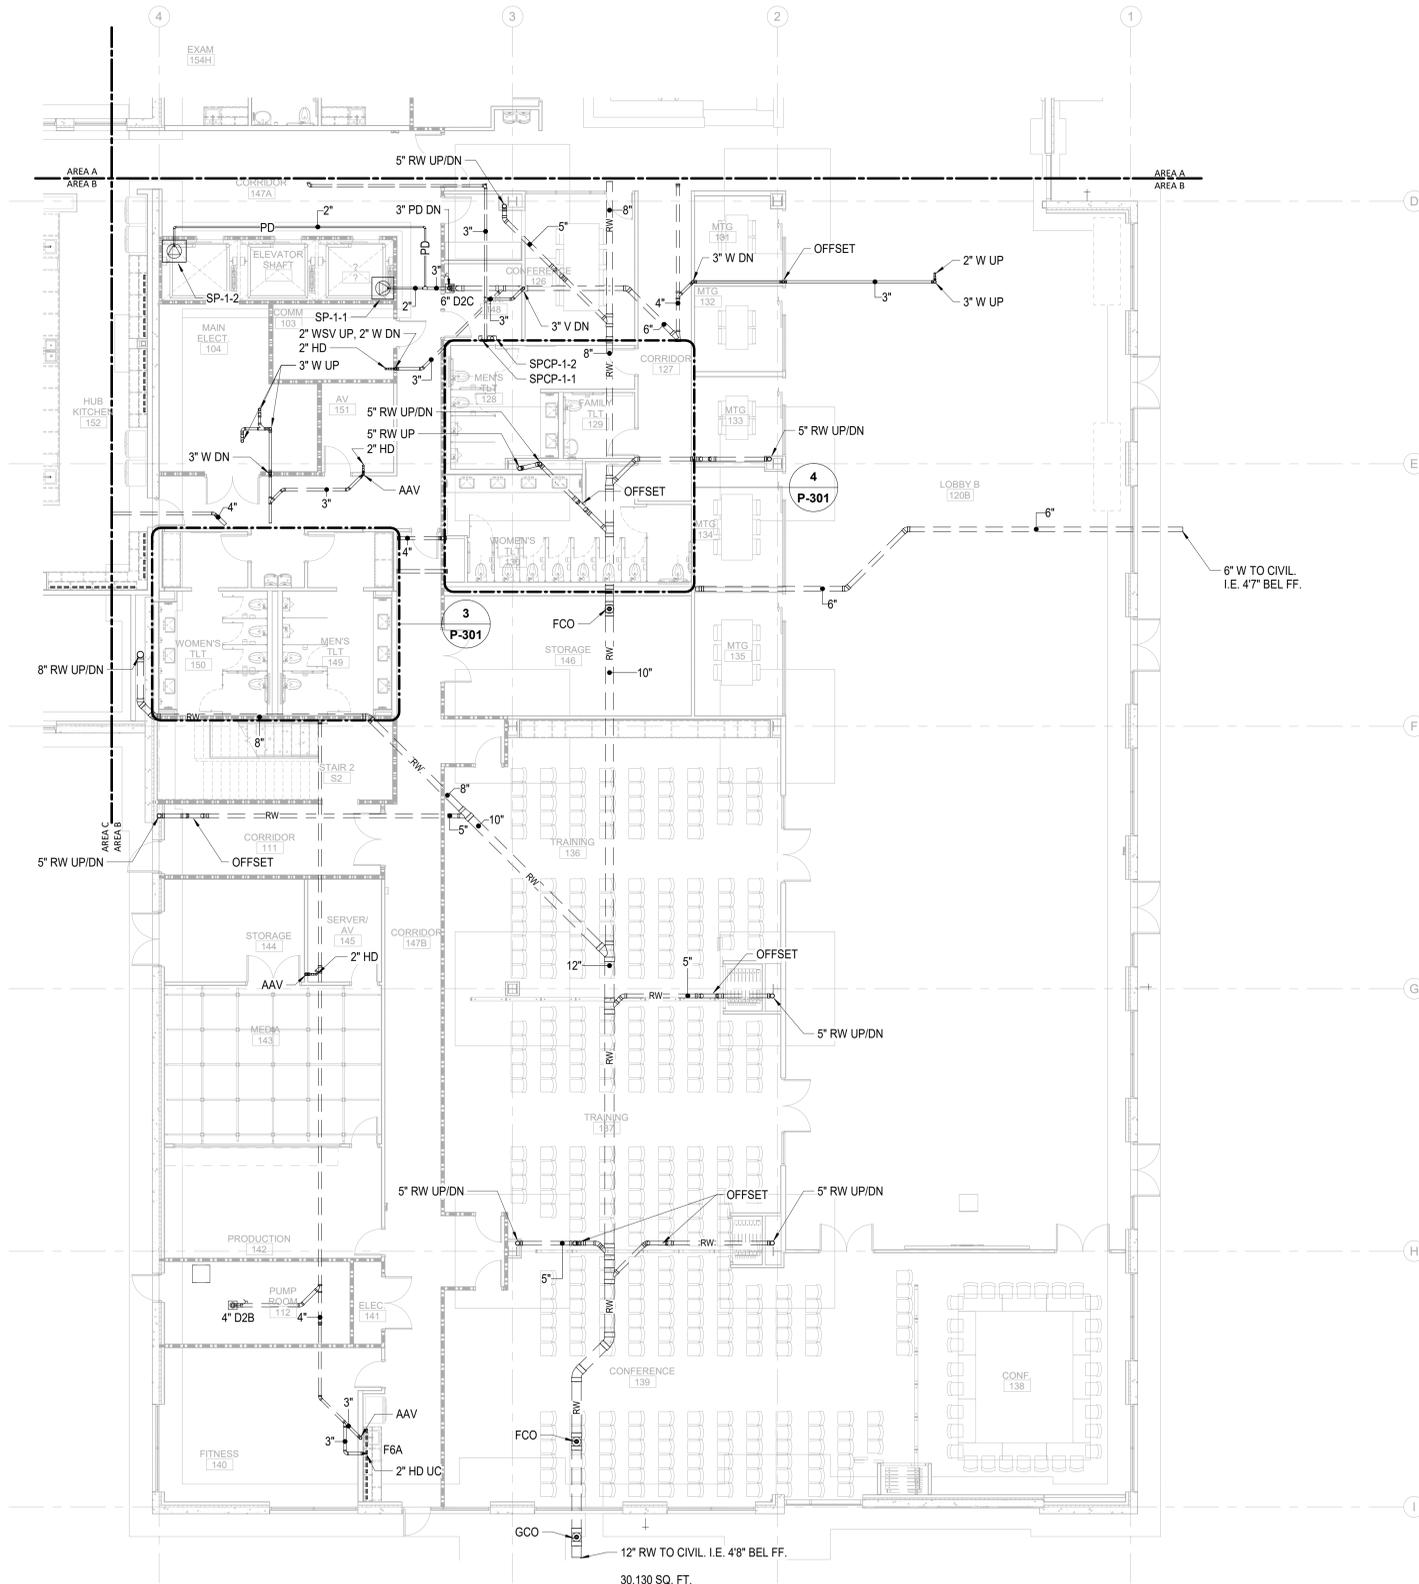

30,130 SQ. FT.



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THE NEW HANOVER COUNTY
PLUMBING WASTE FLOOR PLAN
IS NOT TO BE USED FOR CONSTRUCTION

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P-201B PLUMBING WASTE TI FLOOR PLAN - PARTIAL - LEVEL 1 - AREA B

1/8" = 1'-0"

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1/7/2021 2:36:45 PM



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CONSTRUCTION


NHC Government Center 7702-190810

**NEW HANOVER COUNTY
GOVERNMENT CENTER**
GOVERNMENT CENTER DRIVE
WILMINGTON, NC 28403

LS3P PROJECT: 7702-190810

A	DATE	DESCRIPTION
A	2020.08.18	TI-SCHEMATIC DESIGN
B	2020.10.16	TI-DESIGN DEVELOPMENT
C	2020.12.16	GMP SET
D	2020.12.22	ADDENDUM #1
E	2021.01.08	ADDENDUM #2

KEY PLAN:

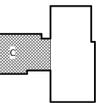

SHEET NAME:
**PLUMBING WASTE
FLOOR PLAN - LEVEL 1
- AREA C**

DATE: 2020.12.16
CURRENT: 2021.01.08


ADDENDUM #2

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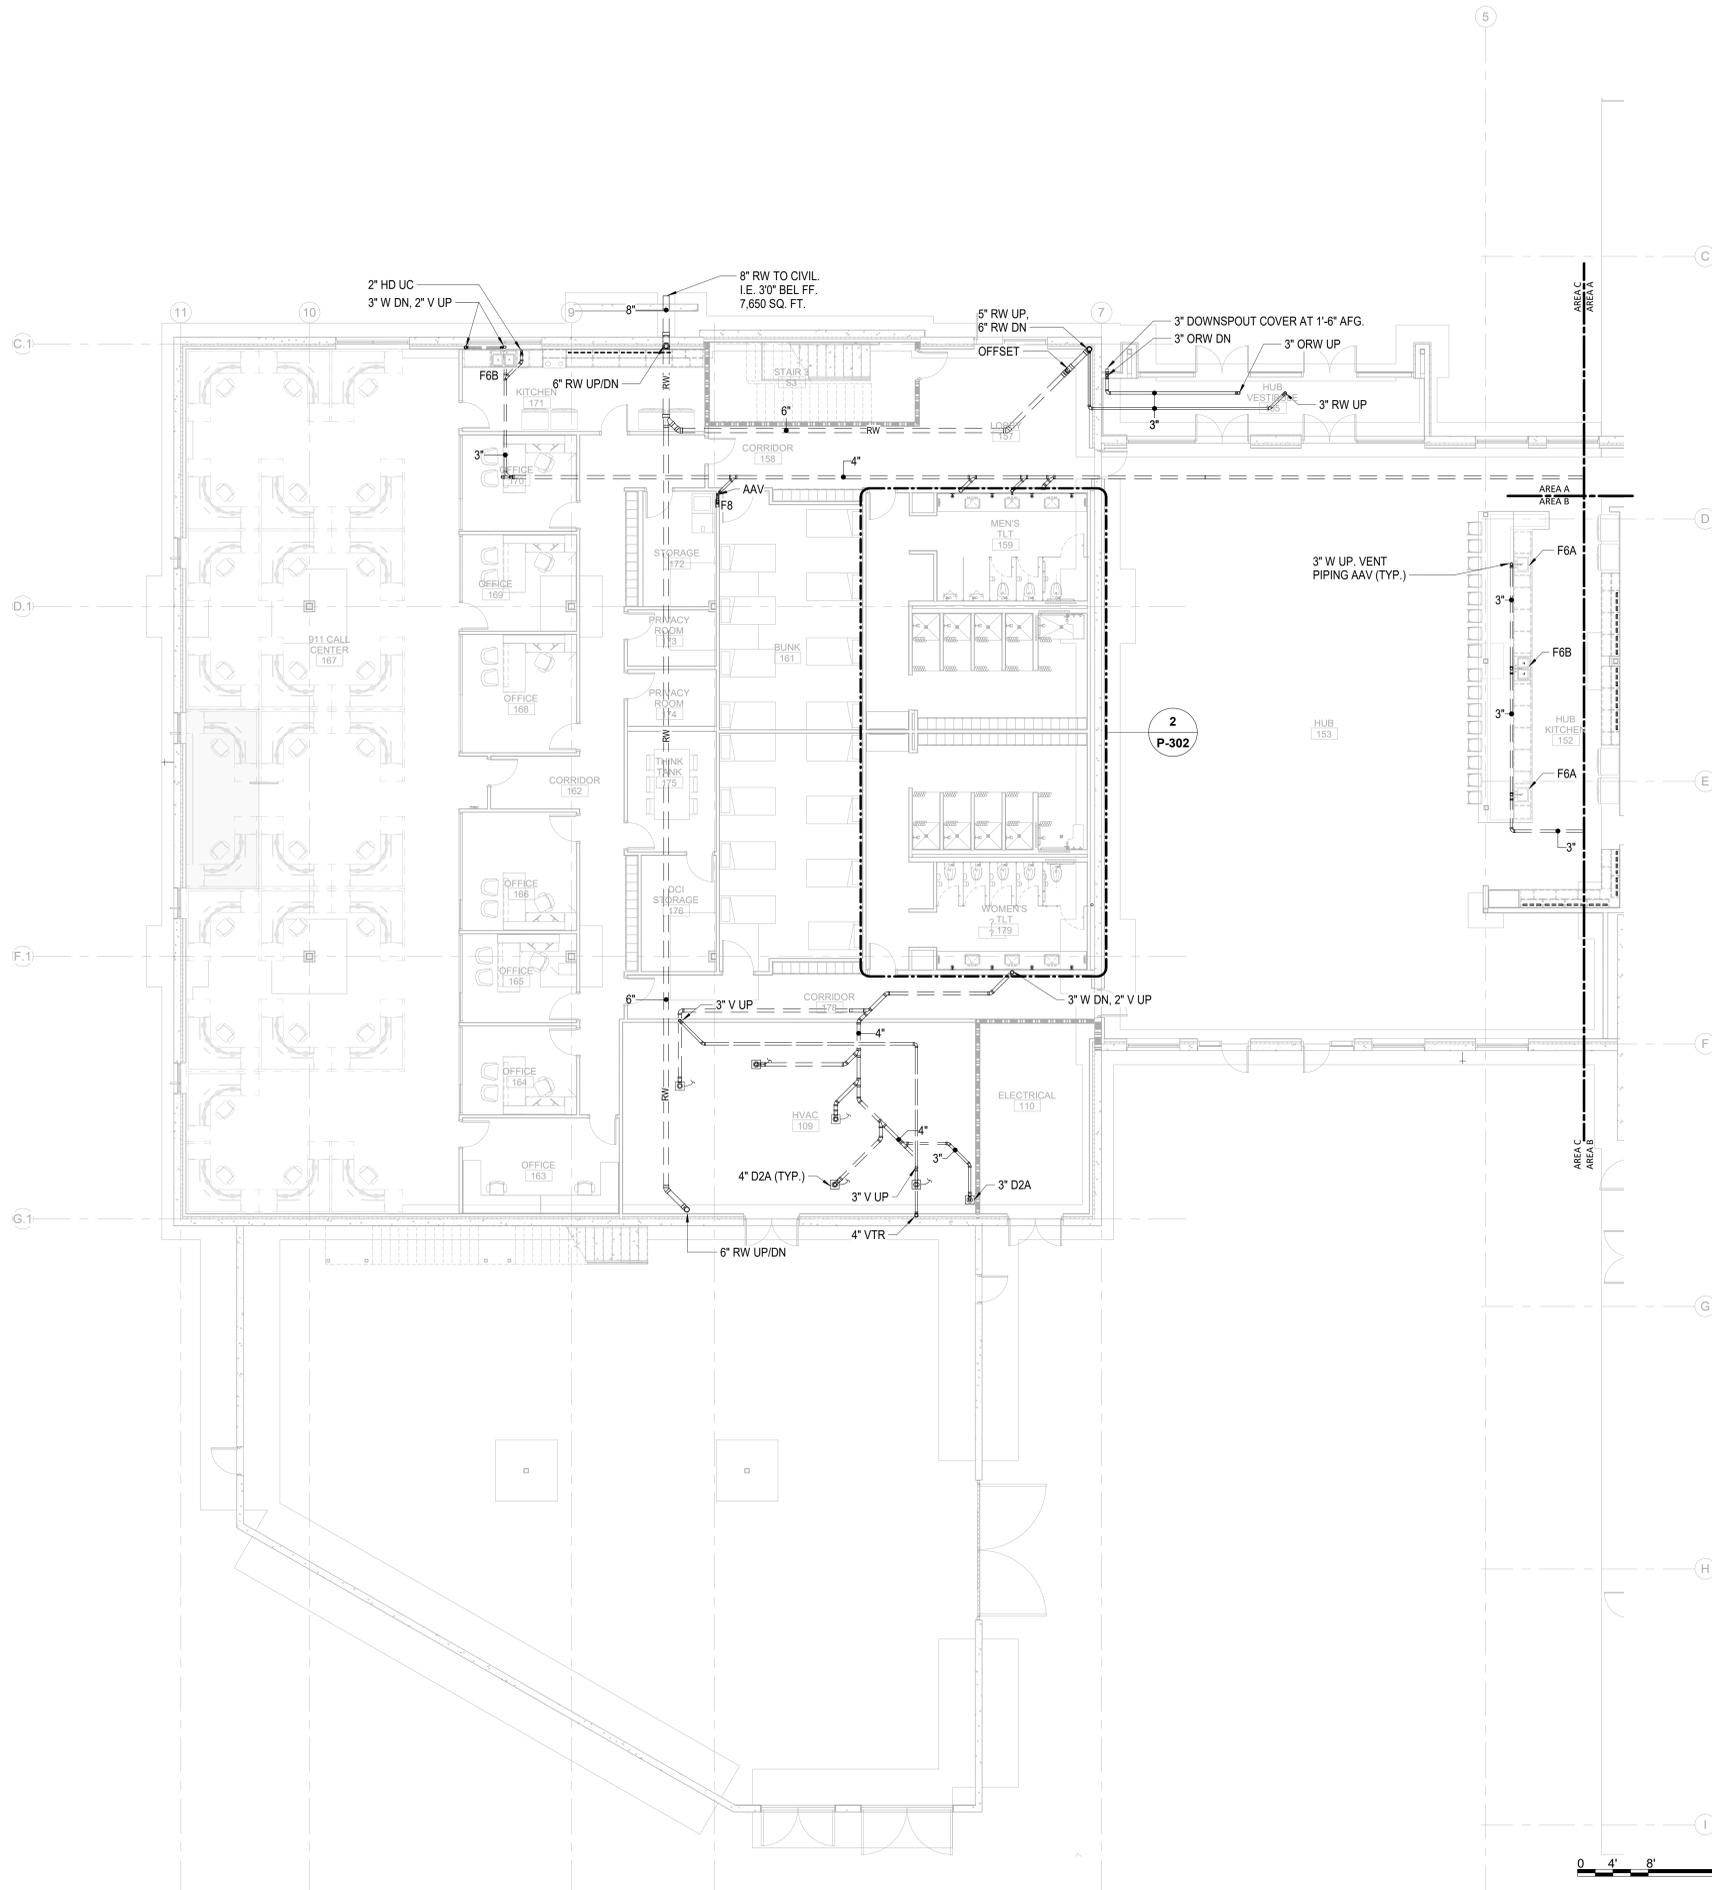
P-201C

GMP SET

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CONSULTANTS AND ENGINEERS
Consulting Engineering Group
5425 Paige Rd
Suite 215
Durham, NC 27703
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N&B PROJECT: 19N342
Firm License No. F-0312

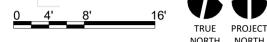

1/8" = 1'-0"



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P-201C

PLUMBING WASTE TI FLOOR PLAN - PARTIAL - LEVEL 1 - AREA C

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WILMINGTON, NORTH CAROLINA 28401
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CONSTRUCTION


NHC Government Center 7702-190810

NEW HANOVER COUNTY GOVERNMENT CENTER GOVERNMENT CENTER DRIVE WILMINGTON, NC 28403

LS3P PROJECT: 7702-190810

A	DATE	DESCRIPTION
A	2020.08.18	TI-SCHEMATIC DESIGN
B	2020.10.16	TI-DESIGN DEVELOPMENT
C	2020.12.16	GMP SET
E	2021.01.08	ADDENDUM #2

KEY PLAN:

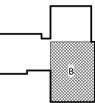

SHEET NAME:
PLUMBING WASTE
FLOOR PLAN - LEVEL 2
- AREA B


DATE: 2020.12.16
CURRENT: 2021.01.08

ADDENDUM #2

SHEET:
P-202B

GMP SET

Newcomb & Boyd
CONSULTANTS AND ENGINEERS
Consulting Engineering Group
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N&B PROJECT: 19N342
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CONSTRUCTION

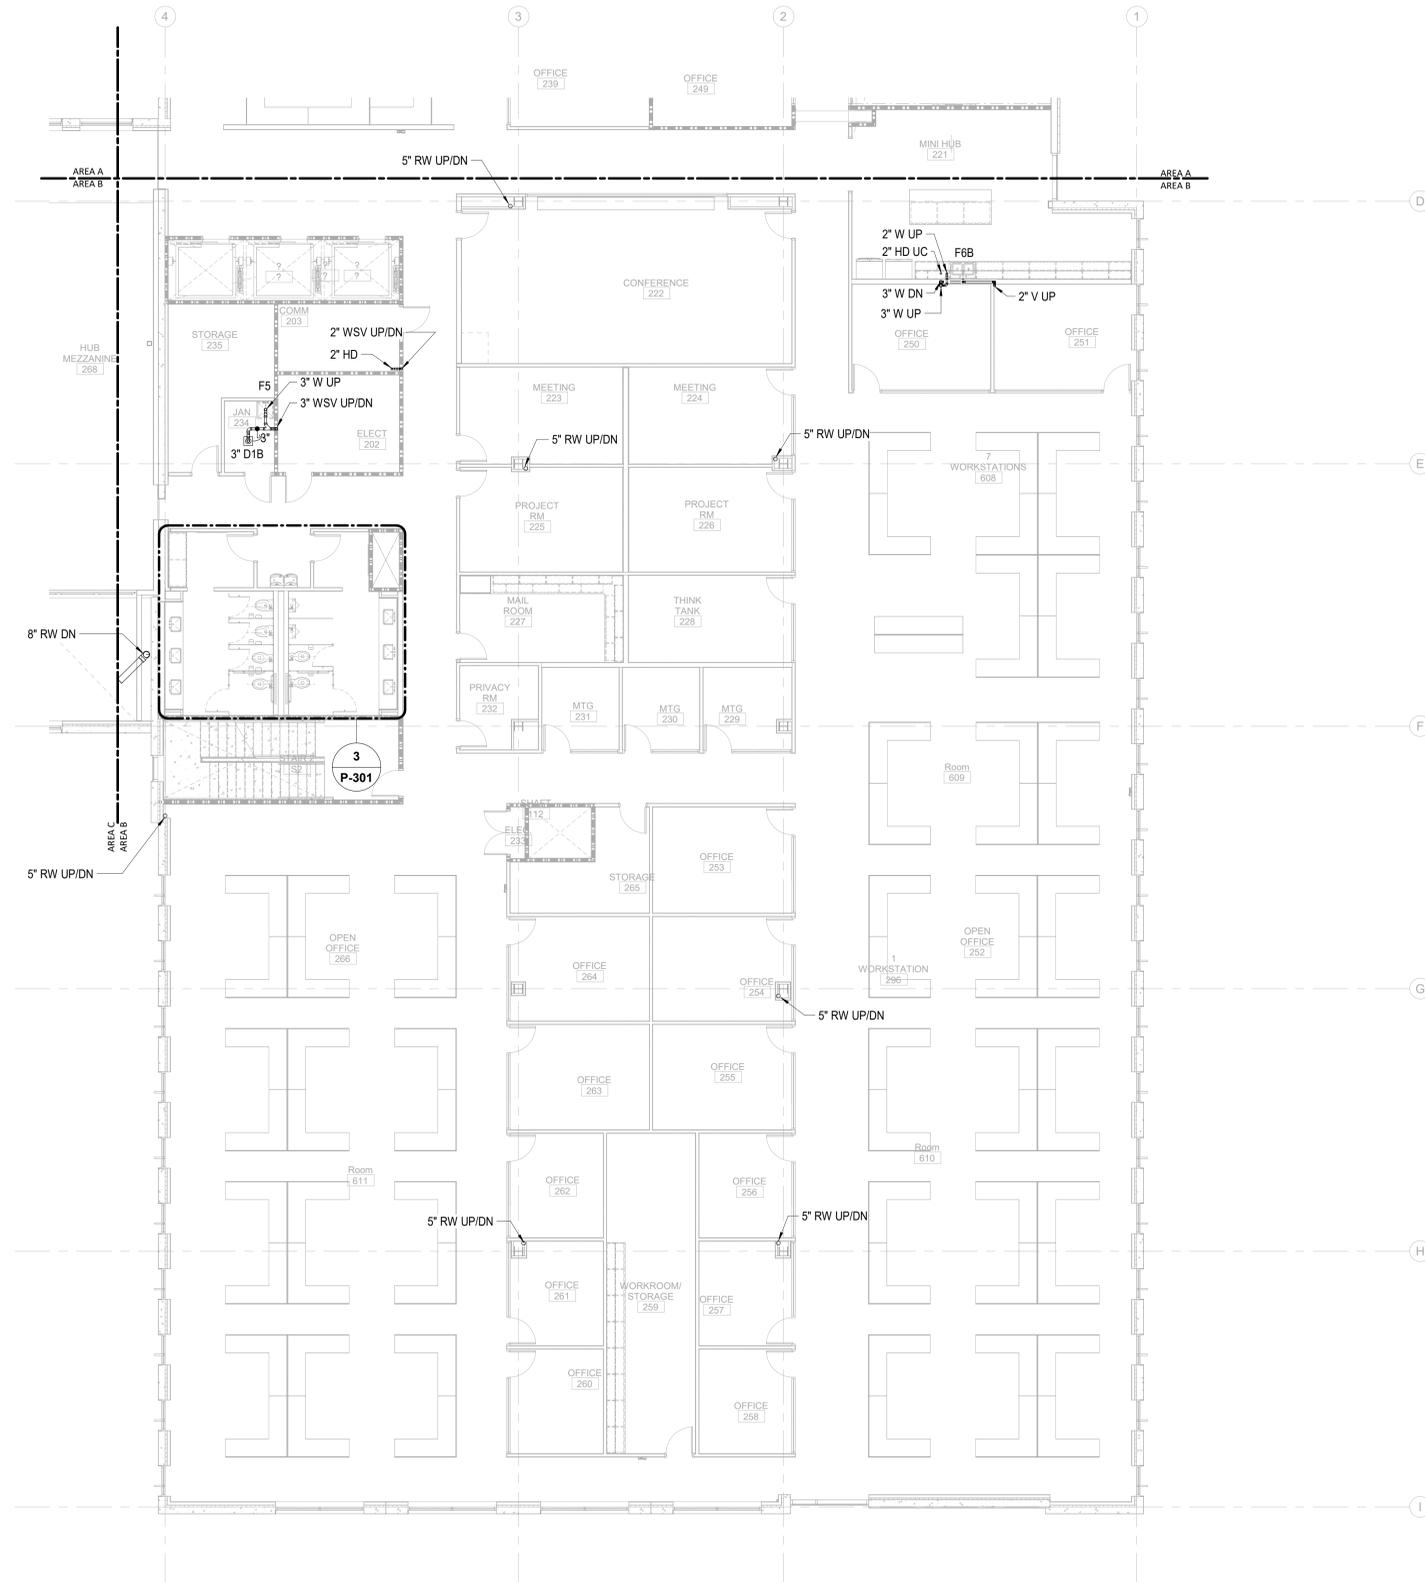
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**NEW HANOVER COUNTY
GOVERNMENT CENTER**
GOVERNMENT CENTER DRIVE
WILMINGTON, NC 28403

LS3P PROJECT: 7702-190810

A	DATE	DESCRIPTION
A	2020.08.18	TI-SCHEMATIC DESIGN
B	2020.10.16	TI-DESIGN DEVELOPMENT
C	2020.12.16	GMP SET
D	2021.01.08	ADDENDUM #1
E	2021.01.08	ADDENDUM #2

KEY PLAN:

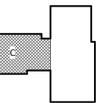

SHEET NAME:
PLUMBING WASTE
FLOOR PLAN - LEVEL 2
- AREA C

DATE: 2020.12.16
CURRENT: 2021.01.08

ADDENDUM #2

SHEET:


P-202C

GMP SET

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Consulting Engineering Group
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Contact: Paul J. Kitchens
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Firm License No. F-0312



1/8" = 1'-0"

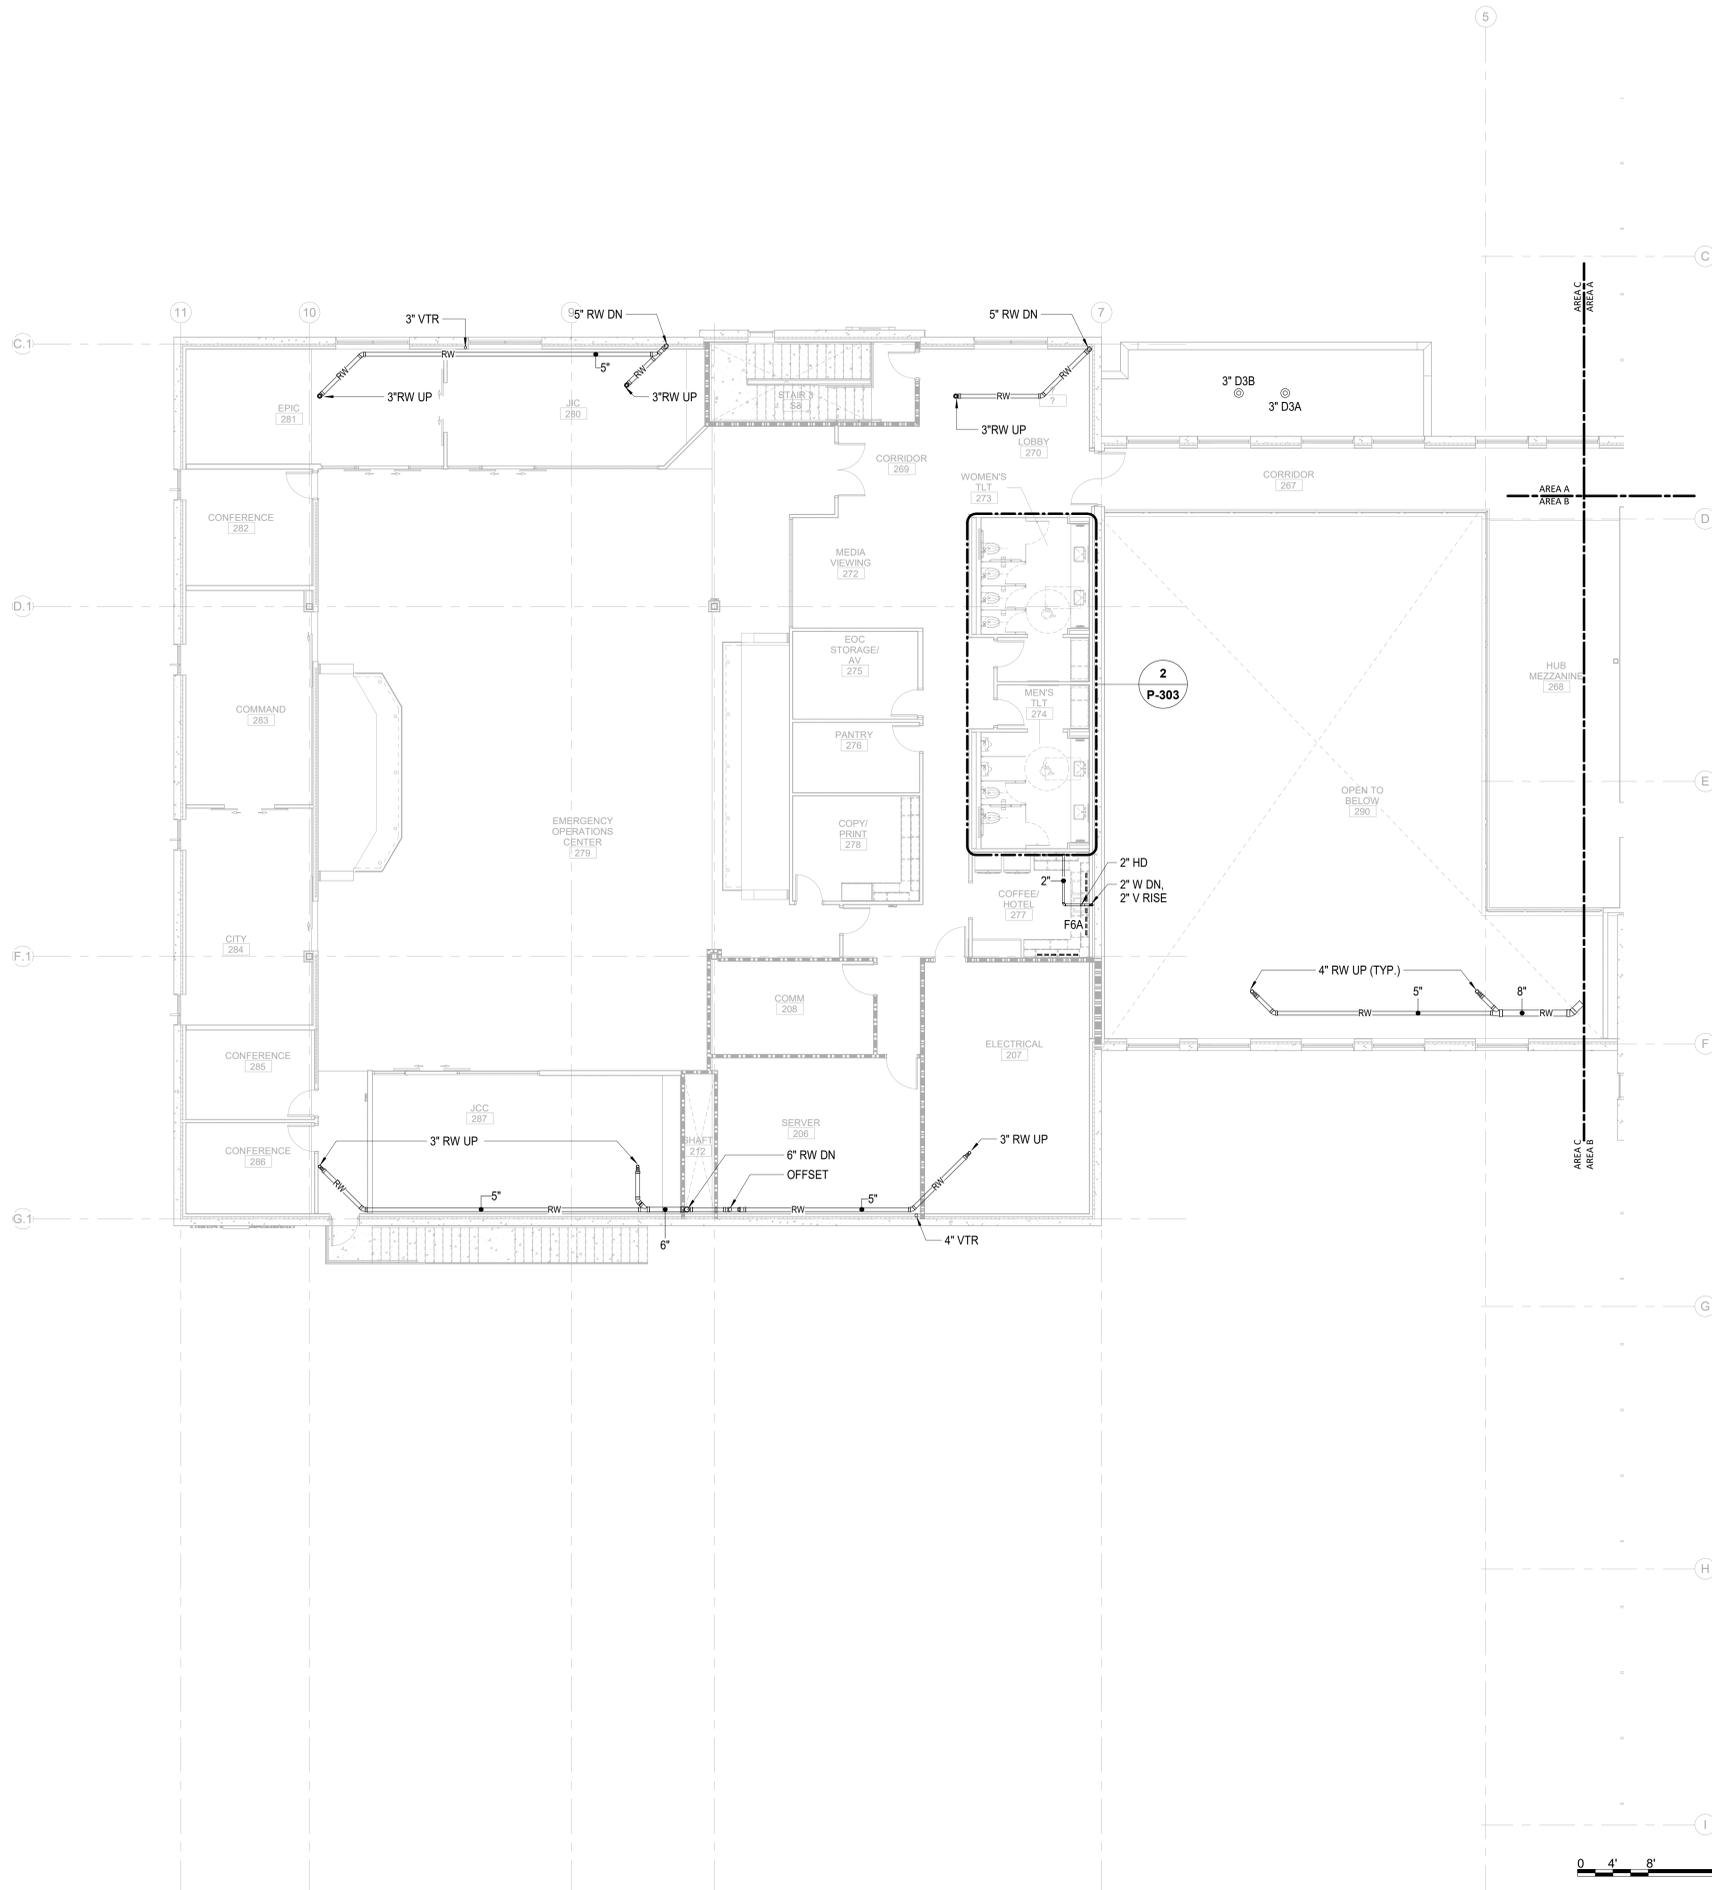

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P-202C
PLUMBING WASTE TI FLOOR PLAN - PARTIAL - LEVEL 2 - AREA C

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WILMINGTON, NORTH CAROLINA 28401
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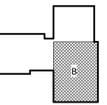
NOT FOR
CONSTRUCTION

NHC Government Center 7702-190810

**NEW HANOVER COUNTY
GOVERNMENT CENTER**
GOVERNMENT CENTER DRIVE
WILMINGTON, NC 28403
LS3P PROJECT: 7702-190810

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A	2020.08.18	TI-SCHEMATIC DESIGN
B	2020.10.16	TI-DESIGN DEVELOPMENT
C	2020.12.16	GMP SET
E	2021.01.08	ADDENDUM #2

KEY PLAN:




SHEET NAME:
PLUMBING WASTE
FLOOR PLAN - LEVEL 3
- AREA B

DATE: 2020.12.16
CURRENT: 2021.01.08
ADDENDUM #2

SHEET:
P-203B

GMP SET

Newcomb & Boyd
CONSULTANTS AND ENGINEERS
Consulting Engineering Group
5425 Page Rd
Suite 215
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Contact: Paul J. Kitchens
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Firm License No. F-0312

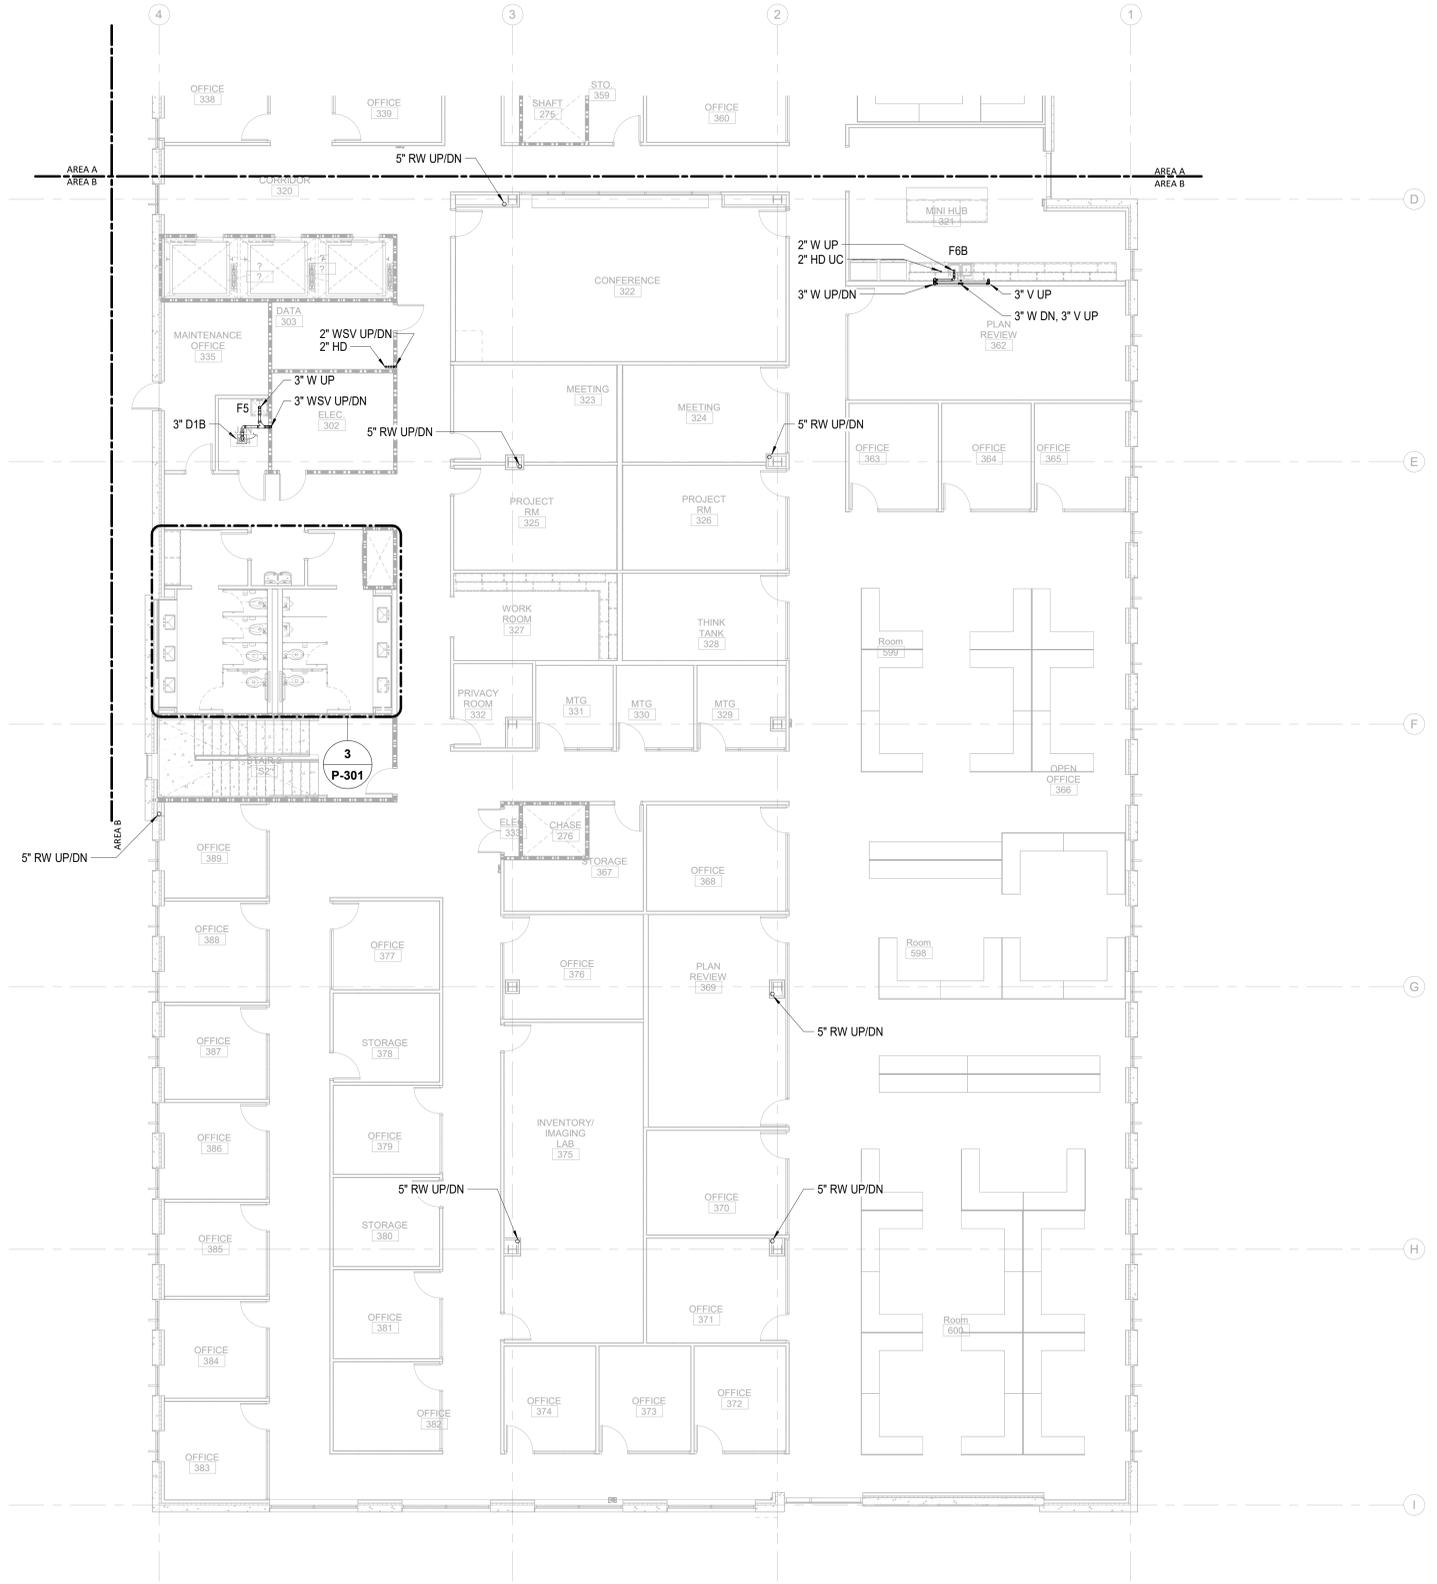

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P-203B

PLUMBING WASTE TI FLOOR PLAN - PARTIAL - LEVEL 3 - AREA B

1/8" = 1'-0"

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THE NEW HANOVER COUNTY
PLUMBING WASTE TI FLOOR PLAN
IS NOT TO BE CONSIDERED AS A
PART OF THE PROJECT CONTRACT.

1/7/2021 2:37:25 PM



CAPE FEAR FD STONEWATER



101 NORTH THIRD STREET, SUITE 500
WILMINGTON, NORTH CAROLINA 28401
TEL. 910.790.3111 FAX. 910.790.9901
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CONSTRUCTION


NHC Government Center 7702-190810

**NEW HANOVER COUNTY
GOVERNMENT CENTER**
GOVERNMENT CENTER DRIVE
WILMINGTON, NC 28403

LS3P PROJECT: 7702-190810

A	DATE	DESCRIPTION
A	2020.08.18	TI- SCHEMATIC DESIGN
B	2020.10.16	TI- DESIGN DEVELOPMENT
C	2020.12.16	GMP SET
E	2021.01.08	ADDENDUM #2

KEY PLAN:

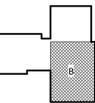

SHEET NAME:
PLUMBING WASTE
FLOOR PLAN - LEVEL 4
- AREA B


DATE: 2020.12.16
CURRENT: 2021.01.08

ADDENDUM #2

SHEET:
P-204B

GMP SET

Newcomb & Boyd
CONSULTANTS AND ENGINEERS
Consulting Engineering Group
5425 Page Rd
Suite 215
Durham, NC 27703
T 919 783-7812
Contact: Paul J. Kitchens
N&B PROJECT: 19N342
Firm License No. F-0312

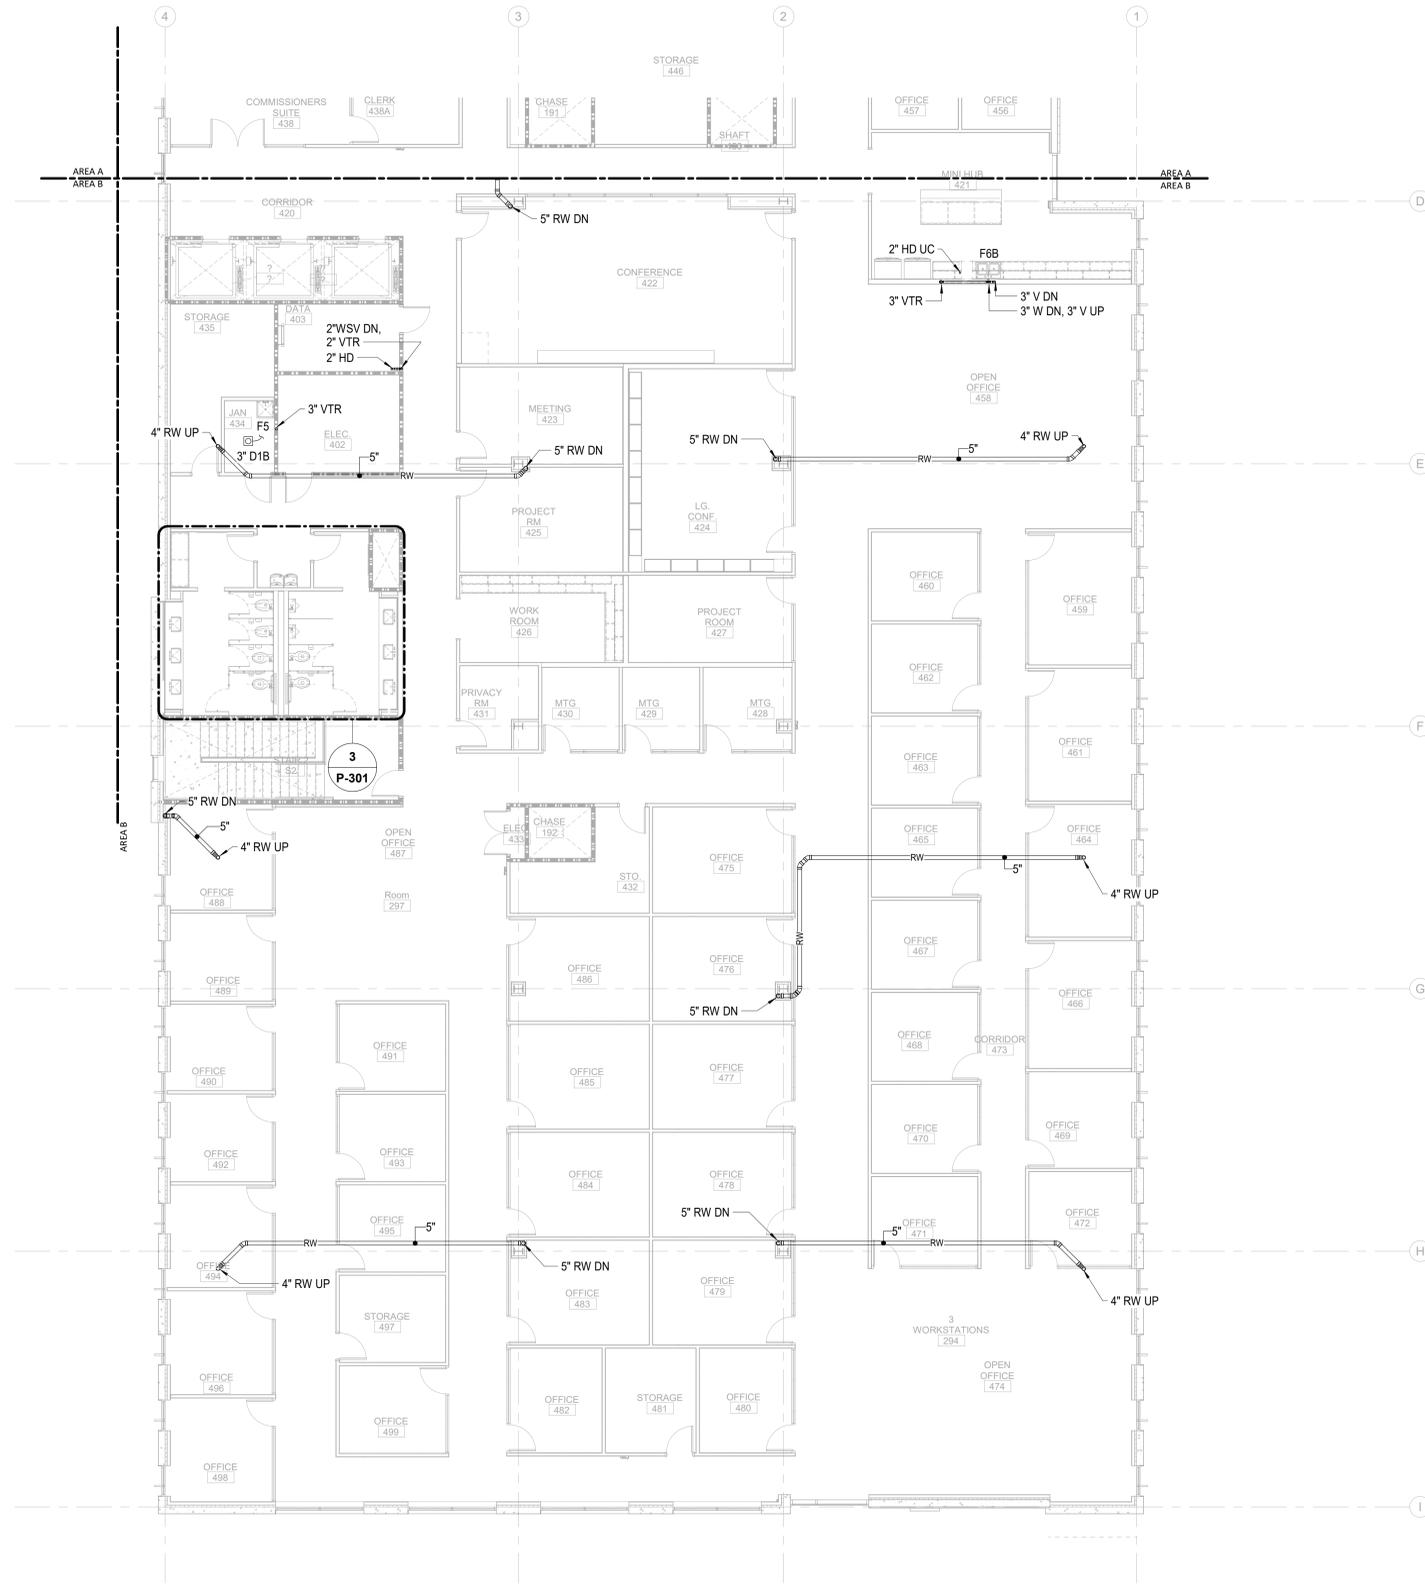

THE NEW HANOVER COUNTY
PLUMBING WASTE FLOOR PLAN
IS TO BE CONSIDERED AS
THE FINAL DESIGN AND SIZE

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P-204B

PLUMBING WASTE TI FLOOR PLAN - PARTIAL - LEVEL 4 - AREA B

1/8" = 1'-0"

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WILMINGTON, NORTH CAROLINA 28401
TEL. 910.790.3111 FAX. 910.790.9901
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NOT FOR
CONSTRUCTION

NHC Government Center 7702-190810


NEW HANOVER COUNTY GOVERNMENT CENTER

GOVERNMENT CENTER DRIVE
WILMINGTON, NC 28403

LS3P PROJECT: 7702-190810

Δ	DATE	DESCRIPTION
A	2020.08.18	TI- SCHEMATIC DESIGN
B	2020.10.16	TI- DESIGN DEVELOPMENT
C	2020.12.16	GMP SET
E	2021.01.08	ADDENDUM #2

KEY PLAN:

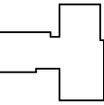


SHEET NAME:
PLUMBING WASTE
ROOF PLAN - OVERALL

DATE: 2020.12.16
CURRENT: 2021.01.08
ADDENDUM #2

SHEET:
P-205

GMP SET

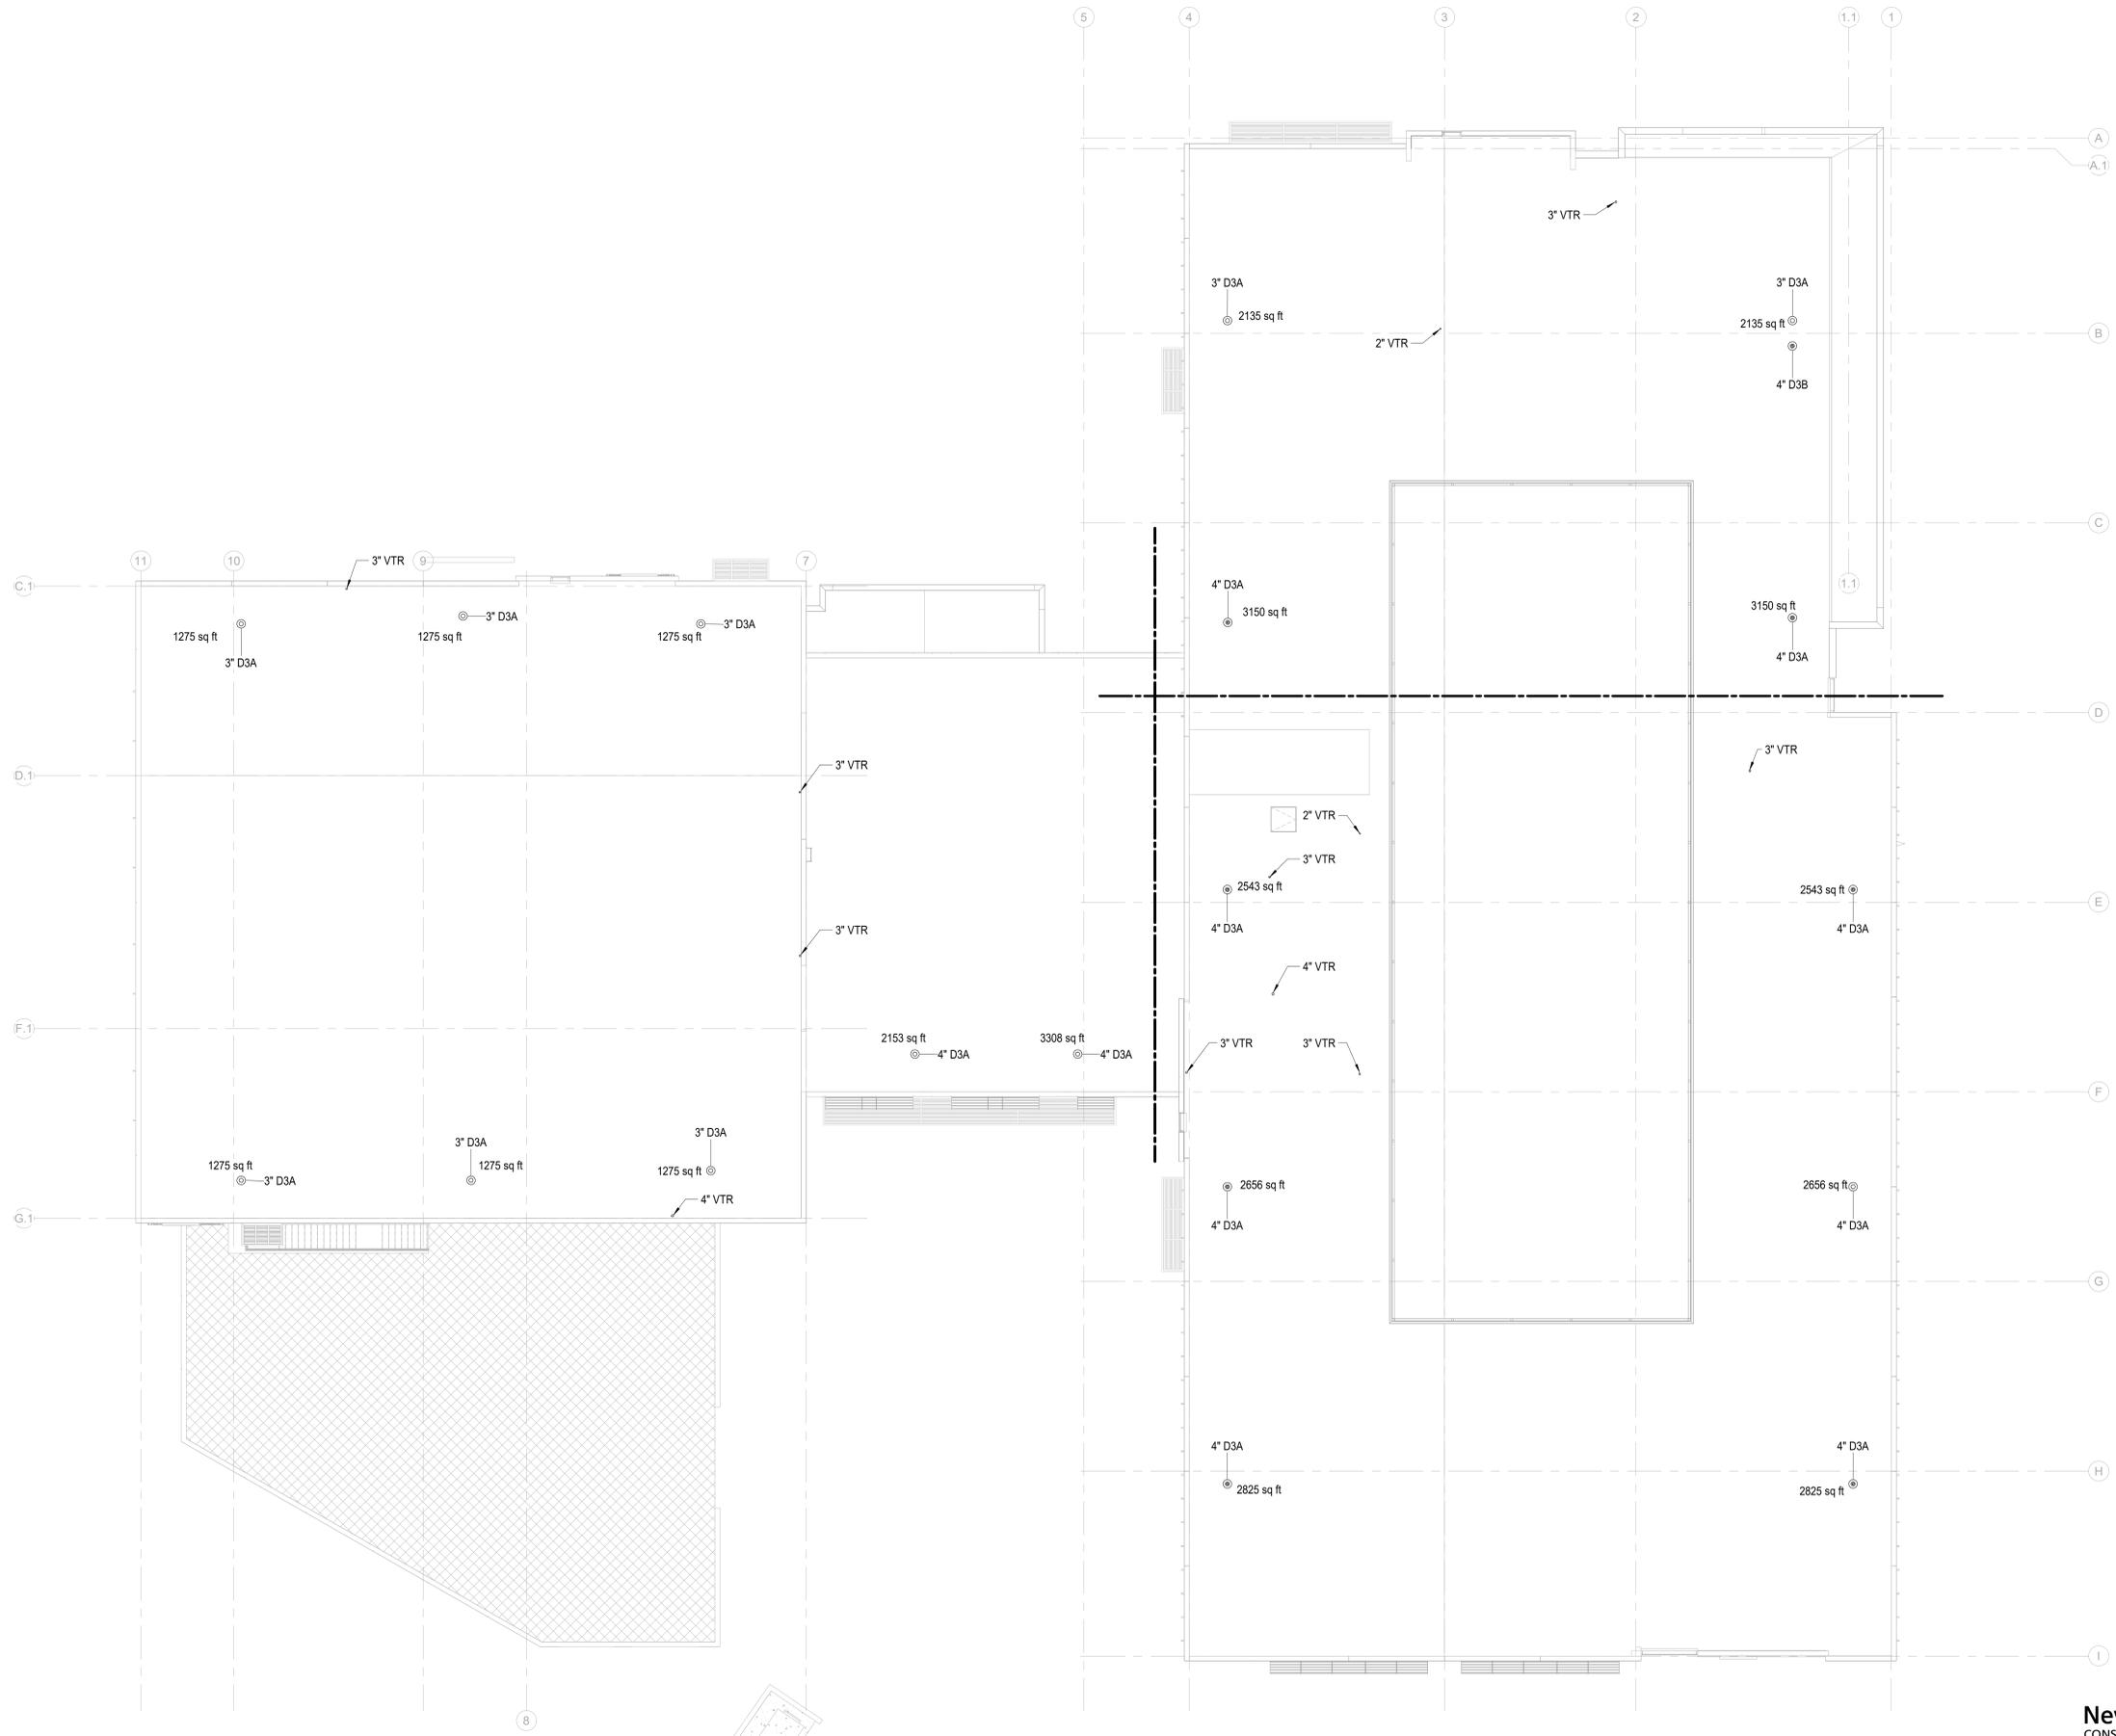


THE NEW HANOVER COUNTY
PROJECT IS SUBJECT TO THE
APPLICABLE ZONING ORDINANCE.

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P-205
PLUMBING WASTE ROOF - C&S



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Suite 215
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N&B PROJECT: 19N342
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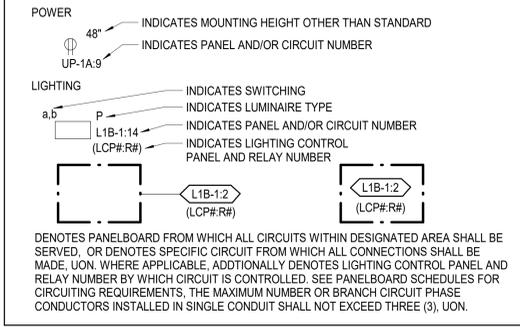
3/32" = 1'-0"

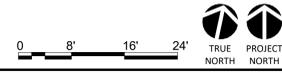1/7/2021 2:37:54 PM

DISCLAIMER

SYMBOLS, ABBREVIATIONS, AND OTHER INFORMATION DEPICTED ON THIS SHEET ARE FOR INFORMATION ONLY AND SHALL NOT CONSTITUTE A CHECKLIST FOR SCOPE INCLUDED IN THIS CONTRACT. ITEMS SHOWN ON THIS SHEET MAY NOT APPEAR AGAIN IN THE ELECTRICAL SERIES.

CIRCUITING



LUMINAIRES

SYMBOL	DESCRIPTION
	LINEAR LUMINAIRE. SHADED REGION INDICATES PROVISION FOR EMERGENCY LIGHTING. LETTER INDICATES LUMINAIRE TYPE. SEE SCHEDULE.
	2' X 2' LUMINAIRE. SHADED REGION INDICATES PROVISION FOR EMERGENCY LIGHTING. LETTER INDICATES LUMINAIRE TYPE. SEE SCHEDULE.
	LINEAR WALL-MOUNTED LUMINAIRE. SHADED REGION INDICATES PROVISION FOR EMERGENCY LIGHTING. LETTER INDICATES LUMINAIRE TYPE. SEE SCHEDULE.
	CIRCULAR RECESSED OR SURFACE LUMINAIRE. SHADED REGION INDICATES PROVISION FOR EMERGENCY LIGHTING. LETTER INDICATES LUMINAIRE TYPE. SEE SCHEDULE.
	SQUARE RECESSED OR SURFACE LUMINAIRE. SHADED REGION INDICATES PROVISION FOR EMERGENCY LIGHTING. LETTER INDICATES LUMINAIRE TYPE. SEE SCHEDULE.
	WALL-MOUNTED LUMINAIRE. SHADED REGION INDICATES PROVISION FOR EMERGENCY LIGHTING. LETTER INDICATES LUMINAIRE TYPE. SEE SCHEDULE.
	STRIP LUMINAIRE. SHADED REGION INDICATES PROVISION FOR EMERGENCY LIGHTING. LETTER INDICATES LUMINAIRE TYPE. SEE SCHEDULE.
	EXIT LIGHT, CEILING, PENDANT, OR WALL-MOUNTED. DARKENED SECTIONS INDICATE FACES; ARROWS AS INDICATED. LETTER INDICATES TYPE. SEE SCHEDULE.
	2' X 4' LUMINAIRE. SHADED REGION INDICATES PROVISION FOR EMERGENCY LIGHTING. LETTER INDICATES LUMINAIRE TYPE. SEE SCHEDULE.
	PEDESTRIAN POLE SITE LUMINAIRE. LETTER INDICATES LUMINAIRE TYPE. SEE SCHEDULE.
	EMERGENCY BUG-EYE LUMINAIRE. LETTER INDICATES LUMINAIRE TYPE. SEE SCHEDULE.
	UL924 EMERGENCY LIGHTING RELAY. REFER TO SPECIFICATIONS AND ELECTRICAL DETAILS FOR ADDITIONAL INFORMATION.

SPECIAL OUTLET SCHEDULE

TYPE	DESCRIPTION
A	40A, 208V, 1 PHASE, SPECIAL OUTLET FOR ELECTRIC RANGE. WALL MOUNTED AT 18" AFF UON. COORDINATE NEMA TYPE OUTLET CONFIGURATION WITH ACTUAL EQUIPMENT PROVIDED.
B	30A, 208V, 4-WIRE GROUNDING OUTLET, 1 PHASE, SPECIAL OUTLET FOR STACKED CLOTHES DRYER. COORDINATE NEMA TYPE OUTLET CONFIGURATION WITH ACTUAL EQUIPMENT PROVIDED.
C	NEMA L6-30R 30A, 208V, 1 PHASE, SPECIAL OUTLET FOR SERVER RACK. WALL MOUNTED AT 18" AFF UON.
D	NEMA L21-20P 20A, 208V, 3 PHASE, SPECIAL OUTLET FOR SERVER RACK PROVIDED AS PART OF THE OVERHEAD BUSWAY SYSTEM. REFER TO DETAIL 5E-605 FOR ADDITIONAL INFORMATION.

ELECTRICAL EQUIPMENT

SYMBOL	DESCRIPTION
	RACEWAY CONCEALED IN FLOOR OR UNDERGROUND.
	RACEWAY CONCEALED IN CEILING CAVITY OR WALL.
	RACEWAY EXPOSED TO VIEW UNLESS OTHERWISE NOTED.
	FLEXIBLE RACEWAY.
	RACEWAY HOMERUN TO PANEL. ONE ARROWHEAD PER CIRCUIT.
	3 WIRES #12 AWG IN CABLE OR CONDUIT, EXCLUDING GROUNDING CONDUCTOR. NOTE: NUMBER OF CROSS HATCHES INDICATES NUMBER OF #12 AWG CONDUCTORS. LESS GROUNDING CONDUCTOR. SHORT CROSS HATCH = PHASE CONDUCTOR. LONG CROSS HATCH = NEUTRAL. NO CROSS HATCHES INDICATES 2 #12 AWG EXCLUDING GROUNDING CONDUCTOR IN CABLE OR CONDUIT.
	RACEWAY TURNED UP.
	RACEWAY TURNED DOWN.
	UNDERGROUND PRIMARY (EXISTING DASHED).
	UNDERGROUND SECONDARY (EXISTING DASHED).
	UNDERGROUND EMERGENCY FEEDER (EXISTING DASHED).
	GROUNDING ELECTRODE.
	GROUNDING ELECTRODE BONDED TO EQUIPOTENTIAL PLANE.
	GROUND BUS.
	DUCT BANK SECTION.
	MANHOLE.
	DRY-TYPE TRANSFORMER.
	TRANSFORMER, PAD-MOUNTED.
	PANELBOARD, FLUSH-MOUNTED.
	PANELBOARD, SURFACE-MOUNTED.
	ELECTRONIC POWER METER.
	MOTOR, NUMERAL INDICATES HP. "F" INDICATES FRACTIONAL HORSE POWER.
	MOTOR CONTROLLER. MOUNT 48" AFF, UNLESS OTHERWISE NOTED.
	COMBINATION MOTOR CONTROLLER/DISCONNECT. MOUNT 48" AFF, UNLESS OTHERWISE NOTED.
	DISCONNECT SWITCH, SIZE/POLES/FUSE/ENCLOSURE TYPE IF OTHER THAN NEMA 1. MOUNT 48" AFF, UNLESS OTHERWISE NOTED.
	INDIVIDUAL CIRCUIT BREAKER, TRIP/POLES. MOUNT 48" AFF, UNLESS OTHERWISE NOTED.

LIGHTING CONTROL DEVICES

SYMBOL	DESCRIPTION	MOUNTING HEIGHT AFF, UON
	LOW VOLTAGE SWITCH, WALL-MOUNTED. LOWERCASE LETTERING INDICATES CONTROLLED ZONE. TYPE DESIGNATED: BLANK - ON/OFF SWITCH OS - OCCUPANCY SENSOR TYPE, DUAL TECHNOLOGY VS - VACANCY SENSOR TYPE, DUAL TECHNOLOGY WP - SWITCH IN WEATHERPROOF ENCLOSURE OR# - LIGHTING RELAY PANEL OVERRIDE SWITCH PS - CONFERENCE ROOM PARTITION SWITCH	48"
	LINE VOLTAGE PRESET COUNTDOWN TIME SWITCH	48"
	LOW VOLTAGE DIMMING SWITCH, WALL-MOUNTED. LOWERCASE LETTERING INDICATES CONTROLLED ZONE. TYPE DESIGNATED: BLANK - RAISE/LOWER, 0-10V OS - OCCUPANCY SENSOR TYPE, DUAL TECHNOLOGY VS - VACANCY SENSOR TYPE, DUAL TECHNOLOGY	48"
	LOW VOLTAGE LIGHTING CONTROL SENSOR DEVICE. DUAL TECHNOLOGY OCCUPANCY SENSOR, PHOTOSENSOR, VACANCY SENSOR. WHERE NO LETTER IS SHOWN, SENSOR(S) SHALL BE CEILING MOUNTED AND CONTROL ALL LUMINAIRES IN CORRESPONDING ROOM. (D = DAMP RESISTANT, P = PENDANT-MOUNT PER MANUFACTURER'S RECOMMENDATIONS)	
	LIGHTING CONTROL STATION	48"

ELECTRICAL DEVICES

SYMBOL	DESCRIPTION	MOUNTING HEIGHT AFF, UON
	DUPLEX RECEPTACLE. SHADED REGION INDICATES PROVISION FOR EMERGENCY POWER. TYPE DESIGNATED: BLANK - DUPLEX RECEPTACLE USB - USB DUPLEX RECEPTACLE WITH TWO USB PORTS. TV - RECEPTACLE FOR TV MONITOR. MOUNT WITHIN DISPLAY BACK BOX. COORDINATE WITH AV AND ARCHITECTURAL DRAWINGS FOR MOUNTING HEIGHTS AND OTHER DETAILS. MW - RECEPTACLE FOR MICROWAVE. U - RECEPTACLE FED FROM UPS SYSTEM.	18"
	DOUBLE DUPLEX RECEPTACLE OUTLET. SHADED REGION INDICATES PROVISION FOR EMERGENCY POWER.	18"
	GFCI DUPLEX RECEPTACLE. SHADED REGION INDICATES PROVISION FOR EMERGENCY POWER. "WP" - WEATHER PROOF GFCI RECEPTACLE WITH COVERPLATE	18"
	GFCI DOUBLE DUPLEX RECEPTACLE OUTLET. SHADED REGION INDICATES PROVISION FOR EMERGENCY POWER.	18"
	GFCI DUPLEX RECEPTACLE. ABOVE COUNTER. SHADED REGION INDICATES PROVISION FOR EMERGENCY POWER.	
	SPECIAL CONNECTION OUTLET. TYPE AS NOTED. REFER TO SPECIAL CONNECTION SCHEDULE, THIS SHEET. SHADED REGION INDICATES PROVISION FOR EMERGENCY POWER.	
	JUNCTION BOX, WALL-MOUNTED. TYPE DESIGNATED: F - JUNCTION BOX FOR POWER CONNECTION TO PRE-WIRED FURNITURE SYSTEM. COORDINATE EXACT REQUIREMENTS WITH THE PARTICULAR SUPPLIER. AND MAKE THE FINAL CONNECTIONS.	
	JUNCTION BOX, FLOOR.	
	JUNCTION BOX, ABOVE CEILING. TYPE DESIGNATED: PS - JUNCTION BOX FOR CONNECTION TO PROJECTION SCREEN. ADJUST LOCATION AS REQUIRED AND COORDINATE CONNECTION REQUIREMENTS WITH SELECTED EQUIPMENT. ADO - AUTOMATIC DOOR OPERATOR. COORDINATE EXACT REQUIREMENTS WITH THE PARTICULAR SUPPLIER. AND MAKE THE FINAL CONNECTIONS.	
	DUPLEX RECEPTACLE, CEILING-MOUNTED. TYPE DESIGNATED: PJ - OUTLET FOR CONNECTION TO PROJECTOR. COORDINATE EXACT LOCATION WITH ARCHITECTURAL AND AV DRAWINGS.	
	FLOOR BOX. TYPE DESIGNATED: A - POWER ONLY FLOOR BOX WITH (2) 20A DUPLEX OUTLETS WITHIN THE BOX. WIREMOLD RFB2S-FC OR APPROVED EQUAL. COORDINATE COVER WITH ARCHITECT. B - POWER/TELECOM FLOOR BOX WITH FLEXIBLE CONDUIT CONNECTION TO FURNITURE SYSTEM. WIREMOLD EVOLUTION WITH FURNITURE FEED OR APPROVED EQUAL. COORDINATE COVER WITH ARCHITECT. C - AV FLOOR BOX. FSR500 OR EQUIVALENT. PROVIDE (2) 20A DUPLEX OUTLETS WITHIN THE BOX. REFER TO ELECTRONIC SYSTEM DRAWINGS FOR TYPE AND QUANTITIES OF DATA AND AV DEVICES WITHIN THE BOX. COORDINATE COVER WITH ARCHITECT. D - RAISED FLOOR AV FLOOR BOX. FSR FL540 OR EQUIVALENT. PROVIDE (2) 20A DUPLEX OUTLETS WITHIN THE BOX. REFER TO ELECTRONIC SYSTEM DRAWINGS FOR TYPE AND QUANTITIES OF DATA AND AV DEVICES WITHIN THE BOX. COORDINATE COVER WITH ARCHITECT.	
	POKE-TROUGH. TYPE DESIGNATED: A - POWER/TELECOM POKE THROUGH WITH FLEXIBLE CONDUIT CONNECTION TO FURNITURE SYSTEM. WIREMOLD EVOLUTION WITH FURNITURE FEED OR APPROVED EQUAL. COORDINATE COVER WITH ARCHITECT. B - AV POKE THROUGH. PROVIDE (2) 20A DUPLEX OUTLETS WITHIN THE BOX. WIREMOLD EVOLUTION 8AT OR APPROVED EQUAL. REFER TO ELECTRONIC SYSTEM DRAWINGS FOR TYPE AND QUANTITIES OF DATA AND AV DEVICES WITHIN THE BOX. C - POWER ONLY POKE THROUGH WITH (2) 20A DUPLEX OUTLETS WITHIN THE BOX. WIREMOLD EVOLUTION 4AT POKE THROUGH OR APPROVED EQUAL. COORDINATE COVER WITH ARCHITECT. D - POWER/TELECOM POKE THROUGH. PROVIDE (2) 20A DUPLEX OUTLETS WITHIN THE BOX. WIREMOLD EVOLUTION 6AT OR APPROVED EQUAL. REFER TO ELECTRONIC SYSTEM DRAWINGS FOR TYPE AND QUANTITIES OF DATA AND AV DEVICES WITHIN THE BOX.	
	RAISED FLOOR BOX WITH WHIP ASSEMBLY PROVIDED BY THE RAISED FLOOR MANUFACTURER, INSTALLED BY EC. TYPE DESIGNATED: A - POWER ONLY WITH (2) 20A DUPLEX OUTLETS WITHIN THE BOX. B - POWER/TELECOM. PROVIDE (2) 20A DUPLEX OUTLETS WITHIN THE BOX. REFER TO ELECTRONIC SYSTEM DRAWINGS FOR TYPE AND QUANTITIES OF DATA DEVICES WITHIN THE BOX.	
	EMERGENCY POWER OFF SWITCH WITH CLEAR PLASTIC COVER. MOUNT AT 66" UON.	

ABBREVIATIONS

AFF/AFGIARF	ABOVE FINISHED FLOOR/GRADE/RAISED FLOOR	HPS	HIGH PRESSURE SODIUM
ABV	ABOVE	IG	ISOLATED GROUND
AC	ALTERNATING CURRENT	IMC	INTERMEDIATE METAL CONDUIT
ARCH	ARCHITECT/ARCHITECTURAL	INV	INVERTER
AV	AUDIO/VISUAL	JB	JUNCTION BOX
AVC	AUDIO/VISUAL CREDENZA	kcmil	THOUSAND CIRCULAR MILLS
BEL	BELOW	MC	METAL-CLAD CABLE
BF	BELOW FLOOR	MCC	MOTOR CONTROL CENTER
BFC	BELOW FINISHED CEILING	NC	NORMALLY CLOSED
BM	BEAM	NL	NIGHT LIGHT
C	CONDUIT	NF	NONFUSIBLE
CB	CIRCUIT BREAKER	NO	NORMALLY OPEN
CKT	CIRCUIT	OC	ON CENTER
CLG	CEILING	OCP	OVERCURRENT PROTECTION
COL	COLUMN	PC	PHOTOCELL
CONN	CONNECT/CONNECTION	PH OR Ø	PHASE
CONT	CONTINUATION/CONTINUOUS	PL	PILOT LIGHT
CTE	CONNECT TO EXISTING	PNL	PANEL
DC	DIRECT CURRENT	PV	PHOTO-VOLTAIC
DN	DOWN	RC	REMOTE CONTROL
EC	EMPTY CONDUIT	REC	RECEPTACLE
EI	ELECTRICALLY OPERATED	REL	RELLOCATE
EI	ELECTRICALLY INTERLOCKED	REM	REMOVE
ELEV	ELEVATOR	RS	RAPID START
EMT	ELECTRICAL METALLIC TUBING	SC	SPLIT CIRCUIT
ENT	ELECTRICAL NONMETALLIC TUBING	SPEC	SPECIFICATION
EX	EXISTING	SPDT	SINGLE-POLE DOUBLE-THROW
ETR	EXISTING TO REMAIN	ST	SHUNT STRIP
EXP	EXPOSED	SW	SWITCH
GRC	RIGID METAL CONDUIT	TELE	TELEPHONE
F	FUSED	TS	TIGHT TO STRUCTURE
FA	FIRE ALARM	UG	UNDERGROUND
LDM	LIGHTING CONTROL MODULE	WP	WEATHER PROOF
LMNR	LUMINAIRE	XFMR	TRANSFORMER
FL	FLOOR	UON	UNLESS OTHERWISE NOTED
G	GROUND		
GFF	GROUND FAULT PROTECTION		
GR	GRADE		
HID	HIGH INTENSITY DISCHARGE		
HOA	HAND-OFF-AUTOMATIC		



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NHC Government Center 7702-190810

**NEW HANOVER COUNTY
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LS3P PROJECT: 7702-190810

A	DATE	DESCRIPTION
A	2020.08.18	TI-SCHEMATIC DESIGN
B	2020.10.16	TI-DESIGN DEVELOPMENT
C	2020.12.16	GMP SET
D	2020.12.22	ADDENDUM #1
E	2021.01.08	ADDENDUM #2

SHEET NAME:
ELECTRICAL LEGEND

DATE: 2020.12.16
CURRENT: 2021.01.08

ADDENDUM #2

SHEET:

E-001

GMP SET

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GENERAL NOTES:

- REFER TO CIVIL PLANS FOR LOCATIONS OF OTHER UTILITIES. FIELD VERIFY LOCATIONS OF EXISTING UTILITIES PRIOR TO INSTALLATION OF NEW DUCTS. OFFSET DUCTS TO AVOID CONFLICTS WITH EXISTING UNDERGROUND OBSTRUCTIONS. DUCTS SHALL CLEAR STEAM LINES AND COMMUNICATION LINES 4' 00" WHERE PARALLEL AND 18" WHERE CROSSING PERPENDICULAR. CLEAR ALL OTHER UTILITIES BY 1' 00".
- ALL UNDERGROUND DUCTS SHALL BE CONCRETE ENCASED, UNLESS OTHERWISE NOTED.
- REFER TO TELECOM DRAWINGS FOR ADDITIONAL DUCTBANK ROUTING PLANS NOT SHOWN ON THIS SHEET.
- COORDINATE THE INSTALLATION AND ROUTING OF NEW UNDERGROUND DUCTBANKS TO AVOID CONFLICTS WITH STRUCTURAL FOOTINGS.

KEY NOTES:

- PAD MOUNTED UTILITY TRANSFORMER PROVIDED BY UTILITY COMPANY.
- UTILITY TRANSFORMER WORKING CLEARANCE OUTLINE. PROVIDE MIN OF 10 FT CLEAR IN FRONT OF TRANSFORMER AND 3 FT MINIMUM ON ALL SIDES PER UTILITY REQUIREMENTS.
- NEW DIESEL GENERATOR SET IN WEATHERPROOF ENCLOSURE. PROVIDE CONCRETE PAD FOR GENERATOR INSTALLATION AND A MINIMUM OF 4 FT WORKING CLEARANCE AROUND GENERATOR.
- NORMAL POWER SECONDARY CONCRETE ENCASED DUCTBANK. REFER TO SITE DETAILS SHEET FOR DUCTBANK DETAIL.
- EMERGENCY POWER CONCRETE ENCASED DUCTBANK. REFER TO SITE DETAILS SHEET FOR DUCTBANK DETAIL.
- STUB UP UNDERGROUND FEEDERS AND ROUTE VERTICALLY IN A CONCRETE ENCASED CHASE TO THE SECOND FLOOR EMERGENCY ELECTRICAL ROOM.
- TEMPORARY GENERATOR CONNECTION BOXES. SEE RISER DIAGRAM FOR DETAILS.
- FOR CONNECTION TO BACK FLOW PREVENTER HOT BOX LOCATED APPROXIMATELY 90 FT AWAY FROM EOC BUILDING. SEE CIVIL PLANS FOR EXACT LOCATION.
- FOR CONNECTION TO SITE LANDSCAPE AND BOLLARD LIGHTING. REFER TO THE LANDSCAPE DRAWINGS FOR FIXTURE TYPES, DESCRIPTIONS AND LOCATIONS.

PRICING NOTES:

- PROVIDE BUDGET ALLOWANCE FOR LABOR AND MATERIALS FOR INSTALLATION OF THE FOLLOWING SITE LIGHTING FIXTURES:
- LIGHTED BOLLARDS ALONG THE WEST SIDE OF THE PARK (EAST SIDE OF THE BUILDING). ASSUME 15' OC SPACING.
 - LIGHTED BOLLARDS FROM PARKING LOT TO EMPLOYEE ENTRANCE (NORTH VESTIBULE AT HUB). ASSUME 15' OC SPACING.
 - LIGHTED BOLLARDS AT REAR/SERVICE SIDE OF BUILDING (SOUTH SIDE OF HUB). ASSUME 12' OC SPACING.
 - LANDSCAPE LIGHTING IN PLANTER AREAS AROUND THE BUILDING.



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SHEET NAME:
ELECTRICAL POWER
SITE PLAN

DATE: 2020.12.16
CURRENT: 2021.01.08
ADDENDUM #2

SHEET:
E-100

GMP SET

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THE NEW HANOVER COUNTY, NORTH CAROLINA
PLUMBING DEPARTMENT HAS REVIEWED THIS
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PLUMBING CODE.


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GENERAL NOTES:

1. REFER TO ELECTRICAL SCHEDULES SHEETS FOR MECHANICAL EQUIPMENT CONNECTION SCHEDULES.
2. REFER TO ARCHITECTURAL DRAWINGS FOR EXACT DEVICE LOCATIONS AND MOUNTING HEIGHTS.
3. COORDINATE FLOOR BOX LOCATIONS FOR PRE-WIRED FURNITURE SYSTEMS WITH FURNITURE VENDOR AND ARCHITECT.
4. PROVIDE TAMPER-RESISTANT OUTLET TYPES IN BUSINESS OFFICES, CORRIDORS, WAITING ROOMS AND SIMILAR TYPE AREAS WITHIN MEDICAL OFFICE AREAS OF THE BUILDING PER NEC 406.12.

KEY NOTES:

- 1 FOR CONNECTION TO WATER COOLER/FOUNTAINS, CIRCUIT SHALL BE PROTECTED BY GFCI CIRCUIT BREAKER IN PANEL.
- 2 FOR CONNECTION TO AUTOMATIC FLUSH TOILETS AND FAUCETS TRANSFORMER POWER, COORDINATE LOCATION, CONNECTION REQUIREMENTS, AND QUANTITY WITH EQUIPMENT. REFER TO ARCHITECTURAL AND PLUMBING DRAWINGS FOR ADDITIONAL INFORMATION.

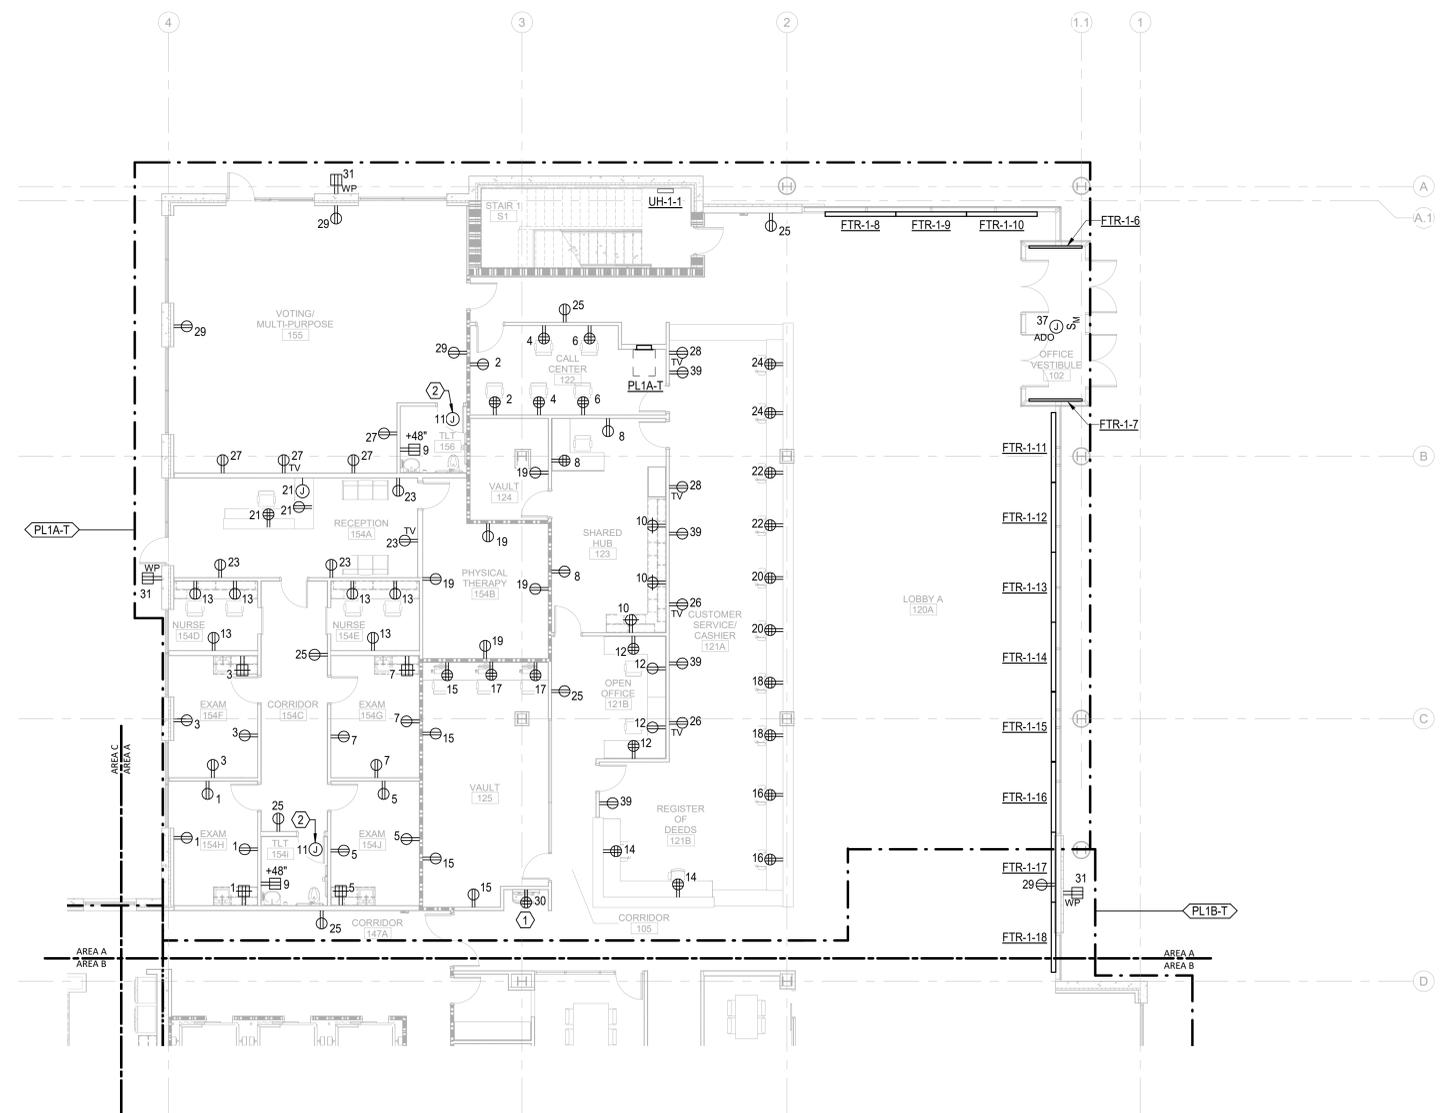

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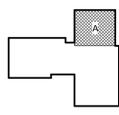
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KEY PLAN:



SHEET NAME:
ELECTRICAL POWER
FLOOR PLAN - LEVEL 1
- AREA A

DATE: 2020.12.16
CURRENT: 2021.01.08
ADDENDUM #2

SHEET:
E-101A

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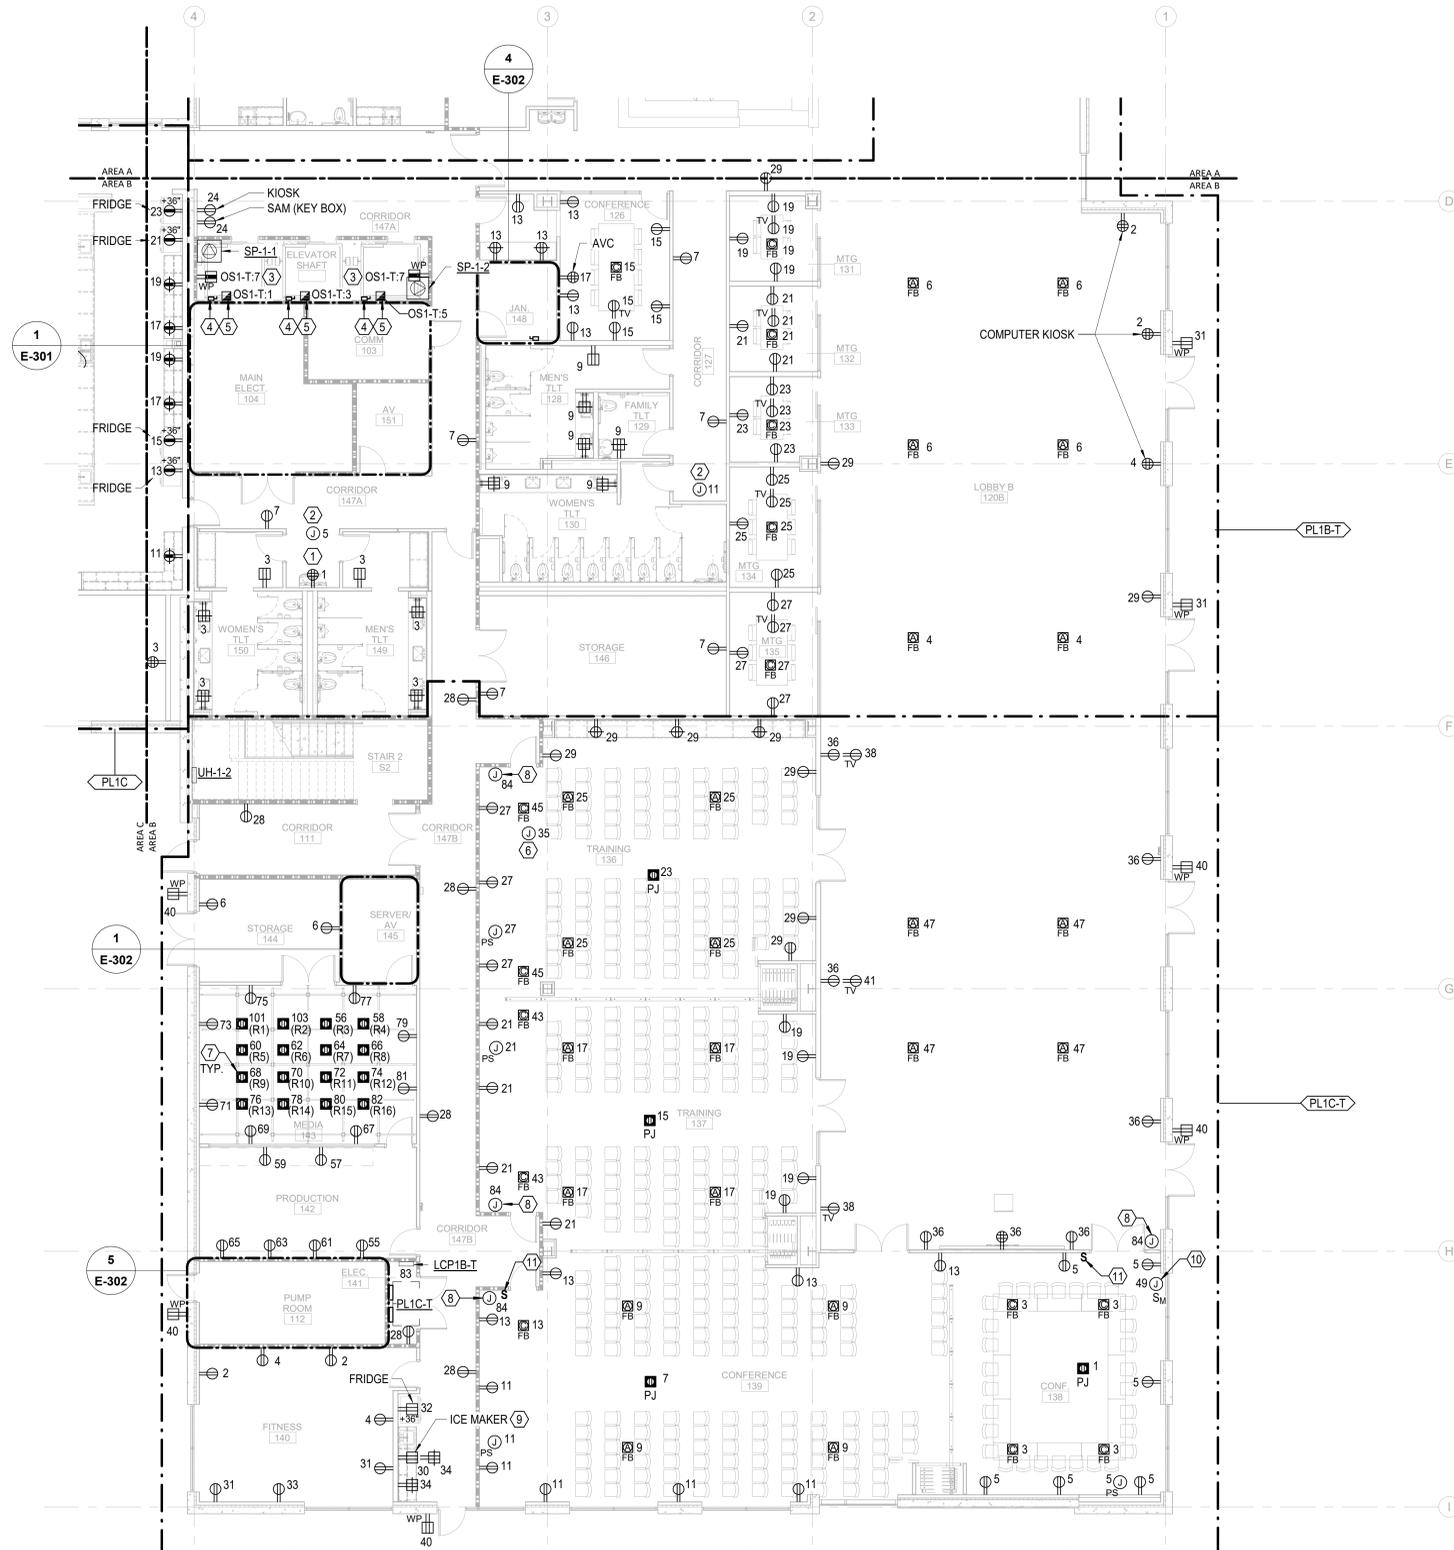
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GENERAL NOTES:

1. REFER TO ELECTRICAL SCHEDULES SHEETS FOR MECHANICAL EQUIPMENT CONNECTION SCHEDULES.
2. REFER TO ARCHITECTURAL DRAWINGS FOR EXACT DEVICE LOCATIONS AND MOUNTING HEIGHTS.
3. COORDINATE FLOOR BOX LOCATIONS FOR PRE-WIRED FURNITURE SYSTEMS WITH FURNITURE VENDOR AND ARCHITECT.

KEY NOTES:

- 1 FOR CONNECTION TO WATER COOLER/FOUNTAINS. CIRCUIT SHALL BE PROTECTED BY GFCI CIRCUIT BREAKER IN PANEL.
- 2 FOR CONNECTION TO AUTOMATIC FLUSH TOILETS AND FAUCETS TRANSFORMER POWER. COORDINATE LOCATION, CONNECTION REQUIREMENTS, AND QUANTITY WITH EQUIPMENT. REFER TO ARCHITECTURAL AND PLUMBING DRAWINGS FOR ADDITIONAL INFORMATION.
- 3 RECEPTACLE IN ELEVATOR PIT. INSTALL 24" AFG.
- 4 PROVIDE 480V, 30/3F DISCONNECT FOR ELEVATOR CONTROLLER. FINAL CONNECTIONS ARE BY ELEVATOR INSTALLER.
- 5 PROVIDE 20A/1 ENCLOSED CIRCUIT BREAKER FOR ELEVATOR CAB LIGHTING AND POWER. FINAL CONNECTIONS ARE BY ELEVATOR INSTALLER.
- 6 FOR CONNECTION TO FIRE SMOKE DAMPERS SERVING THE AREA. REFER TO DIV 23 DRAWINGS AND SPECIFICATIONS FOR EXACT LOCATIONS AND CONNECTION REQUIREMENTS.
- 7 PROVIDE DUPLEX RECEPTACLE MOUNTED TO PIPE GRID SYSTEM FOR SPECIALTY LIGHTING FIXTURE PLUG-IN CONNECTION. SPECIALTY LIGHTING FIXTURES ARE PROVIDED BY OWNER. COORDINATE EXACT OUTLET LOCATION WITH PIPE GRID SYSTEM PRIOR TO INSTALLATION. RECEPTACLE CIRCUIT SHALL BE AUTOMATICALLY CONTROLLED VIA LIGHTING CONTROL RELAY PANEL 'LCP1B-T' LOCATED IN ELECTRICAL CLOSET 141. RECEPTACLE CIRCUIT SHALL ALSO BE LOCALLY CONTROLLED VIA LOW VOLTAGE OVERRIDE SWITCH INDICATED ON LIGHTING PLAN.
- 8 FOR CONNECTION TO FRESKO MASTER LIGHTING CONTROLLER TOUCHSCREEN. REFER TO LIGHTING PLANS FOR DETAILS.
- 9 PROVIDE BLANK FACE SELF-TEST GFI OUTLET ABOVE COUNTER FOR GFI OUTLET BEHIND ICE MAKER. EQUIVALENT TO LEVITON GFRBG SERIES.
- 10 PROVIDE POWER TO SHADES/CONTROLLER. ELECTRICAL CONTRACTOR SHALL PROVIDE CONDUIT PATHWAYS FROM CONTROLLER TO SHADE MOTORS. REFER TO MANUFACTURER SUBMITTAL PACKAGE FOR FINAL LOCATIONS AND INSTALLATION REQUIREMENTS PRIOR TO ROUGH-IN.
- 11 ELECTRICAL CONTRACTOR SHALL PROVIDE BACKBOX FOR SWITCH AND CONDUIT WITH PULLSTRING BACK TO EACH CONTROLLER LOCATION FOR LOW VOLTAGE ELECTRICAL CONNECTIONS. LOW VOLTAGE SWITCH AND CABLING SHALL BE FURNISHED BY SHADE INSTALLER.



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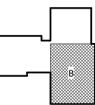
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B 2020.10.16	TI-DESIGN DEVELOPMENT
C 2020.12.16	GMP SET
D 2020.12.22	ADDENDUM #1
E 2021.01.08	ADDENDUM #2

KEY PLAN:



SHEET NAME:
ELECTRICAL POWER
FLOOR PLAN - LEVEL 1
- AREA B

DATE: 2020.12.16
CURRENT: 2021.01.08

ADDENDUM #2

SHEET:
E-101B

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1/7/2021 3:12:53 PM

1
E-101B ELECTRICAL POWER TI FLOOR PLAN - PARTIAL - LEVEL 1 - AREA B

1/8" = 1'-0"

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GMP SET

THE DATE SHOWN INDICATES THE DATE OF PUBLICATION AND NOT THE DATE OF THE ORIGINAL DRAWING.


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GENERAL NOTES:

1. REFER TO ELECTRICAL SCHEDULES SHEETS FOR MECHANICAL EQUIPMENT CONNECTION SCHEDULES.
2. REFER TO ARCHITECTURAL DRAWINGS FOR EXACT DEVICE LOCATIONS AND MOUNTING HEIGHTS.
3. COORDINATE FLOOR BOX LOCATIONS FOR PRE-WIRED FURNITURE SYSTEMS WITH FURNITURE VENDOR AND ARCHITECT.

KEY NOTES:

- 1 FOR CONNECTION TO AUTOMATIC FLUSH TOILETS AND FAUCETS TRANSFORMER POWER, COORDINATE LOCATION, CONNECTION REQUIREMENTS, AND QUANTITY WITH EQUIPMENT. REFER TO ARCHITECTURAL AND PLUMBING DRAWINGS FOR ADDITIONAL INFORMATION.
- 2 CONFIRM NEMA RECEPTACLE TYPE CONFIGURATION WITH ACTUAL EQUIPMENT PROVIDED.
- 3 COORDINATE CONNECTION REQUIREMENTS (PLUG IN OR HARDWIRED) WITH ACTUAL EQUIPMENT INSTALLED.
- 4 FOR CONNECTION TO GENERATOR BATTERY CHARGER, JACKET WATER HEATER, LTG AND RECEPTACLE LOADS.
- 5 FOR CONNECTION TO GENERATOR DOCKING STATION BATTERY CHARGER RECEPTACLE AND CONNECTION TO DOCKING STATION 50A TWIST-LOCK RECEPTACLE.
- 6 WHERE GFCI OUTLET LOCATIONS ARE NOT ACCESSIBLE, PROVIDE BLANK FACE SELF-TEST GFCI OUTLET IN ACCESSIBLE LOCATION, EQUIVALENT TO LEVITON GFRBF SERIES.
- 7 PROVIDE POWER TO (2) DOUBLE DUPLEX AND (1) DUPLEX RECEPTACLES LOCATED WITHIN WORKSTATION CASEWORK. COMPUTER CIRCUITS (DOUBLE DUPLEX RECEPTACLES) SHALL BE FED FROM THE UPS PANELS. ALL OTHER MISCELLANEOUS WORKSTATION LOADS SHALL BE FED FROM THE NON-UPS PANEL. COORDINATE ALL CONNECTION REQUIREMENTS AND BRANCH CIRCUIT ROUTING WITHIN THE FURNITURE STATION WITH MANUFACTURER'S SHOP DRAWINGS.
- 8 FOR CONNECTION TO GENERATOR FUEL PUMP. COORDINATE LOCATION IN FIELD.

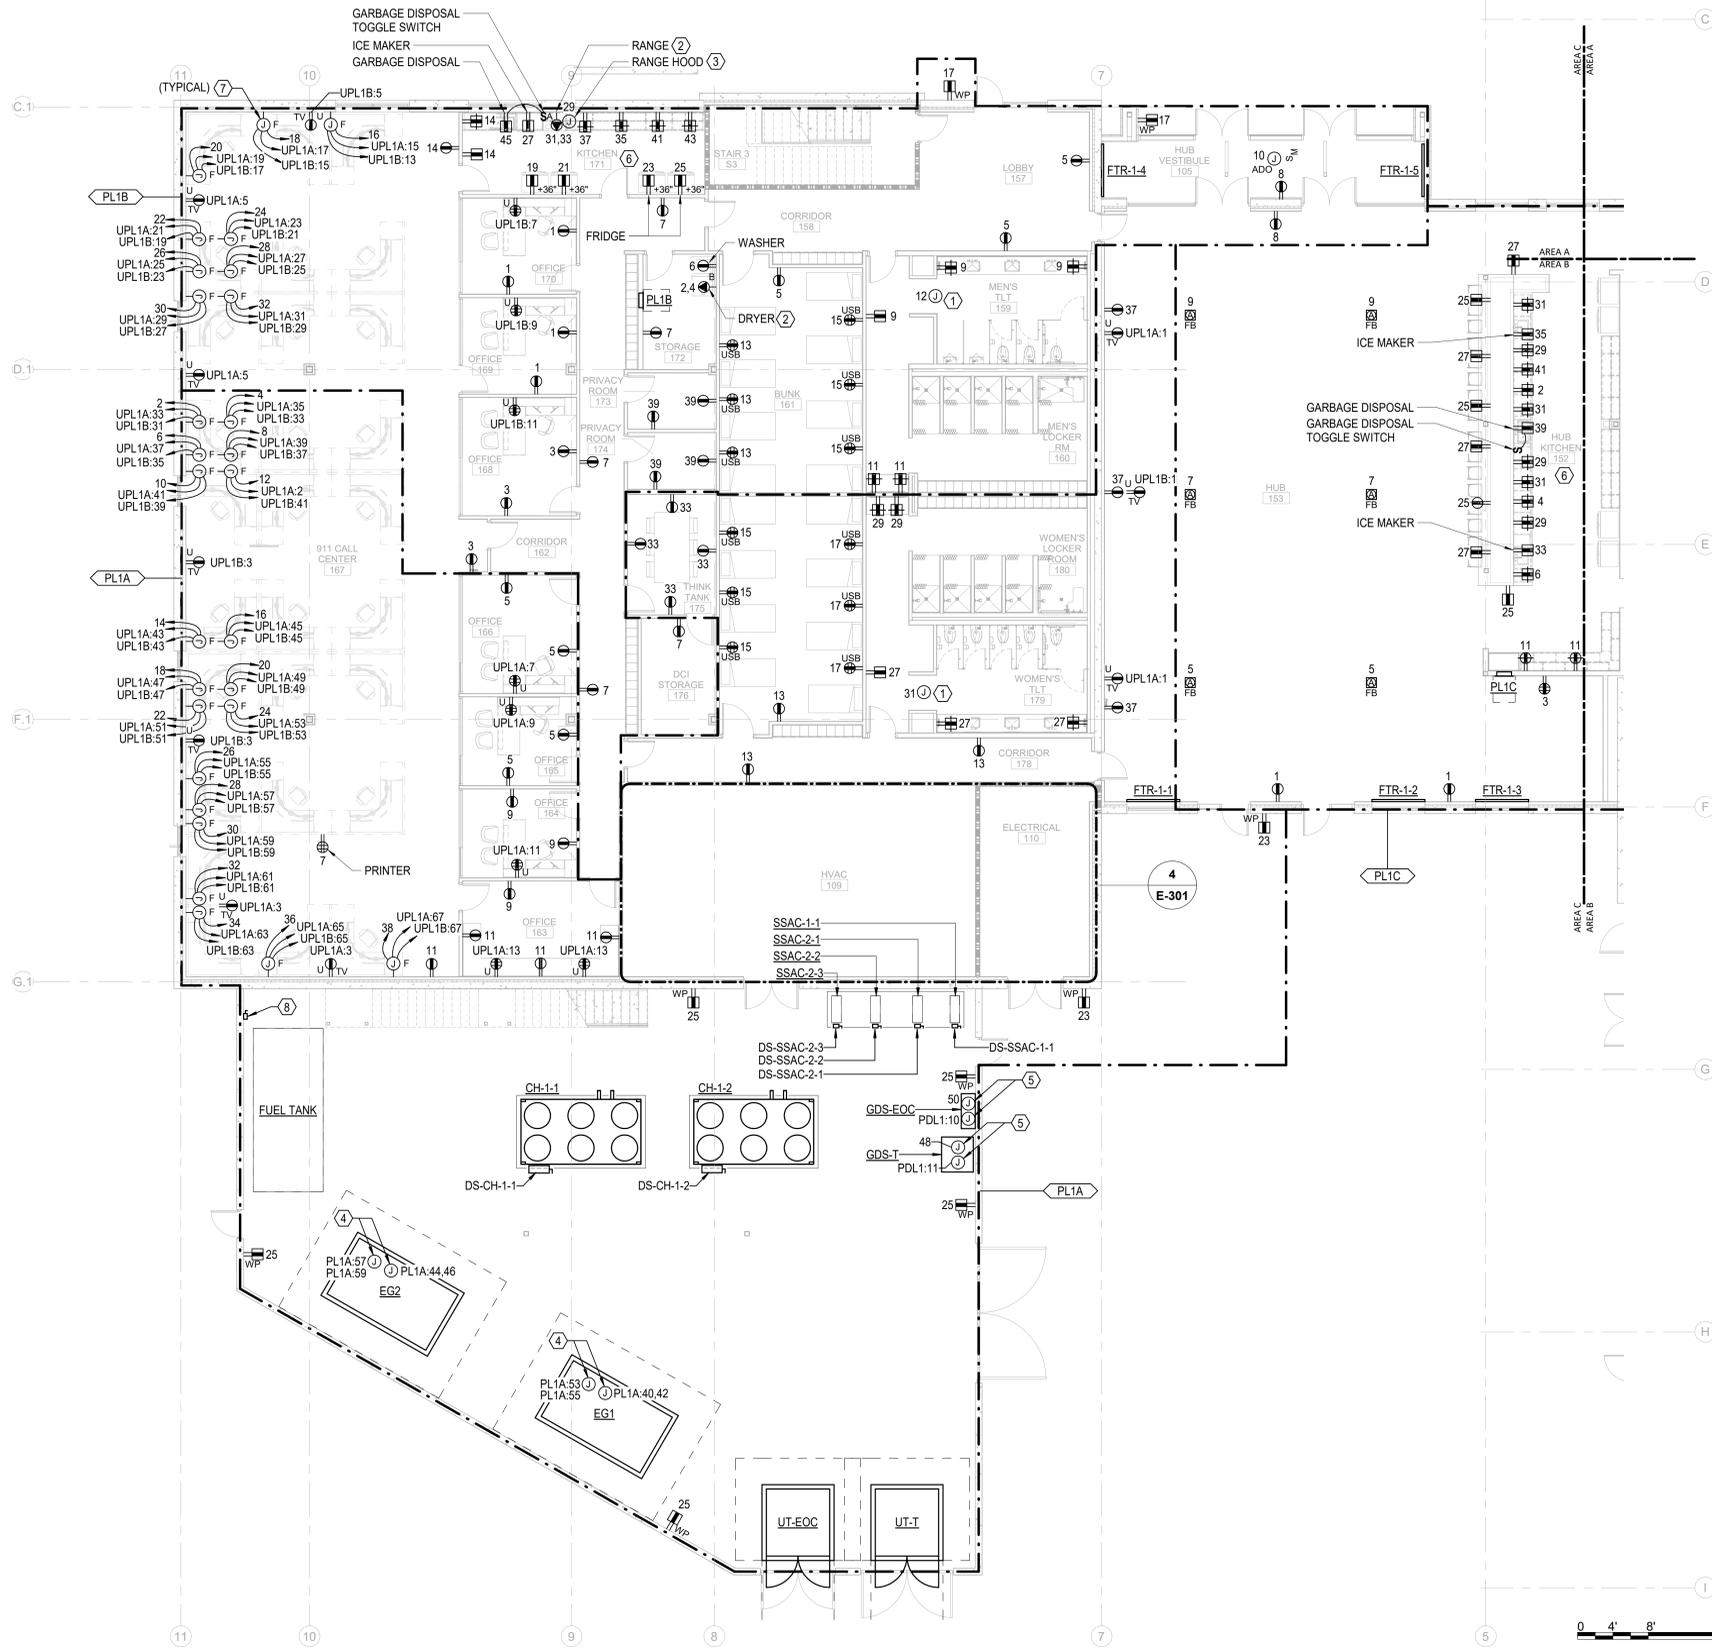

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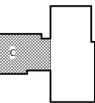
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KEY PLAN:



SHEET NAME:
ELECTRICAL POWER
FLOOR PLAN - LEVEL 1
- AREA C

DATE: 2020.12.16
CURRENT: 2021.01.08

ADDENDUM #2

SHEET:

E-101C

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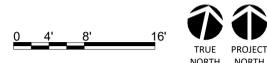
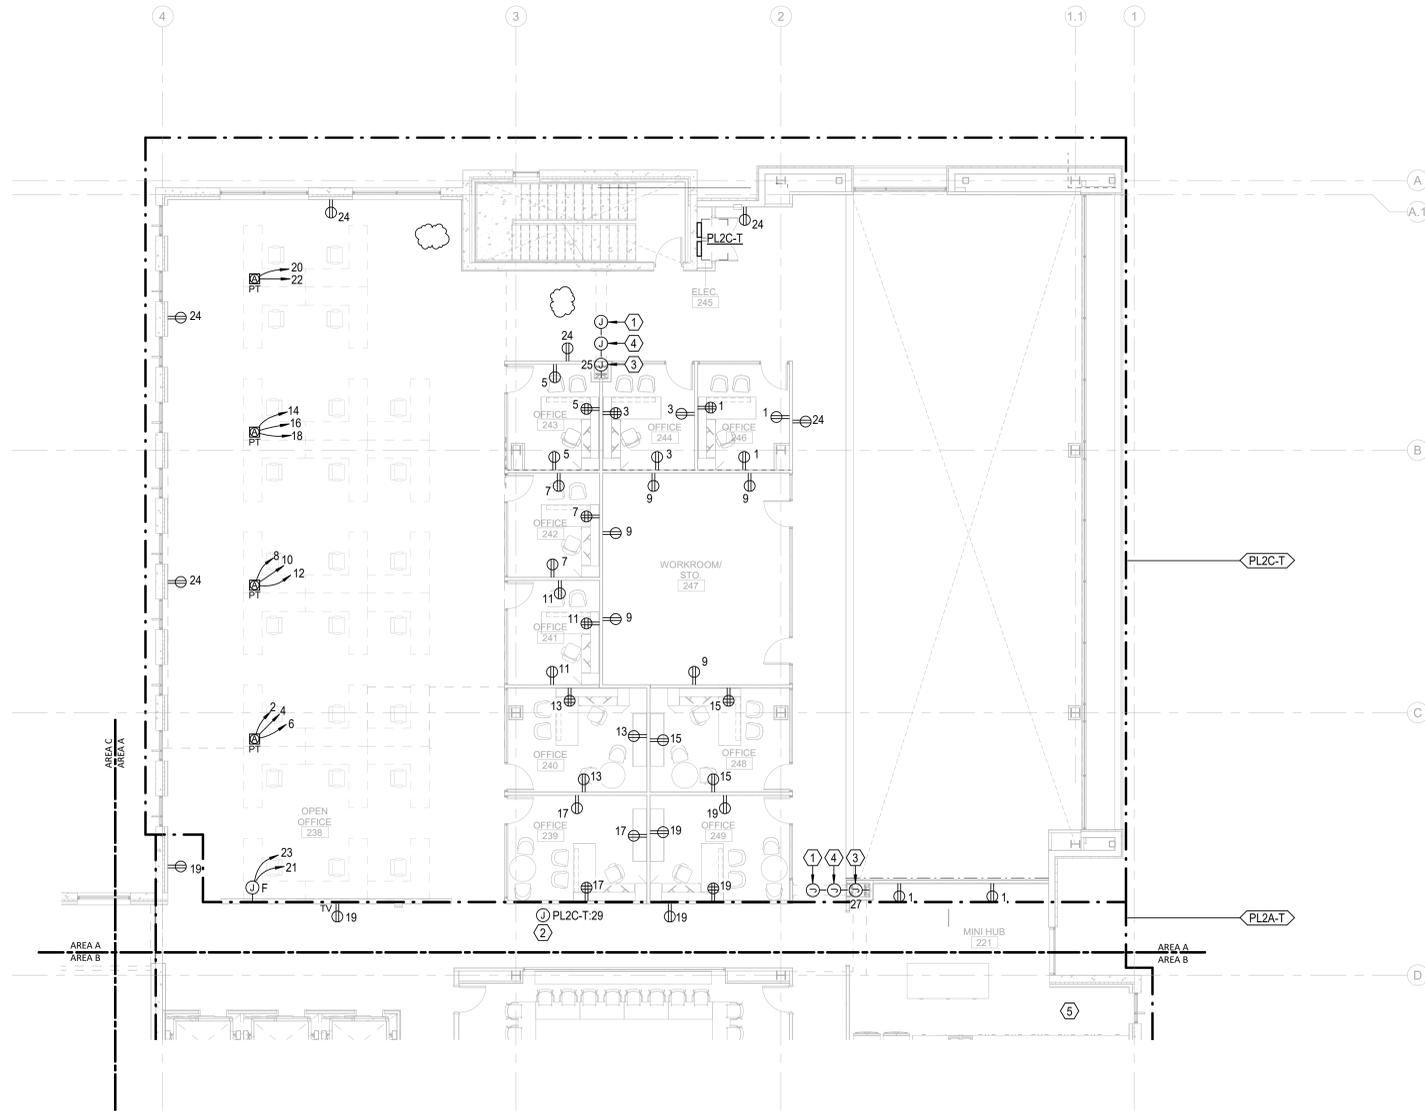
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GENERAL NOTES:

1. REFER TO ELECTRICAL SCHEDULES SHEETS FOR MECHANICAL EQUIPMENT CONNECTION SCHEDULES.
2. REFER TO ARCHITECTURAL DRAWINGS FOR EXACT DEVICE LOCATIONS AND MOUNTING HEIGHTS.
3. COORDINATE FLOOR BOX LOCATIONS FOR PRE-WIRED FURNITURE SYSTEMS WITH FURNITURE VENDOR AND ARCHITECT.

KEY NOTES:

1. PROVIDE RECESSED MOUNTED JUNCTION BOX FOR FIRE PARTITION KEY SWITCH AND OPTICAL OBSTRUCTION SENSOR (PROVIDED BY OTHERS). INSTALL KEY SWITCH JUNCTION BOX AT A MAXIMUM OF 5'-6" AFF. AND WITHIN LINE-OF-SIGHT OF PARTITION. PROVIDE AND INSTALL 3/4" CONDUIT AND WIRING PER THE MANUFACTURER'S REQUIREMENTS.
2. FOR CONNECTION TO FIRE SMOKE DAMPERS SERVING THE AREA. REFER TO DIV 23 DRAWINGS AND SPECIFICATIONS FOR EXACT LOCATIONS AND CONNECTION REQUIREMENTS.
3. FOR CONNECTION TO SLIDING FIRE PARTITION. INSTALL JUNCTION BOX AT 4'-6" AFF.
4. PROVIDE RECESS MOUNTED JUNCTION BOX FOR FIRE PARTITION RELAY/ALARM MODULE. INSTALL JUNCTION BOX AT 5'-0" AFF. PROVIDE AND INSTALL 3/4" CONDUIT AND WIRING PER THE MANUFACTURER'S REQUIREMENTS. COORDINATE WITH FIRE ALARM DRAWINGS.



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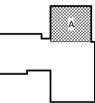
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KEY PLAN:



SHEET NAME:
 ELECTRICAL POWER
 FLOOR PLAN - LEVEL 2
 - AREA A

DATE: 2020.12.16
CURRENT: 2021.01.08

ADDENDUM #2

SHEET:
E-102A

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 T 919 783-7812
 Contact: Paul J. Kitchens
 N&B PROJECT: 19N342
 Firm License No. F-0312

1
 E-102A
 ELECTRICAL POWER TI FLOOR PLAN - PARTIAL - LEVEL 2 - AREA A

1/8" = 1'-0"

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GMP SET

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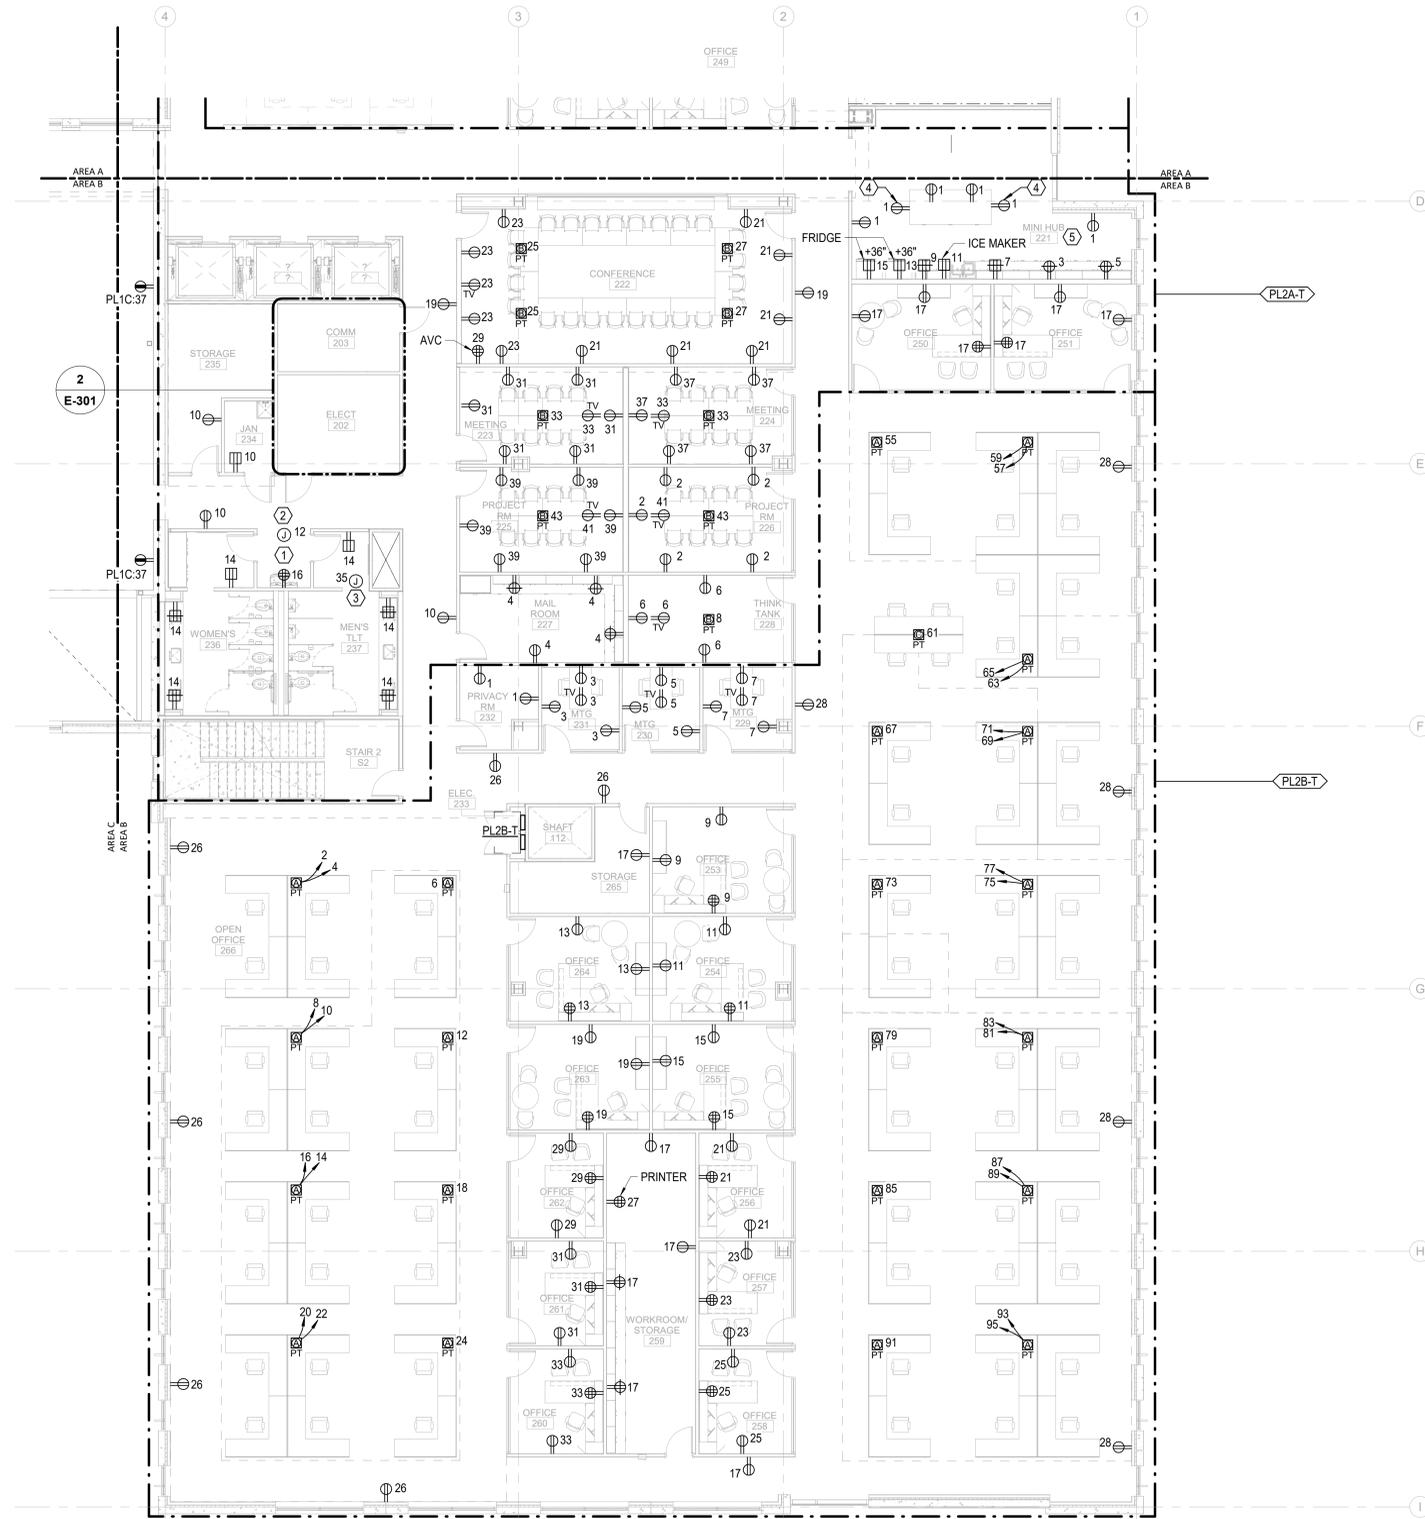
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GENERAL NOTES:

1. REFER TO ELECTRICAL SCHEDULES SHEETS FOR MECHANICAL EQUIPMENT CONNECTION SCHEDULES.
2. REFER TO ARCHITECTURAL DRAWINGS FOR EXACT DEVICE LOCATIONS AND MOUNTING HEIGHTS.
3. COORDINATE FLOOR BOX LOCATIONS FOR PRE-WIRED FURNITURE SYSTEMS WITH FURNITURE VENDOR AND ARCHITECT.

KEY NOTES:

- 1 FOR CONNECTION TO WATER COOLER/FOUNTAINS, CIRCUIT SHALL BE PROTECTED BY GFCI CIRCUIT BREAKER IN PANEL.
- 2 FOR CONNECTION TO AUTOMATIC FLUSH TOILETS AND FAUCETS TRANSFORMER POWER, COORDINATE LOCATION, CONNECTION REQUIREMENTS, AND QUANTITY WITH EQUIPMENT, REFER TO ARCHITECTURAL AND PLUMBING DRAWINGS FOR ADDITIONAL INFORMATION.
- 3 FOR CONNECTION TO FIRE SMOKE DAMPERS SERVING THE AREA, REFER TO DIV 23 DRAWINGS AND SPECIFICATIONS FOR EXACT LOCATIONS AND CONNECTION REQUIREMENTS.
- 4 COORDINATE MOUNTING HEIGHT OF ISLAND RECEPTACLE WITH ARCHITECT PRIOR TO INSTALLATION.
- 5 WHERE GFCI OUTLET LOCATIONS ARE NOT ACCESSIBLE, PROVIDE BLANK FACE SELF-TEST GFCI OUTLET IN ACCESSIBLE LOCATION, EQUIVALENT TO LEVITON GFRBF SERIES.



CAPE FEAR FD STONEWATER



101 NORTH THIRD STREET, SUITE 500
 WILMINGTON, NORTH CAROLINA 28401
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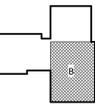
NHC Government Center 7702-190810

**NEW HANOVER COUNTY
 GOVERNMENT CENTER**
 GOVERNMENT CENTER DRIVE
 WILMINGTON, NC 28403

LS3P PROJECT: 7702-190810

DATE	DESCRIPTION
A 2020.08.18	TI-SCHEMATIC DESIGN
B 2020.10.16	TI-DESIGN DEVELOPMENT
C 2020.12.16	GMP SET
D 2020.12.22	ADDENDUM #1
E 2021.01.08	ADDENDUM #2

KEY PLAN:



SHEET NAME:
 ELECTRICAL POWER
 FLOOR PLAN - LEVEL 2
 - AREA B

DATE: 2020.12.16
CURRENT: 2021.01.08

ADDENDUM #2

SHEET:

E-102B

GMP SET

Newcomb & Boyd
 CONSULTANTS AND ENGINEERS
 Consulting Engineering Group
 5425 Page Rd
 Suite 215
 Durham, NC 27703
 T 919 783-7812
 Contact: Paul J. Kitchens
 N&B PROJECT: 19N342
 Firm License No. F-0312



1/7/2021 3:13:13 PM

1
E-102B ELECTRICAL POWER TI FLOOR PLAN - PARTIAL - LEVEL 2 - AREA B

1/8" = 1'-0"

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THE NEW HANOVER COUNTY ARCHITECTURAL RECORDING BOARD HAS REVIEWED THIS DRAWING FOR CONFORMANCE WITH THE RECORDING ACT.


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GENERAL NOTES:

1. REFER TO ELECTRICAL SCHEDULES SHEETS FOR MECHANICAL EQUIPMENT CONNECTION SCHEDULES.
2. REFER TO ARCHITECTURAL DRAWINGS FOR EXACT DEVICE LOCATIONS AND MOUNTING HEIGHTS.
3. COORDINATE FLOOR BOX LOCATIONS FOR PRE-WIRED FURNITURE SYSTEMS WITH FURNITURE VENDOR AND ARCHITECT.

KEY NOTES:

- ① FOR CONNECTION TO FIRE SMOKE DAMPERS SERVING THE AREA. REFER TO DIV 23 DRAWINGS AND SPECIFICATIONS FOR EXACT LOCATIONS AND CONNECTION REQUIREMENTS.

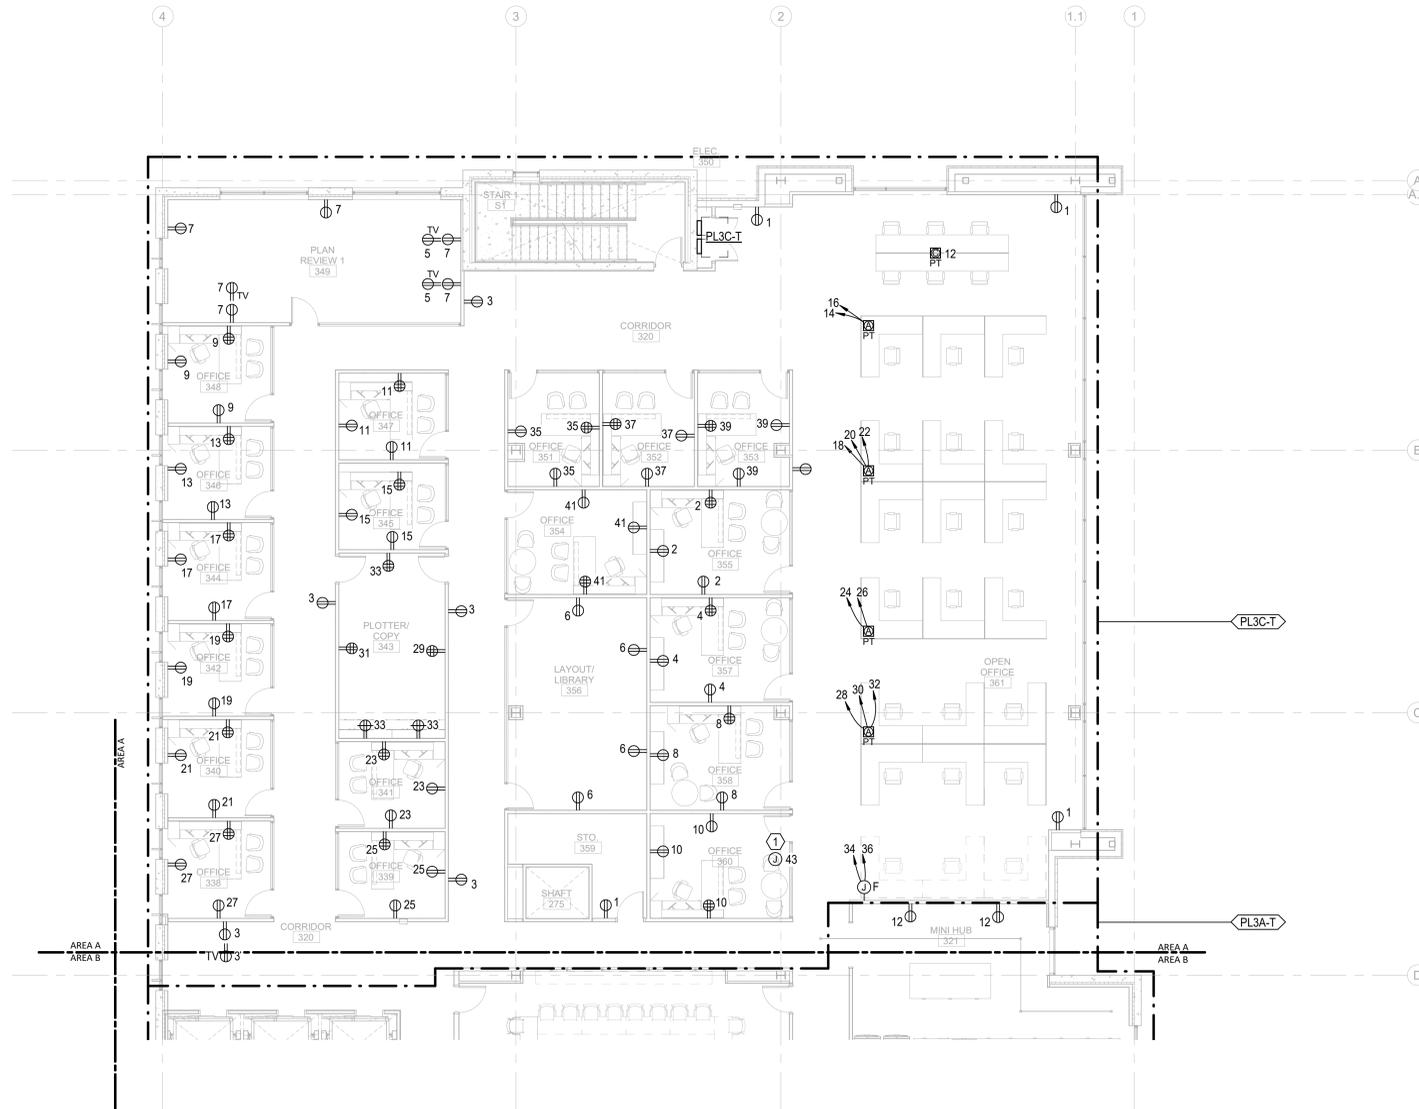

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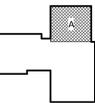
NHC Government Center 7702-190810

**NEW HANOVER COUNTY
 GOVERNMENT CENTER**
 GOVERNMENT CENTER DRIVE
 WILMINGTON, NC 28403

LS3P PROJECT: 7702-190810

A	DATE	DESCRIPTION
A	2020.08.18	TI- SCHEMATIC DESIGN
B	2020.10.16	TI- DESIGN DEVELOPMENT
C	2020.12.16	GMP SET
E	2021.01.08	ADDENDUM #2

KEY PLAN:



SHEET NAME:
 ELECTRICAL POWER
 FLOOR PLAN - LEVEL 3
 - AREA A

DATE: 2020.12.16
CURRENT: 2021.01.08

ADDENDUM #2

SHEET:

E-103A

GMP SET

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 Consulting Engineering Group
 5425 Page Rd
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 N&B PROJECT: 19N342
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1
 E-103A
ELECTRICAL POWER TI FLOOR PLAN - PARTIAL - LEVEL 3 - AREA A

1/8" = 1'-0"

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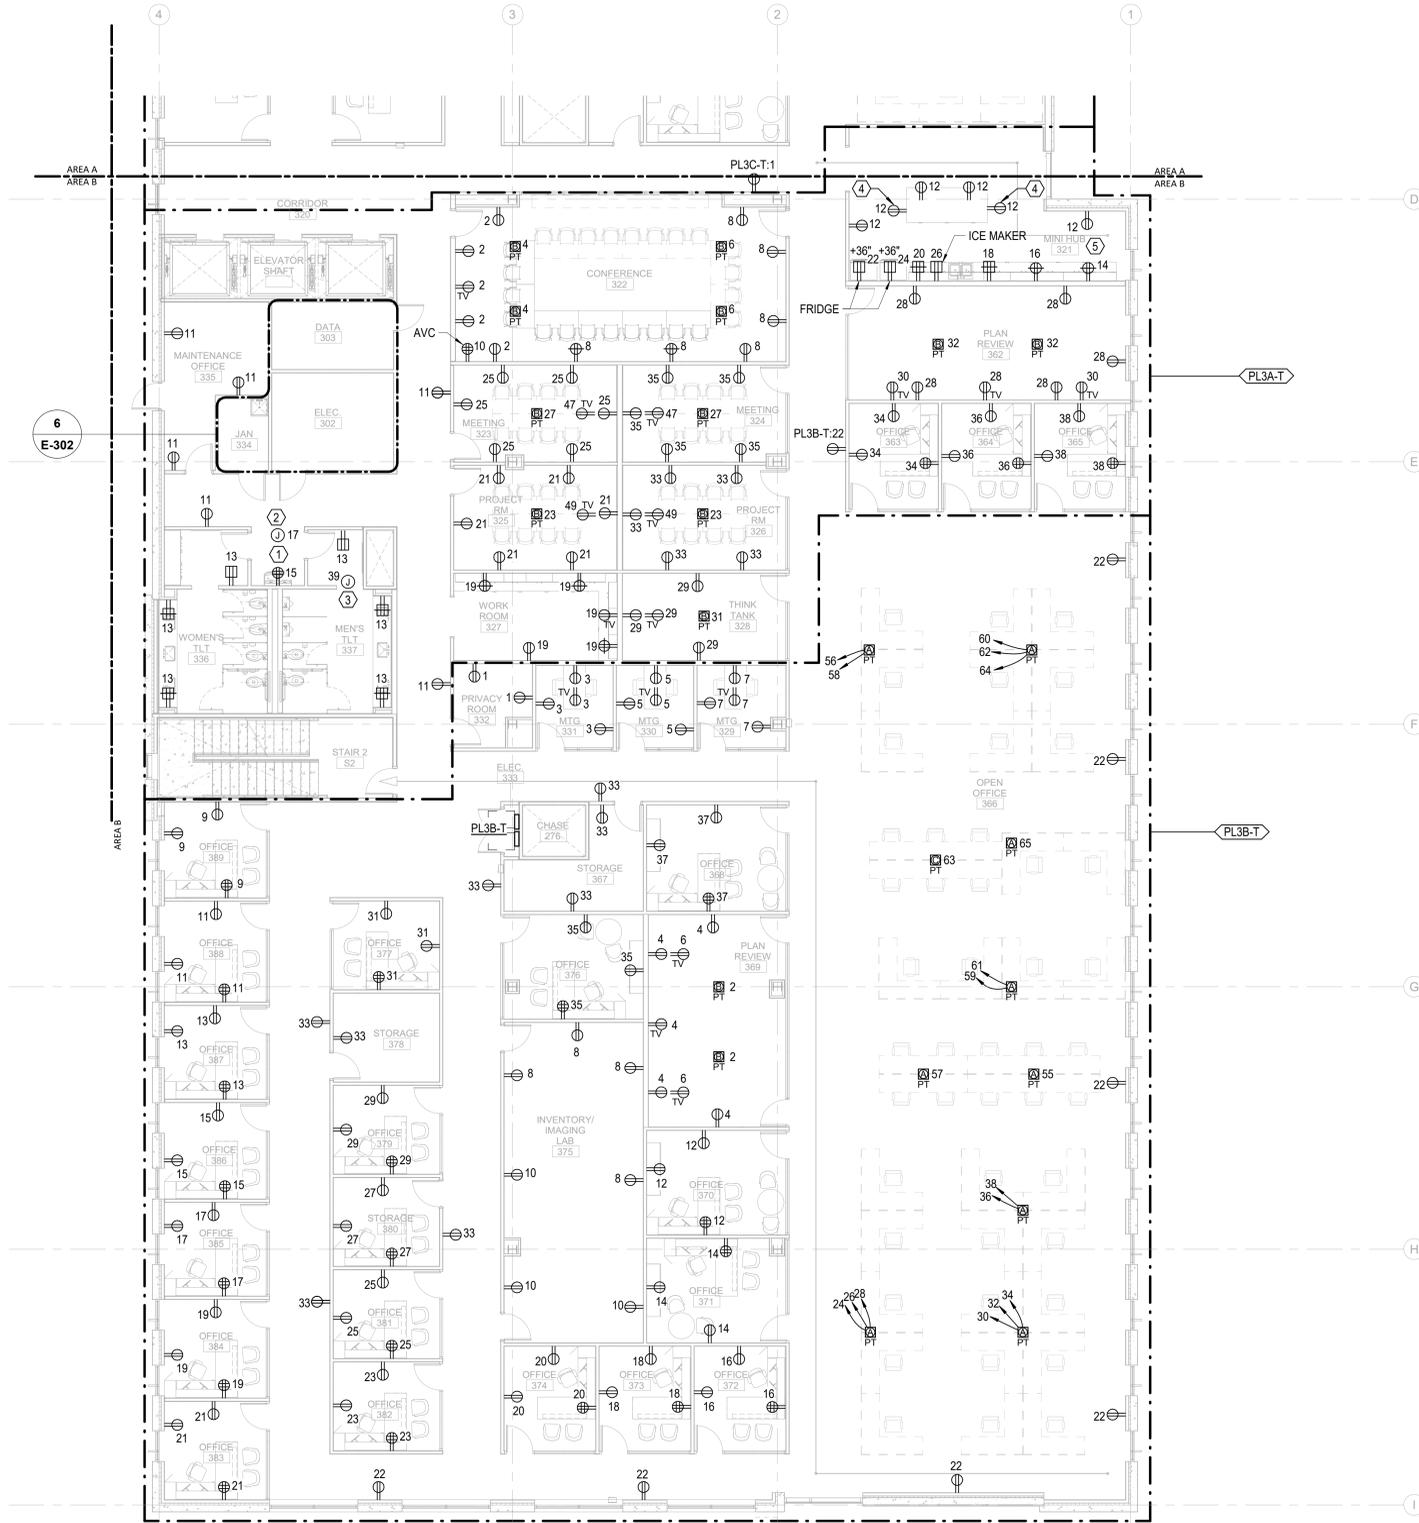
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GENERAL NOTES:

1. REFER TO ELECTRICAL SCHEDULES SHEETS FOR MECHANICAL EQUIPMENT CONNECTION SCHEDULES.
2. REFER TO ARCHITECTURAL DRAWINGS FOR EXACT DEVICE LOCATIONS AND MOUNTING HEIGHTS.
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- ② FOR CONNECTION TO AUTOMATIC FLUSH TOILETS AND FAUCETS TRANSFORMER POWER, COORDINATE LOCATION, CONNECTION REQUIREMENTS, AND QUANTITY WITH EQUIPMENT. REFER TO ARCHITECTURAL AND PLUMBING DRAWINGS FOR ADDITIONAL INFORMATION.
- ③ FOR CONNECTION TO FIRE SMOKE DAMPERS SERVING THE AREA. REFER TO DIV 23 DRAWINGS AND SPECIFICATIONS FOR EXACT LOCATIONS AND CONNECTION REQUIREMENTS.
- ④ COORDINATE MOUNTING HEIGHT OF ISLAND RECEPTACLE WITH ARCHITECT PRIOR TO INSTALLATION.
- ⑤ WHERE GFCI OUTLET LOCATIONS ARE NOT ACCESSIBLE, PROVIDE BLANK FACE SELF-TEST GFCI OUTLET IN ACCESSIBLE LOCATION, EQUIVALENT TO LEVITON GFRFB SERIES.



CAPE FEAR FD STONEWATER



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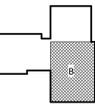
NHC Government Center 7702-190810

**NEW HANOVER COUNTY
GOVERNMENT CENTER**
GOVERNMENT CENTER DRIVE
WILMINGTON, NC 28403

LS3P PROJECT: 7702-190810

A	DATE	DESCRIPTION
A	2020.08.18	TI-SCHEMATIC DESIGN
B	2020.10.16	TI-DESIGN DEVELOPMENT
C	2020.12.16	GMP SET
D	2020.12.22	ADDENDUM #1
E	2021.01.08	ADDENDUM #2

KEY PLAN:



SHEET NAME:
ELECTRICAL POWER
FLOOR PLAN - LEVEL 3
- AREA B

DATE: 2020.12.16
CURRENT: 2021.01.08

ADDENDUM #2

SHEET:

E-103B

GMP SET

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Consulting Engineering Group
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Suite 215
Durham, NC 27703
T 919 783-7812
Contact: Paul J. Kitchens
N&B PROJECT: 19N342
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1/8" = 1'-0"

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E-103B
ELECTRICAL POWER TI FLOOR PLAN - PARTIAL - LEVEL 3 - AREA B

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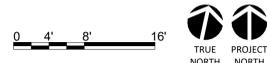
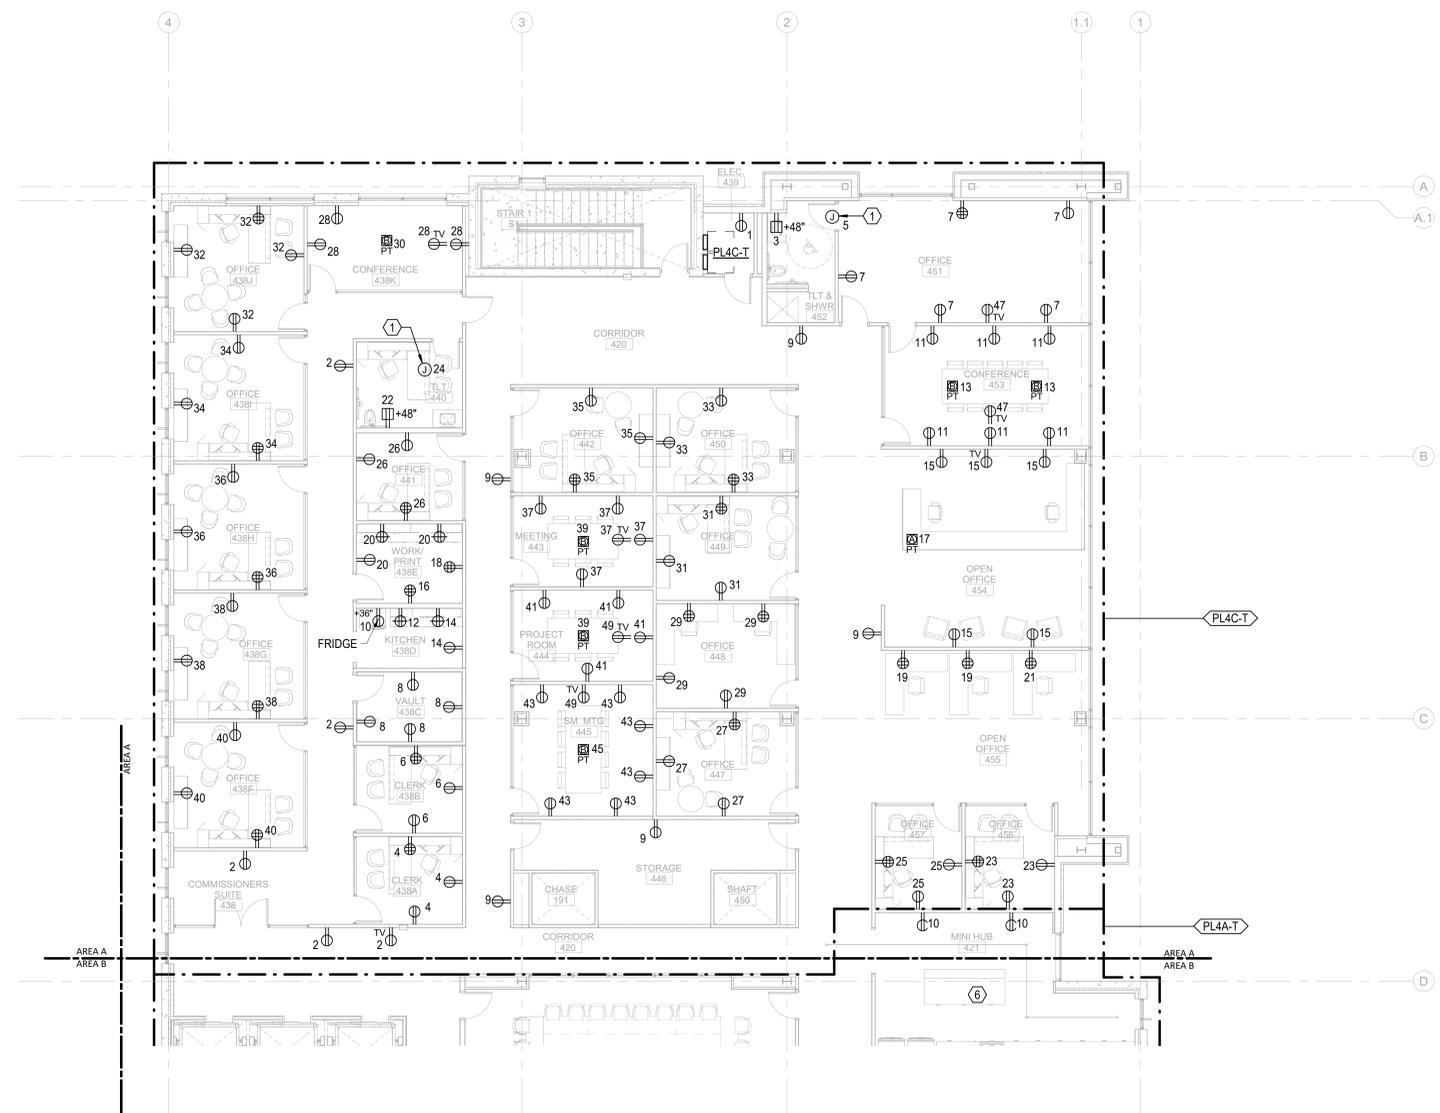
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1 E-104A ELECTRICAL POWER TI FLOOR PLAN - PARTIAL - LEVEL 4 - AREA A



GENERAL NOTES:

1. REFER TO ELECTRICAL SCHEDULES SHEETS FOR MECHANICAL EQUIPMENT CONNECTION SCHEDULES.
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KEY NOTES:

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CAPE FEAR FD STONEWATER




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NHC Government Center 7702-190810

**NEW HANOVER COUNTY
 GOVERNMENT CENTER**
 GOVERNMENT CENTER DRIVE
 WILMINGTON, NC 28403
 LS3P PROJECT: 7702-190810

A	DATE	DESCRIPTION
A	2020.08.18	TI- SCHEMATIC DESIGN
B	2020.10.16	TI- DESIGN DEVELOPMENT
C	2020.12.16	GMP SET
D	2020.12.22	ADDENDUM #1
E	2021.01.08	ADDENDUM #2



SHEET NAME:
 ELECTRICAL POWER
 FLOOR PLAN - LEVEL 4
 - AREA A

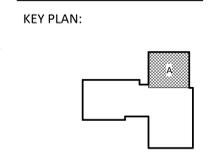DATE: 2020.12.16
CURRENT: 2021.01.08
 ADDENDUM #2

SHEET:
E-104A

Newcomb & Boyd
 CONSULTANTS AND ENGINEERS
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 Suite 215
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 Contact: Paul J. Kitchens
 N&B PROJECT: 19N342
 Firm License No. F-0312

GMP SET

THE NEW HANOVER ADVISORY BOARD HAS REVIEWED THIS DRAWING FOR CONFORMANCE WITH THE NEW HANOVER COUNTY ZONING ORDINANCES.


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GENERAL NOTES:

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2. REFER TO ARCHITECTURAL DRAWINGS FOR EXACT DEVICE LOCATIONS AND MOUNTING HEIGHTS.
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- 2 FOR CONNECTION TO AUTOMATIC FLUSH TOILETS AND FAUCETS TRANSFORMER POWER, COORDINATE LOCATION, CONNECTION REQUIREMENTS, AND QUANTITY WITH EQUIPMENT. REFER TO ARCHITECTURAL AND PLUMBING DRAWINGS FOR ADDITIONAL INFORMATION.
- 3 INSTALL RECEPTACLE AT TOP OF ELEVATOR SHAFT.
- 4 FOR CONNECTION TO FIRE SMOKE DAMPERS SERVING THE AREA. REFER TO DIV 23 DRAWINGS AND SPECIFICATIONS FOR EXACT LOCATIONS AND CONNECTION REQUIREMENTS.
- 5 COORDINATE MOUNTING HEIGHT OF ISLAND RECEPTACLE WITH ARCHITECT PRIOR TO INSTALLATION.
- 6 WHERE GFCI OUTLET LOCATIONS ARE NOT ACCESSIBLE, PROVIDE BLANK FACE SELF-TEST GFCI OUTLET IN ACCESSIBLE LOCATION, EQUIVALENT TO LEVITON GFRBF SERIES.



CAPE FEAR FD STONEWATER

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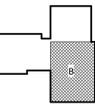
NHC Government Center 7702-190810

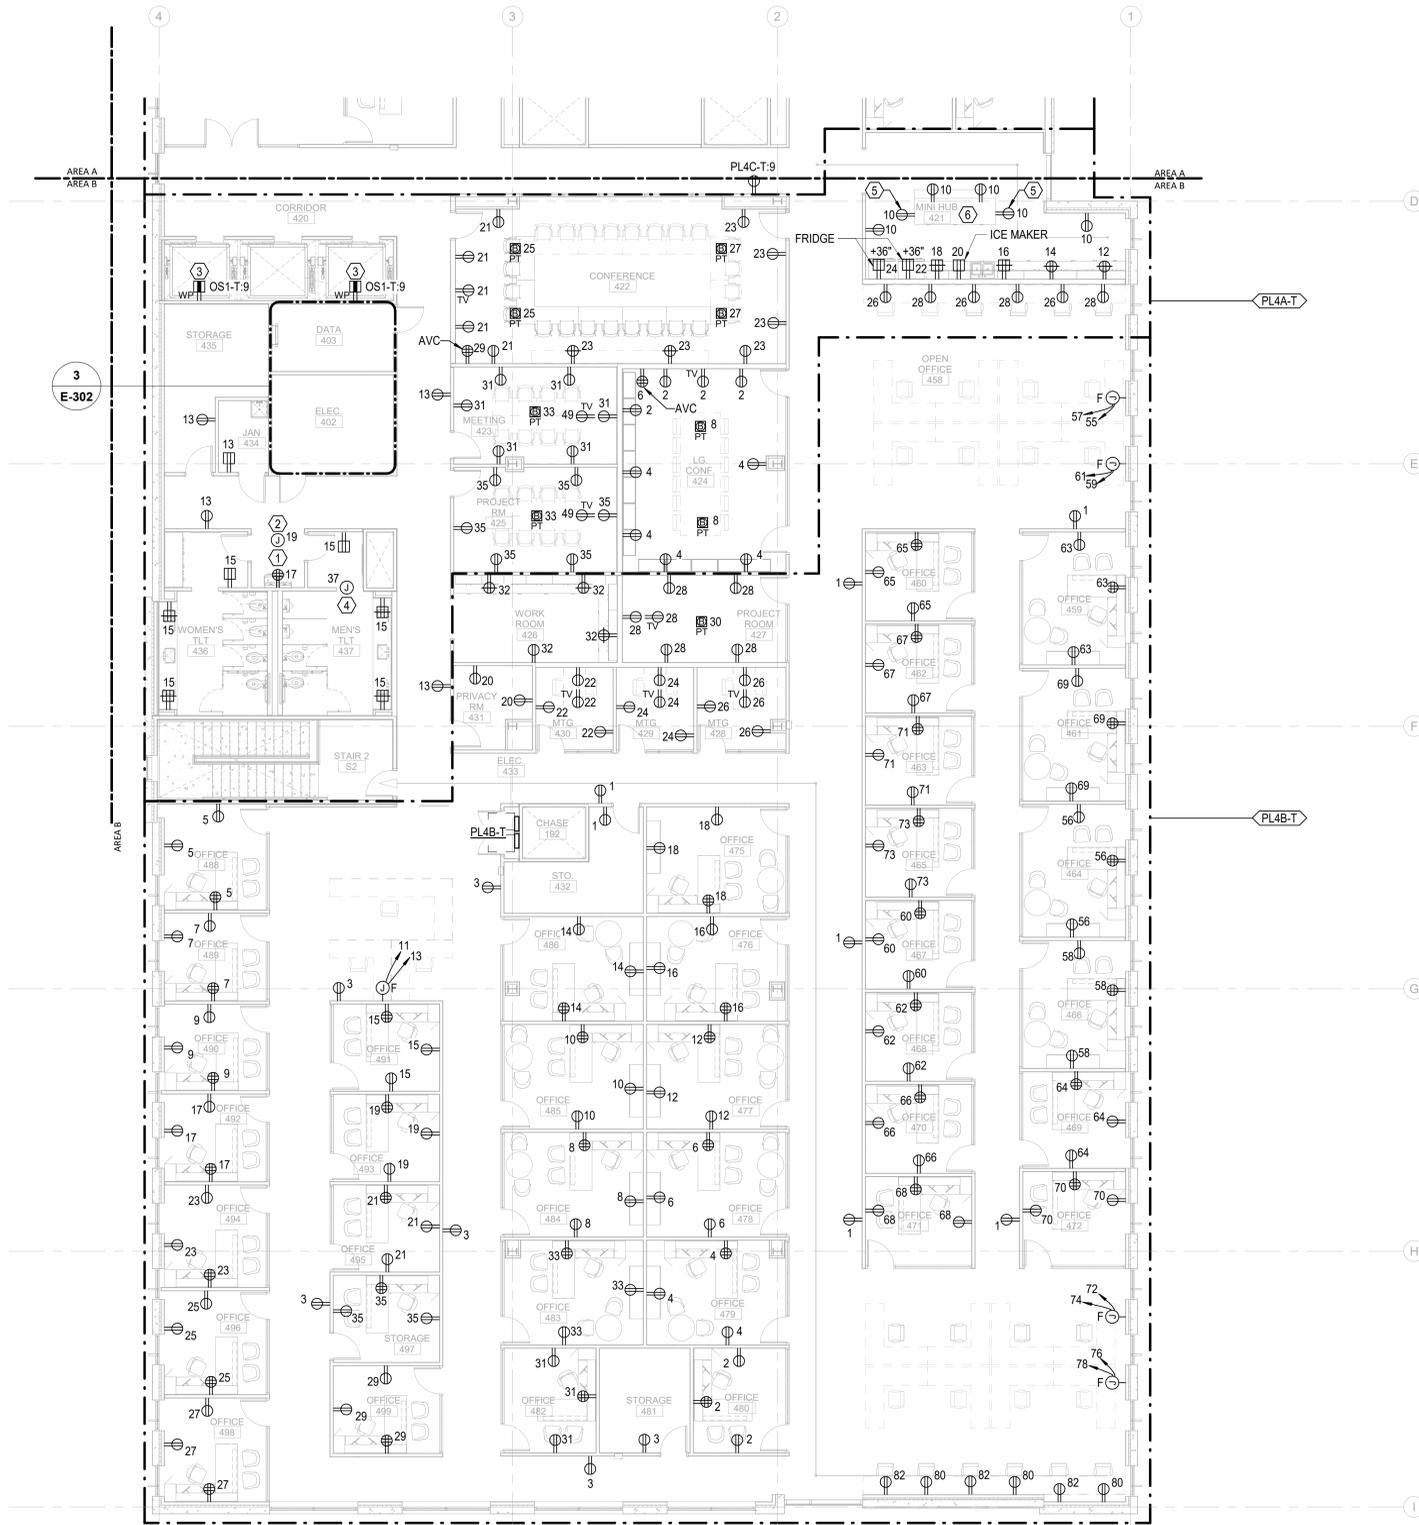**NEW HANOVER COUNTY
 GOVERNMENT CENTER**
 GOVERNMENT CENTER DRIVE
 WILMINGTON, NC 28403

LS3P PROJECT: 7702-190810

A	DATE	DESCRIPTION
A	2020.08.18	TI-SCHEMATIC DESIGN
B	2020.10.16	TI-DESIGN DEVELOPMENT
C	2020.12.16	GMP SET
D	2020.12.22	ADDENDUM #1
E	2021.01.08	ADDENDUM #2

KEY PLAN:



SHEET NAME:
 ELECTRICAL POWER
 FLOOR PLAN - LEVEL 4
 - AREA B

DATE: 2020.12.16
CURRENT: 2021.01.08

ADDENDUM #2

SHEET:

E-104B

GMP SET

Newcomb & Boyd
 CONSULTANTS AND ENGINEERS
 Consulting Engineering Group
 5425 Page Rd
 Suite 215
 Durham, NC 27703
 T 919 783-7812
 Contact: Paul J. Kitchens
 N&B PROJECT: 19N342
 Firm License No. F-0312

0' 4' 8' 16'



1/8" = 1'-0"

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E-104B

ELECTRICAL POWER TI FLOOR PLAN - PARTIAL - LEVEL 4 - AREA B

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THE NEW HANOVER COUNTY
PROJECT INFORMATION SHEET

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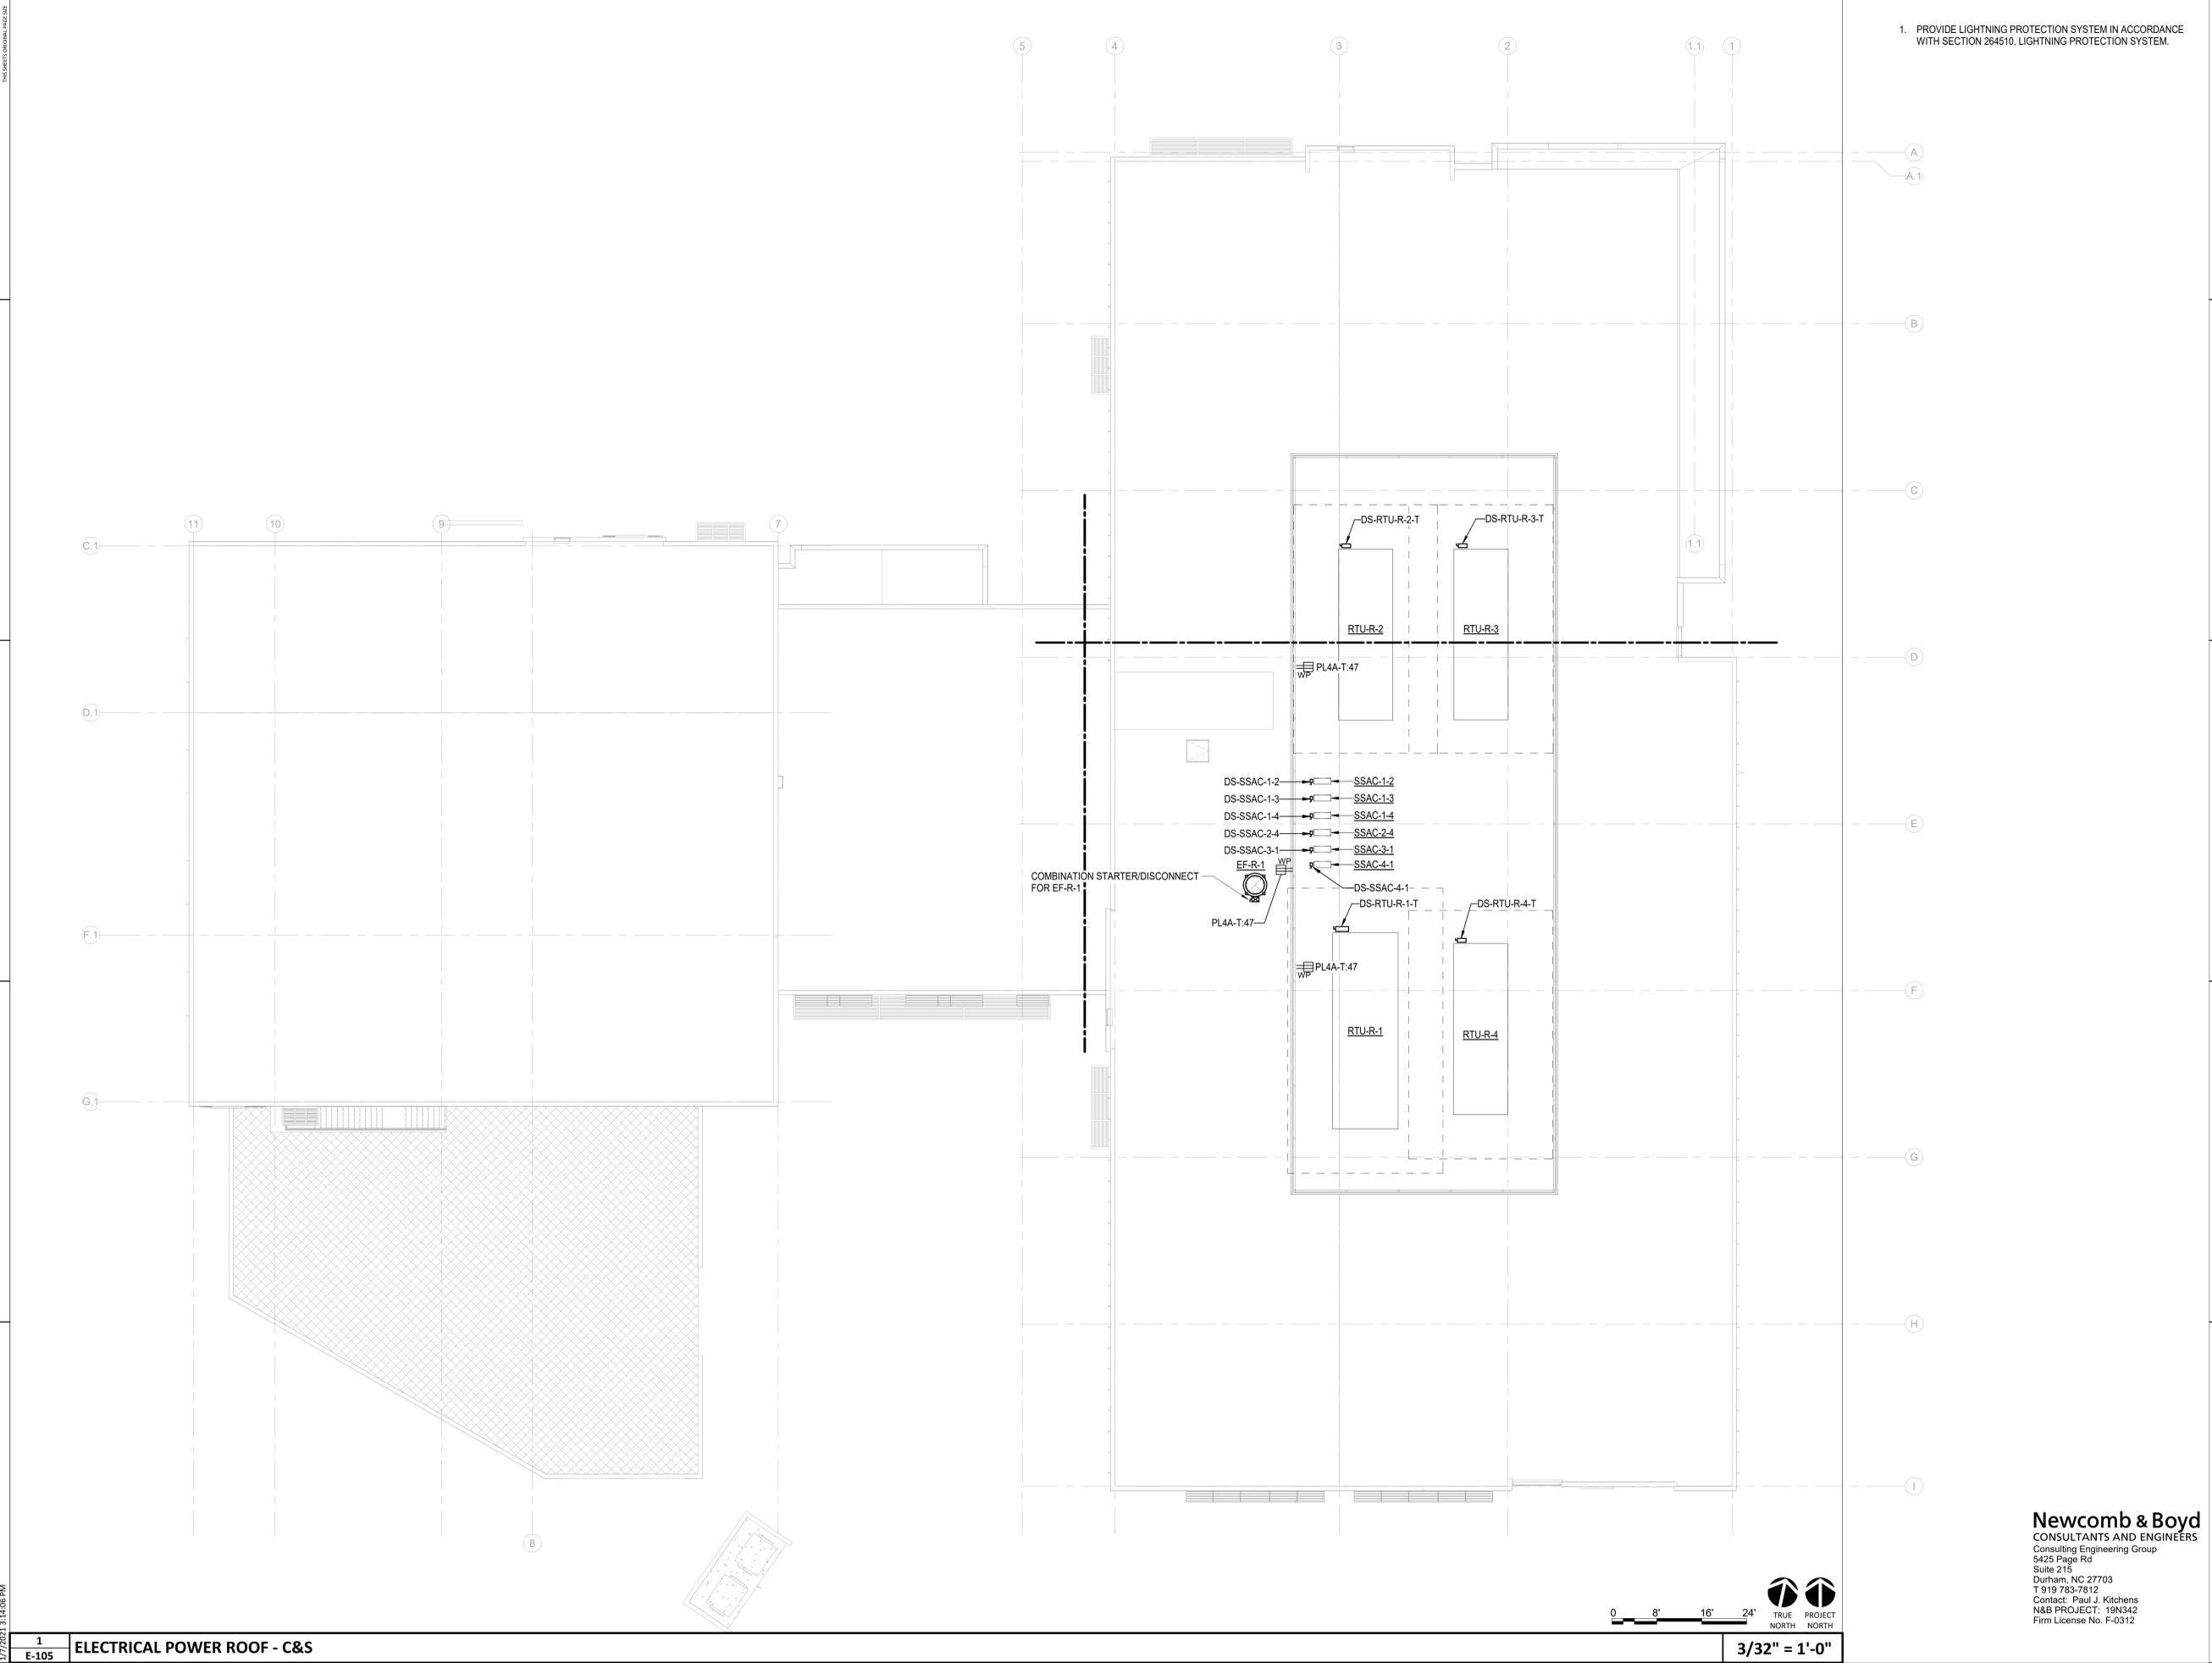
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GENERAL NOTES:

1. PROVIDE LIGHTNING PROTECTION SYSTEM IN ACCORDANCE WITH SECTION 264510, LIGHTNING PROTECTION SYSTEM.



CAPE FEAR FD STONEWATER



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WILMINGTON, NORTH CAROLINA 28401
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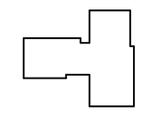
NOT FOR
CONSTRUCTION

NHC Government Center 7702-190810

**NEW HANOVER COUNTY
GOVERNMENT CENTER**
GOVERNMENT CENTER DRIVE
WILMINGTON, NC 28403

Δ	DATE	DESCRIPTION
A	2020.08.18	TI- SCHEMATIC DESIGN
B	2020.10.16	TI- DESIGN DEVELOPMENT
C	2020.12.16	GMP SET
E	2021.01.08	ADDENDUM #2

KEY PLAN:



SHEET NAME:
ELECTRICAL POWER
ROOF PLAN - OVERALL

Newcomb & Boyd
CONSULTANTS AND ENGINEERS
Consulting Engineering Group
5425 Page Rd
Suite 215
Durham, NC 27703
T 919 783-7812
Contact: Paul J. Kitchens
N&B PROJECT: 19N342
Firm License No. F-0312

DATE: 2020.12.16
CURRENT: 2021.01.08
ADDENDUM #2

SHEET:
E-105

1
E-105 ELECTRICAL POWER ROOF - C&S



3/32" = 1'-0"

GMP SET



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NHC Government Center 7702-190810

NEW HANOVER COUNTY GOVERNMENT CENTER

GOVERNMENT CENTER DRIVE
WILMINGTON, NC 28403

LS3P PROJECT: 7702-190810

DATE	DESCRIPTION
A 2020.08.18	TI- SCHEMATIC DESIGN
B 2020.10.16	TI- DESIGN DEVELOPMENT
C 2020.12.16	GMP SET
D 2020.12.22	ADDENDUM #1
E 2021.01.08	ADDENDUM #2

SHEET NAME:
ELECTRICAL POWER
TERMINAL UNIT
FLOOR PLAN - LEVEL 1

DATE: 2020.12.16
CURRENT: 2021.01.08

ADDENDUM #2

SHEET:

E-111


GMP SET

GENERAL NOTES:

- REFER TO ELECTRICAL SCHEDULES SHEETS FOR MECHANICAL AND PLUMBING EQUIPMENT CONNECTION SCHEDULES.
- REFER TO MECHANICAL, PLUMBING, AND FIRE ALARM DRAWINGS FOR ADDITIONAL EQUIPMENT REQUIRING POWER NOT SHOWN ON FLOOR PLANS.

KEY NOTES:

- JUNCTION BOX FOR 120V HVAC TERMINAL UNITS CONTROL/DAMPER POWER. REFER TO MECHANICAL DRAWINGS FOR UNIT LOCATIONS AND QUANTITIES. COORDINATE LOCATIONS AND LOADS OF ALL CONNECTION POINTS WITH DIVISION 23.

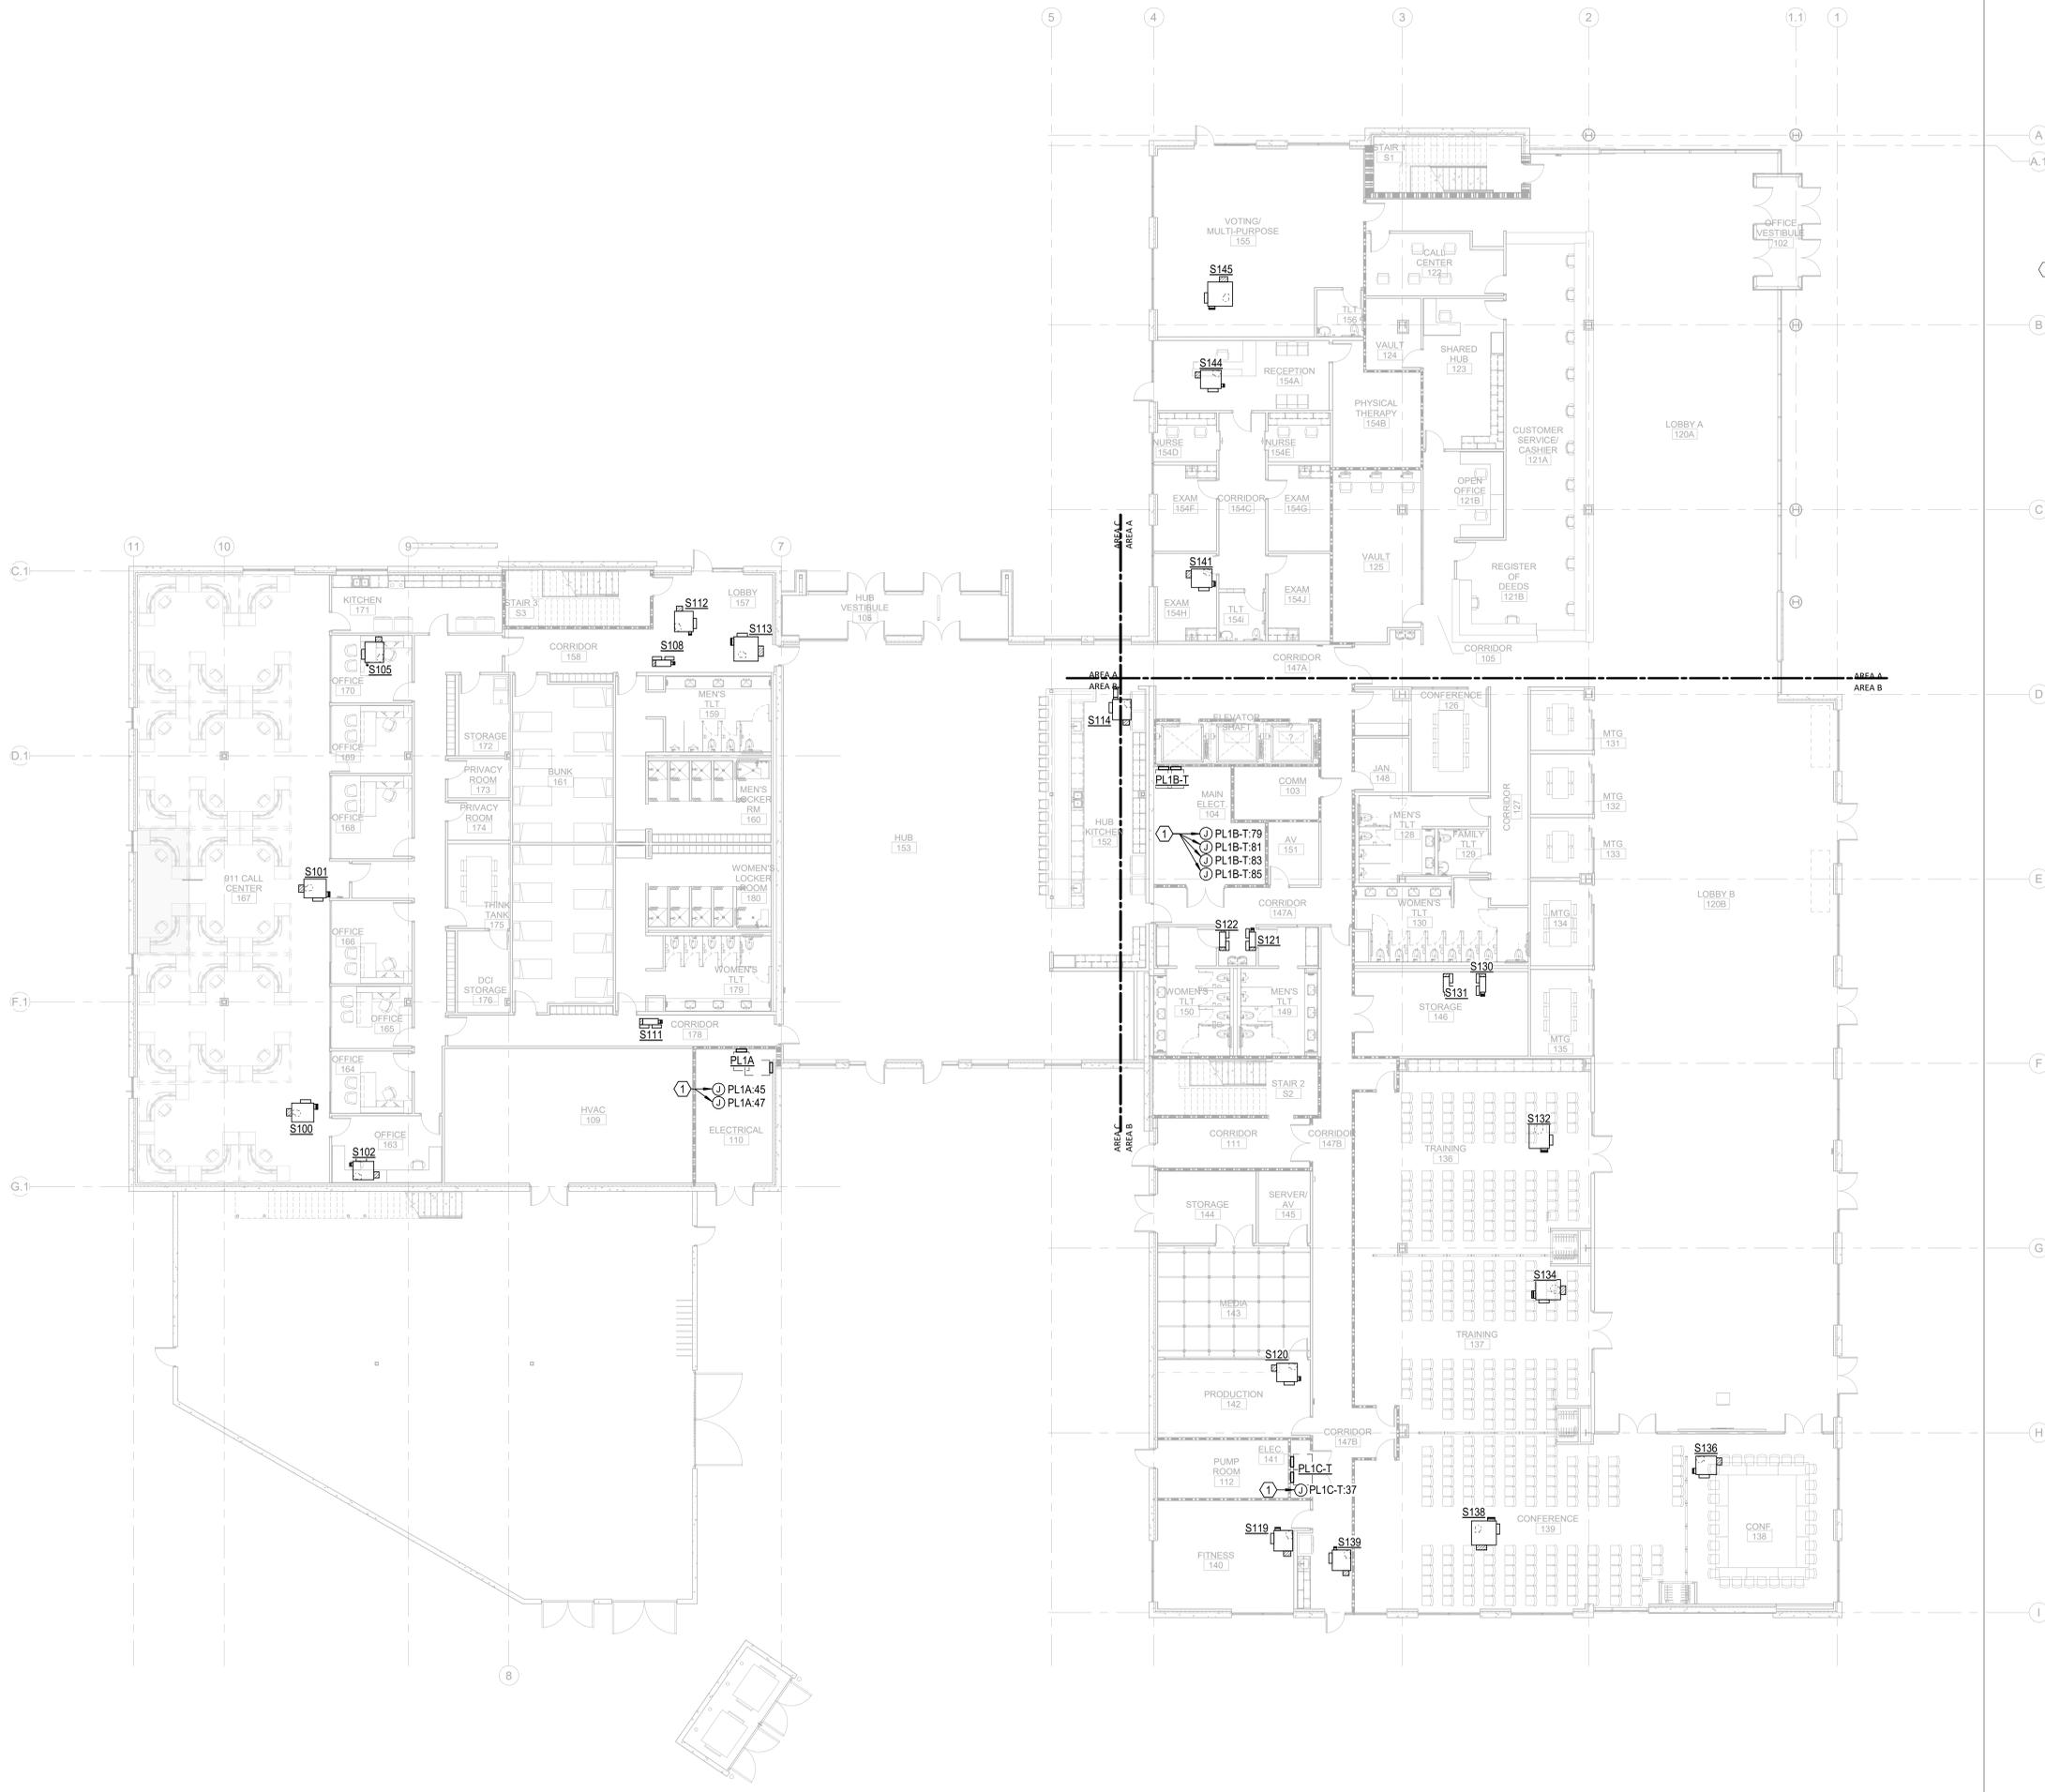

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Consulting Engineering Group
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Firm License No. F-0312



GENERAL NOTES:

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WILMINGTON, NC 28403

LS3P PROJECT: 7702-190810

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E	2021.01.08	ADDENDUM #2

SHEET NAME:
ELECTRICAL POWER
TERMINAL UNIT
FLOOR PLAN - LEVEL 2

DATE: 2020.12.16
CURRENT: 2021.01.08
ADDENDUM #2

SHEET: E-112

Newcomb & Boyd
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Consulting Engineering Group
5425 Page Rd
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Contact: Paul J. Kitchens
N&B PROJECT: 19N342
Firm License No. F-0312

THE NEW HANOVER COUNTY
CONSULTANTS AND ENGINEERS
REGISTERED PROFESSIONAL ENGINEER
NO. 10000

E


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GENERAL NOTES:

- REFER TO ELECTRICAL SCHEDULES SHEETS FOR MECHANICAL AND PLUMBING EQUIPMENT CONNECTION SCHEDULES.
- REFER TO MECHANICAL, PLUMBING, AND FIRE ALARM DRAWINGS FOR ADDITIONAL EQUIPMENT REQUIRING POWER NOT SHOWN ON FLOOR PLANS.

KEY NOTES:

- JUNCTION BOX FOR 120V HVAC TERMINAL UNITS CONTROL/DAMPER POWER. REFER TO MECHANICAL DRAWINGS FOR UNIT LOCATIONS AND QUANTITIES. COORDINATE LOCATIONS AND LOADS OF ALL CONNECTION POINTS WITH DIVISION 23.

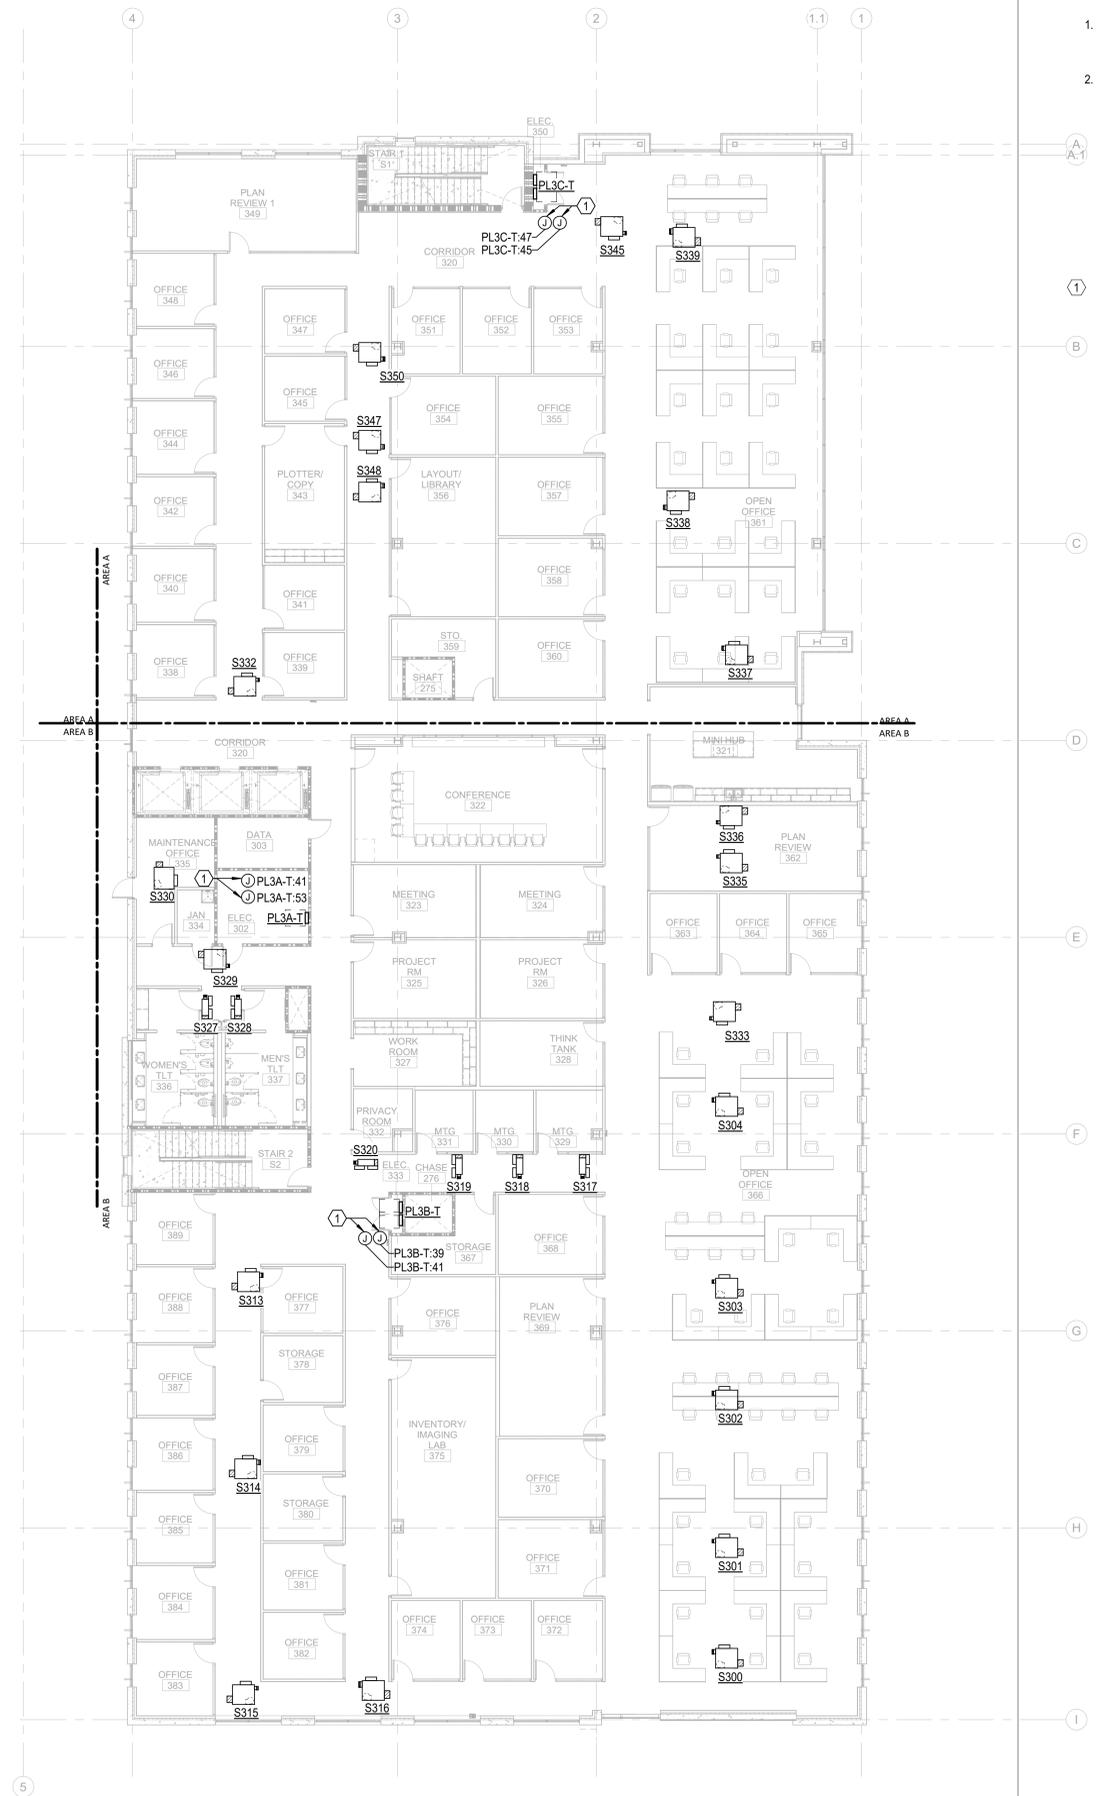

CAPE FEAR FD STONEWATER



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GOVERNMENT CENTER**
GOVERNMENT CENTER DRIVE
WILMINGTON, NC 28403
LS3P PROJECT: 7702-190810


A	DATE	DESCRIPTION
A	2020.08.18	TI- SCHEMATIC DESIGN
B	2020.10.16	TI- DESIGN DEVELOPMENT
C	2020.12.16	GMP SET
D	2021.01.22	ADDENDUM #1
E	2021.01.08	ADDENDUM #2

SHEET NAME:
ELECTRICAL POWER
TERMINAL UNIT
FLOOR PLAN - LEVEL 3

DATE: 2020.12.16
CURRENT: 2021.01.08
ADDENDUM #2

SHEET:
E-113

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Durham, NC 27703
T 919 783-7812
Contact: Paul J. Kitchens
N&B PROJECT: 19N342
Firm License No. F-0312

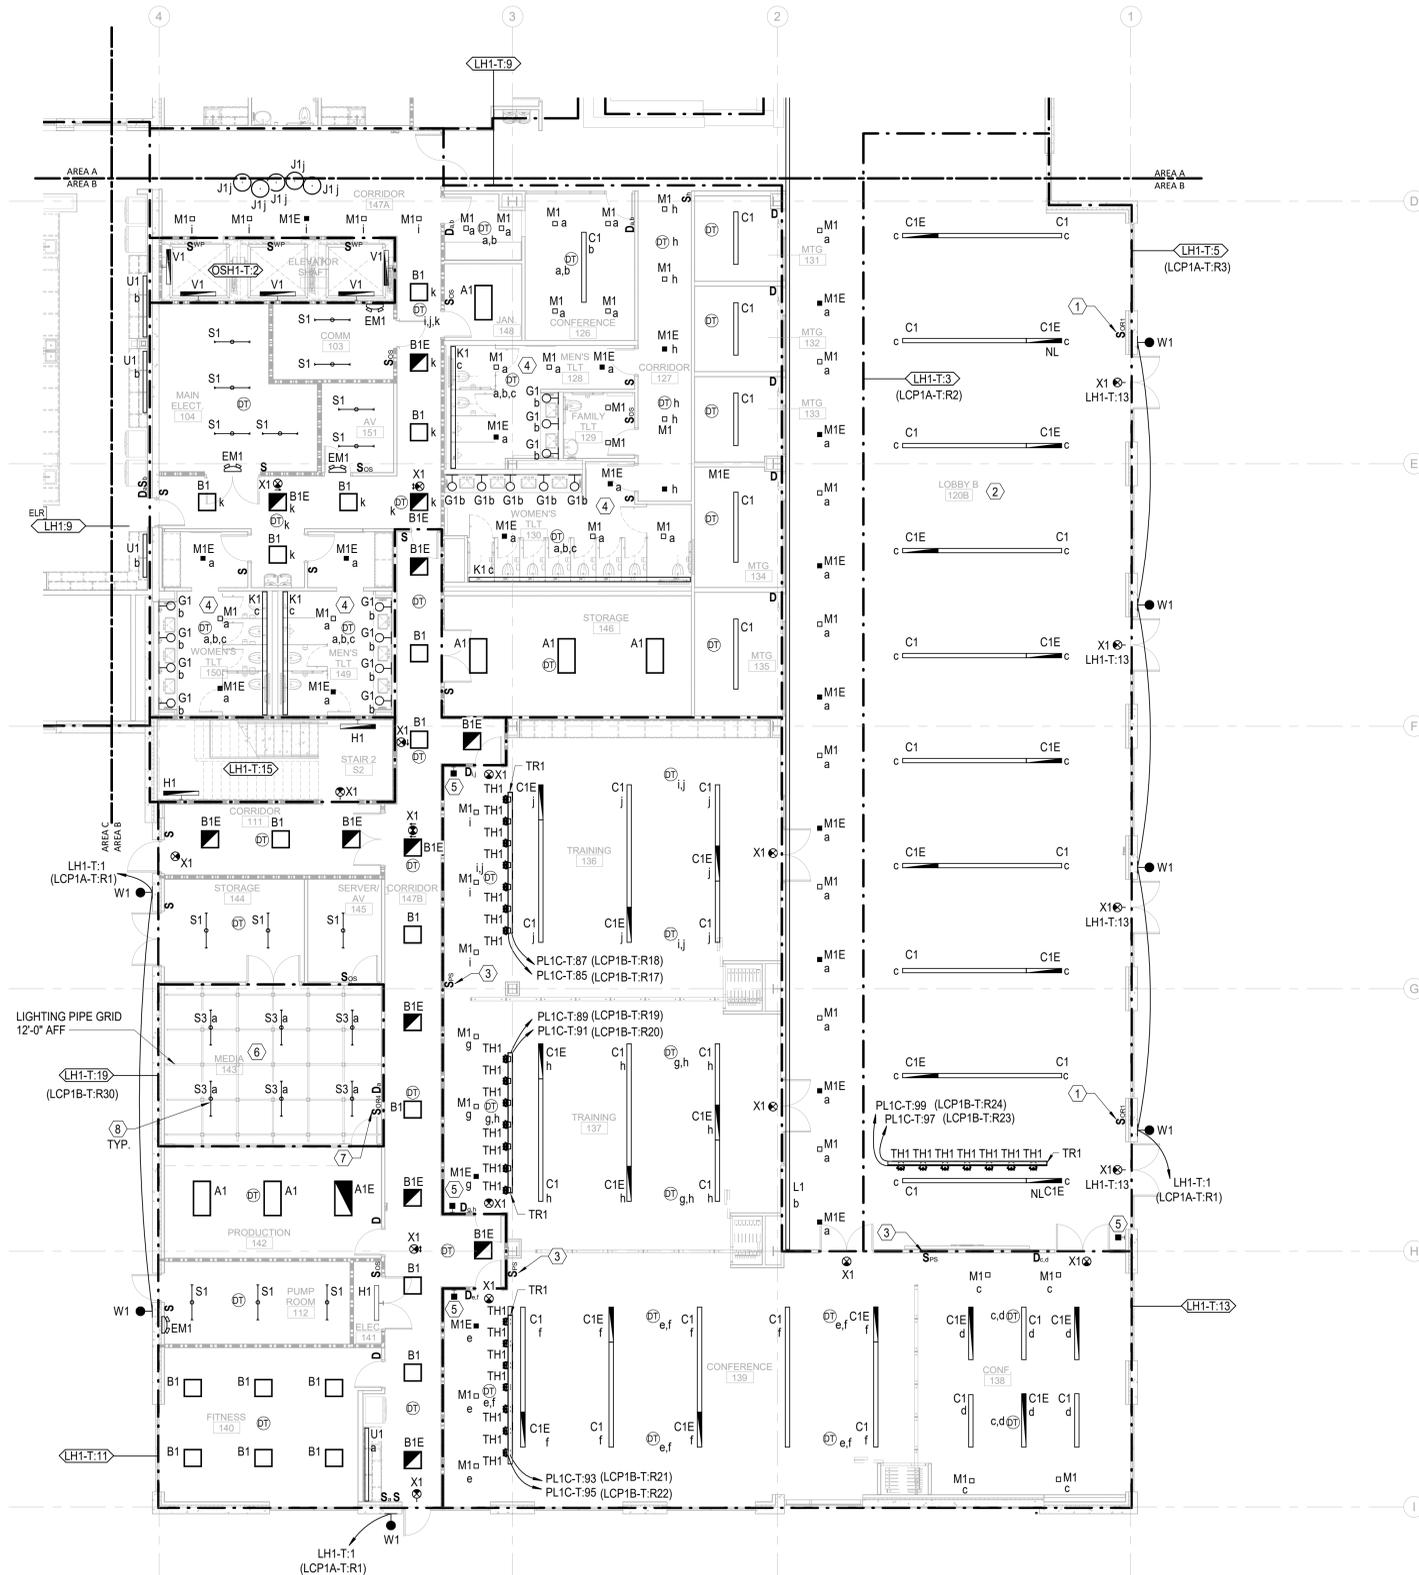

GENERAL NOTES:

- EMERGENCY FIXTURES ARE PROVIDED WITH INTEGRAL 90 MINUTE BATTERY BACK UP, UON. SEE LIGHTING FIXTURE SCHEDULE FOR DETAILS.
- EMERGENCY LIGHTING FIXTURES SHALL BE CONTROLLED TOGETHER WITH NORMAL LIGHTING FIXTURES WITHIN THE SAME AREA, UON.
- ROUTE BRANCH CIRCUITS SERVING EXTERIOR BUILDING MOUNTED LIGHTING FIXTURES VIA LIGHTING RELAY PANEL LOCATED IN THE MAIN ELECTRICAL ROOM.
- ROUTE BRANCH CIRCUITS SERVING EXTERIOR EMERGENCY LIGHTING FIXTURES VIA EMERGENCY LIGHTING INVERTER INV AND LIGHTING RELAY PANEL LOCATED IN THE MAIN ELECTRICAL ROOM.
- PROVIDE UNSWITCHED HOT CONDUCTOR FOR ALL FIXTURES DESIGNATED AS NIGHT LIGHTS.
- LIGHTING IN AREAS WHERE THE LOCAL MEANS OF AUTOMATIC SHUT OFF (OCCUPANCY/VACANCY SENSORS) ARE NOT INDICATED SHALL BE AUTOMATICALLY CONTROLLED VIA LIGHTING RELAY PANEL.
- REFER TO ELECTRICAL SCHEDULES ON SHEET E-501 FOR LIGHTING CONTROL RELAY PANEL SCHEDULES.

KEY NOTES:

- LOW VOLTAGE LIGHTING CONTROL RELAY PANEL 2-HOUR OVERRIDE SWITCH. REFER TO RELAY PANEL SCHEDULE FOR DESCRIPTION OF LIGHTING ZONES CONTROLLED.
- ALL LIGHTING FIXTURES SERVING LOBBY B 120B AREA SHALL BE AUTOMATICALLY CONTROLLED VIA LIGHTING CONTROL RELAY PANEL LOCATED IN MAIN ELECTRICAL ROOM.
- PROVIDE MANUAL ROOM PARTITION SWITCH FOR RECONFIGURATION OF CONNECTED LIGHTING CONTROL DEVICES BASED ON POSITION OF MOVABLE ROOM PARTITION. WHEN PARTITION IS OPEN BETWEEN ANY TWO CONFERENCE ROOMS THE LIGHTING CONTROL DEVICES IN EACH ROOM SHALL SIMULTANEOUSLY CONTROL LIGHTING FIXTURES IN BOTH ROOMS. SWITCH SHOULD BE PROGRAMMED TO RECONFIGURE MORE THAN (2) SPACES AT ONE TIME.
- ALL LIGHTING IN EACH PUBLIC RESTROOM SHALL BE CONTROLLED BY A SINGLE ON/OFF SWITCH. PROVIDE SEPARATE DIMMABLE POWER PACKS FOR EACH FIXTURE TYPE IN THE ROOM.
- PROVIDE TOUCHSCREEN EQUIVALENT TO ACUITY FRESKO MASTER CONTROLLER FOR THE DMX CONTROLLED TRACK LIGHTS. MASTER CONTROLLER SHALL PROVIDE CONTROL FOR EACH INDIVIDUALLY ADDRESSABLE LIGHT. SCENE SETTINGS TO BE DETERMINED BY THE END USER.
- ALL LIGHTING FIXTURES SERVING MEDIA ROOM 143 SHALL BE AUTOMATICALLY CONTROLLED VIA LIGHTING CONTROL RELAY PANEL LOCATED IN ELECTRICAL CLOSET 141.
- PROVIDE (3) LOW VOLTAGE OVERRIDE SWITCHES EACH WITH 8 ON/OFF BUTTONS FOR LOCAL CONTROL OF SPECIALTY LIGHTING FIXTURES IN MEDIA ROOM 143. EACH ON/OFF BUTTON SHALL CONTROL ONE CEILING MOUNTED RECEPTACLE FEEDING AN INDIVIDUAL PIPE GRID MOUNTED LIGHTING FIXTURE. PROVIDE ONE ADDITIONAL ON/OFF BUTTON FOR MANUAL OVERRIDE AND CONTROL OF ALL LIGHTING FIXTURES IN THE ROOM. PROVIDE (4) SPARE BUTTONS FOR FUTURE SPECIALTY LIGHTING FIXTURES.
- SUSPEND STRIP LIGHTING FROM DECK ABOVE VIA CHAIN HANGER WITH A MINIMUM OF 6" BETWEEN BOTTOM OF WIREGUARD AND TOP OF PIPE GRID. CONTRACTOR TO COORDINATE EXACT FIXTURE LOCATIONS AND MOUNTING HEIGHT WITH PIPE GRID AND OTHER TRADES PRIOR TO INSTALLATION.



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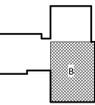
NHC Government Center 7702-190810

**NEW HANOVER COUNTY
GOVERNMENT CENTER**
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WILMINGTON, NC 28403

LS3P PROJECT: 7702-190810

DATE	DESCRIPTION
A 2020.08.18	TI-SCHEMATIC DESIGN
B 2020.10.16	TI-DESIGN DEVELOPMENT
C 2020.12.16	GMP SET
D 2020.12.22	ADDENDUM #1
E 2021.01.08	ADDENDUM #2

KEY PLAN:



SHEET NAME:
ELECTRICAL LIGHTING
FLOOR PLAN - LEVEL 1
- AREA B

DATE: 2020.12.16
CURRENT: 2021.01.08

ADDENDUM #2

SHEET:

E-201B

GMP SET

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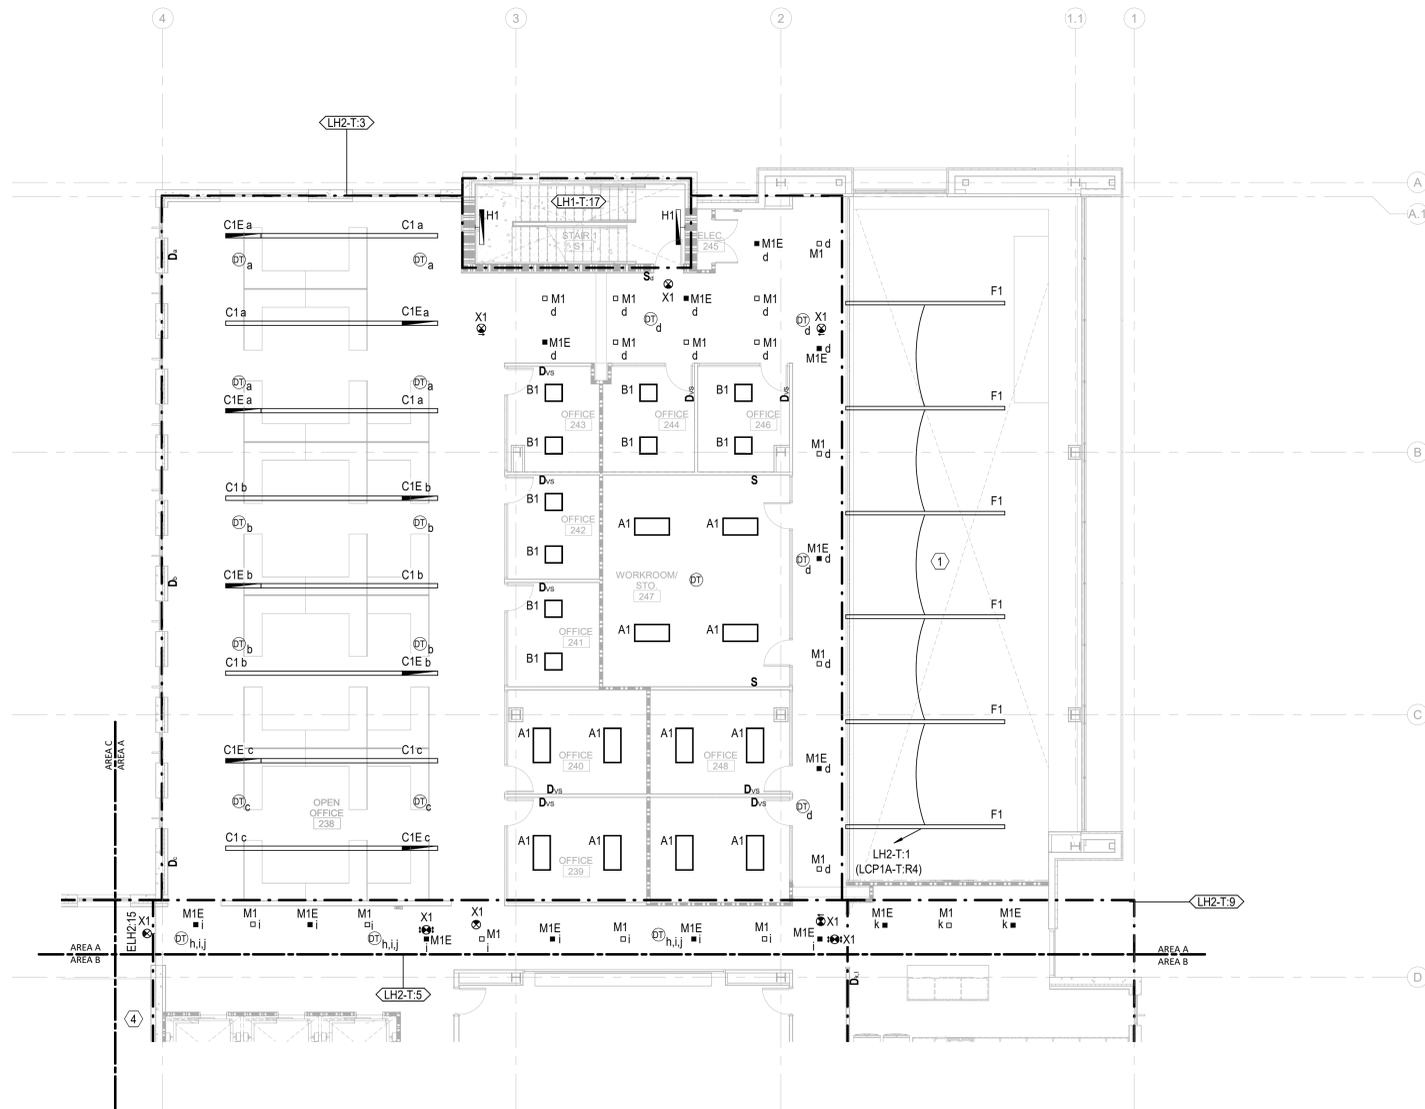
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GENERAL NOTES:

- EMERGENCY FIXTURES ARE PROVIDED WITH INTEGRAL 90 MINUTE BATTERY BACK UP, UON. SEE LIGHTING FIXTURE SCHEDULE FOR DETAILS.
- EMERGENCY LIGHTING FIXTURES SHALL BE CONTROLLED TOGETHER WITH NORMAL LIGHTING FIXTURES WITHIN THE SAME AREA, UON.
- PROVIDE UNSWITCHED HOT CONDUCTOR FOR ALL FIXTURES DESIGNATED AS NIGHT LIGHTS.
- LIGHTING IN AREAS WHERE THE LOCAL MEANS OF AUTOMATIC SHUT OFF (OCCUPANCY/VACANCY SENSORS) ARE NOT INDICATED SHALL BE AUTOMATICALLY CONTROLLED VIA LIGHTING RELAY PANEL.
- REFER TO ELECTRICAL SCHEDULES ON SHEET E-501 FOR LIGHTING CONTROL RELAY PANEL SCHEDULES.

KEY NOTES:

- ALL LIGHTING FIXTURES SERVING LOBBY A 120A AREA SHALL BE AUTOMATICALLY CONTROLLED VIA LIGHTING CONTROL RELAY PANEL LOCATED IN MAIN ELECTRICAL ROOM.



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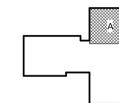
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WILMINGTON, NC 28403

LS3P PROJECT: 7702-190810

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A	2020.08.18	TI-SCHEMATIC DESIGN
B	2020.10.16	TI-DESIGN DEVELOPMENT
C	2020.12.16	GMP SET
D	2020.12.22	ADDENDUM #1
E	2021.01.08	ADDENDUM #2

KEY PLAN:



SHEET NAME:
ELECTRICAL LIGHTING
FLOOR PLAN - LEVEL 2
- AREA A

DATE: 2020.12.16
CURRENT: 2021.01.08


ADDENDUM #2

SHEET:

E-202A

GMP SET

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1
E-202A ELECTRICAL LIGHTING TI FLOOR PLAN - PARTIAL - LEVEL 2 - AREA A

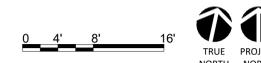1/8" = 1'-0"

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THE STATE OF NORTH CAROLINA
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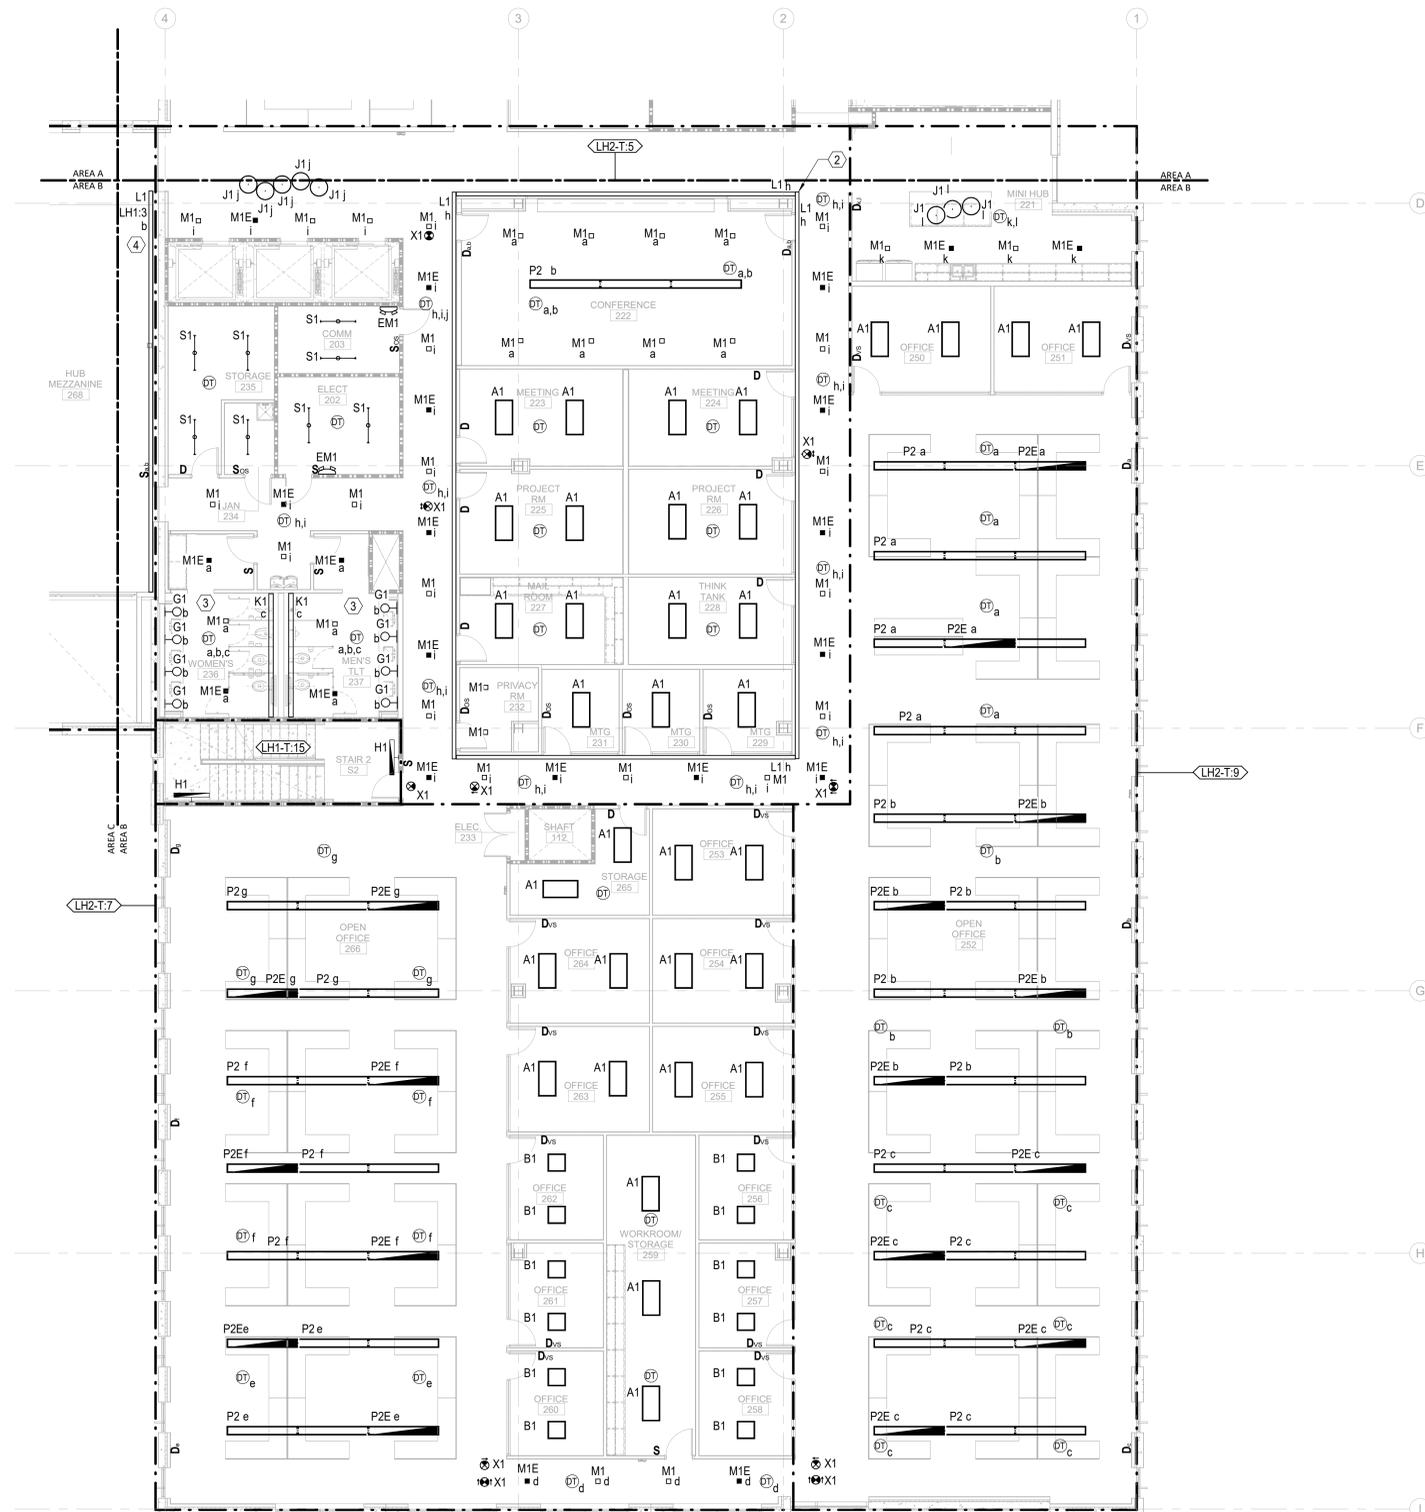
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GENERAL NOTES:

- EMERGENCY FIXTURES ARE PROVIDED WITH INTEGRAL 90 MINUTE BATTERY BACK UP. UON. SEE LIGHTING FIXTURE SCHEDULE FOR DETAILS.
- EMERGENCY LIGHTING FIXTURES SHALL BE CONTROLLED TOGETHER WITH NORMAL LIGHTING FIXTURES WITHIN THE SAME AREA, UON.
- PROVIDE UNSWITCHED HOT CONDUCTOR FOR ALL FIXTURES DESIGNATED AS NIGHT LIGHTS.
- LIGHTING IN AREAS WHERE THE LOCAL MEANS OF AUTOMATIC SHUT OFF (OCCUPANCY/VACANCY SENSORS) ARE NOT INDICATED SHALL BE AUTOMATICALLY CONTROLLED VIA LIGHTING RELAY PANEL.

KEY NOTES:

- LOW VOLTAGE LIGHTING CONTROL RELAY PANEL 2-HOUR OVERRIDE SWITCH.
- INSTALL FIXTURE TO CREATE AN INCLUSIVE CONTINUOUS LINE OF LIGHT WITH CORNERS.
- ALL LIGHTING IN PUBLIC RESTROOMS SHALL BE CONTROLLED BY A SINGLE ON/OFF SWITCH. PROVIDE SEPARATE DIMMABLE POWER PACKS FOR EACH FIXTURE TYPE IN THE ROOM.
- HUB MEZZANINE COVE FIXTURE SHALL BE CONTROLLED BY OCCUPANCY SENSORS SHOWN ON SHEET E-202C.



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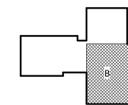
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LS3P PROJECT: 7702-190810

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B	2020.10.16	TI-DESIGN DEVELOPMENT
C	2020.12.16	GMP SET
D	2020.12.22	ADDENDUM #1
E	2021.01.08	ADDENDUM #2

KEY PLAN:



SHEET NAME:
**ELECTRICAL LIGHTING
FLOOR PLAN - LEVEL 2
- AREA B**


DATE: 2020.12.16
CURRENT: 2021.01.08

ADDENDUM #2

SHEET:
E-202B

GMP SET

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E-202B
ELECTRICAL LIGHTING TI FLOOR PLAN - PARTIAL - LEVEL 2 - AREA B

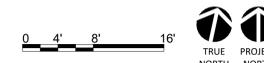1/8" = 1'-0"

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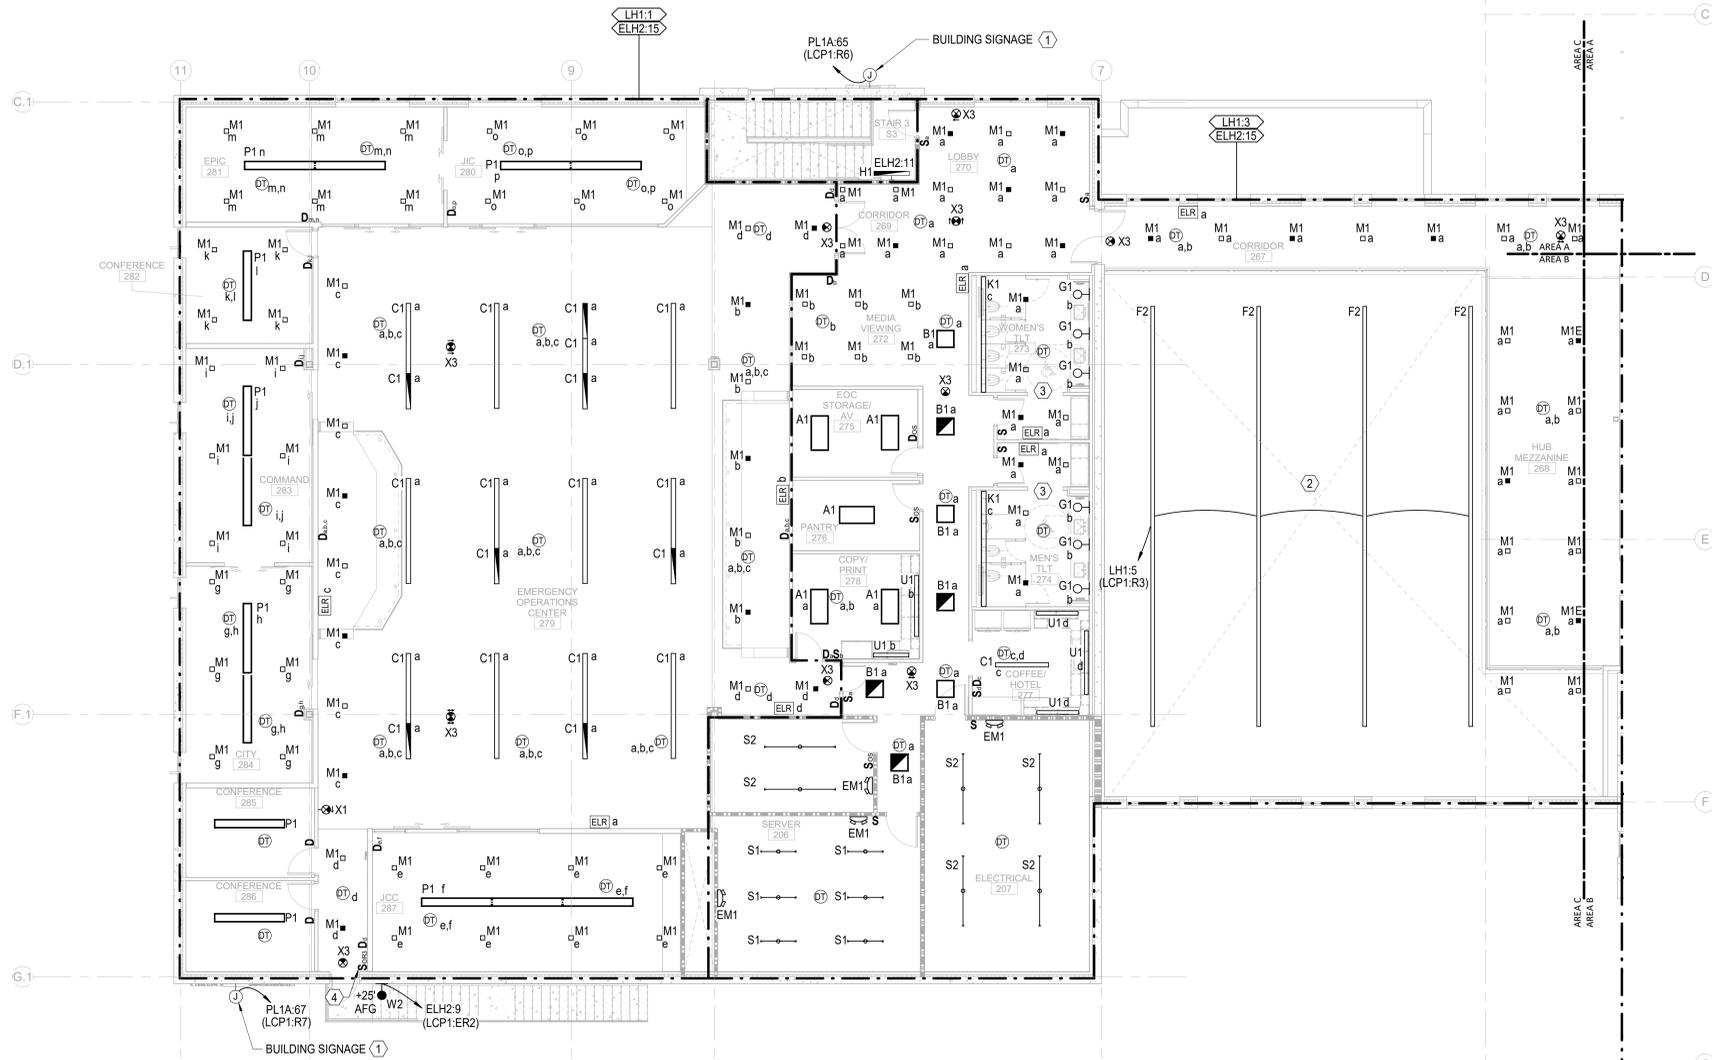
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GENERAL NOTES:

1. CIRCUIT NORMAL LIGHTING TO PANEL "LH1", UON. CIRCUIT ALL EMERGENCY LIGHTING INCLUDING EXIT SIGNS AND FIXTURES WITH INTEGRAL BATTERY BACKUP TO PANEL "ELH2", UON.
2. EMERGENCY LIGHTING FIXTURES SHALL BE CONTROLLED TOGETHER WITH NORMAL LIGHTING FIXTURES WITHIN THE SAME ROOM/AREA UNDER NORMAL CONDITIONS UON. UPON LOSS OF NORMAL POWER ALL EMERGENCY FIXTURES SHALL COME ON AT FULL BRIGHTNESS. PROVIDE EMERGENCY LIGHTING RELAYS AS REQUIRED.
3. ROUTE BRANCH CIRCUITS SERVING EXTERIOR BUILDING MOUNTED LIGHTING FIXTURES VIA LIGHTING RELAY PANEL LOCATED IN THE MAIN ELECTRICAL ROOM. REFER TO RELAY PANEL SCHEDULE FOR DETAILS.
4. ROUTE SITE LIGHTING BRANCH CIRCUITS VIA LIGHTING CONTACTOR LC LOCATED IN MAIN ELECTRICAL ROOM. REFER TO CONTACTOR SCHEDULE FOR DETAILS.
5. PROVIDE UNSWITCHED HOT CONDUCTOR FOR ALL FIXTURES DESIGNATED AS NIGHT LIGHTS.
6. REFER TO ELECTRICAL SCHEDULES ON SHEET E-501 FOR LIGHTING CONTROL RELAY PANEL SCHEDULES.

KEY NOTES:

- 1 PROVIDE POWER TO INTERNALLY ILLUMINATED SIGNAGE. REFER TO ARCHITECTURAL PLANS FOR EXACT LOCATION AND MOUNTING HEIGHT. ROUTE CIRCUIT VIA LIGHTING CONTROL RELAY PANEL LOCATED IN ELECTRICAL 168 FOR TIME CLOCK CONTROL.
- 2 ALL LIGHTING FIXTURES SERVING HUB 153 AREA SHALL BE AUTOMATICALLY CONTROLLED VIA LIGHTING CONTROL RELAY PANEL LOCATED IN ELECTRICAL 168.
- 3 ALL LIGHTING IN PUBLIC RESTROOMS SHALL BE CONTROLLED BY A SINGLE ON/OFF SWITCH. PROVIDE SEPARATE DIMMABLE POWER PACKS FOR EACH FIXTURE TYPE IN THE ROOM.
- 4 LOW VOLTAGE LIGHTING CONTROL RELAY PANEL 2-HOUR OVERRIDE SWITCH. REFER TO RELAY PANEL SCHEDULE FOR DESCRIPTION OF LIGHTING ZONES CONTROLLED.



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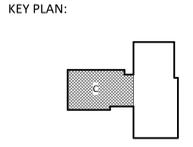
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NHC Government Center 7702-190810

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LS3P PROJECT: 7702-190810

DATE	DESCRIPTION
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B 2020.10.16	TI- DESIGN DEVELOPMENT
C 2020.12.16	GMP SET
D 2020.12.22	ADDENDUM #1
E 2021.01.08	ADDENDUM #2



SHEET NAME:
ELECTRICAL LIGHTING
FLOOR PLAN - LEVEL 2
- AREA C

DATE: 2020.12.16
CURRENT: 2021.01.08
ADDENDUM #2

SHEET:
E-202C

GMP SET

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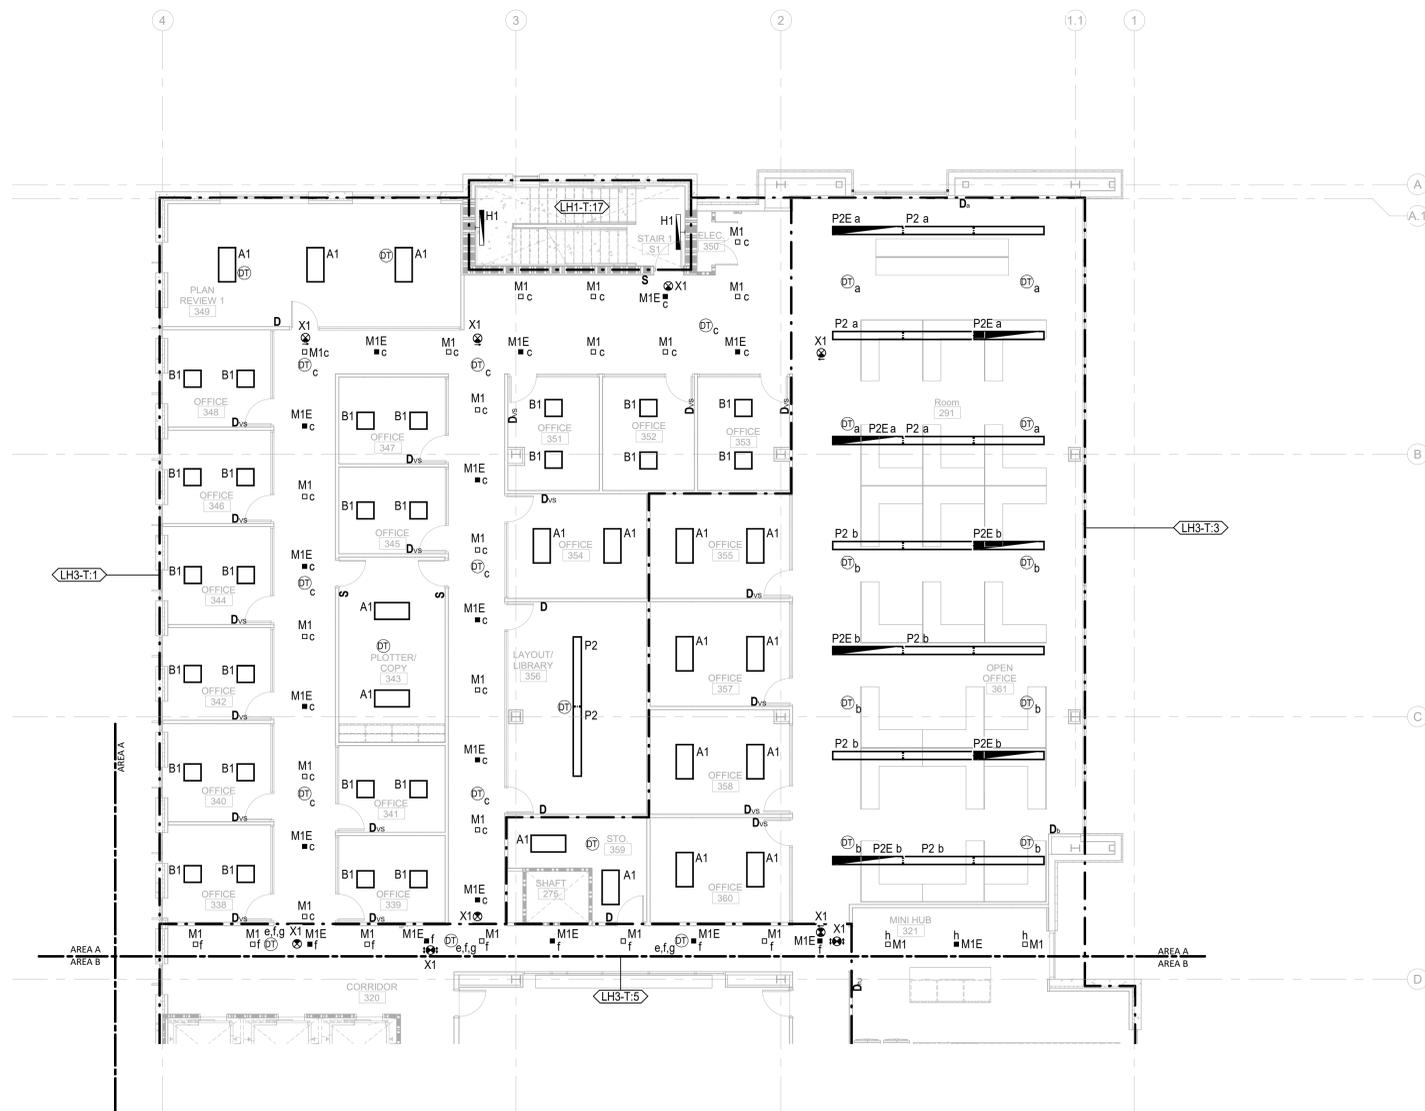
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GENERAL NOTES:

- EMERGENCY FIXTURES ARE PROVIDED WITH INTEGRAL 90 MINUTE BATTERY BACK UP. UON. SEE LIGHTING FIXTURE SCHEDULE FOR DETAILS.
- EMERGENCY LIGHTING FIXTURES SHALL BE CONTROLLED TOGETHER WITH NORMAL LIGHTING FIXTURES WITHIN THE SAME AREA, UON.
- PROVIDE UNSWITCHED HOT CONDUCTOR FOR ALL FIXTURES DESIGNATED AS NIGHT LIGHTS.
- LIGHTING IN AREAS WHERE THE LOCAL MEANS OF AUTOMATIC SHUT OFF (OCCUPANCY/VACANCY SENSORS) ARE NOT INDICATED SHALL BE AUTOMATICALLY CONTROLLED VIA LIGHTING RELAY PANEL.



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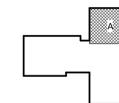
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LS3P PROJECT: 7702-190810

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C	2020.12.16	GMP SET
D	2020.12.22	ADDENDUM #1
E	2021.01.08	ADDENDUM #2

KEY PLAN:




SHEET NAME:
 ELECTRICAL LIGHTING
 FLOOR PLAN - LEVEL 3
 - AREA A

DATE: 2020.12.16
CURRENT: 2021.01.08

ADDENDUM #2

SHEET:
E-203A

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 E-203A
ELECTRICAL LIGHTING TI FLOOR PLAN - PARTIAL - LEVEL 3 - AREA A

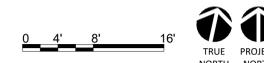1/8" = 1'-0"

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GMP SET

THE STATE OF NORTH CAROLINA
COUNTY OF HANOVER
PLANNING AND ZONING DEPARTMENT


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GENERAL NOTES:

- EMERGENCY FIXTURES ARE PROVIDED WITH INTEGRAL 90 MINUTE BATTERY BACK UP. UON. SEE LIGHTING FIXTURE SCHEDULE FOR DETAILS.
- EMERGENCY LIGHTING FIXTURES SHALL BE CONTROLLED TOGETHER WITH NORMAL LIGHTING FIXTURES WITHIN THE SAME AREA, UON.
- PROVIDE UNSWITCHED HOT CONDUCTOR FOR ALL FIXTURES DESIGNATED AS NIGHT LIGHTS.
- LIGHTING IN AREAS WHERE THE LOCAL MEANS OF AUTOMATIC SHUT OFF (OCCUPANCY/VACANCY SENSORS) ARE NOT INDICATED SHALL BE AUTOMATICALLY CONTROLLED VIA LIGHTING RELAY PANEL.

KEY NOTES:

- INSTALL FIXTURE TO CREATE AN INCLUSIVE CONTINUOUS LINE OF LIGHT WITH CORNERS.
- ALL LIGHTING IN PUBLIC RESTROOMS SHALL BE CONTROLLED BY A SINGLE ON/OFF SWITCH. PROVIDE SEPARATE DIMMABLE POWER PACKS FOR EACH FIXTURE TYPE IN THE ROOM.

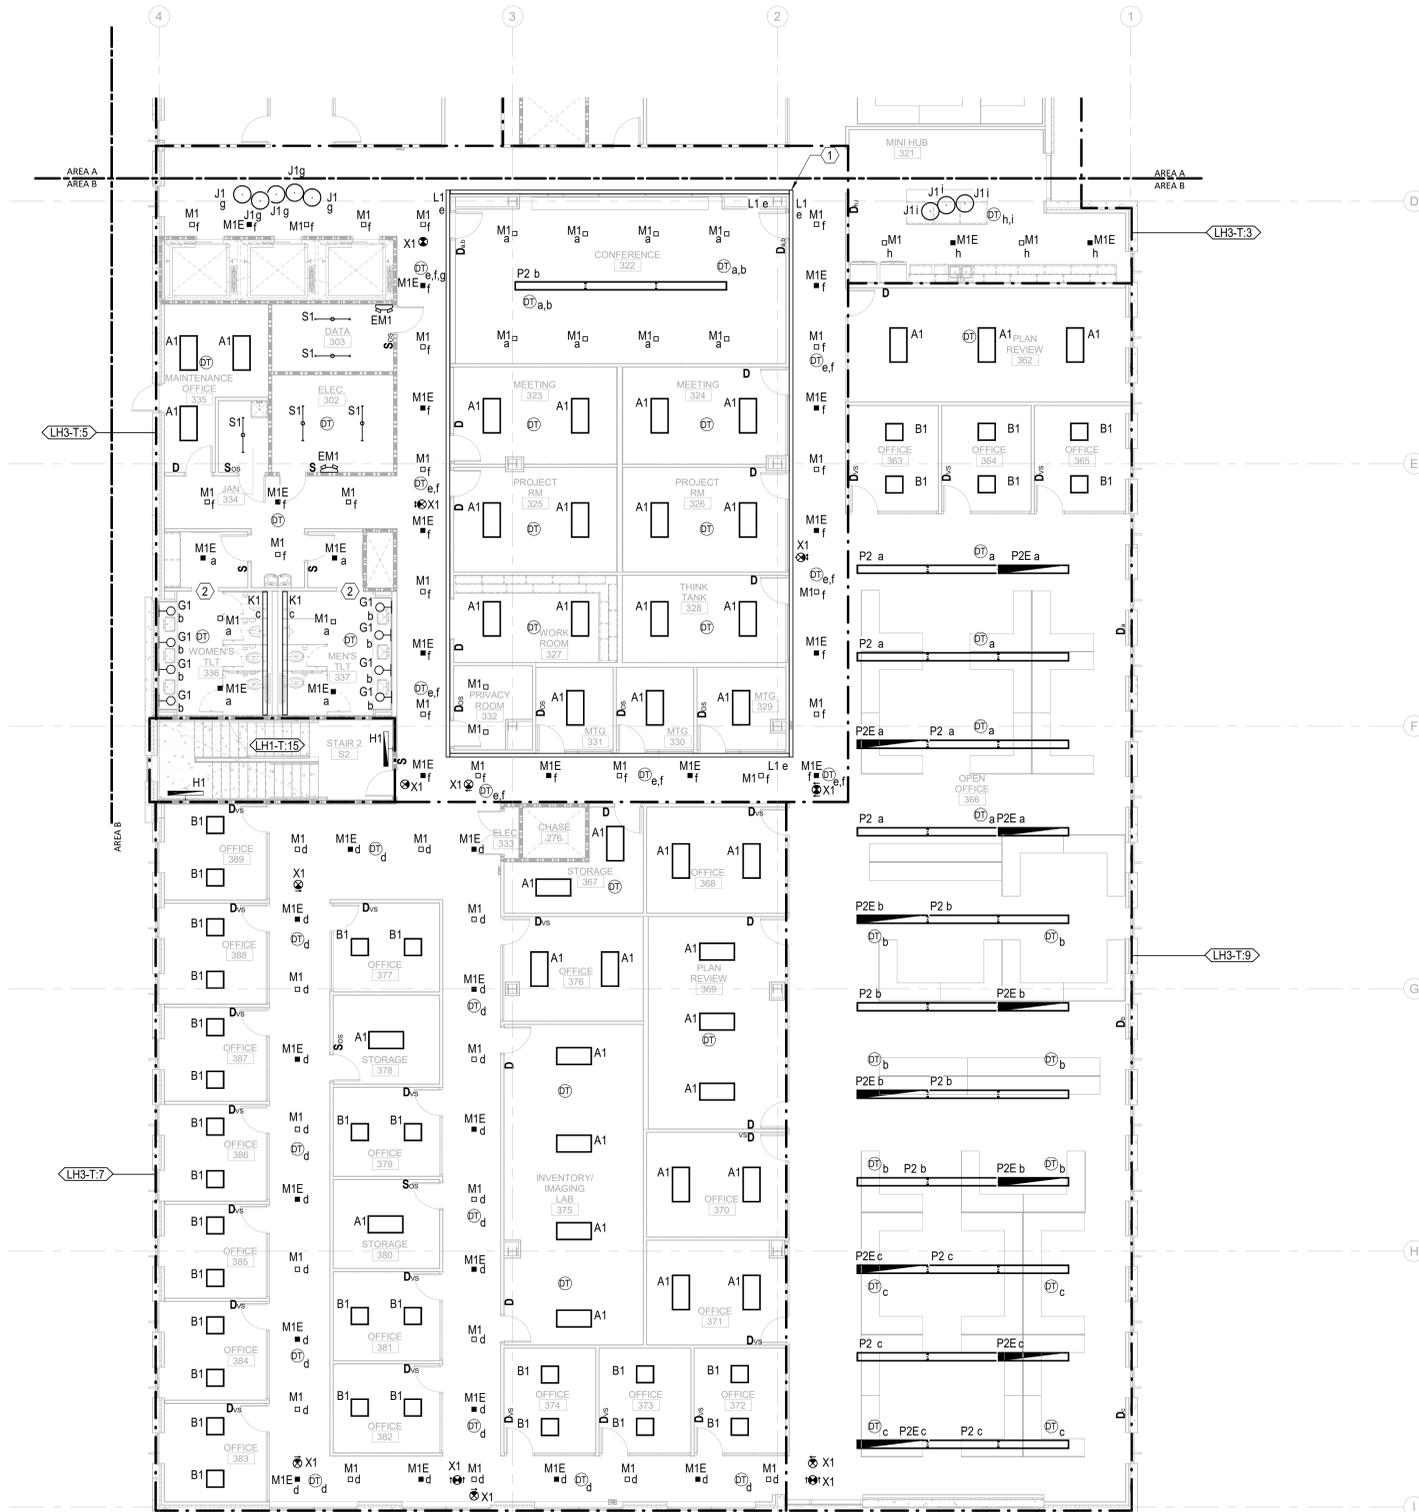

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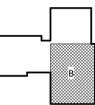
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E	2021.01.08	ADDENDUM #2

KEY PLAN:



SHEET NAME:
**ELECTRICAL LIGHTING
FLOOR PLAN - LEVEL 3
- AREA B**

DATE: 2020.12.16
CURRENT: 2021.01.08
ADDENDUM #2

SHEET:
E-203B

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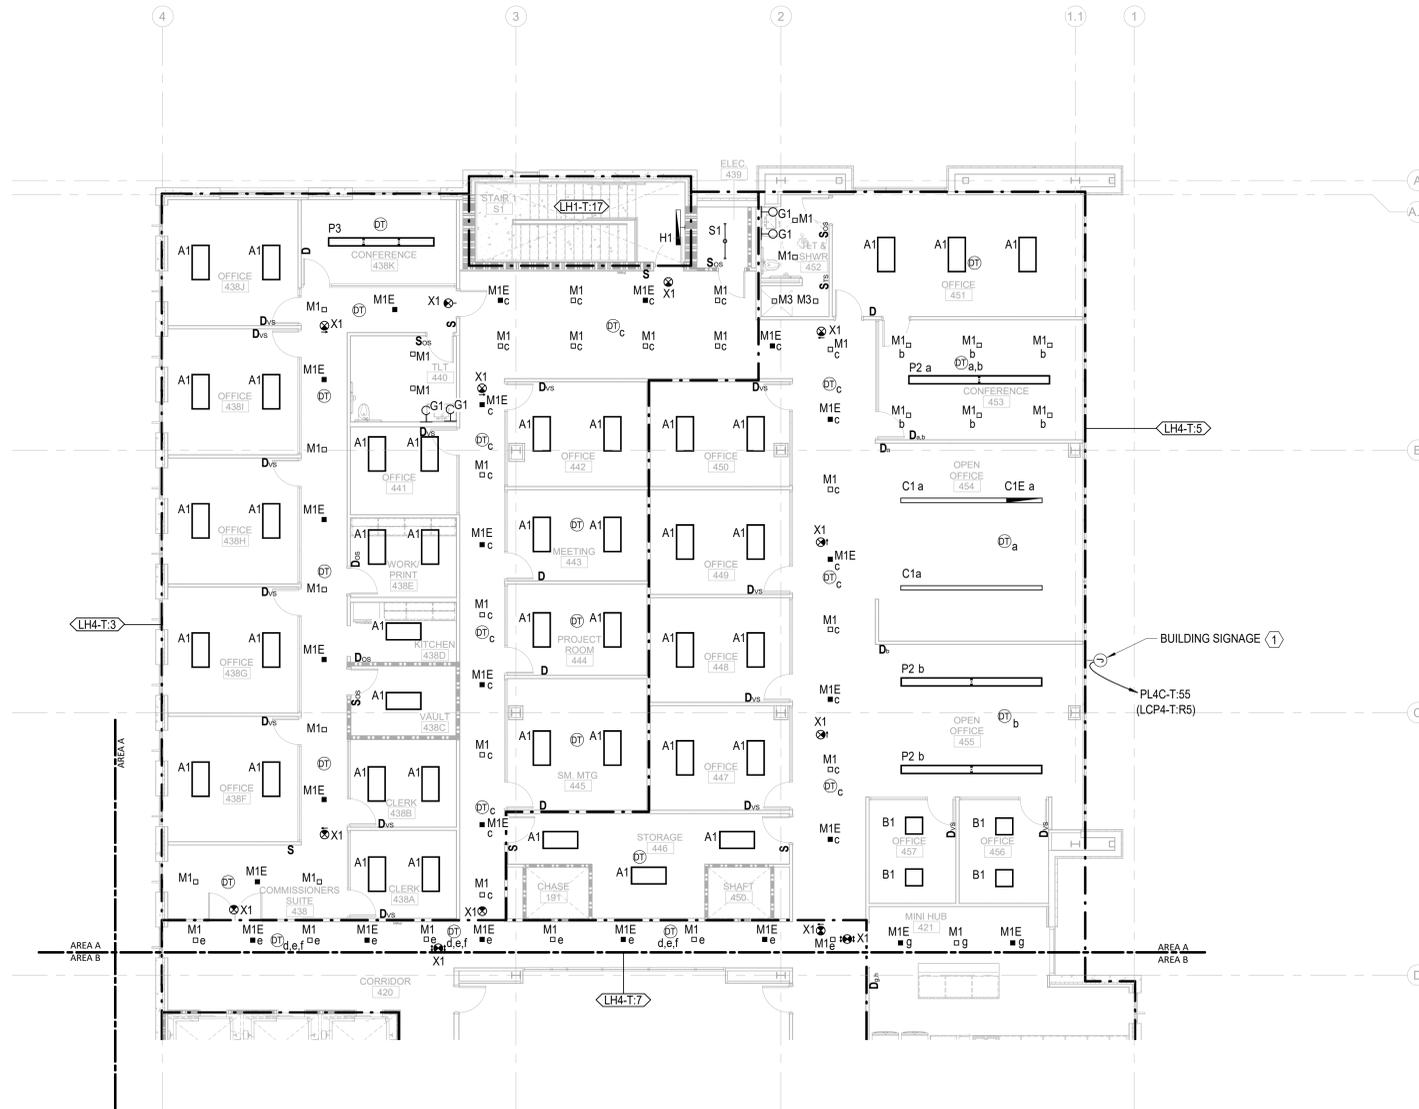
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- PROVIDE UNSWITCHED HOT CONDUCTOR FOR ALL FIXTURES DESIGNATED AS NIGHT LIGHTS.
- LIGHTING IN AREAS WHERE THE LOCAL MEANS OF AUTOMATIC SHUT OFF (OCCUPANCY/VACANCY SENSORS) ARE NOT INDICATED SHALL BE AUTOMATICALLY CONTROLLED VIA LIGHTING RELAY PANEL.
- REFER TO ELECTRICAL SCHEDULES ON SHEET E-501 FOR LIGHTING CONTROL RELAY PANEL SCHEDULES.

KEY NOTES:

- PROVIDE POWER TO INTERNALLY ILLUMINATED SIGNAGE. REFER TO ARCHITECTURAL PLANS FOR FINAL LOCATION AND MOUNTING HEIGHT. COORDINATE FINAL INSTALLATION REQUIREMENTS WITH GC PRIOR TO FINAL ROUGH-IN. ROUTE CIRCUIT VIA LIGHTING CONTROL PANEL LOCATED IN MAIN ELECTRICAL ROOM FOR TIME CLOCK CONTROL.



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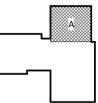
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KEY PLAN:



SHEET NAME:
 ELECTRICAL LIGHTING
 FLOOR PLAN - LEVEL 4
 - AREA A

DATE: 2020.12.16
CURRENT: 2021.01.08

ADDENDUM #2

SHEET:

E-204A

GMP SET

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 E-204A
 ELECTRICAL LIGHTING TI FLOOR PLAN - PARTIAL - LEVEL 4 - AREA A

1/8" = 1'-0"

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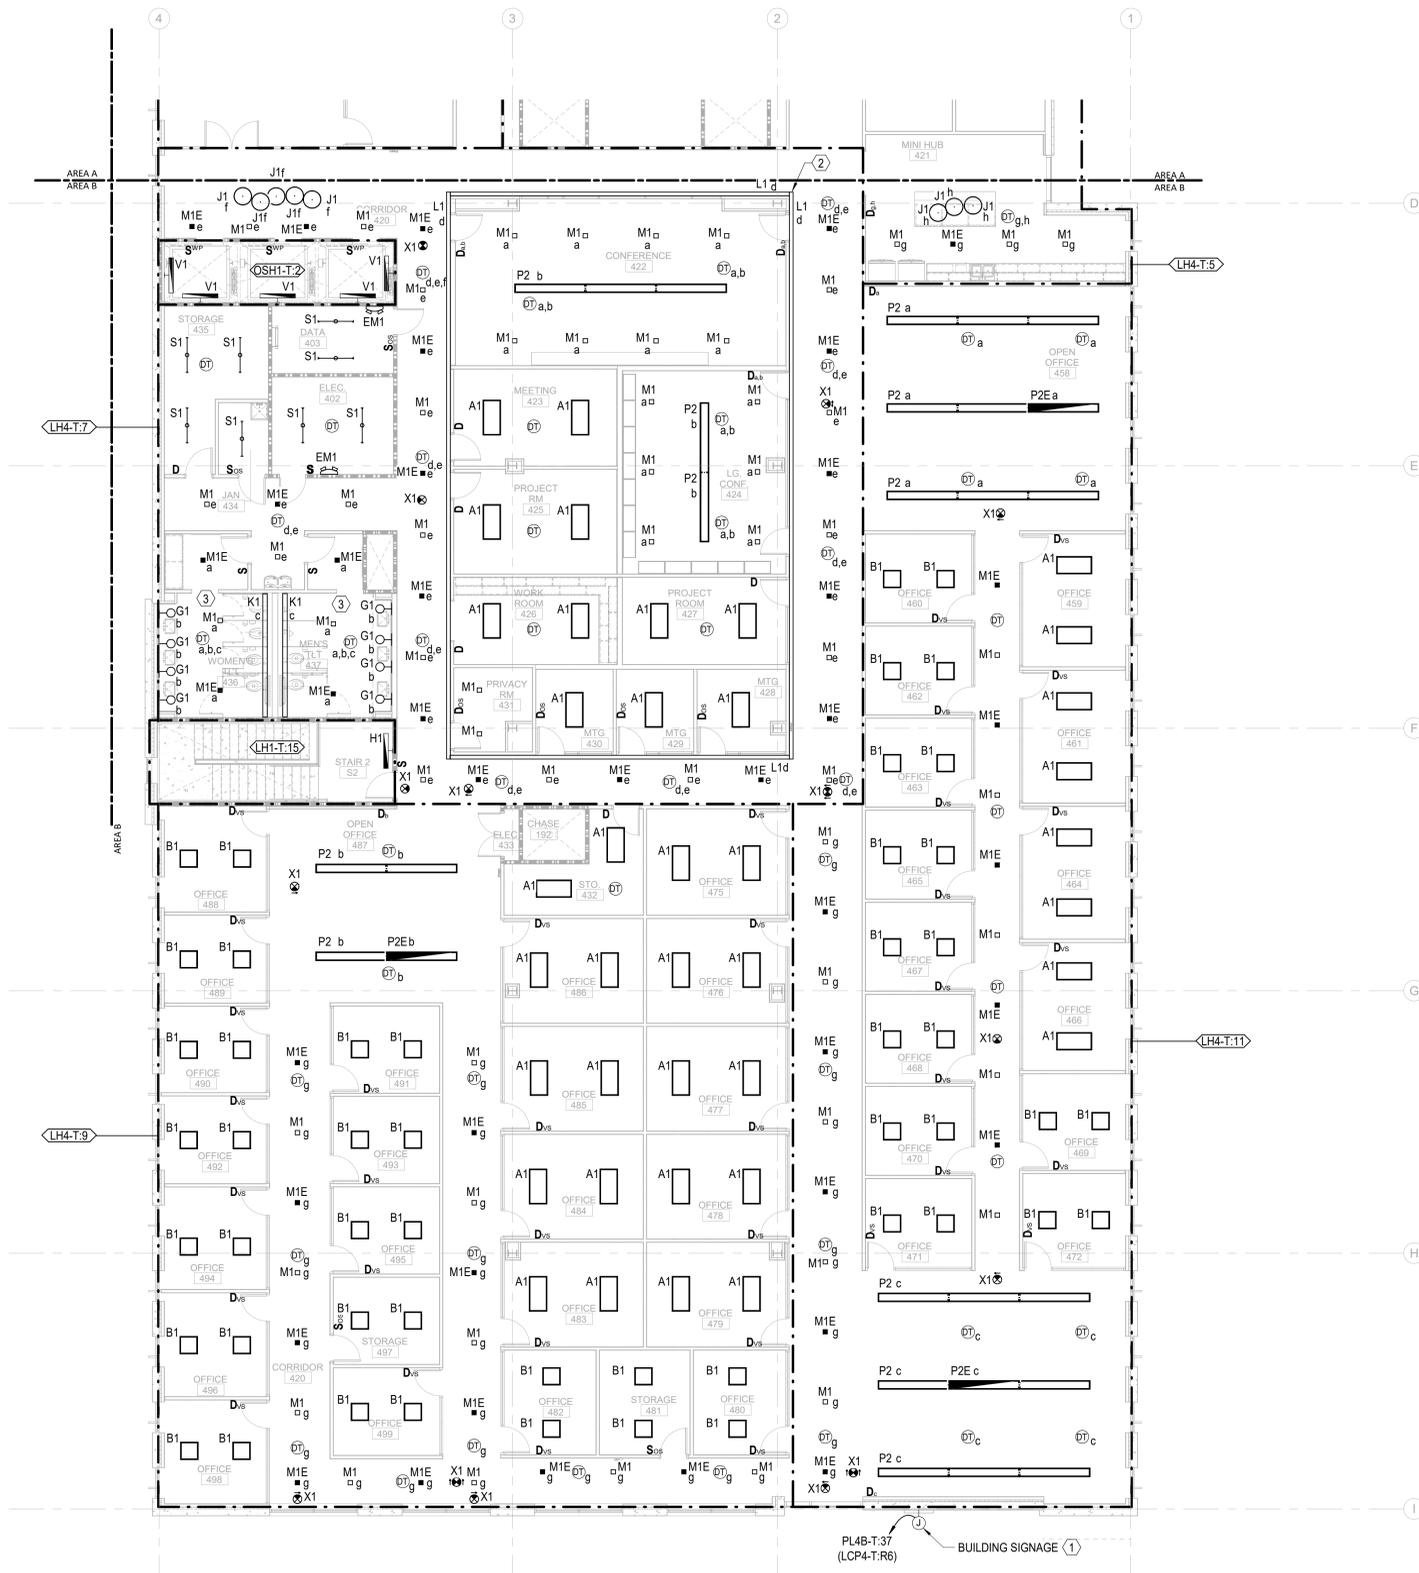
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GENERAL NOTES:

- EMERGENCY FIXTURES ARE PROVIDED WITH INTEGRAL 90 MINUTE BATTERY BACK UP, UON. SEE LIGHTING FIXTURE SCHEDULE FOR DETAILS.
- EMERGENCY LIGHTING FIXTURES SHALL BE CONTROLLED TOGETHER WITH NORMAL LIGHTING FIXTURES WITHIN THE SAME AREA, UON.
- PROVIDE UNSWITCHED HOT CONDUCTOR FOR ALL FIXTURES DESIGNATED AS NIGHT LIGHTS.
- LIGHTING IN AREAS WHERE THE LOCAL MEANS OF AUTOMATIC SHUT OFF (OCCUPANCY/VACANCY SENSORS) ARE NOT INDICATED SHALL BE AUTOMATICALLY CONTROLLED VIA LIGHTING RELAY PANEL.
- REFER TO ELECTRICAL SCHEDULES ON SHEET E-501 FOR LIGHTING CONTROL RELAY PANEL SCHEDULES.

KEY NOTES:

- PROVIDE POWER TO INTERNALLY ILLUMINATED SIGNAGE. REFER TO ARCHITECTURAL PLANS FOR FINAL LOCATION AND MOUNTING HEIGHT. COORDINATE FINAL INSTALLATION REQUIREMENTS WITH GC PRIOR TO FINAL ROUGH-IN. ROUTE CIRCUIT VIA LIGHTING CONTROL PANEL LOCATED IN 4TH FLOOR ELECTRICAL ROOM FOR TIME CLOCK CONTROL.
- INSTALL FIXTURE TO CREATE AN INCLUSIVE CONTINUOUS LINE OF LIGHT WITH CORNERS.
- ALL LIGHTING IN PUBLIC RESTROOMS SHALL BE CONTROLLED BY A SINGLE ON/OFF SWITCH. PROVIDE SEPARATE DIMMABLE POWER PACKS FOR EACH FIXTURE TYPE IN THE ROOM.



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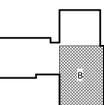
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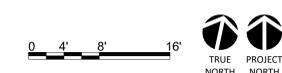
SHEET NAME:
**ELECTRICAL LIGHTING
FLOOR PLAN - LEVEL 4
- AREA B**

DATE: 2020.12.16
CURRENT: 2021.01.08
ADDENDUM #2

SHEET:
E-204B

GMP SET

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1/7/2021 3:16:34 PM


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D


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B

A




4 E-301 ELECTRICAL / HVAC ROOM - ENLARGED - LEVEL 1 - AREA C NTS

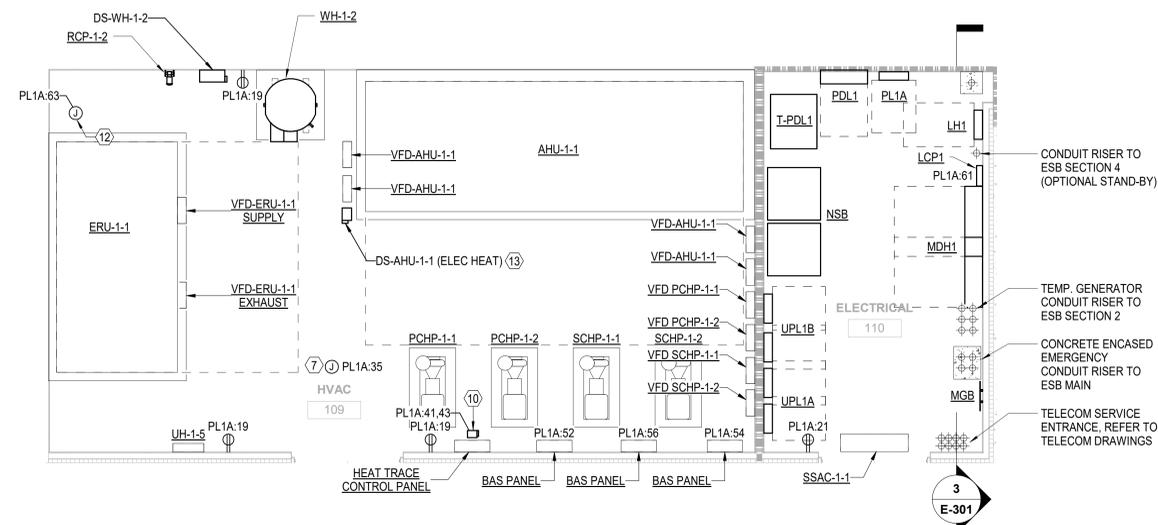


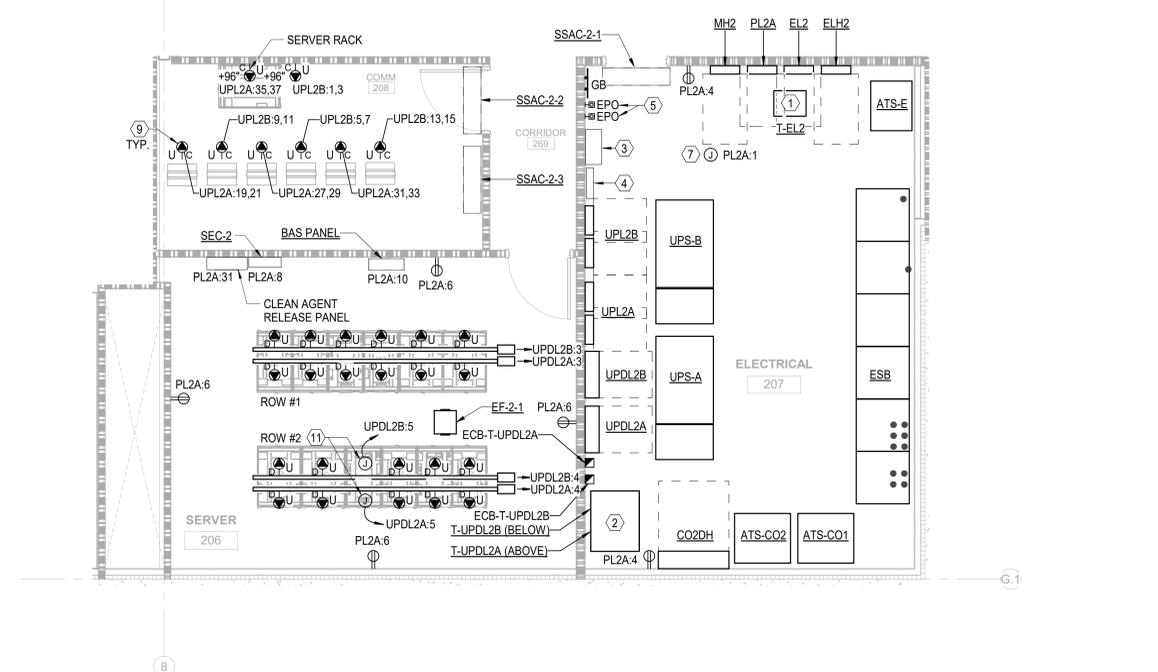5 E-301 ELECTRICAL / SERVER ROOM - ENLARGED - LEVEL 2 - AREA C NTS


1 E-301 ELECTRICAL / COMM / AV ROOM - ENLARGED - LEVEL 1 - AREA B NTS

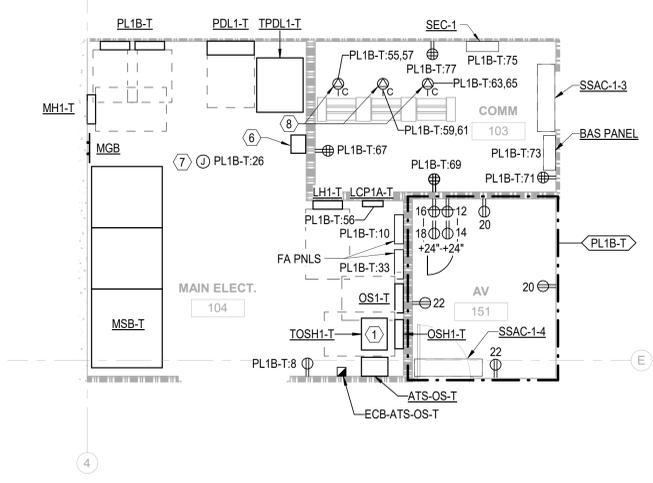

2 E-301 ELECTRICAL / COMM ROOM - ENLARGED - LEVEL 2 - AREA B NTS

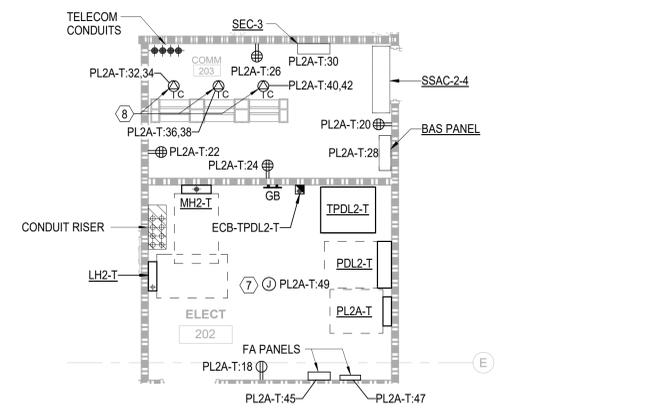

3 E-301 ELECTRICAL ROOM - CONDUIT RISER SECTION - AREA C NTS

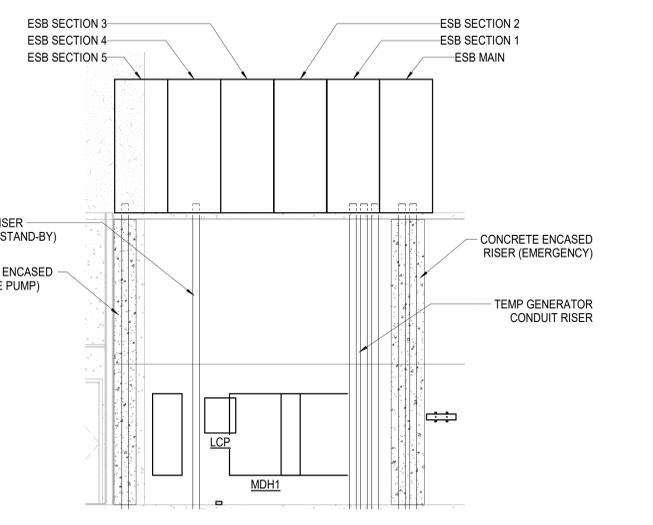

KEY NOTES:

- ① INSTALL TRANSFORMER SUSPENDED FROM THE STRUCTURE ABOVE.
- ② PROVIDE STRUCTURAL STEEL TO MOUNT T-UPDL2A TRANSFORMER ABOVE T-UPDL2B TRANSFORMER. CONTRACTOR SHALL SUBMIT SHOP DRAWINGS OF STRUCTURAL SUPPORT FOR APPROVAL PRIOR TO CONSTRUCTION.
- ③ PROVIDE WALL MOUNTED GENERATOR SET MASTER CONTROLLER WITH INTEGRAL LOAD SHED CONTROL RELAYS.
- ④ PROVIDE GENERATOR REMOTE ANNUNCIATOR PANEL FOR EACH GENERATOR SET.
- ⑤ PROVIDE EMERGENCY GENERATOR SHUT-OFF FOR EACH GENERATOR SET.
- ⑥ PROVIDE 277V, 400VA EMERGENCY LIGHTING INVERTER. EQUIVALENT TO PHILIPS BODINE ELI-S-400.
- ⑦ JUNCTION BOX FOR 120V MISCELLANEOUS HVAC CONTROL POWER. COORDINATE LOCATIONS AND LOADS OF ALL CONNECTION POINTS WITH DIVISION 23.
- ⑧ TYPICAL TELECOM RACK POWER CONFIGURATION, WITH RECEPTACLES MOUNTED TO CABLE TRAY ABOVE. SEE TELECOM PLANS FOR DETAILS.
- ⑨ MOUNT RECEPTACLES TO CABLE TRAY ABOVE.
- ⑩ FOR 208V CONNECTION FOR HEAT TRACE FOR CHS/R PIPING WITHIN UTILITY YARD FROM NEW BREAKER(S) INSTALLED IN PANELBOARD PL1A. REFER TO HVAC DRAWINGS FOR LOCATION OF PIPING. BREAKER SIZE AND QUANTITIES AS REQUIRED BY LENGTH OF HEAT TRACE. BREAKERS SHALL BE GFEP TYPE. COORDINATE LOCATION OF DISCONNECT IN FIELD.
- ⑪ FOR CONNECTION TO SERVER RACK IN-ROW COOLING / DEHUMIDIFICATION UNIT.
- ⑫ FOR CONNECTION TO FIRE SMOKE DAMPERS SERVING THE AREA. REFER TO DIV 23 DRAWINGS AND SPECIFICATIONS FOR EXACT LOCATIONS AND CONNECTION REQUIREMENTS.
- ⑬ COORDINATE EXACT MOUNTING LOCATION OF DISCONNECT IN FIELD WITH MECHANICAL EQUIPMENT PROVIDED.



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NHC Government Center 7702-190810

NEW HANOVER COUNTY
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GOVERNMENT CENTER DRIVE
WILMINGTON, NC 28403
LS3P PROJECT: 7702-190810

A	DATE	DESCRIPTION
A	2020.08.18	TI- SCHEMATIC DESIGN
B	2020.10.16	TI- DESIGN DEVELOPMENT
C	2020.12.16	GMP SET
D	2020.12.22	ADDENDUM #1
E	2021.01.08	ADDENDUM #2

SHEET NAME:
ELECTRICAL
ENLARGED POWER
PLANS

DATE: 2020.12.16
CURRENT: 2021.01.08

ADDENDUM #2

SHEET:

E-301

GMP SET

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ESB SWITCHBOARD MANUAL TRANSFER SCHEME:

PROVIDE A (3) POSITION OPERATOR SWITCH FOR SELECTING MAIN - OFF - SEC 1.

- SELECTING "OFF" SHALL OPEN ALL BREAKERS AND SHALL BE USED FOR THE MAINTENANCE.
- SELECTING "MAIN" OR "SEC 1" SHALL INITIATE A 5 SECOND DELAY BEFORE THE SELECTED MAIN BREAKERS ARE CLOSED.

MAIN BREAKERS AND TEMPORARY GENERATOR BREAKER SHALL BE ELECTRICALLY OPERATED INSULATED CASE BREAKERS.

MAIN AND TEMPORARY GENERATOR CIRCUIT BREAKERS SHALL BE ELECTRICALLY INTERLOCKED WITH EACH OTHER SO THAT THE TEMPORARY GENERATOR CIRCUIT BREAKER CAN NOT BE CLOSED UNTIL THE MAIN BREAKERS ARE OPEN.

GENERAL NOTES:


- CIRCUIT BREAKERS NOTED WITH ASTERISKS (*) SHALL BE LSIG TYPE WITH GROUND FAULT ALARM ONLY.
- ALL EMERGENCY AND CRITICAL OPERATIONS SYSTEMS OVERCURRENT PROTECTION DEVICES SHALL BE SELECTIVELY COORDINATED. ATS' SHOWN ON THIS DRAWING SERVE EITHER EMERGENCY OR CRITICAL OPERATIONS SYSTEMS.
- REFER TO UPS, GENERATOR AND ATS EQUIPMENT SCHEDULES ON ELECTRICAL SCHEDULES SHEETS.

BASIS OF DESIGN BREAKERS TO BE UTILIZED:
 480/277V SYSTEM
 GENERATOR BREAKERS = SQUARE D MASTER PACK NW WITH ADJUSTABLE LSI.
 FEEDER BREAKERS 70A TO 600A = SQUARE D L-FRAME MISSION CRITICAL WITH ADJUSTABLE LSI.
 BRANCH BREAKERS UP TO 60A = SQUARE D E-FRAME.
 208/120V SYSTEM
 FEEDER AND MAIN BREAKERS 400A TO 600A = SQUARE D M-FRAME WITH ADJUSTABLE LSI.
 FEEDER AND MAIN BREAKERS 100A TO 250A = SQUARE D J-FRAME MISSION CRITICAL WITH ADJUSTABLE LSI.

MANUFACTURER SHALL PROVIDE BREAKER FRAME SIZES AND TRIP UNITS AS LISTED ABOVE AND NEEDED TO ACHIEVE SELECTIVE COORDINATION. ANY ADJUSTMENTS TO SCHEDULED BREAKERS AND EQUIPMENT SHALL BE PROVIDED AT NO ADDITIONAL COST TO THE OWNER.

KEY NOTES:

- RUN FEEDER(S) VERTICALLY ENCASED IN A MINIMUM OF 2 INCHES OF CONCRETE PER NEC REQUIREMENTS.
- INSTALL FEEDER UNDERGROUND PER NEC ARTICLE 708 REQUIREMENTS.
- INSTALL ABOVE GRADE/FLOOR VERTICAL FEEDER IN RIGID CONDUIT.
- INSTALL FEEDER IN CONCRETE SLAB PER NEC ARTICLE 708 REQUIREMENTS.
- PROVIDE MANUAL TRANSFER SELECTOR SWITCH IN MAIN SWITCHBOARD SECTION WITH THE FOLLOWING FEATURES:
 - MAIN BREAKER(S) SHALL BE ELECTRICALLY OPERATED INSULATED CASE BREAKERS
 - SEE MANUAL TRANSFER SWITCH SCHEME DESCRIPTION ON THIS SHEET.
- PROVIDE INPUT SIGNALS FROM GENERATOR SETS TO UPS-B AND UPS-A. UPS BATTERY CHARGING CURRENT SHALL BE REDUCED TO A SET VALUE WHILE THE UPS SYSTEM IS CONNECTED TO THE EMERGENCY BACK UP POWER AND UNTIL THE NORMAL POWER IS RESTORED. UPS BATTERY CHARGING RATE SHALL SET BY THE UPS INSTALLER DURING THE START-UP.
- PROVIDE CIRCUIT BREAKER WITH LSI FUNCTIONS AND GROUND FAULT ALARM ONLY. PROVIDE ENERGY-REDUCING ARC FLASH MITIGATION SYSTEM.
- INSTALL 1" CONDUIT UNDERGROUND FOR CONTROLS WIRING BETWEEN EG1 AND EG2.

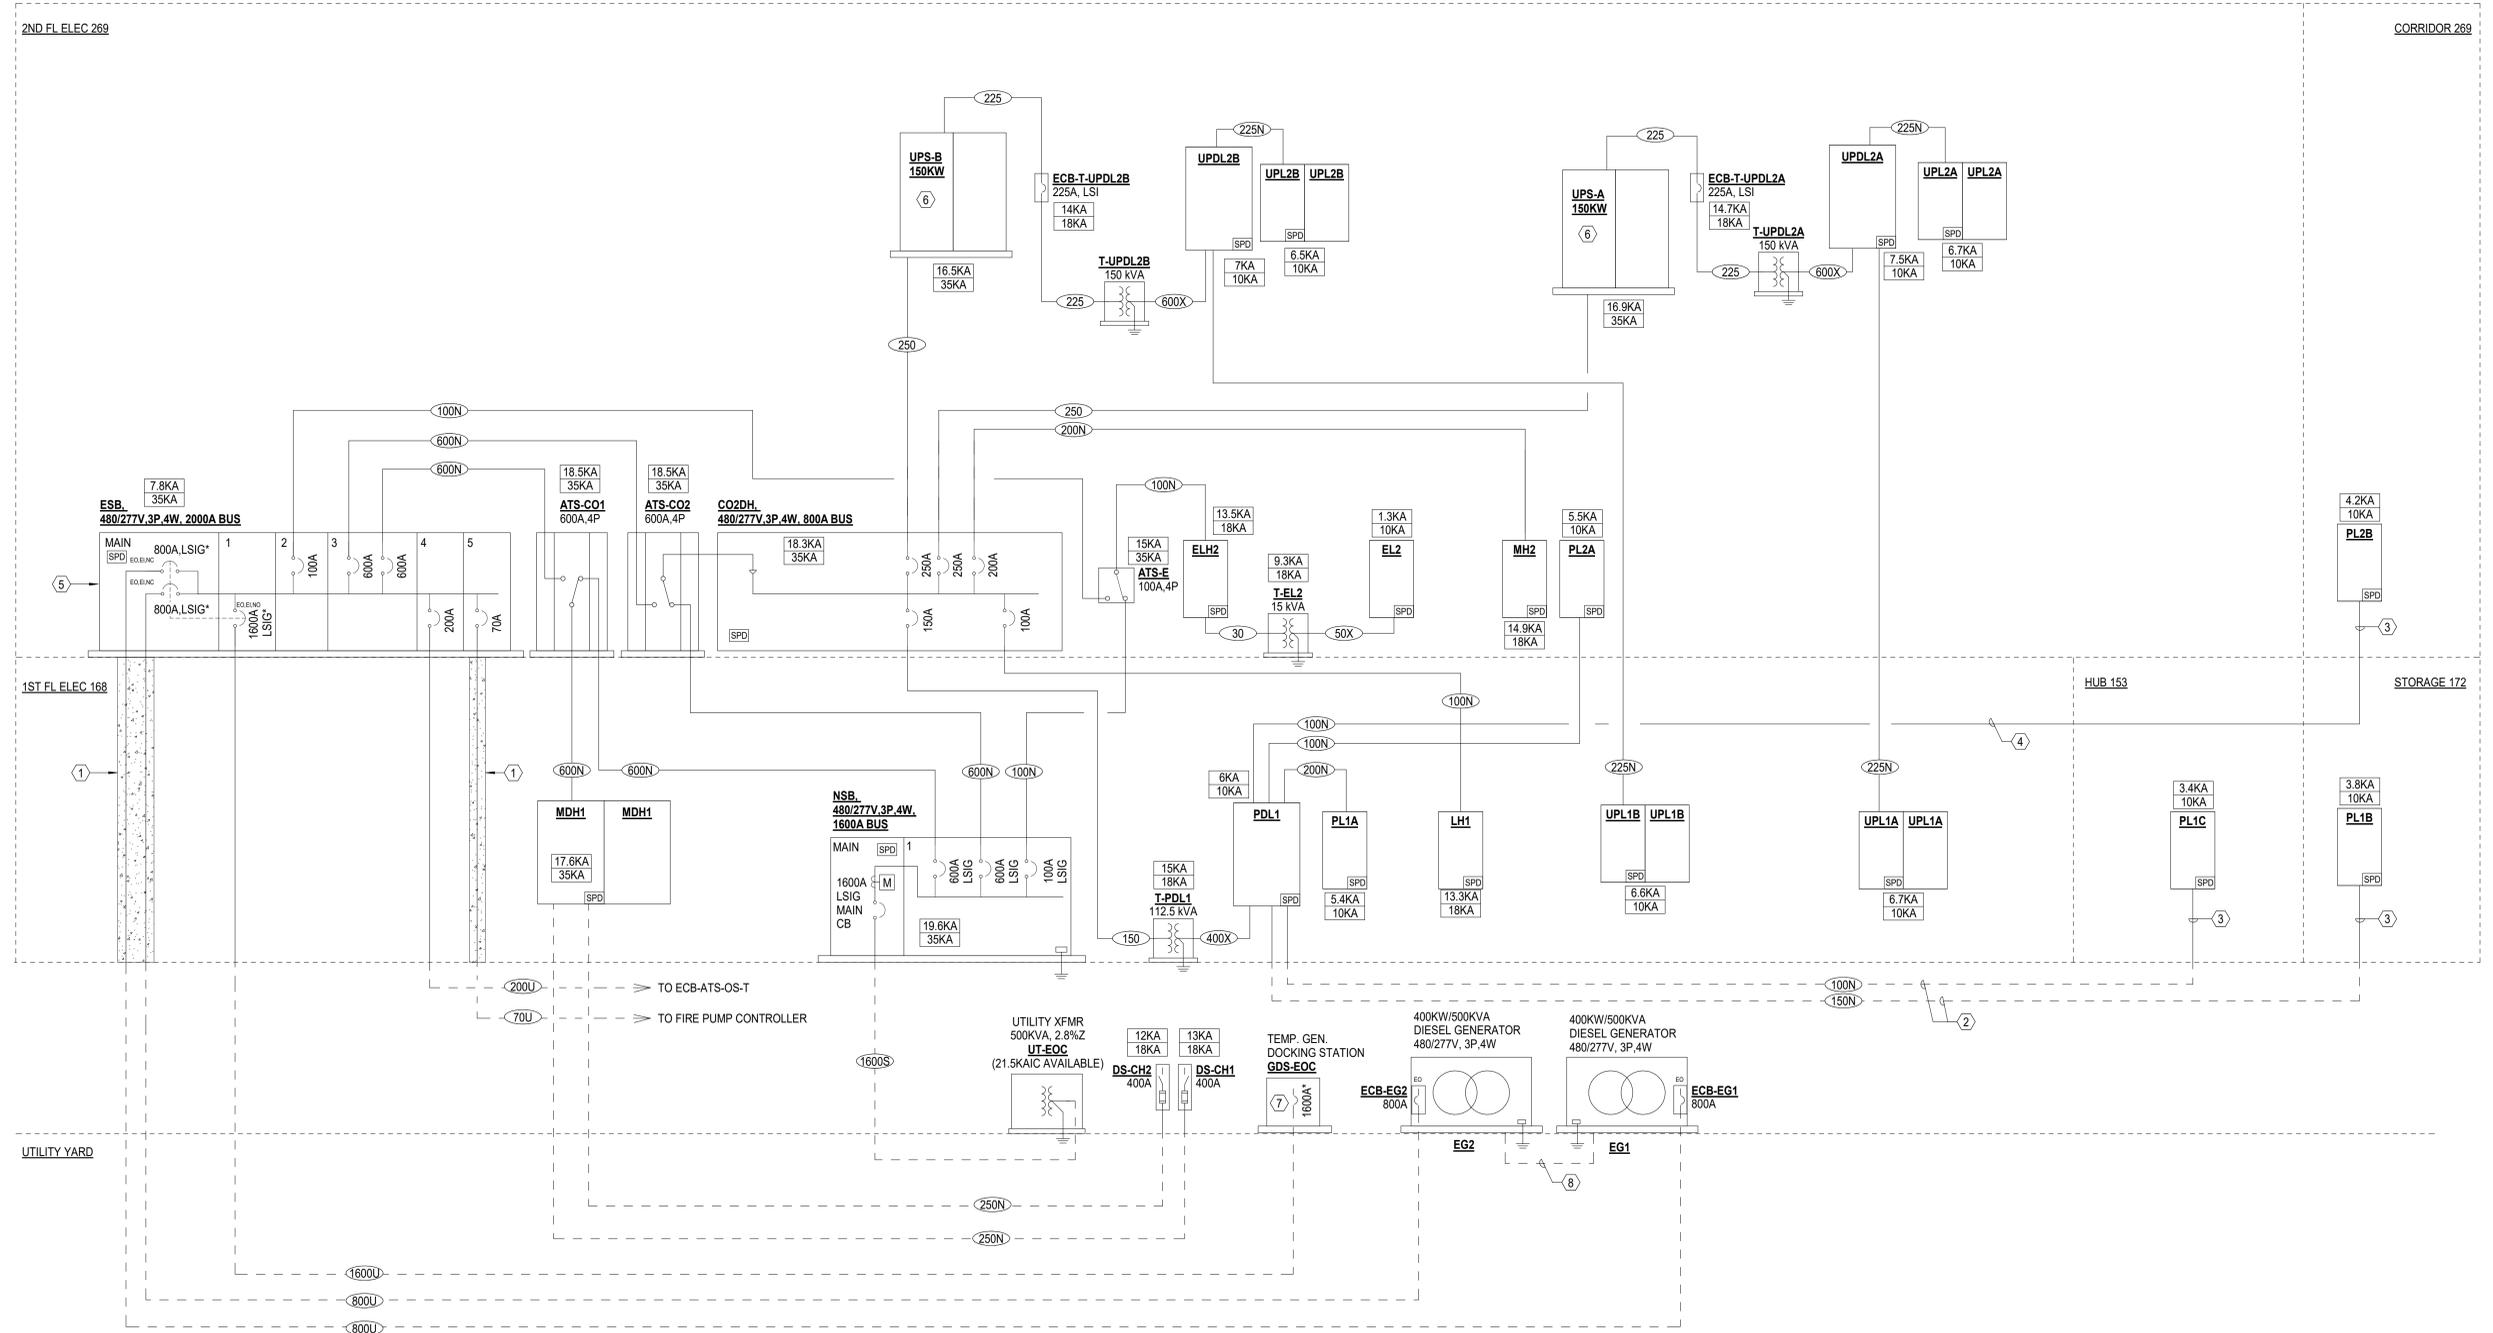

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**NEW HANOVER COUNTY
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 WILMINGTON, NC 28403

DATE	DESCRIPTION
A 2020.08.18	T1- SCHEMATIC DESIGN
B 2020.10.16	T1- DESIGN DEVELOPMENT
C 2020.12.16	GMP SET
E 2021.01.08	ADDENDUM #2

SHEET NAME:
 ELECTRICAL RISER
 DIAGRAM EOC

DATE: 2020.12.16
 CURRENT: 2021.01.08
 ADDENDUM #2

SHEET:
E-401

GMP SET

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C	2020.12.16	GMP SET
E	2021.01.08	ADDENDUM #2

SHEET NAME:
ELECTRICAL RISER
DIAGRAM TOWER

DATE: 2020.12.16
CURRENT: 2021.01.08
ADDENDUM #2


SHEET:
E-402

GMP SET

KEY NOTES:

- 1 FIRE PUMP CONTROLLER, FURNISHED AND INSTALLED BY DIV 22.
- 2 PROVIDE A MANUAL TRANSFER SCHEME FOR THE SWITCHBOARD WITH THE FOLLOWING FEATURES:
 - MAIN BREAKER(S) SHALL BE ELECTRICALLY OPERATED INSULATED CASE BREAKERS
 - SEE MANUAL TRANSFER SWITCH SCHEME DESCRIPTION ON THIS SHEET.
- 3 PROVIDE CIRCUIT BREAKER WITH LSI FUNCTIONS AND GROUND FAULT ALARM ONLY. PROVIDE ENERGY-REDUCING ARC FLASH MITIGATION SYSTEM.

PANELBOARD DESIGNATION SCHEME:

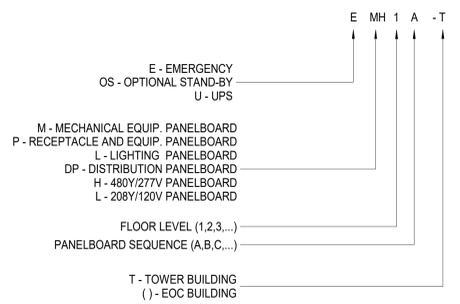

FEEDER SIZE SCHEDULE

FEEDER MARK	COPPER CONDUCTORS AND CONDUIT SIZE
20N	4 #12 AND 1 #12 G - 0.75" C
20X	4 #12 AND 1 #8 G - 0.75" C
20	3 #12 AND 1 #12 G - 0.75" C
30N	4 #10 AND 1 #10 G - 0.75" C
30X	4 #10 AND 1 #8 G - 0.75" C
30	3 #10 AND 1 #10 G - 0.75" C
40N	4 #8 AND 1 #10 G - 1" C
40	3 #8 AND 1 #10 G - 1" C
50N	4 #6 AND 1 #8 G - 1.25" C
50X	4 #6 AND 1 #8 G - 1.25" C
50	3 #6 AND 1 #8 G - 1.25" C
60N	4 #4 AND 1 #8 G - 1.25" C
60	3 #4 AND 1 #8 G - 1.25" C
70U	3 #4 AND 1 #8 G - 4" C & (1) SPARE 4" C
70S	4 #4 - 4" C & (1) SPARE 4" C
100N	4 #2 AND 1 #8 G - 1.5" C
100X	4 #1 AND 1 #6 G - 1.5" C
100	3 #2 AND 1 #8 G - 1.5" C
125N	4 #1/0 AND 1 #6 G - 2" C
125	3 #1/0 AND 1 #6 G - 2" C
150N	4 #2/0 AND 1 #6 G - 2" C
150X	4 #2/0 AND 1 #4 G - 2" C
150	3 #2/0 AND 1 #6 G - 2" C
200N	4 #3/0 AND 1 #6 G - 2" C
200U	4 #3/0 AND 1 #6 G - 4" C & (1) SPARE 4" C
200	3 #3/0 AND 1 #6 G - 2" C
225N	4 #4/0 AND 1 #4 G - 2.5" C
225X	4 #4/0 AND 1 #2 G - 2.5" C
225	3 #4/0 AND 1 #4 G - 2.5" C
250N	4 #250 kcmil AND 1 #4 G - 3" C
250	3 #250 kcmil AND 1 #4 G - 3" C
300N	4-300 kcmil AND 1 #4 G - 3" C
300	3-300 kcmil AND 1 #4 G - 3" C
350N	4-400 kcmil AND 1 #3 G - 3" C
350	3-400 kcmil AND 1 #3 G - 3" C
400N	4-500 kcmil AND 1 #3 G - 3.5" C
400X	2 SETS (4 #3/0 AND 1 #1/0 G - 2.5" C)
400	3-500 kcmil AND 1 #3 G - 3.5" C
500N	4-250 kcmil AND 1 #2 G - 3" C
600N	2 SETS (4-350 kcmil AND 1 #2/0 G - 3" C)
600X	2 SETS (4-350 kcmil AND 1 #2/0 G - 3" C)
600	2 SETS (3-350 kcmil AND 1 #2/0 G - 3" C)
800U	2 SETS (4-500 kcmil AND 1 #2/0 G - 4" C) & (1) SPARE 4" C
800	2 SETS (3-500 kcmil AND 1 #2/0 G - 3.5" C)
1000N	3 SETS (4-400 kcmil AND 1 #2/0 G - 3.5" C)
1200N	4 SETS (4-350 kcmil AND 1 #3/0 G - 3" C)
1200S	4 SETS (4-350 kcmil - 4" C) & (2) SPARE 4" C
1600U	6 SETS (4-300 kcmil AND 1 #4/0 G - 4" C) & (2) SPARE 4" C
1600S	6 SETS (4-300 kcmil - 4" C) & (2) SPARE 4" C
3000S	8 SETS (4-500 kcmil - 4" C) & (1) SPARE 4" C
3000U	8 SETS (4-500 kcmil AND 1-400 kcmil G - 4" C) & (1) SPARE 4" C

DRY-TYPE TRANSFORMER FEEDER SCHEDULE

kVA	PRIMARY FEEDER MARK	SECONDARY FEEDER MARK	GROUNDING ELECTRODE CONDUCTOR
9	20	30X	#8
15	30	50X	#8
30	50	100X	#6
45	70	150X	#4
75	125	225X	#2
112.5	150	400X	#1/0
150	225	600X	#2/0
225	350	800X	#2/0
300	400	1000X	#3/0
500	800	1600X	#3/0

NOTES:
1. TRANSFORMER FEEDER SIZES BASED ON 480 V, 3-PHASE, DELTA PRIMARY AND 208Y/120 V, 3-PHASE, 4-WIRE SECONDARY.
2. GROUNDING ELECTRODE CONDUCTORS SHALL BE INSTALLED IN METALLIC RACEWAY, MINIMUM SIZE PER NFPA 70, ARTICLE 250.
3. REFER TO FEEDER SIZE SCHEDULE FOR CONDUCTORS AND RACEWAYS.


MSB-T SWITCHBOARD MANUAL TRANSFER SCHEME:

PROVIDE A (3) POSITION OPERATOR SWITCH FOR SELECTING MAIN 1 - OFF - MAIN 2.

- SELECTING "OFF" SHALL OPEN ALL MAIN BREAKERS AND SHALL BE USED FOR THE MAINTENANCE.
- SELECTING "MAIN 1" OR "MAIN 2" SHALL INITIATE A 5 SECOND DELAY BEFORE THE SELECTED MAIN BREAKERS ARE CLOSED.

MAIN BREAKERS SHALL BE ELECTRICALLY OPERATED INSULATED CASE BREAKERS.

MAIN AND TEMPORARY GENERATOR CIRCUIT BREAKERS SHALL BE ELECTRICALLY INTERLOCKED WITH EACH OTHER SO THAT THE TEMPORARY GENERATOR CIRCUIT BREAKER CAN NOT BE CLOSED UNTIL THE MAIN BREAKER IS OPEN.

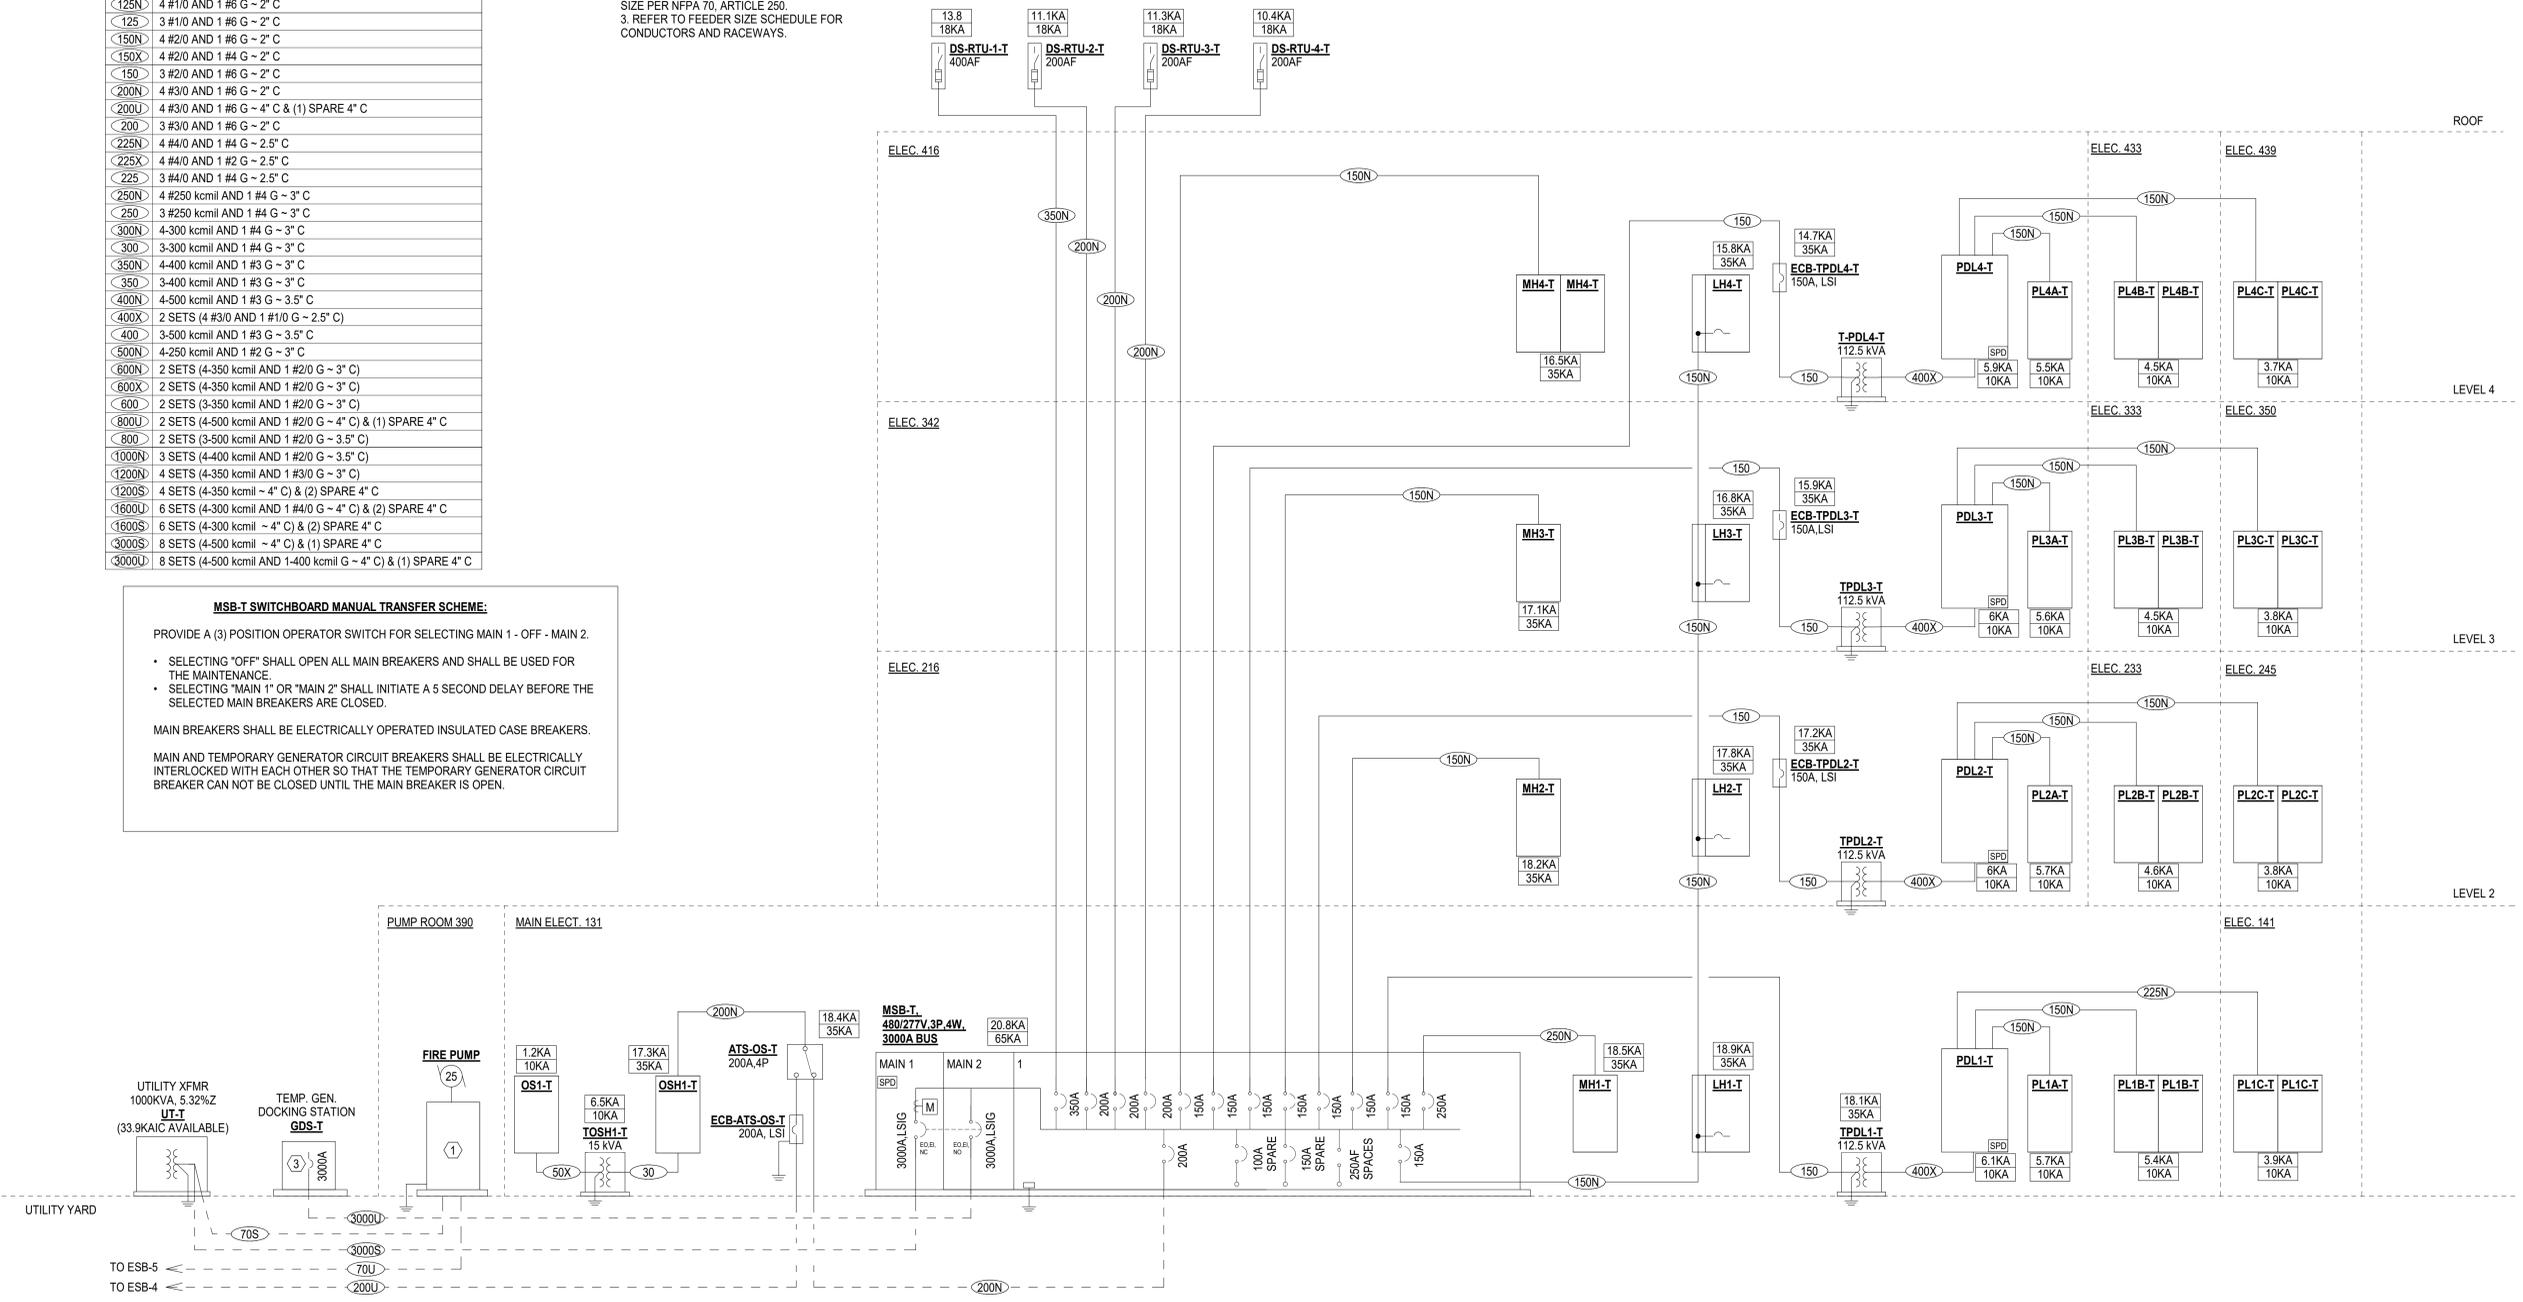

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LIGHTING CONTROL RELAY PANEL "LCP1" SCHEDULE					
CONTACTOR	POWER CIRCUIT	LOAD (WATTS)	DESCRIPTION	OVERRIDE SWITCH	CONTROL NOTES
R1	LH1:13	50	EOC EXTERIOR LIGHTING	N/A	
R2	LH1:7	200	EOC SERVICE YARD LIGHTING	OR3	
R3	LH1:5	1800	EOC 2ND LEVEL HIGH BAY LIGHTING	OR2	
R4-R5			SPARE		
BARRIER BETWEEN 120V AND 277V RELAYS					
R6	PL1A:65	500	EOC BUILDING SIGNAGE NORTH	N/A	
R7	PL1A:67	500	EOC BUILDING SIGNAGE SOUTH	N/A	
R8-R9			SPARE		
BARRIER BETWEEN NORMAL AND EMERGENCY RELAYS					
ER1	ELH2:7	135	EOC EXTERIOR LIGHTING	N/A	
ER2	ELH2:9	100	EOC SERVICE YARD LIGHTING	OR3	
ER3-ER7			SPARE		
PROVIDE DIGITAL TIME CLOCK INSIDE THE RELAY PANEL.					
PROVIDE VOLTAGE BARRIERS BETWEEN 120V AND 277V BRANCH CIRCUITS.					
PROVIDE BARRIER BETWEEN NORMAL AND EMERGENCY RELAYS.					

LIGHTING CONTROL RELAY PANEL "LCP4-T" SCHEDULE					
CONTACTOR	POWER CIRCUIT	LOAD (WATTS)	DESCRIPTION	OVERRIDE SWITCH	CONTROL NOTES
R1	LH4-T:1	800	FACADE LIGHTING	N/A	
R2-R4			SPARE		
BARRIER BETWEEN 120V AND 277V RELAYS					
R5	PL4C-T:55	500	TOWER SIGNAGE WEST	N/A	
R6	PL4B-T:37	500	TOWER SIGNAGE SOUTH	N/A	
R7-R8			SPARE		
PROVIDE VOLTAGE BARRIER BETWEEN 120V AND 277V BRANCH CIRCUITS.					

LIGHTING CONTROL RELAY PANEL "LCP1A-T" SCHEDULE					
CONTACTOR	POWER CIRCUIT	LOAD (WATTS)	DESCRIPTION	OVERRIDE SWITCH	CONTROL NOTES
R1	LH1-T:1	350	TOWER EXTERIOR LIGHTING	N/A	
R2	LH1-T:3	1500	LOBBY DOWNLIGHTS	OR1	
R3	LH1-T:5	1900	LOBBY B LINEAR LIGHTING	OR1	
R4	LH2-T:1	1500	LOBBY A HIGH BAY LIGHTING	OR1	
R5	LH1-T:21	500	SITE LIGHTING	N/A	
R6	LH1-T:23	500	SITE LIGHTING	N/A	
R7	LH1-T:25	500	SITE LIGHTING	N/A	
R8-R16			SPARE		
PROVIDE DIGITAL TIME CLOCK INSIDE THE RELAY PANEL.					

LIGHTING CONTROL RELAY PANEL "LCP1B-T" SCHEDULE					
CONTACTOR	POWER CIRCUIT	LOAD (WATTS)	DESCRIPTION	OVERRIDE SWITCH	CONTROL NOTES
R1	PL1C-T:105	220	MEDIA LIGHTING	OR4	
R2	PL1C-T:107	220	MEDIA LIGHTING	OR4	
R3	PL1C-T:96	220	MEDIA LIGHTING	OR4	
R4	PL1C-T:58	220	MEDIA LIGHTING	OR4	
R5	PL1C-T:60	220	MEDIA LIGHTING	OR4	
R6	PL1C-T:62	220	MEDIA LIGHTING	OR4	
R7	PL1C-T:64	220	MEDIA LIGHTING	OR4	
R8	PL1C-T:66	220	MEDIA LIGHTING	OR4	
R9	PL1C-T:68	220	MEDIA LIGHTING	OR4	
R10	PL1C-T:70	220	MEDIA LIGHTING	OR4	
R11	PL1C-T:72	220	MEDIA LIGHTING	OR4	
R12	PL1C-T:74	220	MEDIA LIGHTING	OR4	
R13	PL1C-T:76	220	MEDIA LIGHTING	OR4	
R14	PL1C-T:78	220	MEDIA LIGHTING	OR4	
R15	PL1C-T:80	220	MEDIA LIGHTING	OR4	
R16	PL1C-T:82	220	MEDIA LIGHTING	OR4	
R17	PL1C-T:89	1500	136 TRAINING TRACK LIGHTING	FRESCO...	
R18	PL1C-T:91	1500	136 TRAINING TRACK LIGHTING	FRESCO TOUCHPAD	
R19	PL1C-T:93	1500	137 TRAINING TRACK LIGHTING	FRESCO TOUCHPAD	
R20	PL1C-T:95	1500	137 TRAINING TRACK LIGHTING	FRESCO TOUCHPAD	
R21	PL1C-T:97	1500	139 CONFERENCE TRACK LIGHTING	FRESCO TOUCHPAD	
R22	PL1C-T:99	1500	139 CONFERENCE TRACK LIGHTING	FRESCO TOUCHPAD	
R23	PL1C-T:101	1500	120B LOBBY B TRACK LIGHTING	FRESCO TOUCHPAD	
R24	PL1C-T:103	1500	120B LOBBY B TRACK LIGHTING	FRESCO TOUCHPAD	
R25-R29			SPARE		
BARRIER BETWEEN 120V AND 277V BRANCH CIRCUITS					
R30	LH1-T:19	250	MEDIA OVERHEAD LIGHTING	OR4	
R31-R32			SPARE		
PROVIDE VOLTAGE BARRIER BETWEEN 120V AND 277V BRANCH CIRCUITS.					

AUTOMATIC TRANSFER SWITCH SCHEDULE									
NAME	VOLTAGE	AMPERES	POLES	BYPASS ISOLATION	CLOSED TRANSITION	WITHSTAND RATING, AIC	PRIORITY	LOAD SHED FUNCTIONALITY	
ATS-CO1	480 V	600 A	4	Yes	No	35000	1	Yes	
ATS-CO2	480 V	600 A	4	Yes	No	35000	1	Yes	
ATS-E	480 V	100 A	4	Yes	No	25000	0	No	
ATS-OS-T	480 V	100 A	4	No	No	25000	2	Yes	

- NOTES:
1. 0 IS THE HIGHEST PRIORITY LOAD AND SHALL BE LOADED FIRST AND SHALL NOT BE SHED.
2. CLOSING SEQUENCE OF ATS'S IS DETERMINED BY PRIORITY.
3. ALL ATS SHALL BE FRONT CONNECTED TYPE.

ENGINE GENERATOR SET SCHEDULE										
NO.	RATING		VOLTAGE	HZ	RPM	UNIT MOUNTED CIRCUIT BREAKERS				
	KW	KVA				CKT	CIRCUIT BREAKER	EQUIPMENT SERVED	FEEDER MARK	NOTES
EG1	400	500	480Y/277	60	1800	1	800A/3P.LSI	ESB	800U	1,2,3,4,5,6
EG2	400	500	480Y/277	60	1800	1	800A/3P.LSI	ESB	800U	1,2,3,4,5,6

NOTES:
1. UNIT MOUNTED CIRCUIT BREAKERS SHALL BE 100% RATED, ELECTRICALLY OPERATED, MANUFACTURER SHALL BE THE SAME AS SWITCHBOARDS.
2. UNIT SHALL BE STANDBY RATED, 3- PHASE, 4 WIRE, WYE CONNECTED.
3. RATING SHALL APPLY AT SITE CONDITIONS OF 1000' ABOVE SEA LEVEL AND AT 110F AMBIENT TEMPERATURE (EXCLUDING ENGINE RADIATION EFFECTS).
4. ENGINE GENERATOR ALTERNATOR SHALL BE SIZED TO LIMIT VOLTAGE DROP TO LESS THAN 15% FOR FIRE PUMP.
5. ENGINE GENERATOR SHALL BE EQUIPPED WITH ON-BOARD PARALLELING CONTROLLER.
6. PROVIDE ADDITIONAL GENERATOR MOUNTED 800A/3P CIRCUIT BREAKER WITH QUICK CONNECTS ON LOAD SIDE FOR TEMPORARY PORTABLE LOAD BANK CONNECTION. GENERATOR SHALL HAVE PROVISIONS TO CONNECT LOAD DUMP SIGNAL TO TEMPORARY PORTABLE LOAD BANK.

UNINTERRUPTIBLE POWER SUPPLY SCHEDULE														
DESIGNATION	SYSTEM LOAD INPUT VOLTAGE			BYPASS INPUT VOLTAGE (NOTE 3)			BATTERY PROTECT TIME, MINUTES	BATTERY TYPE	SYSTEM OUTPUT VOLTAGE			OUTPUT KVA	OUTPUT KW	POWER FACTOR
	VOLTS	PHASE	WIRES (NOTE 1)	VOLTS	PHASE	WIRES (NOTE 1)			VOLTS	PHASE	WIRES (NOTE 1)			
UPS-A	480	3	3	480	3	3	10	VRLA	480	3	3	160	144	0.9
UPS-B	480	3	3	480	3	3	10	VRLA	480	3	3	160	144	0.9

NOTES:
1. PLUS EQUIPMENT GROUND.
2. SYSTEM EFFICIENCY SHALL BE THE MINIMUM OVERALL AC-TO-AC SYSTEM EFFICIENCY, INPUT-TO-OUTPUT.
3. PROVIDE FLOOR MOUNTED BYPASS CABINET.
4. UPS SIZED TO CARRY FULL UNINTERRUPTIBLE LOAD (N+1 REDUNDANCY).



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A	DATE	DESCRIPTION
A	2020.08.18	TI- SCHEMATIC DESIGN
B	2020.10.16	TI- DESIGN DEVELOPMENT
C	2020.12.16	GMP SET
D	2020.12.22	ADDENDUM #1
E	2021.01.08	ADDENDUM #2

SHEET NAME: ELECTRICAL SCHEDULES

DATE: 2020.12.16

CURRENT: 2021.01.08

ADDENDUM #2

SHEET:

E-501

GMP SET

Newcomb & Boyd CONSULTANTS AND ENGINEERS Consulting Engineering Group 5425 Page Rd Suite 215 Durham, NC 27703 T 919 783-7812 Contact: Paul J. Kitchens N&B PROJECT: 19N342 Firm License No. F-0312



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NHC Government Center 7702-190810

NEW HANOVER COUNTY GOVERNMENT CENTER GOVERNMENT CENTER DRIVE WILMINGTON, NC 28403 LS3P PROJECT: 7702-190810

Table with columns: A, B, C, D, E, DATE, DESCRIPTION. Includes revision history for schematic design, design development, GMP set, and addendums.

SHEET NAME: ELECTRICAL SCHEDULES

DATE: 2020.12.16 CURRENT: 2021.01.08

ADDENDUM #2

SHEET: E-502

GMP SET

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MECHANICAL EQUIPMENT CONNECTION SCHEDULE table with columns: NAME, DESCRIPTION, LOAD, CONNECTION INFO (VOLTAGE, NUMBER OF POLES), MOTOR INFO (QUANTITY, HP), HOMERUN INFO (PANEL, CIRCUIT), DISCONNECT, STARTER, NOTES. Lists various equipment like AHU, CHILLER, FAN, ELEVATOR, PUMP, HEATER, etc.

MECHANICAL EQUIPMENT CONNECTION SCHEDULE NOTES: 1. STARTER: FVNR - FULL VOLTAGE NON-REVERSING... 2. STARTERS WILL BE FURNISHED UNDER OTHER DIVISIONS... 3. SEE ELECTRICAL EQUIPMENT SCHEDULES... 4. PROVIDE DISCONNECT SWITCH AS INDICATED... 5. PROVIDE SHUNT TRIP AT UPSTREAM CIRCUIT BREAKER... 6. PROVIDE FUSES SIZED PER MANUFACTURER REQUIREMENTS...

TERMINAL UNIT CONNECTION SCHEDULE - LEVEL 1 table with columns: NAME, DESCRIPTION, LOAD, CONNECTION INFO (VOLTAGE, NUMBER OF POLES), MOTOR INFO (QUANTITY, HP), HOMERUN INFO (PANEL, CIRCUIT), DISCONNECT, STARTER, NOTES. Lists terminal units S100 through S145.

TERMINAL UNIT CONNECTION SCHEDULE - LEVEL 2 table with columns: NAME, DESCRIPTION, LOAD, CONNECTION INFO (VOLTAGE, NUMBER OF POLES), MOTOR INFO (QUANTITY, HP), HOMERUN INFO (PANEL, CIRCUIT), DISCONNECT, STARTER, NOTES. Lists terminal units S200 through S250.

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TERMINAL UNIT CONNECTION SCHEDULE - LEVEL 4											
NAME	DESCRIPTION	LOAD	CONNECTION INFO		MOTOR INFO		HOMERUN INFO		DISCONNECT	STARTER	NOTES
			VOLTAGE	NUMBER OF POLES	QUANTITY	HP	PANEL	CIRCUIT			
S400	TERMINAL UNIT	4.0 kVA	277 V	1	1	0.5	MH4-T	1	INTEGRAL		
S401	TERMINAL UNIT	2.0 kVA	277 V	1	1	0.3	MH4-T	3	INTEGRAL		
S402	TERMINAL UNIT	2.0 kVA	277 V	1	1	0.3	MH4-T	5	INTEGRAL		
S403	TERMINAL UNIT	0.5 kVA	277 V	1			MH4-T	7	INTEGRAL		
S404	TERMINAL UNIT	0.5 kVA	277 V	1			MH4-T	9	INTEGRAL		
S405	TERMINAL UNIT	0.5 kVA	277 V	1			MH4-T	11	INTEGRAL		
S406	TERMINAL UNIT	3.0 kVA	277 V	1	1	0.3	MH4-T	13	INTEGRAL		
S407	TERMINAL UNIT	0.5 kVA	277 V	1			MH4-T	15	INTEGRAL		
S408	TERMINAL UNIT	0.5 kVA	277 V	1			MH4-T	17	INTEGRAL		
S409	TERMINAL UNIT	0.5 kVA	277 V	1			MH4-T	19	INTEGRAL		
S410	TERMINAL UNIT	0.5 kVA	277 V	1			MH4-T	21	INTEGRAL		
S411	TERMINAL UNIT	2.0 kVA	277 V	1	1	0.3	MH4-T	23	INTEGRAL		
S412	TERMINAL UNIT	3.0 kVA	277 V	1	1	0.3	MH4-T	25	INTEGRAL		
S413	TERMINAL UNIT	3.0 kVA	277 V	1	1	0.3	MH4-T	27	INTEGRAL		
S414	TERMINAL UNIT	0.5 kVA	277 V	1			MH4-T	29	INTEGRAL		
S415	TERMINAL UNIT	0.5 kVA	277 V	1			MH4-T	31	INTEGRAL		
S416	TERMINAL UNIT	1.0 kVA	277 V	1			MH4-T	33	INTEGRAL		
S417	TERMINAL UNIT	0.5 kVA	277 V	1			MH4-T	35	INTEGRAL		
S418	TERMINAL UNIT	0.5 kVA	277 V	1			MH4-T	37	INTEGRAL		
S419	TERMINAL UNIT	0.5 kVA	277 V	1			MH4-T	39	INTEGRAL		
S420	TERMINAL UNIT	0.5 kVA	277 V	1			MH4-T	41	INTEGRAL		
S421	TERMINAL UNIT	0.5 kVA	277 V	1			MH4-T	2	INTEGRAL		
S422	TERMINAL UNIT	0.5 kVA	277 V	1			MH4-T	4	INTEGRAL		
S423	TERMINAL UNIT	0.5 kVA	277 V	1			MH4-T	6	INTEGRAL		
S424	TERMINAL UNIT	0.5 kVA	277 V	1			MH4-T	43	INTEGRAL		
S425	TERMINAL UNIT	1.0 kVA	277 V	1			MH4-T	45	INTEGRAL		
S426	TERMINAL UNIT	1.5 kVA	277 V	1			MH4-T	8	INTEGRAL		
S427	TERMINAL UNIT	1.5 kVA	277 V	1			MH4-T	10	INTEGRAL		
S428	TERMINAL UNIT	1.0 kVA	277 V	1			MH4-T	47	INTEGRAL		
S429	TERMINAL UNIT	0.5 kVA	277 V	1			MH4-T	12	INTEGRAL		
S430	TERMINAL UNIT	1.0 kVA	277 V	1			MH4-T	49	INTEGRAL		
S431	TERMINAL UNIT	1.0 kVA	277 V	1	1	0.3	MH4-T	14	INTEGRAL		
S432	TERMINAL UNIT	0.5 kVA	277 V	1			MH4-T	16	INTEGRAL		
S433	TERMINAL UNIT	2.0 kVA	277 V	1	1	0.3	MH4-T	18	INTEGRAL		
S434	TERMINAL UNIT	1.0 kVA	277 V	1	1	0.3	MH4-T	51	INTEGRAL		
S435	TERMINAL UNIT	1.0 kVA	277 V	1	1	0.3	MH4-T	53	INTEGRAL		
S436	TERMINAL UNIT	0.5 kVA	277 V	1			MH4-T	55	INTEGRAL		
S437	TERMINAL UNIT	4.0 kVA	277 V	1	1	0.5	MH4-T	57	INTEGRAL		
S438	TERMINAL UNIT	2.0 kVA	277 V	1	1	0.3	MH4-T	59	INTEGRAL		
S439	TERMINAL UNIT	2.0 kVA	277 V	1	1	0.3	MH4-T	61	INTEGRAL		
S440	TERMINAL UNIT	0.5 kVA	277 V	1			MH4-T	63	INTEGRAL		
S441	TERMINAL UNIT	0.5 kVA	277 V	1			MH4-T	65	INTEGRAL		
S442	TERMINAL UNIT	0.5 kVA	277 V	1			MH4-T	67	INTEGRAL		
S443	TERMINAL UNIT	0.5 kVA	277 V	1			MH4-T	69	INTEGRAL		
S444	TERMINAL UNIT	0.5 kVA	277 V	1			MH4-T	71	INTEGRAL		
S445	TERMINAL UNIT	0.5 kVA	277 V	1			MH4-T	73	INTEGRAL		
S446	TERMINAL UNIT	0.5 kVA	277 V	1			MH4-T	75	INTEGRAL		
S447	TERMINAL UNIT	0.5 kVA	277 V	1			MH4-T	77	INTEGRAL		
S448	TERMINAL UNIT	1.0 kVA	277 V	1	1	0.3	MH4-T	79	INTEGRAL		
S449	TERMINAL UNIT	3.0 kVA	277 V	1	1	0.3	MH4-T	81	INTEGRAL		
S450	TERMINAL UNIT	3.0 kVA	277 V	1	1	0.3	MH4-T	83	INTEGRAL		
S451	TERMINAL UNIT	2.0 kVA	277 V	1	1	0.3	MH4-T	44	INTEGRAL		
S452	TERMINAL UNIT	1.0 kVA	277 V	1	1	0.3	MH4-T	46	INTEGRAL		
S453	TERMINAL UNIT	0.5 kVA	277 V	1			MH4-T	48	INTEGRAL		
S455	TERMINAL UNIT	0.5 kVA	277 V	1			MH4-T	50	INTEGRAL		

TERMINAL UNIT CONNECTION SCHEDULE - LEVEL 3											
NAME	DESCRIPTION	LOAD	CONNECTION INFO		MOTOR INFO		HOMERUN INFO		DISCONNECT	STARTER	NOTES
			VOLTAGE	NUMBER OF POLES	QUANTITY	HP	PANEL	CIRCUIT			
S300	TERMINAL UNIT	3.0 kVA	277 V	1	1	0.5	MH3-T	1	INTEGRAL		
S301	TERMINAL UNIT	2.0 kVA	277 V	1	1	0.3	MH3-T	3	INTEGRAL		
S302	TERMINAL UNIT	2.0 kVA	277 V	1	1	0.3	MH3-T	5	INTEGRAL		
S303	TERMINAL UNIT	2.0 kVA	277 V	1	1	0.3	MH3-T	7	INTEGRAL		
S304	TERMINAL UNIT	3.0 kVA	277 V	1	1	0.5	MH3-T	9	INTEGRAL		
S313	TERMINAL UNIT	3.0 kVA	277 V	1	1	0.5	MH3-T	11	INTEGRAL		
S314	TERMINAL UNIT	3.0 kVA	277 V	1	1	0.5	MH3-T	13	INTEGRAL		
S315	TERMINAL UNIT	1.0 kVA	277 V	1	1	0.3	MH3-T	15	INTEGRAL		
S316	TERMINAL UNIT	4.0 kVA	277 V	1	1	0.5	MH3-T	17	INTEGRAL		
S317	TERMINAL UNIT	0.5 kVA	277 V	1			MH3-T	19	INTEGRAL		
S318	TERMINAL UNIT	0.5 kVA	277 V	1			MH3-T	21	INTEGRAL		
S319	TERMINAL UNIT	0.5 kVA	277 V	1			MH3-T	23	INTEGRAL		
S320	TERMINAL UNIT	0.5 kVA	277 V	1			MH3-T	25	INTEGRAL		
S327	TERMINAL UNIT	1.5 kVA	277 V	1			MH3-T	27	INTEGRAL		
S328	TERMINAL UNIT	1.5 kVA	277 V	1			MH3-T	29	INTEGRAL		
S329	TERMINAL UNIT	1.0 kVA	277 V	1	1	0.3	MH3-T	31	INTEGRAL		
S330	TERMINAL UNIT	1.0 kVA	277 V	1	1	0.3	MH3-T	33	INTEGRAL		
S332	TERMINAL UNIT	1.0 kVA	277 V	1	1	0.3	MH3-T	35	INTEGRAL		
S333	TERMINAL UNIT	1.0 kVA	277 V	1	1	0.3	MH3-T	37	INTEGRAL		
S335	TERMINAL UNIT	1.0 kVA	277 V	1	1	0.3	MH3-T	39	INTEGRAL		
S336	TERMINAL UNIT	1.0 kVA	277 V	1	1	0.3	MH3-T	41	INTEGRAL		
S337	TERMINAL UNIT	2.0 kVA	277 V	1	1	0.3	MH3-T	43	INTEGRAL		
S338	TERMINAL UNIT	3.0 kVA	277 V	1	1	0.5	MH3-T	45	INTEGRAL		
S339	TERMINAL UNIT	3.0 kVA	277 V	1	1	0.5	MH3-T	47	INTEGRAL		
S345	TERMINAL UNIT	1.0 kVA	277 V	1	1	0.3	MH3-T	8	INTEGRAL		
S347	TERMINAL UNIT	3.0 kVA	277 V	1	1	0.5	MH3-T	10	INTEGRAL		
S348	TERMINAL UNIT	3.0 kVA	277 V	1	1	0.5	MH3-T	12	INTEGRAL		
S350	TERMINAL UNIT	3.0 kVA	277 V	1	1	0.5	MH3-T	14	INTEGRAL		



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GOVERNMENT CENTER
 GOVERNMENT CENTER DRIVE
 WILMINGTON, NC 28403
 LS3P PROJECT: 7702-190810

A	DATE	DESCRIPTION
A	2020.08.18	TI- SCHEMATIC DESIGN
B	2020.10.16	TI- DESIGN DEVELOPMENT
C	2020.12.16	GMP SET
D	2020.12.22	ADDENDUM #1
E	2021.01.08	ADDENDUM #2

SHEET NAME:
 ELECTRICAL
 SCHEDULES

Newcomb & Boyd
 CONSULTANTS AND ENGINEERS
 Consulting Engineering Group
 5425 Page Rd
 Suite 215
 Durham, NC 27703
 T 919 783-7812
 Contact: Paul J. Kitchens
 N&B PROJECT: 19N342
 Firm License No. F-0312

DATE: 2020.12.16
 CURRENT: 2021.01.08
 ADDENDUM #2

SHEET:
E-503



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NEW HANOVER COUNTY GOVERNMENT CENTER GOVERNMENT CENTER DRIVE WILMINGTON, NC 28403

Table with 2 columns: A, DATE, DESCRIPTION. Rows include 2020.08.18 (Schematic Design), 2020.10.16 (Design Development), 2020.12.16 (GMP SET), 2021.01.22 (Addendum #1), 2021.01.08 (Addendum #2)

SHEET NAME: ELECTRICAL SCHEDULES

DATE: 2020.12.16 CURRENT: 2021.01.08

ADDENDUM #2

SHEET: E-504

GMP SET

PANEL IS FED FROM 600A/3P CB IN SWITCHBOARD NSB

DISTRIBUTION PANELBOARD "UPDL2A" SCHEDULE. Table with columns: CKT, CIRCUIT DESCRIPTION, POLES, TRIP, LOAD, REMARKS, FEEDER TAG. Includes notes on demand factor.

DISTRIBUTION PANELBOARD "MDH1" SCHEDULE: SECTION 1. Table with columns: CKT, CIRCUIT DESCRIPTION, POLES, TRIP, LOAD, REMARKS, FEEDER TAG. Includes notes on demand factor.

SWITCHBOARD "ESB" SCHEDULE. Table with columns: SECTION NUMBER / CIRCUIT NUMBER, CIRCUIT DESCRIPTION, POLES, FRAME, TRIP, LOAD, REMARKS, FEEDER TAG. Includes notes on surge protection and breaker types.

PANEL IS FED FROM 600A/3P CB IN SWITCHBOARD NSB

DISTRIBUTION PANELBOARD "UPDL2B" SCHEDULE. Table with columns: CKT, CIRCUIT DESCRIPTION, POLES, TRIP, LOAD, REMARKS, FEEDER TAG. Includes notes on demand factor.

DISTRIBUTION PANELBOARD "MDH1" SCHEDULE: SECTION 2. Table with columns: CKT, CIRCUIT DESCRIPTION, POLES, TRIP, LOAD, REMARKS, FEEDER TAG. Includes notes on demand factor.

SWITCHBOARD "NSB" SCHEDULE. Table with columns: SECTION NUMBER / CIRCUIT NUMBER, CIRCUIT DESCRIPTION, POLES, FRAME, TRIP, LOAD, REMARKS, FEEDER TAG. Includes notes on surge protection and breaker types.

PANEL IS FED FROM 600A/3P CB IN SWITCHBOARD NSB

DISTRIBUTION PANELBOARD "PDL1" SCHEDULE. Table with columns: CKT, CIRCUIT DESCRIPTION, POLES, TRIP, LOAD, REMARKS, FEEDER TAG. Includes notes on demand factor.

DISTRIBUTION PANELBOARD "CO2DH" SCHEDULE. Table with columns: CKT, CIRCUIT DESCRIPTION, POLES, TRIP, LOAD, REMARKS, FEEDER TAG. Includes notes on surge protection.

PANEL SCHEDULE LEGEND table with columns: Panel Name, Description. Rows include UPDL2A, MDH1, ESB, UPDL2B, MDH1, NSB, PDL1, CO2DH.

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NEW HANOVER COUNTY GOVERNMENT CENTER GOVERNMENT CENTER DRIVE WILMINGTON, NC 28403

Table with 2 columns: A, B, C, D, E, F. Rows include DATE, DESCRIPTION, and ADDENDUM #1-2.

SHEET NAME: ELECTRICAL SCHEDULES

DATE: 2020.12.16 CURRENT: 2021.01.08

ADDENDUM #2

SHEET: E-505

GMP SET

PANEL IS FED FROM 150A/3P CB IN PANELBOARD PDL1

PANELBOARD "PL1A" SCHEDULE table with columns: LOAD DESCRIPTION, WIRE & CONDUIT, CB TRIP / POLES, CKT #, A, B, C, CT, CB TRIP / POLES, WIRE & CONDUIT, LOAD DESCRIPTION. Includes connected amperes and kVA values.

PANEL IS FED FROM 150A/3P CB IN PANELBOARD PDL1

PANELBOARD "PL1B" SCHEDULE table with columns: LOAD DESCRIPTION, WIRE & CONDUIT, CB TRIP / POLES, CKT #, A, B, C, CT, CB TRIP / POLES, WIRE & CONDUIT, LOAD DESCRIPTION. Includes connected amperes and kVA values.

PANEL IS FED FROM 100A/3P CB IN PANELBOARD PDL1

PANELBOARD "PL1C" SCHEDULE table with columns: LOAD DESCRIPTION, WIRE & CONDUIT, CB TRIP / POLES, CKT #, A, B, C, CT, CB TRIP / POLES, WIRE & CONDUIT, LOAD DESCRIPTION. Includes connected amperes and kVA values.

PANEL IS FED FROM 100A/3P CB IN PANELBOARD PDL1

PANELBOARD "PL2A" SCHEDULE table with columns: LOAD DESCRIPTION, WIRE & CONDUIT, CB TRIP / POLES, CKT #, A, B, C, CT, CB TRIP / POLES, WIRE & CONDUIT, LOAD DESCRIPTION. Includes connected amperes and kVA values.

PANEL IS FED FROM 100A/3P CB IN PANELBOARD PDL1

PANELBOARD "PL2B" SCHEDULE table with columns: LOAD DESCRIPTION, WIRE & CONDUIT, CB TRIP / POLES, CKT #, A, B, C, CT, CB TRIP / POLES, WIRE & CONDUIT, LOAD DESCRIPTION. Includes connected amperes and kVA values.

PANEL SCHEDULE LEGEND table with columns: PANEL, SCHEDULE. Rows include PL1C, PL1A, PL2A, PL1B, PL2B.

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THE NEW HANOVER COUNTY...

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PANEL IS FED FROM 100A/3P
CB IN PANELBOARD CO2DH

PANELBOARD "LH1" SCHEDULE											
VOLTS: 480/277 Wye PHASES: 3 WIRE: 4			BUS: 125 A MAIN: MLO SCCR: 18KAIC			MOUNTING: SURFACE SECTIONS: 1 LOCATION: ELECTRICAL 110					
LOAD DESCRIPTION	WIRE & CONDUIT	CB TRIP / POLES	CKT #	A	B	C	CKT #	CB TRIP / POLES	LOAD DESCRIPTION		
LTG - EOC MAIN RM	2#12 & 1#12G - 0.75"C	20 A	1	2.9	0.0		2	1	20 A		
LTG - EOC CORE	2#12 & 1#12G - 0.75"C	20 A	1		2.0	0.0	4	1	20 A		
LTG - HUB HIGH BAY	2#12 & 1#12G - 0.75"C	20 A	1	5		1.8	0.0	6	1	20 A	
LTG - SERVICE YARD	2#12 & 1#12G - 0.75"C	20 A	1	7	0.2	0.0		8	1	20 A	
LTG - LVL 1 CORE	2#12 & 1#12G - 0.75"C	20 A	1	9		2.3	0.0	10	1	20 A	
LTG - LVL 1 OFFICES	2#12 & 1#12G - 0.75"C	20 A	1	11		2.1	0.0	12	1	20 A	
LTG - EOC EXTERIOR	2#12 & 1#12G - 0.75"C	20 A	1	13	0.0	0.0		14	1	20 A	
SPARE	--	20 A	1	15		0.0	0.0	16	1	20 A	
SPARE	--	20 A	1	17		0.0	0.0	18	1	20 A	
SPARE	--	20 A	1	19	0.0	0.0		20	1	20 A	
SPARE	--	20 A	1	21		0.0	0.0	22	1	20 A	
SPARE	--	20 A	1	23		0.0	0.0	24	1	20 A	
SPARE	--	20 A	1	25	0.0	0.0		26	1	20 A	
SPARE	--	20 A	1	27		0.0	0.0	28	1	20 A	
SPARE	--	20 A	1	29		0.0	0.0	30	1	20 A	
SPARE	--	20 A	1	31	0.0	0.0		32	1	20 A	
SPARE	--	20 A	1	33		0.0	0.0	34	1	20 A	
SPARE	--	20 A	1	35		0.0	0.0	36	1	20 A	
SPARE	--	20 A	1	37	0.0	0.0		38	1	20 A	
SPARE	--	20 A	1	39		0.0	0.0	40	1	20 A	
SPARE	--	20 A	1	41		0.0	0.0	42	1	20 A	
PHASE TOTALS (KVA):				3.1	4.3	3.9					
CONNECTED AMPERES:				13.6 A	CONNECTED KVA:		11.3 kVA				
CALCULATED AMPERES:				13.6 A	CALCULATED KVA:		11.3 kVA				
NOTES:											

PANEL IS FED FROM 225A/3P
CB IN PANELBOARD UPDL2B

PANELBOARD "UPL1B" SCHEDULE: SECTION 1											
VOLTS: 120/208 Wye PHASES: 3 WIRE: 4			BUS: 225 A MAIN: MLO SCCR: 10KAIC			MOUNTING: SURFACE SECTIONS: 2 LOCATION: ELECTRICAL 110					
LOAD DESCRIPTION	WIRE & CONDUIT	CB TRIP / POLES	CKT #	A	B	C	CKT #	CB TRIP / POLES	LOAD DESCRIPTION		
153 HUB TV	2#12 & 1#12G - 0.75"C	20 A	1	0.7	0.0		2	1	20 A		
167 911 CALL CN TV	2#12 & 1#12G - 0.75"C	20 A	1		1.5	0.0	4	1	20 A		
167 911 CALL CN TV	2#12 & 1#12G - 0.75"C	20 A	1	5		0.7	0.0	6	1	20 A	
170 OFFICE REC.	2#12 & 1#12G - 0.75"C	20 A	1	7	0.4	0.0		8	1	20 A	
169 OFFICE REC.	2#12 & 1#12G - 0.75"C	20 A	1	9		0.4	0.0	10	1	20 A	
170 OFFICE REC.	2#12 & 1#12G - 0.75"C	20 A	1	11		0.4	0.0	12	1	20 A	
167 911 CALL CN DESK	2#12 & 1#12G - 0.75"C	20 A	1	13	0.5	0.0		14	1	20 A	
167 911 CALL CN DESK	2#12 & 1#12G - 0.75"C	20 A	1	15		0.5	0.0	16	1	20 A	
167 911 CALL CN DESK	2#12 & 1#12G - 0.75"C	20 A	1	17		0.5	0.0	18	1	20 A	
167 911 CALL CN DESK	2#12 & 1#12G - 0.75"C	20 A	1	19	0.5	0.0		20	1	20 A	
167 911 CALL CN DESK	2#12 & 1#12G - 0.75"C	20 A	1	21		0.5	0.0	22	1	20 A	
167 911 CALL CN DESK	2#12 & 1#12G - 0.75"C	20 A	1	23		0.5	0.0	24	1	20 A	
167 911 CALL CN DESK	2#12 & 1#12G - 0.75"C	20 A	1	25	0.5	0.0		26	1	20 A	
167 911 CALL CN DESK	2#12 & 1#12G - 0.75"C	20 A	1	27		0.5	0.0	28	1	20 A	
167 911 CALL CN DESK	2#12 & 1#12G - 0.75"C	20 A	1	29		0.5	0.0	30	1	20 A	
167 911 CALL CN DESK	2#12 & 1#12G - 0.75"C	20 A	1	31	0.5	0.0		32	1	20 A	
167 911 CALL CN DESK	2#12 & 1#12G - 0.75"C	20 A	1	33		0.5	0.0	34	1	20 A	
167 911 CALL CN DESK	2#12 & 1#12G - 0.75"C	20 A	1	35		0.5	0.0	36	1	20 A	
167 911 CALL CN DESK	2#12 & 1#12G - 0.75"C	20 A	1	37	0.5	0.0		38	1	20 A	
167 911 CALL CN DESK	2#12 & 1#12G - 0.75"C	20 A	1	39		0.5	0.0	40	1	20 A	
167 911 CALL CN DESK	2#12 & 1#12G - 0.75"C	20 A	1	41		0.5	0.0	42	1	20 A	
PHASE TOTALS (KVA):				6.1	6.3	5.6					
CONNECTED AMPERES:				50.0 A	CONNECTED KVA:		18.0 kVA				
CALCULATED AMPERES:				50.0 A	CALCULATED KVA:		18.0 kVA				
NOTES:											

PANEL IS FED FROM 225A/3P
CB IN PANELBOARD UPDL2A

PANELBOARD "UPL1A" SCHEDULE: SECTION 1											
VOLTS: 120/208 Wye PHASES: 3 WIRE: 4			BUS: 225 A MAIN: MLO SCCR: 10KAIC			MOUNTING: SURFACE SECTIONS: 2 LOCATION: ELECTRICAL 110					
LOAD DESCRIPTION	WIRE & CONDUIT	CB TRIP / POLES	CKT #	A	B	C	CKT #	CB TRIP / POLES	LOAD DESCRIPTION		
153 HUB TV	2#12 & 1#12G - 0.75"C	20 A	1	1.5	0.5		2	1	20 A		
167 911 CALL CN TV	2#12 & 1#12G - 0.75"C	20 A	1		1.5	0.0	4	1	20 A		
167 911 CALL CN TV	2#12 & 1#12G - 0.75"C	20 A	1	5		1.5	0.0	6	1	20 A	
166 OFFICE REC.	2#12 & 1#12G - 0.75"C	20 A	1	7	0.4	0.0		8	1	20 A	
165 OFFICE REC.	2#12 & 1#12G - 0.75"C	20 A	1	9		0.4	0.0	10	1	20 A	
164 OFFICE REC.	2#12 & 1#12G - 0.75"C	20 A	1	11		0.4	0.0	12	1	20 A	
163 OFFICE REC.	2#12 & 1#12G - 0.75"C	20 A	1	13	0.7	0.0		14	1	20 A	
167 911 CALL CN DESK	2#12 & 1#12G - 0.75"C	20 A	1	15		1.2	0.0	16	1	20 A	
167 911 CALL CN DESK	2#12 & 1#12G - 0.75"C	20 A	1	17		0.5	0.0	18	1	20 A	
167 911 CALL CN DESK	2#12 & 1#12G - 0.75"C	20 A	1	19	0.5	0.0		20	1	20 A	
167 911 CALL CN DESK	2#12 & 1#12G - 0.75"C	20 A	1	21		0.5	0.0	22	1	20 A	
167 911 CALL CN DESK	2#12 & 1#12G - 0.75"C	20 A	1	23		0.5	0.0	24	1	20 A	
167 911 CALL CN DESK	2#12 & 1#12G - 0.75"C	20 A	1	25	0.5	0.0		26	1	20 A	
167 911 CALL CN DESK	2#12 & 1#12G - 0.75"C	20 A	1	27		0.5	0.0	28	1	20 A	
167 911 CALL CN DESK	2#12 & 1#12G - 0.75"C	20 A	1	29		0.5	0.0	30	1	20 A	
167 911 CALL CN DESK	2#12 & 1#12G - 0.75"C	20 A	1	31	0.5	0.0		32	1	20 A	
167 911 CALL CN DESK	2#12 & 1#12G - 0.75"C	20 A	1	33		0.5	0.0	34	1	20 A	
167 911 CALL CN DESK	2#12 & 1#12G - 0.75"C	20 A	1	35		0.5	0.0	36	1	20 A	
167 911 CALL CN DESK	2#12 & 1#12G - 0.75"C	20 A	1	37	0.5	0.0		38	1	20 A	
167 911 CALL CN DESK	2#12 & 1#12G - 0.75"C	20 A	1	39		0.5	0.0	40	1	20 A	
167 911 CALL CN DESK	2#12 & 1#12G - 0.75"C	20 A	1	41		0.5	0.0	42	1	20 A	
PHASE TOTALS (KVA):				7.5	7.1	6.3					
CONNECTED AMPERES:				58.1 A	CONNECTED KVA:		20.9 kVA				
CALCULATED AMPERES:				58.1 A	CALCULATED KVA:		20.9 kVA				
NOTES:											



CAPE FEAR FD STONEWATER



101 NORTH THIRD STREET, SUITE 500
WILMINGTON, NORTH CAROLINA 28401
TEL. 910.790.3111 FAX. 910.790.9901
WWW.LS3P.COM

NOT FOR CONSTRUCTION

NHC Government Center 7702-190810

NEW HANOVER COUNTY
GOVERNMENT CENTER
GOVERNMENT CENTER DRIVE
WILMINGTON, NC 28403
LS3P PROJECT: 7702-190810

A	DATE	DESCRIPTION
A	2020.08.18	TI- SCHEMATIC DESIGN
B	2020.10.16	TI- DESIGN DEVELOPMENT
C	2020.12.16	GMP SET
D	2020.12.22	ADDENDUM #1
E	2021.01.08	ADDENDUM #2

SHEET NAME:
ELECTRICAL
SCHEDULES

DATE: 2020.12.16
CURRENT: 2021.01.08

ADDENDUM #2

SHEET: E-506

PANEL IS FED FROM 100A/3P
CB IN SWITCHBOARD NSB

PANELBOARD "UPL1B" SCHEDULE: SECTION 2											
VOLTS: 120/208 Wye PHASES: 3 WIRE: 4			BUS: 225 A MAIN: MLO SCCR: 10KAIC			MOUNTING: SURFACE SECTIONS: 2 LOCATION: ELECTRICAL 110					
LOAD DESCRIPTION	WIRE & CONDUIT	CB TRIP / POLES	CKT #	A	B	C	CKT #	CB TRIP / POLES	LOAD DESCRIPTION		
167 911 CALL CN DESK	2#12 & 1#12G - 0.75"C	20 A	1	43	0.5	0.0		44	1	20 A	
167 911 CALL CN DESK	2#12 & 1#12G - 0.75"C	20 A	1	45		0.5	0.0	46	1	20 A	
167 911 CALL CN DESK	2#12 & 1#12G - 0.75"C	20 A	1	47		0.5	0.0	48	1	20 A	
167 911 CALL CN DESK	2#12 & 1#12G - 0.75"C	20 A	1	49	0.5	0.0		50	1	20 A	
167 911 CALL CN DESK	2#12 & 1#12G - 0.75"C	20 A	1	51		0.5	0.0	52	1	20 A	
167 911 CALL CN DESK	2#12 & 1#12G - 0.75"C	20 A	1	53		0.5	0.0	54	1	20 A	
167 911 CALL CN DESK	2#12 & 1#12G - 0.75"C	20 A	1	55	0.5	0.0		56	1	20 A	
167 911 CALL CN DESK	2#12 & 1#12G - 0.75"C	20 A	1	57		0.5	0.0	58	1	20 A	
167 911 CALL CN DESK	2#12 & 1#12G - 0.75"C	20 A	1	59		0.5	0.0	60	1	20 A	
167 911 CALL CN DESK	2#12 & 1#12G - 0.75"C	20 A	1	61	0.5	0.0		62	1	20 A	
167 911 CALL CN DESK	2#12 & 1#12G - 0.75"C	20 A	1	63		0.5	0.0	64	1	20 A	
167 911 CALL CN DESK	2#12 & 1#12G - 0.75"C	20 A	1	65		0.5	0.0	66	1	20 A	
167 911 CALL CN DESK	2#12 & 1#12G - 0.75"C	20 A	1	67	0.5	0.0		68	1	20 A	
SPARE	--	20 A	1	69		0.0	0.0	70	1	20 A	
SPARE	--	20 A	1	71		0.0	0.0	72	1	20 A	
SPARE	--	20 A	1	73	0.0	0.0		74	1	20 A	
SPARE	--	20 A	1	75		0.0	0.0	76	1	20 A	
SPARE	--	20 A	1	77		0.0	0.0	78	1	20 A	
SPARE	--	20 A	1	79	0.0	0.0		80	1	20 A	
SPARE	--	20 A	1	81		0.0	0.0	82	1	20 A	
SPARE	--	20 A	1	83		0.0	0.0	84	1	20 A	
PHASE TOTALS (KVA):				2.5	2.0	2.0					
CONNECTED AMPERES:				18.0 A	CONNECTED KVA:		6.5 kVA				
CALCULATED AMPERES:				18.0 A	CALCULATED KVA:		6.5 kVA				
NOTES:											

PANELBOARD "UPL1A" SCHEDULE: SECTION 2										
VOLTS: 120/208 Wye PHASES: 3 WIRE: 4			BUS: 225 A MAIN: MLO SCCR: 10KAIC			MOUNTING: SURFACE SECTIONS: 2 LOCATION: ELECTRICAL 110				
LOAD DESCRIPTION	WIRE & CONDUIT	CB TRIP / POLES	CKT #	A	B	C	CKT #	CB TRIP / POLES	LOAD DESCRIPTION	
167 911 CALL CN DESK	2#12 & 1#12G - 0.75"C	20 A	1	43	0.5	0.0		44	1	20 A
167 911 CALL CN DESK	2#12 & 1#12G - 0.75"C	20 A	1	45		0.5	0.0	46	1	20 A
167 911 CALL CN DESK	2#12 & 1#12G - 0.75"C	20 A	1	47		0.5	0.0	48	1	20 A
167 911 CALL CN DESK	2#12 & 1#12G - 0.75"C	20 A	1	49	0.5	0.0		50	1	

THE NEW HANOVER COUNTY BOARD OF COMMISSIONERS HAS REVIEWED AND APPROVED THIS DOCUMENT FOR THE PROJECT DESCRIBED HEREIN.

E

D

C

B

A

1/7/2021 3:17:38 PM

PANEL IS FED FROM 225A/3P
CB IN PANELBOARD UPDL2B

PANEL IS FED FROM 225A/3P
CB IN PANELBOARD UPDL2A

PANELBOARD "UPL2B" SCHEDULE: SECTION 1													
VOLTS: 120/208 Wye				BUS: 225 A				MOUNTING: SURFACE					
PHASES: 3				MAIN: M.L.O				SECTIONS: 2					
WIRE: 4				SCCR: 10KAIC				LOCATION: ELECTRICAL 207					
LOAD DESCRIPTION	WIRE & CONDUIT	CB TRIP / POLES	CKT #	A	B	C	CKT #	CB TRIP / POLES	WIRE & CONDUIT	LOAD DESCRIPTION			
208 AT&T MISC. PWR.	2#10 & 1#10G ~ 0.75°C	30 A	2	1	1.3	0.7		2	1	20 A	2#12 & 1#12G ~ 0.75°C	283 CMD. FB	
208 MOTOROLA SERVER RACK	2#10 & 1#10G ~ 0.75°C	30 A	2	5			4	1	20 A	2#12 & 1#12G ~ 0.75°C	284 CITY, 285 CONF TV		
208 MOTOROLA SERVER RACK	2#10 & 1#10G ~ 0.75°C	30 A	2	7	1.3	1.5		8	1	20 A	2#12 & 1#12G ~ 0.75°C	275 AV RACK	
208 MOTOROLA SERVER RACK	2#10 & 1#10G ~ 0.75°C	30 A	2	9			10	1	20 A	2#12 & 1#12G ~ 0.75°C	275 AV RACK		
208 MISC. SERVER RACK	2#10 & 1#10G ~ 0.75°C	30 A	2	11			12	1	20 A	2#12 & 1#12G ~ 0.75°C	275 AV RACK		
279 EOC REC.	2#12 & 1#12G ~ 0.75°C	20 A	1	17			16	1	20 A	--	SPARE		
280 JIC REC.	2#12 & 1#12G ~ 0.75°C	20 A	1	19	0.7	0.0		20	1	20 A	--	SPARE	
281 EPC FB	2#12 & 1#12G ~ 0.75°C	20 A	1	21			22	1	20 A	--	SPARE		
SPARE	--	20 A	1	23			24	1	20 A	--	SPARE		
SPARE	--	20 A	1	25	0.0	0.0		26	1	20 A	--	SPARE	
SPARE	--	20 A	1	27			28	1	20 A	--	SPARE		
SPARE	--	20 A	1	29			30	1	20 A	--	SPARE		
SPARE	--	20 A	1	31	0.0	0.0		32	1	20 A	--	SPARE	
SPARE	--	20 A	1	33			34	1	20 A	--	SPARE		
SPARE	--	20 A	1	35			36	1	20 A	--	SPARE		
SPARE	--	20 A	1	37	0.0	0.0		38	1	20 A	--	SPARE	
SPARE	--	20 A	1	39			40	1	20 A	--	SPARE		
SPARE	--	20 A	1	41			42	1	20 A	--	SPARE		
PHASE TOTALS (kVA):				11.6	11.5	9.7							
CONNECTED AMPERES:				91.2 A	CONNECTED KVA:				32.8 KVA				
CALCULATED AMPERES:				71.0 A	CALCULATED KVA:				25.6 KVA				
NOTES:													

PANELBOARD "UPL2A" SCHEDULE: SECTION 1													
VOLTS: 120/208 Wye				BUS: 225 A				MOUNTING: SURFACE					
PHASES: 3				MAIN: M.L.O				SECTIONS: 2					
WIRE: 4				SCCR: 10KAIC				LOCATION: ELECTRICAL 207					
LOAD DESCRIPTION	WIRE & CONDUIT	CB TRIP / POLES	CKT #	A	B	C	CKT #	CB TRIP / POLES	WIRE & CONDUIT	LOAD DESCRIPTION			
280 JIC FB	2#12 & 1#12G ~ 0.75°C	20 A	1	1	0.7	0.0		2	1	20 A	--	SPARE	
275 AV RACK	2#12 & 1#12G ~ 0.75°C	20 A	1	3			4	1	20 A	--	SPARE		
275 AV RACK	2#12 & 1#12G ~ 0.75°C	20 A	1	5			6	1	20 A	--	SPARE		
275 AV RACK	2#12 & 1#12G ~ 0.75°C	20 A	1	7	1.5	0.0		8	1	20 A	--	SPARE	
275 AV RACK	2#12 & 1#12G ~ 0.75°C	20 A	1	9			10	1	20 A	--	SPARE		
278 COPY/PRINT REC.	2#12 & 1#12G ~ 0.75°C	20 A	1	11			12	1	20 A	--	SPARE		
279 EOC REC.	2#12 & 1#12G ~ 0.75°C	20 A	1	13	0.2	0.0		14	1	20 A	--	SPARE	
282 CONF. FB	2#12 & 1#12G ~ 0.75°C	20 A	1	15			16	1	20 A	--	SPARE		
208 MOTOROLA SERVER RACK	2#10 & 1#10G ~ 0.75°C	30 A	2	19	1.3	0.0		20	1	20 A	--	SPARE	
285 SELECTIVE SIGNAL	2#12 & 1#12G ~ 0.75°C	20 A	1	23			24	1	20 A	--	SPARE		
288 CONF. 287 JCC TV	2#12 & 1#12G ~ 0.75°C	20 A	1	25	1.5	0.0		26	1	20 A	--	SPARE	
208 MOTOROLA SERVER RACK	2#10 & 1#10G ~ 0.75°C	30 A	2	27			28	1	20 A	--	SPARE		
208 SERVICE PROVIDER SERVER RACK	2#10 & 1#10G ~ 0.75°C	30 A	2	29			30	1	20 A	--	SPARE		
208 AT&T SERVER RACK	2#10 & 1#10G ~ 0.75°C	30 A	2	31	1.3	0.0		32	--	--	SPACE		
SPARE	--	20 A	1	33			34	--	--	--	SPACE		
SPARE	--	20 A	1	35			36	--	--	--	SPACE		
SPARE	--	20 A	1	37	0.0	0.0		38	--	--	SPACE		
SPARE	--	20 A	1	39			40	--	--	--	SPACE		
SPARE	--	20 A	1	41			42	--	--	--	SPACE		
PHASE TOTALS (kVA):				12.9	13.5	9.7							
CONNECTED AMPERES:				100.3 A	CONNECTED KVA:				36.1 KVA				
CALCULATED AMPERES:				75.6 A	CALCULATED KVA:				27.2 KVA				
NOTES:													

PANELBOARD "UPL2B" SCHEDULE: SECTION 2													
VOLTS: 120/208 Wye				BUS: 225 A				MOUNTING: SURFACE					
PHASES: 3				MAIN: M.L.O				SECTIONS: 2					
WIRE: 4				SCCR: 10KAIC				LOCATION: ELECTRICAL 207					
LOAD DESCRIPTION	WIRE & CONDUIT	CB TRIP / POLES	CKT #	A	B	C	CKT #	CB TRIP / POLES	WIRE & CONDUIT	LOAD DESCRIPTION			
279 EOC REC.	2#12 & 1#12G ~ 0.75°C	20 A	1	43	0.7	0.0		44	1	20 A	--	SPARE	
279 EOC REC.	2#12 & 1#12G ~ 0.75°C	20 A	1	45			46	1	20 A	--	SPARE		
279 EOC TV	2#12 & 1#12G ~ 0.75°C	20 A	1	47			48	1	20 A	--	SPARE		
279 EOC LRG DISPLAY	2#12 & 1#12G ~ 0.75°C	20 A	1	49	1.4	0.0		50	1	20 A	--	SPARE	
279 EOC LRG DISPLAY	2#12 & 1#12G ~ 0.75°C	20 A	1	51			52	1	20 A	--	SPARE		
279 EOC LRG DISPLAY	2#12 & 1#12G ~ 0.75°C	20 A	1	53			54	1	20 A	--	SPARE		
279 EOC LRG DISPLAY	2#12 & 1#12G ~ 0.75°C	20 A	1	55	1.4	0.0		56	1	20 A	--	SPARE	
279 EOC LRG DISPLAY	2#12 & 1#12G ~ 0.75°C	20 A	1	57			58	1	20 A	--	SPARE		
279 EOC LRG DISPLAY	2#12 & 1#12G ~ 0.75°C	20 A	1	59			60	1	20 A	--	SPARE		
280 JIC, 281 JIC TV	2#12 & 1#12G ~ 0.75°C	20 A	1	61	1.5	0.0		62	1	20 A	--	SPARE	
285 CONF. FB	2#12 & 1#12G ~ 0.75°C	20 A	1	63			64	1	20 A	--	SPARE		
SPARE	--	20 A	1	65			66	1	20 A	--	SPARE		
SPARE	--	20 A	1	67	0.0	0.0		68	1	20 A	--	SPARE	
SPARE	--	20 A	1	69			70	1	20 A	--	SPARE		
SPARE	--	20 A	1	71			72	1	20 A	--	SPARE		
SPARE	--	20 A	1	73	0.0	0.0		74	1	20 A	--	SPARE	
SPARE	--	20 A	1	75			76	1	20 A	--	SPARE		
SPARE	--	20 A	1	77			78	1	20 A	--	SPARE		
SPARE	--	20 A	1	79	0.0	0.0		80	1	20 A	--	SPARE	
SPARE	--	20 A	1	81			82	1	20 A	--	SPARE		
SPARE	--	20 A	1	83			84	1	20 A	--	SPARE		
PHASE TOTALS (kVA):				5.0	4.0	3.5							
CONNECTED AMPERES:				34.7 A	CONNECTED KVA:				12.5 KVA				
CALCULATED AMPERES:				34.7 A	CALCULATED KVA:				12.5 KVA				
NOTES:													

PANELBOARD "UPL2A" SCHEDULE: SECTION 2													
VOLTS: 120/208 Wye				BUS: 225 A				MOUNTING: SURFACE					
PHASES: 3				MAIN: M.L.O				SECTIONS: 2					
WIRE: 4				SCCR: 10KAIC				LOCATION: ELECTRICAL 207					
LOAD DESCRIPTION	WIRE & CONDUIT	CB TRIP / POLES	CKT #	A	B	C	CKT #	CB TRIP / POLES	WIRE & CONDUIT	LOAD DESCRIPTION			
279 EOC REC.	2#12 & 1#12G ~ 0.75°C	20 A	1	43	0.4	0.0		44	1	20 A	--	SPARE	
284 CITY FB	2#12 & 1#12G ~ 0.75°C	20 A	1	45			46	1	20 A	--	SPARE		
279 EOC FB	2#12 & 1#12G ~ 0.75°C	20 A	1	47			48	1	20 A	--	SPARE		
279 EOC TV	2#12 & 1#12G ~ 0.75°C	20 A	1	49	0.7	0.0		50	1	20 A	--	SPARE	
279 EOC TV	2#12 & 1#12G ~ 0.75°C	20 A	1	51			52	1	20 A	--	SPARE		
289 CORR. TV	2#12 & 1#12G ~ 0.75°C	20 A	1	53			54	1	20 A	--	SPARE		
283 CMD, 282 CONF. TV	2#12 & 1#12G ~ 0.75°C	20 A	1	55	1.5	0.0		56	1	20 A	--	SPARE	
287 JCC FB	2#12 & 1#12G ~ 0.75°C	20 A	1	57			58	1	20 A	--	SPARE		
287 JCC REC	2#12 & 1#12G ~ 0.75°C	20 A	1	59			60	1	20 A	--	SPARE		
279 EOC LRG DISPLAY	2#12 & 1#12G ~ 0.75°C	20 A	1	61	1.4	0.0		62	1	20 A	--	SPARE	
279 EOC LRG DISPLAY	2#12 & 1#12G ~ 0.75°C	20 A	1	63			64	1	20 A	--	SPARE		
279 EOC LRG DISPLAY	2#12 & 1#12G ~ 0.75°C	20 A	1	65			66	1	20 A	--	SPARE		
279 EOC LRG DISPLAY	2#12 & 1#12G ~ 0.75°C	20 A	1	67	1.4	0.0		68	1	20 A	--	SPARE	
279 EOC LRG DISPLAY	2#12 & 1#12G ~ 0.75°C	20 A	1	69			70	1	20 A	--	SPARE		
279 EOC LRG DISPLAY	2#12 & 1#12G ~ 0.75°C	20 A	1	71			72	1	20 A	--	SPARE		
SPARE	--	20 A	1	73	0.0	0.0		74	1	20 A	--	SPARE	
SPARE	--	20 A	1	75			76	1	20 A	--	SPARE		
SPARE	--	20 A	1	77			78	1	20 A	--	SPARE		
SPARE	--	20 A	1	79	0.0	0.0		80	1	20 A	--	SPARE	
SPARE	--	20 A	1	81			82	1	20 A	--	SPARE		
SPARE	--	20 A	1	83			84	1	20 A	--	SPARE		
PHASE TOTALS (kVA):				5.3	6.0	4.9							
CONNECTED AMPERES:				45.3 A	CONNECTED KVA:				16.3 KVA				
CALCULATED AMPERES:				45.3 A	CALCULATED KVA:				16.3 KVA				
NOTES:													

PANEL IS FED FROM 200A/3P
CB IN PANELBOARD CO2DH

PANELBOARD "MH2" SCHEDULE												
VOLTS: 480/277 Wye				BUS: 250 A				MOUNTING: SURFACE				
PHASES: 3				MAIN: M.L.O				SECTIONS: 1				
WIRE: 4				SCCR: 18KAIC				LOCATION: ELECTRICAL 207				
LOAD DESCRIPTION	WIRE & CONDUIT	CB TRIP / POLES	CKT #	A	B	C	CKT #	CB TRIP / POLES	WIRE & CONDUIT	LOAD DESCRIPTION		
S100	2#8 & 1#10G ~ 0.75°C	35 A	1	7.0	3.0		2	1	20 A	2#12 & 1#12G ~ 0.75°C	FTR-1-1 & FTR-1-2	
S101	2#8 & 1#10G ~ 0.75°C	35 A	1	3			4	1	20 A	2#12 & 1#12G ~ 0.75°C	FTR-1-3 & FTR-1-4	
S102	2#12 & 1#12G ~ 0.75°C	15 A	1	5			6	1	20 A	2#12 & 1#12G ~ 0.75°C	FTR-1-5	
S105	2#12 & 1#12G ~ 0.75°C	15 A	1	7	1.0	0.0		8	1	20 A	--	SPARE
S108	2#12 & 1#12G ~ 0.75°C	15 A	1	9			10	1	20 A	--	SPARE	
S111	2#12 & 1#12G ~ 0.75°C	15 A	1	11			12	1	20 A	--	SPARE	
S112	2#12 & 1#12G ~ 0.75°C	15 A	1	13	2.0	0.0		14	1	20 A	--	SPARE
S113	2#8 & 1#10G ~ 0.75°C	45 A	1	15			16	1	20 A	--	SPARE	
S114	2#12 & 1#12G ~ 0.75°C	15 A	1	17			18	1	20 A	--	SPARE	
S200	2#12 & 1#12G ~ 0.75°C	15 A	1	19	1.0	0.0		20	1	20 A	--	SPARE
S201	2#12 & 1#12G ~ 0.75°C	15 A	1	21			22	1	20 A	--	SPARE	
S202	2#12 & 1#12G ~ 0.75°C	20 A	1	23			24	1	20 A	--	SPARE	
S203	2#12 & 1#12G ~ 0.75°C	20 A	1	25	3.0	0.0		26	1	20 A	--	SPARE
S204	2#12 & 1#12G ~ 0.75°C	15 A	1	27			28	1	20 A			



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NHC Government Center 7702-190810

NEW HANOVER COUNTY GOVERNMENT CENTER GOVERNMENT CENTER DRIVE WILMINGTON, NC 28403 LS3P PROJECT: 7702-190810

Table with 2 columns: A, DATE, DESCRIPTION. Rows include 2020.08.18 TI-SCHEMATIC DESIGN, 2020.10.16 TI-DESIGN DEVELOPMENT, 2020.12.16 GMP SET, 2020.12.22 ADDENDUM #1, 2021.01.08 ADDENDUM #2

SHEET NAME: ELECTRICAL SCHEDULES

DATE: 2020.12.16 CURRENT: 2021.01.08 ADDENDUM #2

SHEET: E-509

GMP SET

PANELBOARD "PDL1-T" SCHEDULE. Table with columns: CKT, PL1A-T, PL1B-T, PL1C-T, SPACE, WIRE & CONDUIT, POLES, TRIP, LOAD, REMARKS, FEEDER TAG. Includes notes: 1. MAIN CIRCUIT BREAKER SHALL BE LSI TYPE.

PANELBOARD "LH1-T" SCHEDULE. Table with columns: LOAD DESCRIPTION, WIRE & CONDUIT, CB TRIP / POLES, CKT #, A, B, C, CKT #, WIRE & CONDUIT, LOAD DESCRIPTION. Includes phase totals and connected/calculated amperes.

PANELBOARD "MH1-T" SCHEDULE. Table with columns: LOAD DESCRIPTION, WIRE & CONDUIT, CB TRIP / POLES, CKT #, A, B, C, CKT #, WIRE & CONDUIT, LOAD DESCRIPTION. Includes phase totals and connected/calculated amperes.

PANELBOARD "PL1A-T" SCHEDULE. Table with columns: LOAD DESCRIPTION, WIRE & CONDUIT, CB TRIP / POLES, CKT #, A, B, C, CKT #, WIRE & CONDUIT, LOAD DESCRIPTION. Includes phase totals and connected/calculated amperes.

PANELBOARD "PL1B-T" SCHEDULE: SECTION 1. Table with columns: LOAD DESCRIPTION, WIRE & CONDUIT, CB TRIP / POLES, CKT #, A, B, C, CKT #, WIRE & CONDUIT, LOAD DESCRIPTION. Includes phase totals and connected/calculated amperes.

PANELBOARD "PL1C-T" SCHEDULE: SECTION 1. Table with columns: LOAD DESCRIPTION, WIRE & CONDUIT, CB TRIP / POLES, CKT #, A, B, C, CKT #, WIRE & CONDUIT, LOAD DESCRIPTION. Includes phase totals and connected/calculated amperes.

PANELBOARD "PL1B-T" SCHEDULE: SECTION 2. Table with columns: LOAD DESCRIPTION, WIRE & CONDUIT, CB TRIP / POLES, CKT #, A, B, C, CKT #, WIRE & CONDUIT, LOAD DESCRIPTION. Includes phase totals and connected/calculated amperes.

PANELBOARD "PL1C-T" SCHEDULE: SECTION 2. Table with columns: LOAD DESCRIPTION, WIRE & CONDUIT, CB TRIP / POLES, CKT #, A, B, C, CKT #, WIRE & CONDUIT, LOAD DESCRIPTION. Includes phase totals and connected/calculated amperes.

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NEW HANOVER COUNTY GOVERNMENT CENTER GOVERNMENT CENTER DRIVE WILMINGTON, NC 28403 LS3P PROJECT: 7702-190810

Table with 2 columns: DATE, DESCRIPTION. Rows include A 2020.08.18 TI-SCHEMATIC DESIGN, B 2020.10.16 TI-DESIGN DEVELOPMENT, C 2020.12.16 GMP SET, D 2020.12.22 ADDENDUM #1, E 2021.01.08 ADDENDUM #2

SHEET NAME: ELECTRICAL SCHEDULES

DATE: 2020.12.16 CURRENT: 2021.01.08

ADDENDUM #2

SHEET: E-510

GMP SET

PANELBOARD "PDL2-T" SCHEDULE. VOLTAGE: 120/208 Wye. BUS: 400 A. MAIN: 400A/3P MCB, LSI. SCRR: 10KAIC. MOUNTING: SURFACE. LOCATION: ELECT 202. Includes table with columns: CKT, CIRCUIT DESCRIPTION, POLES, TRIP, LOAD, REMARKS, FEEDER TAG.

CONNECTED AMPERES: 298 A. CALCULATED AMPERES: 175 A. 107.3 KVA. 63.6 KVA.

NOTES: 1. MAIN CIRCUIT BREAKER SHALL BE LSI TYPE.

PANELBOARD "LH2-T" SCHEDULE. VOLTAGE: 480/277 Wye. BUS: 250 A. MAIN: 50A/3P MCB. SCRR: 35KAIC. MOUNTING: SURFACE. LOCATION: ELECT 202. Includes table with columns: LOAD DESCRIPTION, WIRE & CONDUIT, CB TRIP / POLES, CKT #, A, B, C, CKT #, CB TRIP / POLES, WIRE & CONDUIT, LOAD DESCRIPTION.

CONNECTED AMPERES: 15.1 A. CALCULATED AMPERES: 15.1 A. CONNECTED KVA: 12.6 KVA. CALCULATED KVA: 12.6 KVA.

NOTES:

PANEL IS FED FROM 150A/3P CB IN PANELBOARD PDL2-T

PANELBOARD "MH2-T" SCHEDULE. VOLTAGE: 480/277 Wye. BUS: 250 A. MAIN: 150A/3P MCB. SCRR: 35KAIC. MOUNTING: SURFACE. LOCATION: ELECT 202. Includes table with columns: LOAD DESCRIPTION, WIRE & CONDUIT, CB TRIP / POLES, CKT #, A, B, C, CKT #, CB TRIP / POLES, WIRE & CONDUIT, LOAD DESCRIPTION.

CONNECTED AMPERES: 49.3 A. CALCULATED AMPERES: 49.3 A. CONNECTED KVA: 41.0 KVA. CALCULATED KVA: 41.0 KVA.

NOTES:

PANEL IS FED FROM 150A/3P CB IN PANELBOARD PDL2-T

PANELBOARD "PL2A-T" SCHEDULE. VOLTAGE: 120/208 Wye. BUS: 225 A. MAIN: MLO. SCRR: 10KAIC. MOUNTING: SURFACE. LOCATION: ELECT 202. Includes table with columns: LOAD DESCRIPTION, WIRE & CONDUIT, CB TRIP / POLES, CKT #, A, B, C, CKT #, CB TRIP / POLES, WIRE & CONDUIT, LOAD DESCRIPTION.

CONNECTED AMPERES: 108.4 A. CALCULATED AMPERES: 75.0 A. CONNECTED KVA: 39.1 KVA. CALCULATED KVA: 27.0 KVA.

NOTES: 1. PROVIDE GFCI TYPE CIRCUIT BREAKER.

PANELBOARD "PL2B-T" SCHEDULE: SECTION 1. VOLTAGE: 120/208 Wye. BUS: 225 A. MAIN: MLO. SCRR: 10KAIC. MOUNTING: SURFACE. LOCATION: ELEC. 233. Includes table with columns: LOAD DESCRIPTION, WIRE & CONDUIT, CB TRIP / POLES, CKT #, A, B, C, CKT #, CB TRIP / POLES, WIRE & CONDUIT, LOAD DESCRIPTION.

CONNECTED AMPERES: 127.8 A. CALCULATED AMPERES: 77.8 A. CONNECTED KVA: 46.1 KVA. CALCULATED KVA: 28.0 KVA.

NOTES:

PANEL IS FED FROM 150A/3P CB IN PANELBOARD PDL2-T

PANELBOARD "PL2C-T" SCHEDULE: SECTION 1. VOLTAGE: 120/208 Wye. BUS: 225 A. MAIN: MLO. SCRR: 10KAIC. MOUNTING: SURFACE. LOCATION: ELEC. 245. Includes table with columns: LOAD DESCRIPTION, WIRE & CONDUIT, CB TRIP / POLES, CKT #, A, B, C, CKT #, CB TRIP / POLES, WIRE & CONDUIT, LOAD DESCRIPTION.

CONNECTED AMPERES: 61.5 A. CALCULATED AMPERES: 49.9 A. CONNECTED KVA: 22.2 KVA. CALCULATED KVA: 18.0 KVA.

NOTES:

PANEL IS FED FROM 150A/3P CB IN PANELBOARD PDL2-T

PANELBOARD "PL2B-T" SCHEDULE: SECTION 2. VOLTAGE: 120/208 Wye. BUS: 225 A. MAIN: MLO. SCRR: 10KAIC. MOUNTING: SURFACE. LOCATION: ELEC. 233. Includes table with columns: LOAD DESCRIPTION, WIRE & CONDUIT, CB TRIP / POLES, CKT #, A, B, C, CKT #, CB TRIP / POLES, WIRE & CONDUIT, LOAD DESCRIPTION.

CONNECTED AMPERES: 52.5 A. CALCULATED AMPERES: 40.1 A. CONNECTED KVA: 18.9 KVA. CALCULATED KVA: 14.5 KVA.

NOTES:

PANEL IS FED FROM 150A/3P CB IN PANELBOARD PDL2-T

PANELBOARD "PL2C-T" SCHEDULE: SECTION 2. VOLTAGE: 120/208 Wye. BUS: 225 A. MAIN: MLO. SCRR: 10KAIC. MOUNTING: SURFACE. LOCATION: ELEC. 245. Includes table with columns: LOAD DESCRIPTION, WIRE & CONDUIT, CB TRIP / POLES, CKT #, A, B, C, CKT #, CB TRIP / POLES, WIRE & CONDUIT, LOAD DESCRIPTION.

CONNECTED AMPERES: 0.0 A. CALCULATED AMPERES: 0.0 A. CONNECTED KVA: 0.0 KVA. CALCULATED KVA: 0.0 KVA.

NOTES:

PANEL IS FED FROM 150A/3P CB IN PANELBOARD PDL2-T

PANEL SCHEDULE LEGEND. Table with 3 columns: MH2-T, LH2-T, PDL2-T, PL2C-T, PL2B-T, PL2A-T, PL2C-T, PL2B-T.

Newcomb & Boyd CONSULTANTS AND ENGINEERS Consulting Engineering Group 5425 Page Rd Suite 215 Durham, NC 27703 T 919 783-7812 Contact: Paul J. Kitchens N&B PROJECT: 19N342 Firm License No. F-0312

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Table with 2 columns: A, DATE, DESCRIPTION. Rows include 2020.08.18, 2020.10.16, 2020.12.16, 2020.12.22, 2021.01.08.

Table with 2 columns: A, DATE, DESCRIPTION. Rows include 2020.08.18, 2020.10.16, 2020.12.16, 2020.12.22, 2021.01.08.

SHEET NAME: ELECTRICAL SCHEDULES

DATE: 2020.12.16 CURRENT: 2021.01.08 ADDENDUM #2

SHEET: E-511

GMP SET

PANELBOARD "PDL3-T" SCHEDULE. Table with columns: CKT, CIRCUIT DESCRIPTION, POLES, TRIP, LOAD, REMARKS, FEEDER TAG. Includes connected and calculated amperes.

CONNECTED AMPERES: 339 A CALCULATED AMPERES: 197 A

CONNECTED KVA: 122.0 KVA CALCULATED KVA: 71.0 KVA

NOTES: 1. MAIN CIRCUIT BREAKER SHALL BE LSI TYPE.

PANELBOARD "LH3-T" SCHEDULE. Table with columns: LOAD DESCRIPTION, WIRE & CONDUIT, CB TRIP / POLES, CKT #, A, B, C, CKT #, CB TRIP / POLES, WIRE & CONDUIT, LOAD DESCRIPTION.

PHASE TOTALS (KVA): 4.2, 4.0, 3.1

CONNECTED AMPERES: 13.6 A CALCULATED AMPERES: 13.6 A

CONNECTED KVA: 11.3 KVA CALCULATED KVA: 11.3 KVA

NOTES:

CONNECTED AMPERES: 339 A CALCULATED AMPERES: 197 A

CONNECTED KVA: 122.0 KVA CALCULATED KVA: 71.0 KVA

NOTES: 1. MAIN CIRCUIT BREAKER SHALL BE LSI TYPE.

PANELBOARD "MH3-T" SCHEDULE 1. Table with columns: LOAD DESCRIPTION, WIRE & CONDUIT, CB TRIP / POLES, CKT #, A, B, C, CKT #, CB TRIP / POLES, WIRE & CONDUIT, LOAD DESCRIPTION.

PHASE TOTALS (KVA): 23.0, 22.0, 25.0

CONNECTED AMPERES: 84.2 A CALCULATED AMPERES: 84.2 A

CONNECTED KVA: 70.0 KVA CALCULATED KVA: 70.0 KVA

NOTES:

PANEL IS FED FROM 150A/3P CB IN PANELBOARD PDL3-T

PANEL IS FED FROM 150A/3P CB IN PANELBOARD PDL3-T

PANEL IS FED FROM 150A/3P CB IN PANELBOARD PDL3-T

PANELBOARD "PL3A-T" SCHEDULE. Table with columns: LOAD DESCRIPTION, WIRE & CONDUIT, CB TRIP / POLES, CKT #, A, B, C, CKT #, CB TRIP / POLES, WIRE & CONDUIT, LOAD DESCRIPTION.

PHASE TOTALS (KVA): 14.9, 12.3, 16.3

CONNECTED AMPERES: 120.6 A CALCULATED AMPERES: 81.2 A

CONNECTED KVA: 43.4 KVA CALCULATED KVA: 29.2 KVA

NOTES: 1. PROVIDE GFCI TYPE CIRCUIT BREAKER.

PANELBOARD "PL3B-T" SCHEDULE: SECTION 1. Table with columns: LOAD DESCRIPTION, WIRE & CONDUIT, CB TRIP / POLES, CKT #, A, B, C, CKT #, CB TRIP / POLES, WIRE & CONDUIT, LOAD DESCRIPTION.

PHASE TOTALS (KVA): 14.4, 15.7, 14.2

CONNECTED AMPERES: 123.1 A CALCULATED AMPERES: 77.6 A

CONNECTED KVA: 44.3 KVA CALCULATED KVA: 28.0 KVA

NOTES:

PANELBOARD "PL3C-T" SCHEDULE: SECTION 1. Table with columns: LOAD DESCRIPTION, WIRE & CONDUIT, CB TRIP / POLES, CKT #, A, B, C, CKT #, CB TRIP / POLES, WIRE & CONDUIT, LOAD DESCRIPTION.

PHASE TOTALS (KVA): 11.2, 11.6, 11.4

CONNECTED AMPERES: 95.0 A CALCULATED AMPERES: 66.1 A

CONNECTED KVA: 34.2 KVA CALCULATED KVA: 23.8 KVA

NOTES:

PANELBOARD "PL3B-T" SCHEDULE: SECTION 2. Table with columns: LOAD DESCRIPTION, WIRE & CONDUIT, CB TRIP / POLES, CKT #, A, B, C, CKT #, CB TRIP / POLES, WIRE & CONDUIT, LOAD DESCRIPTION.

PHASE TOTALS (KVA): 3.6, 3.6, 2.7

CONNECTED AMPERES: 27.5 A CALCULATED AMPERES: 27.5 A

CONNECTED KVA: 9.9 KVA CALCULATED KVA: 9.9 KVA

NOTES:

PANELBOARD "PL3C-T" SCHEDULE: SECTION 2. Table with columns: LOAD DESCRIPTION, WIRE & CONDUIT, CB TRIP / POLES, CKT #, A, B, C, CKT #, CB TRIP / POLES, WIRE & CONDUIT, LOAD DESCRIPTION.

PHASE TOTALS (KVA): 0.0, 0.0, 0.0

CONNECTED AMPERES: 0.0 A CALCULATED AMPERES: 0.0 A

CONNECTED KVA: 0.0 KVA CALCULATED KVA: 0.0 KVA

NOTES:

PANEL SCHEDULE LEGEND table with columns: MH3-T, LH3-T, PDL3-T, PL3C-T, PL3B-T, PL3A-T.

Newcomb & Boyd CONSULTANTS AND ENGINEERS Consulting Engineering Group 5425 Page Rd Suite 215 Durham, NC 27703 T 919 783-7812 Contact: Paul J. Kitchens N&B PROJECT: 19N342 Firm License No. F-0312

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NEW HANOVER COUNTY GOVERNMENT CENTER GOVERNMENT CENTER DRIVE WILMINGTON, NC 28403 LS3P PROJECT: 7702-190810

SHEET NAME: ELECTRICAL SCHEDULES

DATE: 2020.12.16

CURRENT: 2021.01.08

ADDENDUM #2

SHEET: E-512

GMP SET

PANEL IS FED FROM 150A/3P CB IN PANELBOARD PDL4-T

PANELBOARD "PL4A-T" SCHEDULE. Table with columns: LOAD DESCRIPTION, WIRE & CONDUIT, CB TRIP / POLES, CKT #, A, B, C, CKT #, CB TRIP / POLES, WIRE & CONDUIT, LOAD DESCRIPTION. Includes notes and summary statistics.

DISTRIBUTION PANELBOARD "PDL4-T" SCHEDULE. Table with columns: CKT, CIRCUIT DESCRIPTION, POLES, TRIP, LOAD, REMARKS, FEEDER TAG. Includes notes and summary statistics.

PANELBOARD "LH4-T" SCHEDULE. Table with columns: LOAD DESCRIPTION, WIRE & CONDUIT, CB TRIP / POLES, CKT #, A, B, C, CKT #, CB TRIP / POLES, WIRE & CONDUIT, LOAD DESCRIPTION. Includes notes and summary statistics.

PANELBOARD "MH4-T" SCHEDULE: SECTION 1. Table with columns: LOAD DESCRIPTION, WIRE & CONDUIT, CB TRIP / POLES, CKT #, A, B, C, CKT #, CB TRIP / POLES, WIRE & CONDUIT, LOAD DESCRIPTION. Includes notes and summary statistics.

PANELBOARD "PL4B-T" SCHEDULE: SECTION 1. Table with columns: LOAD DESCRIPTION, WIRE & CONDUIT, CB TRIP / POLES, CKT #, A, B, C, CKT #, CB TRIP / POLES, WIRE & CONDUIT, LOAD DESCRIPTION. Includes notes and summary statistics.

PANELBOARD "MH4-T" SCHEDULE: SECTION 2. Table with columns: LOAD DESCRIPTION, WIRE & CONDUIT, CB TRIP / POLES, CKT #, A, B, C, CKT #, CB TRIP / POLES, WIRE & CONDUIT, LOAD DESCRIPTION. Includes notes and summary statistics.

PANELBOARD "PL4B-T" SCHEDULE: SECTION 2. Table with columns: LOAD DESCRIPTION, WIRE & CONDUIT, CB TRIP / POLES, CKT #, A, B, C, CKT #, CB TRIP / POLES, WIRE & CONDUIT, LOAD DESCRIPTION. Includes notes and summary statistics.

PANELBOARD "LH4-T" SCHEDULE. Table with columns: LOAD DESCRIPTION, WIRE & CONDUIT, CB TRIP / POLES, CKT #, A, B, C, CKT #, CB TRIP / POLES, WIRE & CONDUIT, LOAD DESCRIPTION. Includes notes and summary statistics.

PANELBOARD "PL4C-T" SCHEDULE: SECTION 1. Table with columns: LOAD DESCRIPTION, WIRE & CONDUIT, CB TRIP / POLES, CKT #, A, B, C, CKT #, CB TRIP / POLES, WIRE & CONDUIT, LOAD DESCRIPTION. Includes notes and summary statistics.

PANELBOARD "PL4C-T" SCHEDULE: SECTION 2. Table with columns: LOAD DESCRIPTION, WIRE & CONDUIT, CB TRIP / POLES, CKT #, A, B, C, CKT #, CB TRIP / POLES, WIRE & CONDUIT, LOAD DESCRIPTION. Includes notes and summary statistics.

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NEW HANOVER COUNTY
GOVERNMENT CENTER
GOVERNMENT CENTER DRIVE
WILMINGTON, NC 28403
LS3P PROJECT: 7702-190810

DATE	DESCRIPTION
A 2020.08.18	TI- SCHEMATIC DESIGN
B 2020.10.16	TI- DESIGN DEVELOPMENT
C 2020.12.16	GMP SET
E 2021.01.08	ADDENDUM #2

SHEET NAME:
ELECTRICAL DETAILS -
SITE


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CURRENT: 2021.01.08

ADDENDUM #2


SHEET:

E-601


GMP SET

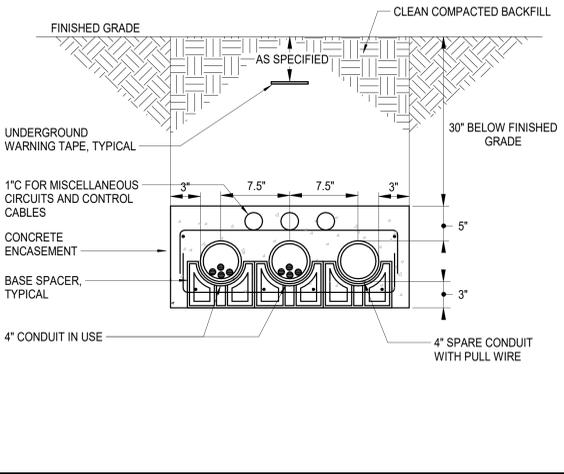


1 E-601 EMERGENCY CONCRETE-ENCASED DUCTBANK - EOC NTS

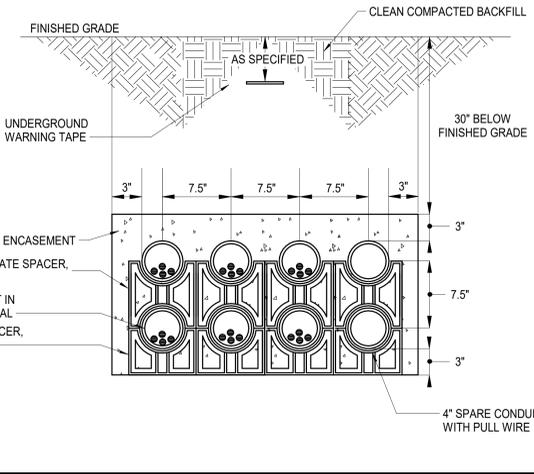


4 E-601 NORMAL CONCRETE-ENCASED DUCTBANK - EOC NTS

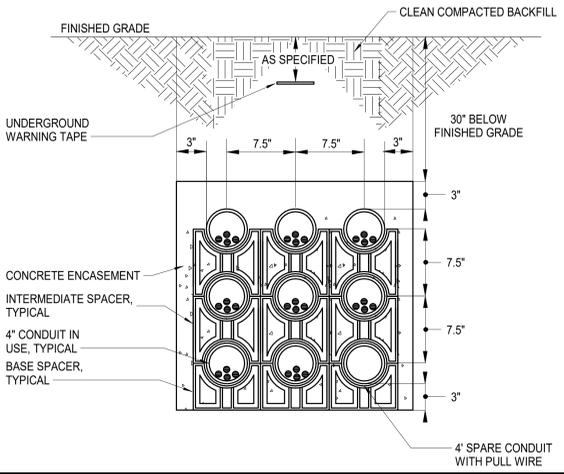


7 E-601 NORMAL CONCRETE-ENCASED DUCTBANK - TOWER NTS

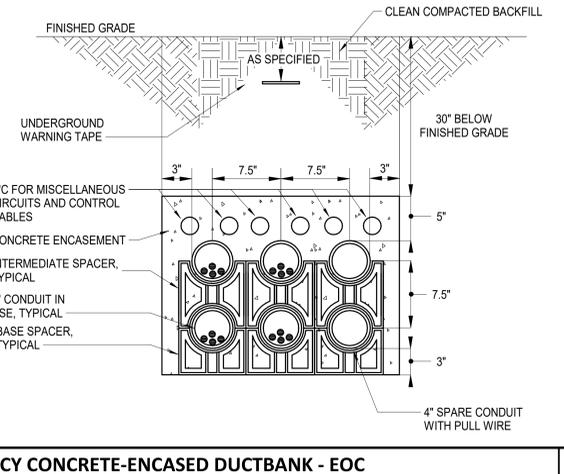


2 E-601 EMERGENCY CONCRETE-ENCASED DUCTBANK - EOC NTS

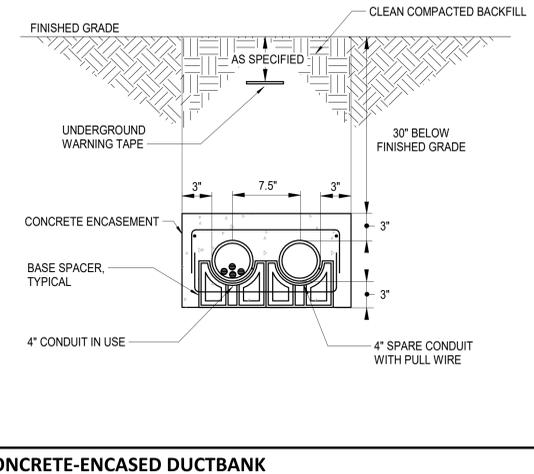


5 E-601 NORMAL CONCRETE-ENCASED DUCTBANK NTS

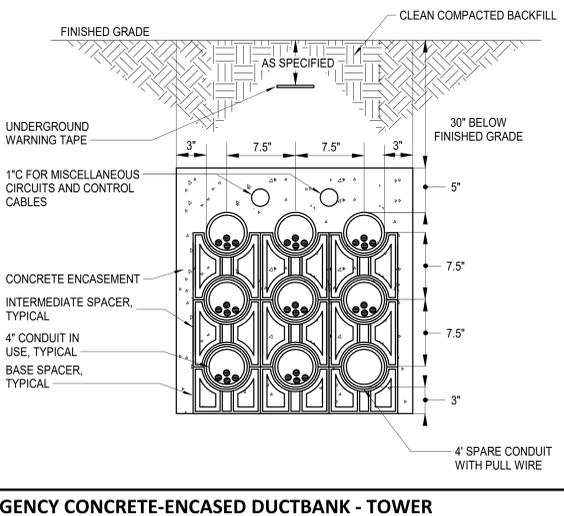


8 E-601 EMERGENCY CONCRETE-ENCASED DUCTBANK - TOWER NTS

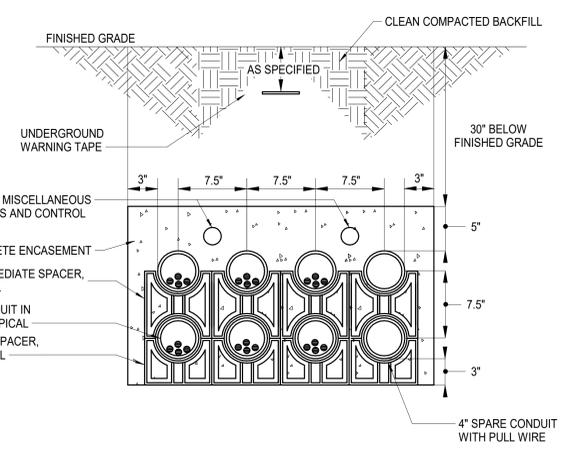

3 E-601 EMERGENCY CONCRETE-ENCASED DUCTBANK - EOC NTS

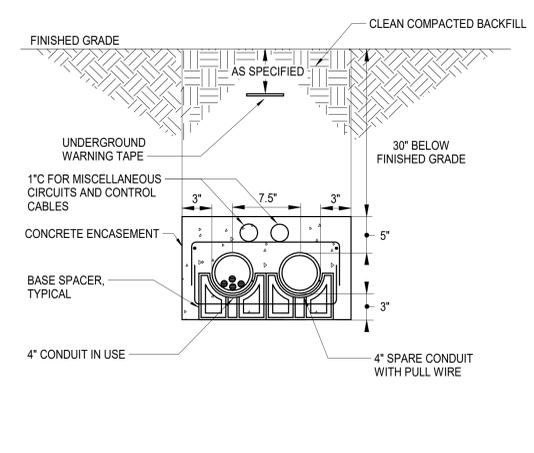

6 E-601 EMERGENCY CONCRETE-ENCASED DUCTBANK NTS

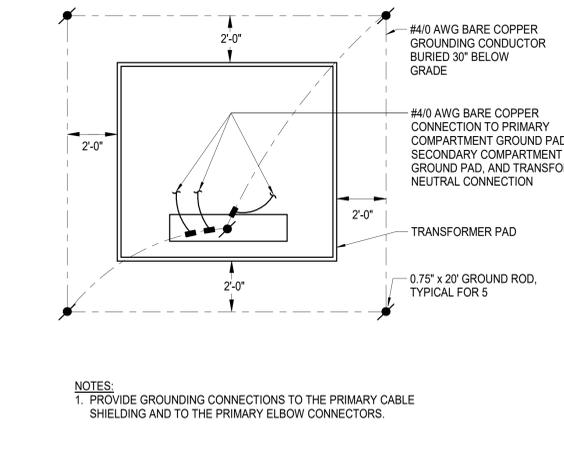

9 E-601 TRANSFORMER GROUNDING NTS

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N&B PROJECT: 19N342
Firm License No. F-0312

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GOVERNMENT CENTER DRIVE
WILMINGTON, NC 28403

LS3P PROJECT: 7702-190810

A	DATE	DESCRIPTION
A	2020.08.18	TI- SCHEMATIC DESIGN
B	2020.10.16	TI- DESIGN DEVELOPMENT
C	2020.12.16	GMP SET
E	2021.01.08	ADDENDUM #2




SHEET NAME:
ELECTRICAL DETAILS -
GROUNDING

DATE: 2020.12.16
CURRENT: 2021.01.08


ADDENDUM #2

SHEET: E-602

GMP SET

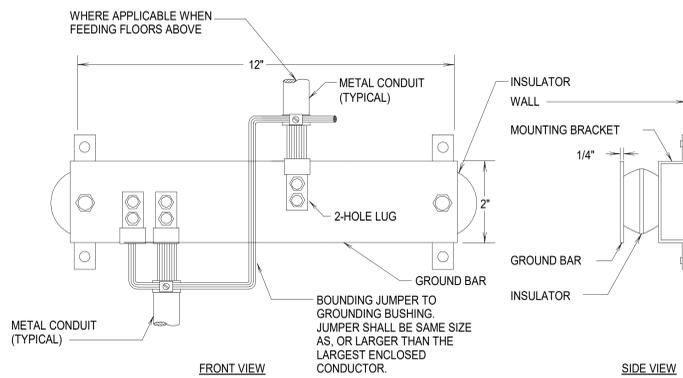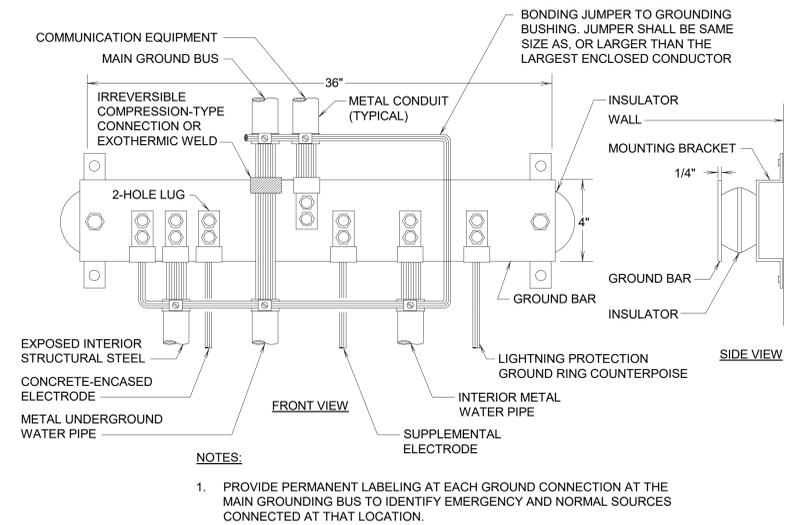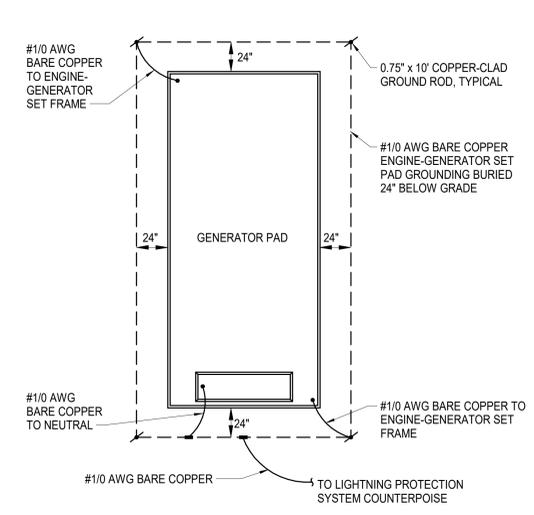

3 E-602	GROUND BAR (GB)	NTS	2 E-602	MAIN GROUND BUS BAR (MGB)	NTS	1 E-602	ENGINE-GENERATOR SET GROUNDING	NTS
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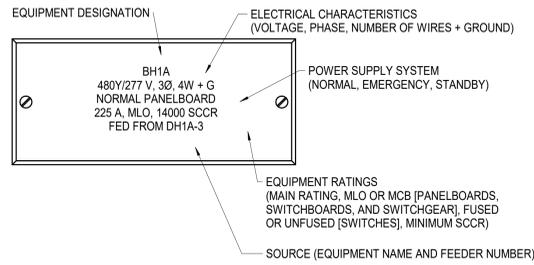


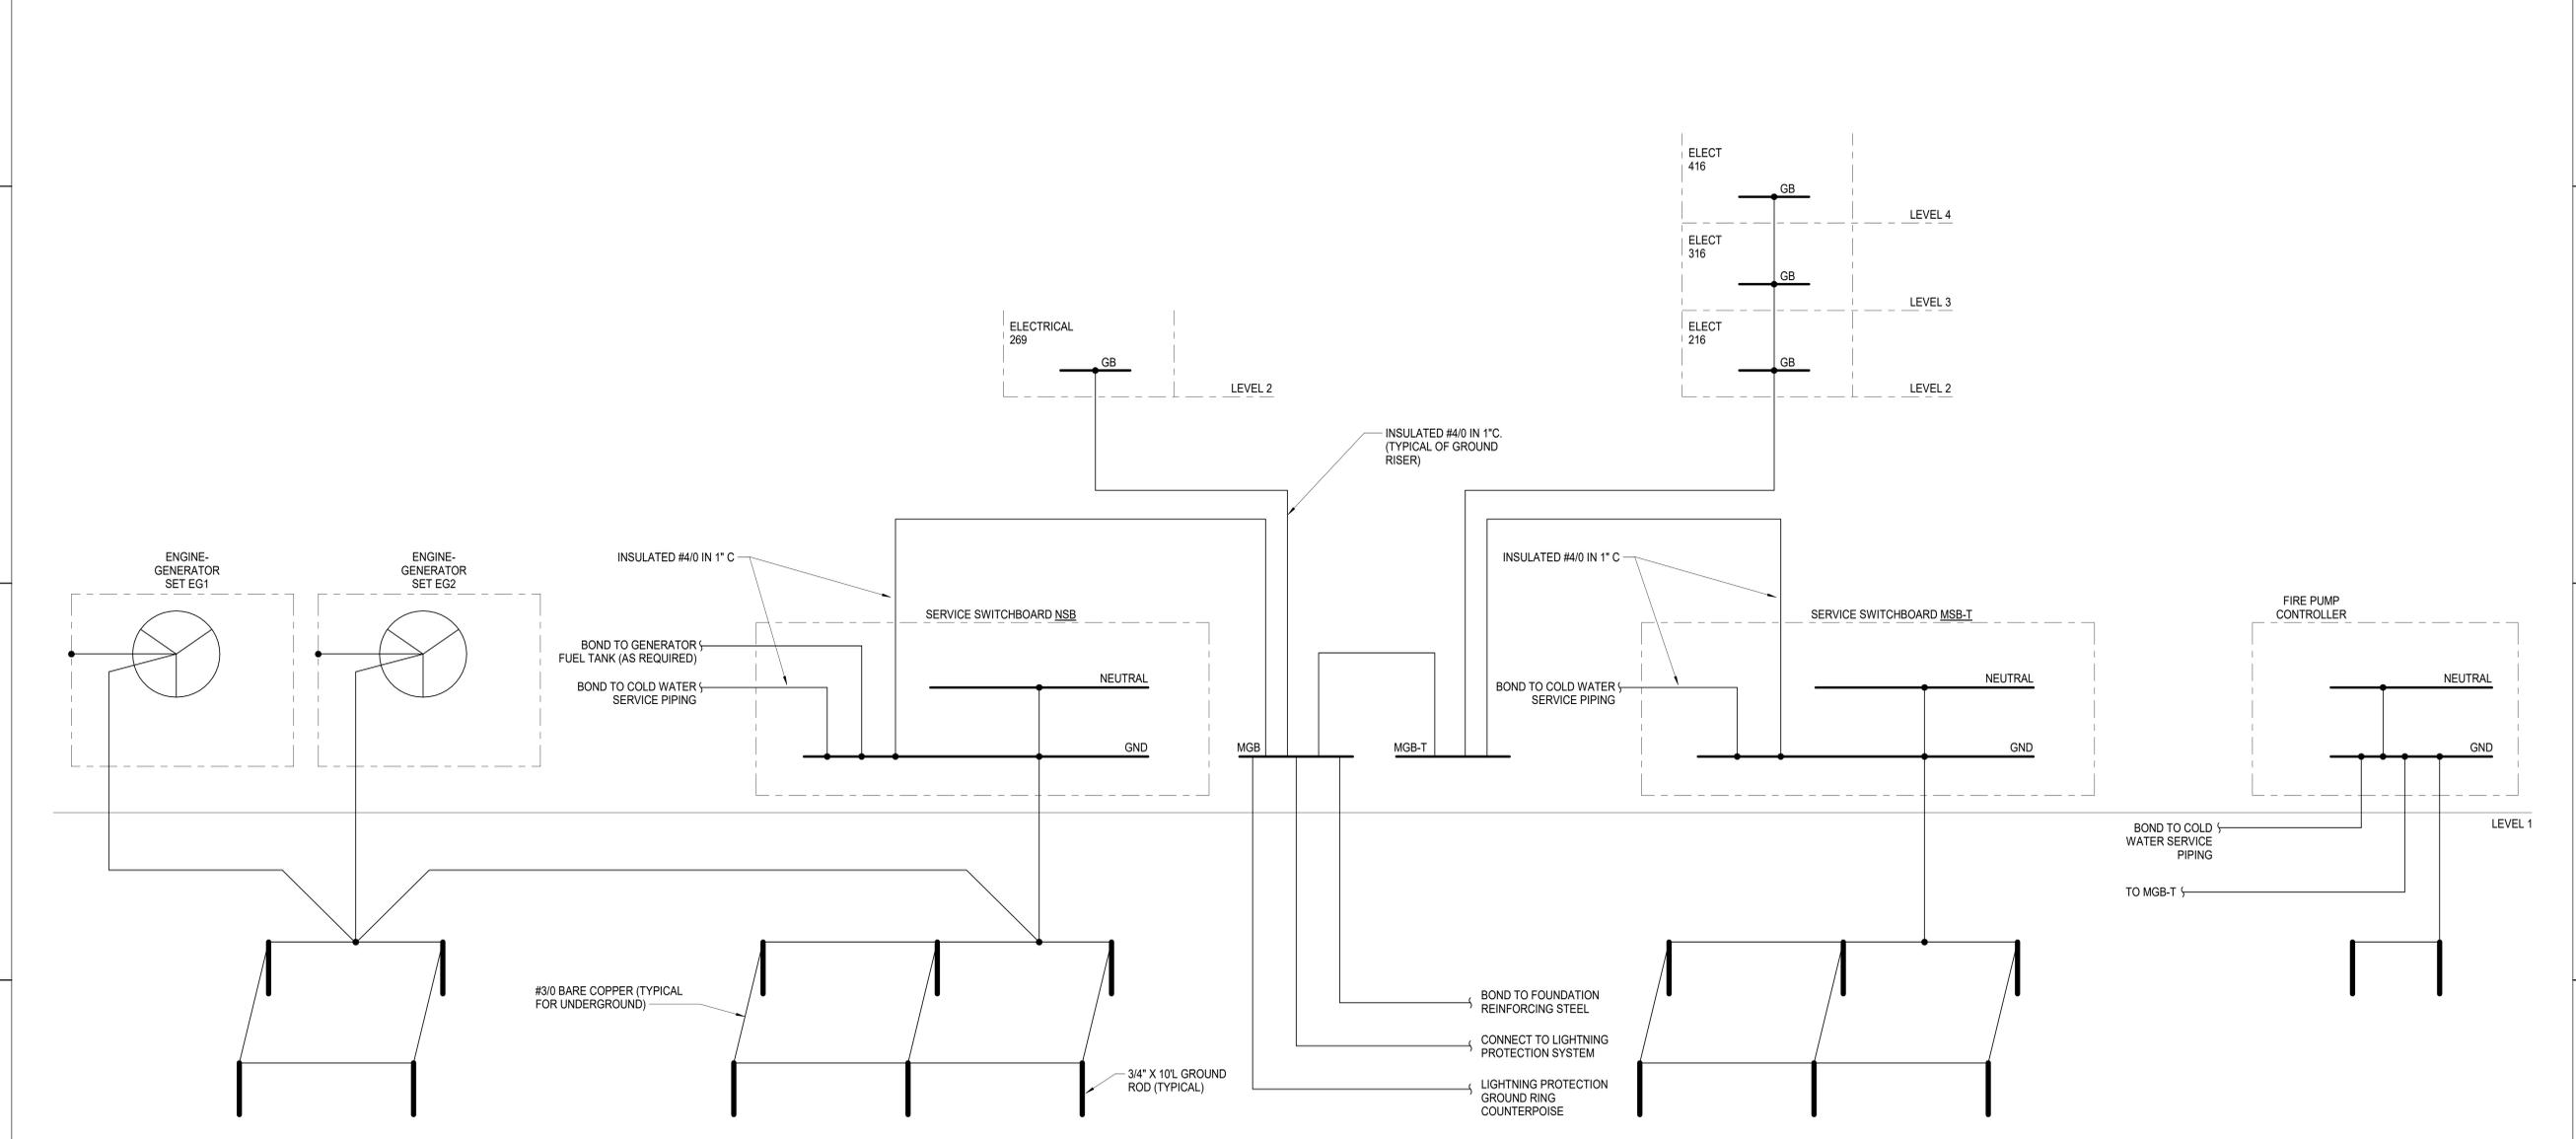4 E-602	ELECTRICAL GROUNDING RISER DIAGRAM	NTS
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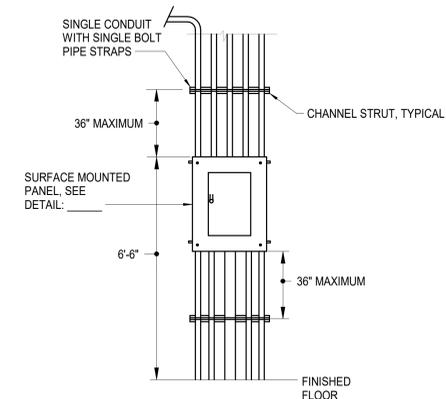
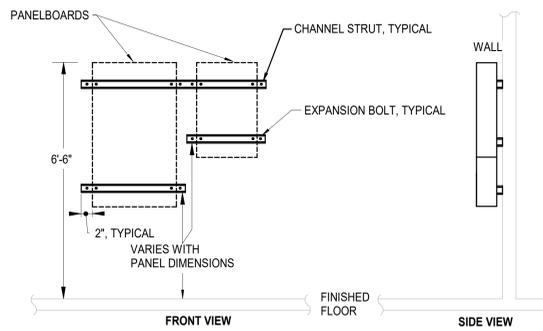
Newcomb & Boyd
CONSULTANTS AND ENGINEERS
Consulting Engineering Group
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Suite 215
Durham, NC 27703
T 919 783-7812
Contact: Paul J. Kitchens
N&B PROJECT: 19N342
Firm License No. F-0312

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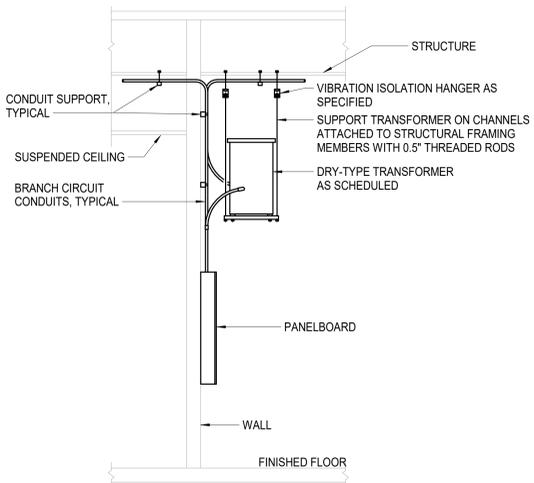
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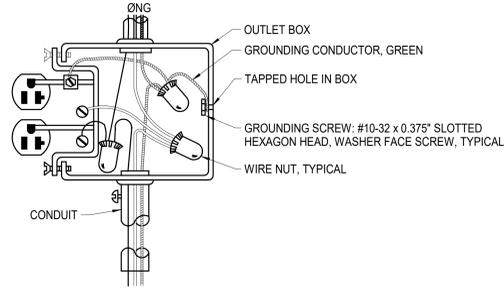
NOTES:
1. NAMEPLATE BACKGROUND COLORS SHALL BE BLACK FOR NORMAL POWER SUPPLY SYSTEMS, RED FOR LEGALLY REQUIRED EMERGENCY POWER SUPPLY SYSTEMS, AND YELLOW FOR OPTIONAL STANDBY POWER SUPPLY SYSTEMS.




7 E-603	EQUIPMENT NAMEPLATES	NTS	4 E-603	WALL-MOUNTED PANELBOARD MOUNTING	NTS	1 E-603	CONDUIT SUPPORT FOR SURFACE-MOUNTED PANELS	NTS
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NOTES:
1. PROVIDE ROD STIFFENER ON EACH THREADED ROD AND LATERAL SUPPORT AT EACH CORNER FOR SEISMIC RESTRAINT.




NOTES:
1. GROUNDING CONDUCTOR SHALL BE CONTINUOUS SO THAT REMOVAL OF DEVICE WILL NOT INTERFERE WITH CONDUCTOR CONTINUITY.



NOTES:
1. USE FOR CONDUITS STUBBED-UP THROUGH SLABS ON GRADE WHERE NOT CONCEALED IN WALL CONSTRUCTION, AND CONDUITS 1.25" AND LARGER.
2. TREAT RIGID METAL CONDUIT BELOW GRADE AS SPECIFIED.


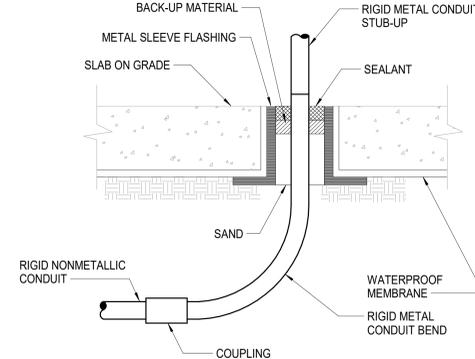
8 E-603	SUSPENDED DRY-TYPE TRANSFORMERS	NTS	5 E-603	RECEPTACLE WIRING	NTS	2 E-603	CONDUIT PENETRATIONS	NTS
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NOTES:

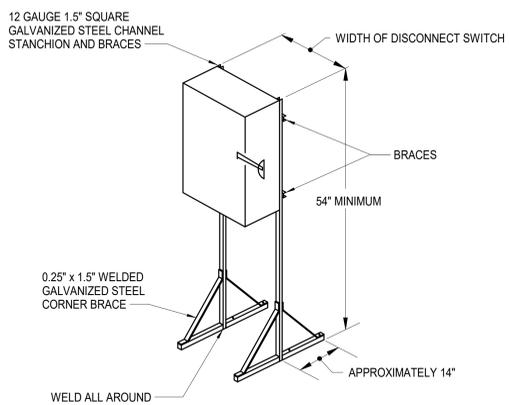1. TRANSFORMER BONDING STRAP, IF NOT PROVIDED BY THE TRANSFORMER MANUFACTURER SHALL BE SIZED THE SAME SIZE AS THE MAIN BONDING JUMPER. (PER 250-66)
2. USE A BONDING BUSHING AND JUMPER AT THE CONDUIT TERMINATION. JUMPER SHOULD BE THE SAME SIZE AS THE GROUNDING ELECTRODE CONDUCTOR CONTAINED IN THE CONDUIT.
3. USE A BONDING CLAMP AT THE TERMINATION OF THE GROUNDING ELECTRODE CONDUCTOR TO THE ELECTRODE.

GROUNDING ELECTRODE TO THE STEEL FRAME OF THE BLDG. WHERE PROVEN TO BE SUITABLY GROUNDED, OR TO THE METALLIC WATER PIPE WITHIN 5' FROM THE POINT OF ENTRANCE INTO THE BUILDING(250-30(a)).



NOTES:
1. CIRCUIT BREAKER SHALL HAVE THE SAME CHARACTERISTICS AS CIRCUIT BREAKER PROVIDED IN GENERATOR.
2. PROVIDE HARDWARE LUGS FOR TEMPORARY GENERATOR CONNECTION IN ADDITION TO MALE CAMLOCKS.
3. PROVIDE AUTOSTART TERMINAL BLOCK.
4. REFER TO ELECTRICAL DRAWINGS AND SPECIFICATIONS FOR ADDITIONAL INFORMATION.

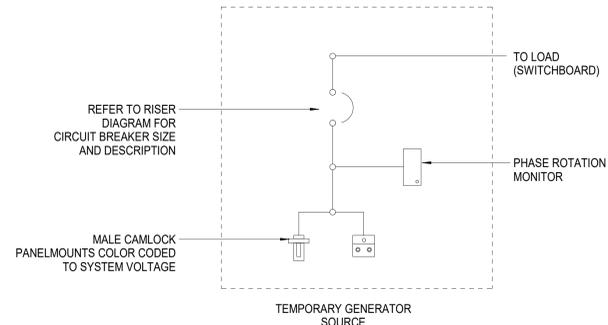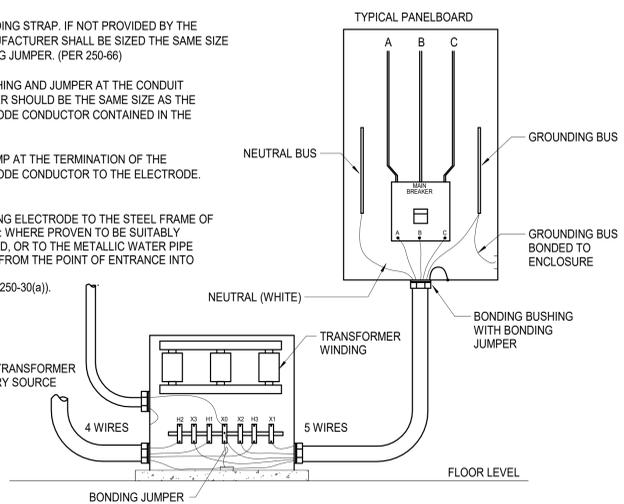9 E-603	DISCONNECT MOUNTING	NTS	6 E-603	DRY-TYPE TRANSFORMER GROUNDING DETAIL	NTS	3 E-603	SINGLE BREAKER GENERATOR DOCKING STATION	NTS
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NOT FOR CONSTRUCTION

NHC Government Center 7702-190810

NEW HANOVER COUNTY
GOVERNMENT CENTER
GOVERNMENT CENTER DRIVE
WILMINGTON, NC 28403
LS3P PROJECT: 7702-190810

DATE	DESCRIPTION
A 2020.08.18	TI- SCHEMATIC DESIGN
B 2020.10.16	TI- DESIGN DEVELOPMENT
C 2020.12.16	GMP SET
E 2021.01.08	ADDENDUM #2

SHEET NAME:
ELECTRICAL DETAILS

DATE: 2020.12.16
CURRENT: 2021.01.08

ADDENDUM #2

SHEET:
E-603

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CAPE FEAR FD STONEWATER



101 NORTH THIRD STREET, SUITE 500
WILMINGTON, NORTH CAROLINA 28401
TEL. 910.790.3111 FAX. 910.790.9901
WWW.LS3P.COM

NOT FOR CONSTRUCTION

NHC Government Center 7702-190810

NEW HANOVER COUNTY
GOVERNMENT CENTER
GOVERNMENT CENTER DRIVE
WILMINGTON, NC 28403

LS3P PROJECT: 7702-190810

DATE	DESCRIPTION
A 2020.08.18	TI- SCHEMATIC DESIGN
B 2020.10.16	TI- DESIGN DEVELOPMENT
C 2020.12.16	GMP SET
D 2020.12.22	ADDENDUM #1
E 2021.01.08	ADDENDUM #2


SHEET NAME:
ELECTRICAL DETAILS -
LIGHTING CONTROLS

DATE: 2020.12.16
CURRENT: 2021.01.08


ADDENDUM #2

SHEET: E-607

GMP SET

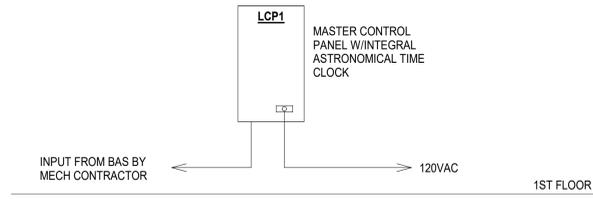


1 E-607 EOC BUILDING LIGHTING CONTROL RELAY PANEL RISER DIAGRAM NTS

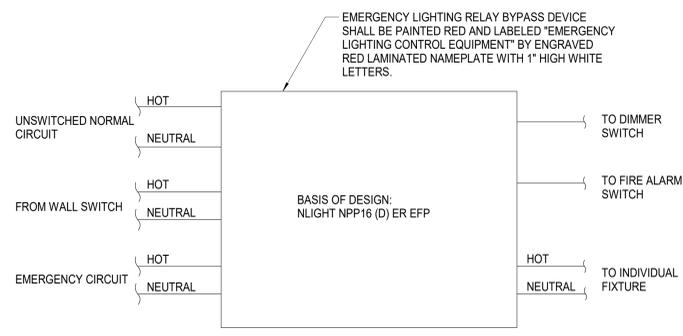

- NOTES:
- WHEN NORMAL POWER IS LOST EMERGENCY CIRCUIT SHALL BRING INDIVIDUAL LIGHT FIXTURE TO FULL BRIGHTNESS. ELR SHALL BE COMPATIBLE WITH DIMMING DRIVERS PROVIDED WITH LUMINAIRES.
 - ELR'S SHOWN ON PLANS ARE FOR DIAGRAMMATIC PURPOSES ONLY. ELR SHALL BE MOUNTED NEATLY TO STRUCTURE.


3 E-607 EOC BUILDING EMERGENCY LIGHTING RELAY SCHEME NTS

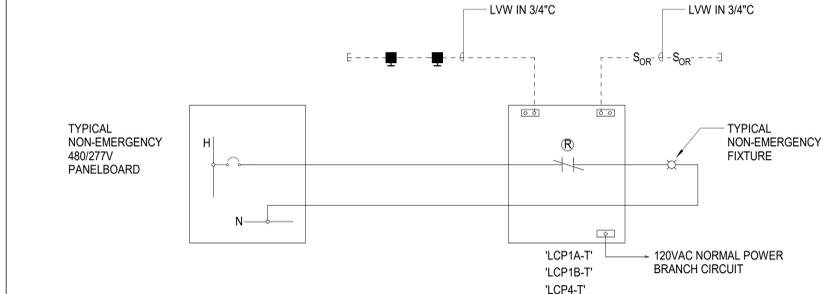

- LEGEND
- S_{OR} LOW VOLTAGE OVERRIDE SWITCH
 - (R) LOW VOLTAGE RELAY
 - LCP LIGHTING CONTROL PANEL
 - LWV LOW VOLTAGE DATA CABLE PER MFR RECOMMENDATIONS
 - Master Controller Touchscreen

- NOTES:
- PROVIDE LIGHTING RELAY PANELS WITH NUMBER OF RELAYS AS INDICATED ON THE RELAY PANEL SCHEDULES. EQUIVALENT TO WATTSTOPPER LMCP SERIES.


2 E-607 TOWER BUILDING LIGHTING CONTROL RELAY PANEL DIAGRAM NTS

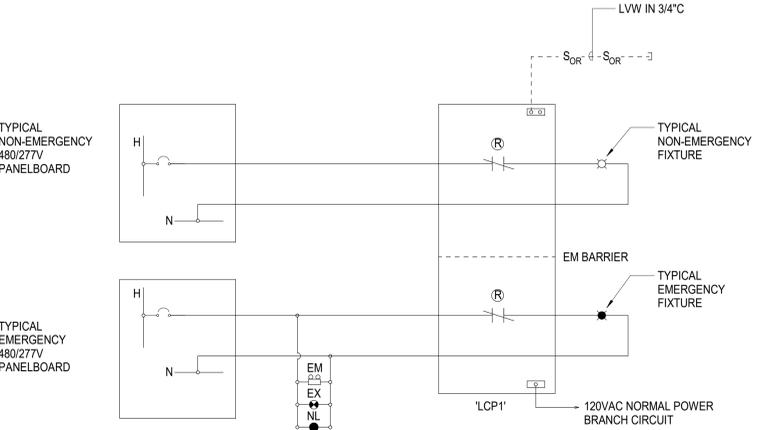

- LEGEND
- S_{OR} LOW VOLTAGE OVERRIDE SWITCH
 - (R) LOW VOLTAGE RELAY
 - LCP LIGHTING CONTROL PANEL
 - LWV LOW VOLTAGE DATA CABLE PER MFR RECOMMENDATIONS


- NOTES:
- PROVIDE LIGHTING RELAY PANEL WITH NUMBER OF RELAYS AS INDICATED ON THE RELAY PANEL SCHEDULE INCLUDING NORMAL AND EMERGENCY RELAYS, EQUIVALENT TO WATTSTOPPER LMCP SERIES.

4 E-607 EOC BUILDING LIGHTING CONTROL RELAY PANEL DIAGRAM NTS

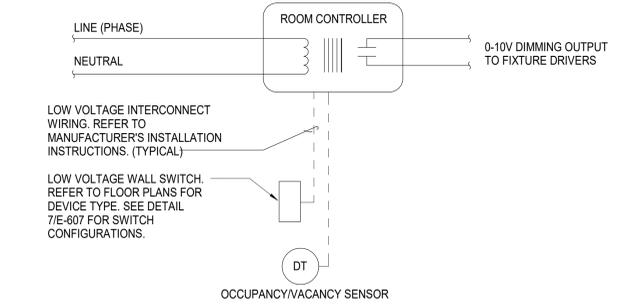


- NOTES:
- LOW VOLTAGE SWITCH SHALL HAVE FUNCTIONALITY (SWITCHING, OCCUPANCY OR DIMMING) AND NUMBER OF BUTTONS REQUIRED TO ACCOMMODATE ZONE SELECTION, ON/OFF SWITCHING AND RAISE/LOW CONTROL OF SELECTED ZONE.
 - ROOM CONTROLLERS SHALL BE LOCATED ABOVE THE NEAREST ACCESSIBLE CEILING. ALL ROOM CONTROLLERS SHALL BE DIMMING TYPE.
 - REFER TO FLOOR PLANS FOR QUANTITY, LOCATIONS OF SWITCHES AND NUMBER OF ZONES CONTROLLED. PROVIDE ROOM CONTROLLERS AS REQUIRED.
 - ROOM CONTROLLERS AND LOW VOLTAGE DIMMERS SHALL BE COMPATIBLE.
 - OCCUPANCY SENSOR SHALL ACT AS A "VACANCY SENSOR" (MANUAL ON, AUTOMATIC OFF) AND TURN LIGHTING OFF IF PERSON IS NO LONGER DETECTED IN THE ROOM. PROVIDE VACANCY TYPE SENSORS WHERE INDICATED ON FLOOR PLANS. PROVIDE OCCUPANCY TYPE SENSORS IN ALL OTHER AREAS.
 - LIGHTING CONTROL SYSTEM SHALL BE BY ONE OF THE FOLLOWING MANUFACTURERS: ACUITY N-LIGHT, WATTSTOPPER DLM OR EATON GREENGATE.

5 E-607 LOW VOLTAGE LIGHTING CONTROL SYSTEM DIAGRAM NTS

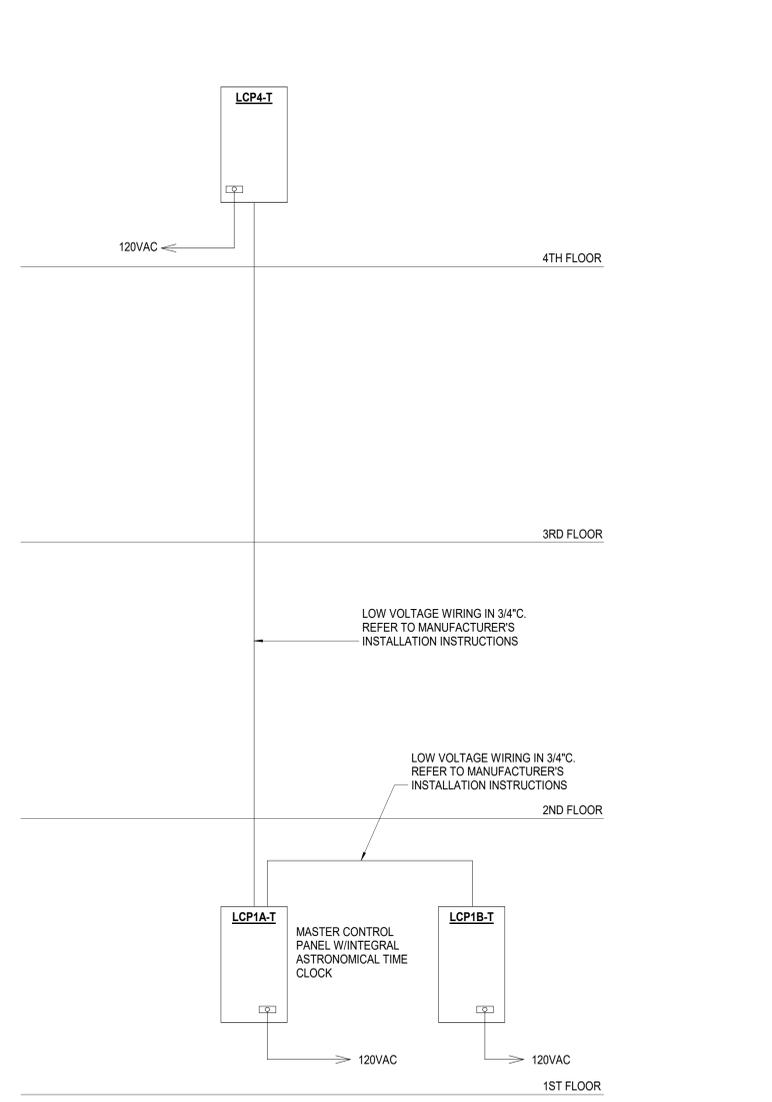

6 E-607 TOWER BUILDING LIGHTING CONTROL RELAY PANEL RISER DIAGRAM NTS

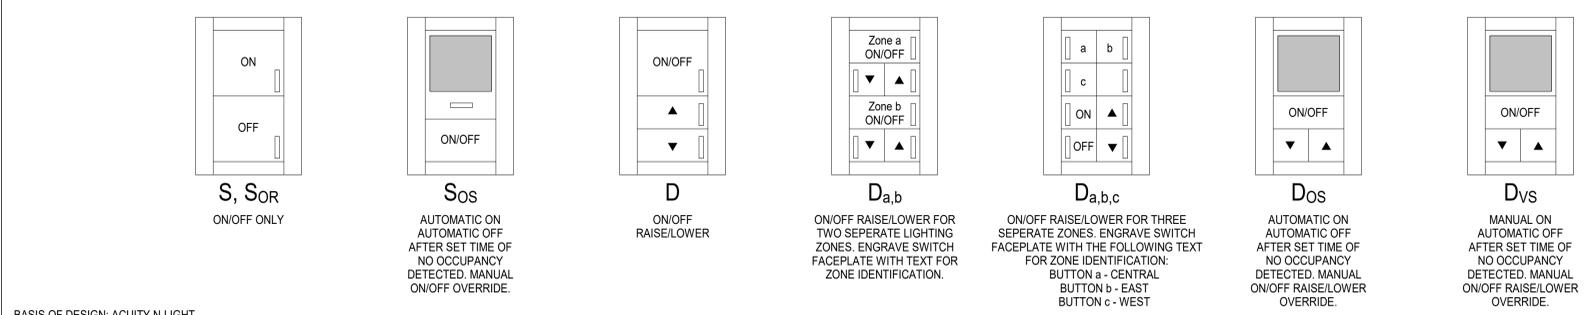

BASIS OF DESIGN: ACUITY N-LIGHT
APPROVED EQUALS: WATTSTOPPER DLM OR EATON GREENGATE
REFER TO THE FLOOR PLANS FOR TYPES AND LOCATIONS.

7 E-607 TYPICAL LOW VOLTAGE LIGHTING SWITCH CONFIGURATIONS NTS

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SCOPE GUIDANCE AND GENERAL NOTES


- THE WORK DESCRIBED IN THESE T-SERIES DRAWINGS APPLY TO SPECIFICATION SECTIONS 27 00 10, 27 00 50, 27 00 90, 27 10 00, 27 11 00.
- ELECTRICAL SCOPE:**
THE INFRASTRUCTURE PORTION OF THESE DOCUMENTS SHALL BE PROVIDED AND INSTALLED BY THE ELECTRICAL CONTRACTOR AND SHALL INCLUDE, BUT NOT BE LIMITED TO, THE FOLLOWING:
2.1 TELECOM SPACES
2.1.1 BACKBOARDS
2.2 CONDUIT PULL BOXES
2.3 RISER SLEEVES
2.4 SLEEVES FROM TELECOM SPACES TO CABLE TRAY
2.5 SLEEVES THROUGH WALL PARTITIONS ALONG CABLE TRAY ROUTE INCLUDING AIR ZONE/SPACE PARTITIONS
2.6 JUNCTION BOXES
2.7 FLOOR BOXES, AS SPECIFIED BY ELECTRICAL OR AUDIOVISUAL
2.8 SITE WORK, DUCTBANK AND INNERDUCT FOR CAMPUS DISTRIBUTION
2.9 INTERIOR INNERDUCT
2.10 BONDING AND GROUNDING CONDUIT AND RACEWAY TO GROUND BUS
- CABLING SCOPE**
THE CABLING PORTION OF THESE DOCUMENTS SHALL BE PROVIDED AND INSTALLED BY THE COMMUNICATIONS CABLING CONTRACTOR AND SHALL INCLUDE, BUT NOT BE LIMITED TO, THE FOLLOWING:
3.1 TELECOM SPACES
3.1.1 TELECOM RELAY RACKS AND EQUIPMENT CABINETS
3.1.2 CABLE RUNWAY AND TRAY IN TELECOM ROOMS
3.1.3 PATCH PANELS
3.1.4 TERMINATION BLOCKS
3.1.5 VERTICAL AND HORIZONTAL CABLING MANAGEMENT
3.1.6 BONDING AND GROUNDING OF EQUIPMENT TO GROUND BUS (AS PROVIDED BY ELECTRICAL PORTION)
3.2 CABLING AND CONNECTIVITY
3.2.1 ALL COPPER AND FIBER CABLING PATCH CORDS
3.2.2 ALL COPPER AND FIBER CONNECTORS AND JACKS
3.2.3 ALL COPPER AND FIBER TERMINATIONS
3.2.4 ALL DATA CABLING REQUIRED TO SUPPORT SECURITY AND ACCESS CONTROL INFRASTRUCTURE. (CAMERAS, CARD READERS, MEDIA CONVERTERS, ETC.)
3.2.5 WORKSTATION FACEPLATES
3.2.6 CONSOLIDATION POINTS
3.2.7 EXTERIOR/OUTSIDE PLANT CABLING, INCLUDING TERMINATIONS AND TESTING.
3.3 INTERIOR & EXTERIOR PATHWAYS
3.3.1 SEALING OF TELECOM CONDUITS AND SLEEVES
3.4 WIRELESS ACCESS POINTS
3.4.1 WIRELESS ACCESS POINTS SHALL BE OWNER FURNISHED, CONTRACTOR INSTALLED
3.4.2 ASSUME THAT WIRELESS ACCESS POINTS WILL BE PROVIDED WITH STANDARD MOUNTING ACCESSORIES ONLY. ANY SPECIAL MOUNTING EQUIPMENT, FITTINGS OR ACCESSORIES SHALL BE PROVIDED BY THE CONTRACTOR.
3.4.3 CONTRACTOR TO PROVIDE MOCK-UP INSTALLATION PRIOR TO ROUGH-IN OF UNITS TO BE INSTALLED IN EACH CEILING INSTALLATION TYPE.
3.4.4 CONTRACTOR SHALL REVIEW INSTALLATION ON ALL CEILING TYPES WITH OWNER PRIOR TO ROUGH-IN
3.4.5 CONTRACTOR TO PROVIDE ALL PATCH CORDS, LABELING, AND AS-BUILT DOCUMENTATION
3.4.6 CONTRACTOR TO SUBMIT FOR APPROVAL ANY DIVIATIONS FROM THE DETAILS INCLUDED IN THESE DESIGN DOCUMENTS.
- THE CONTRACTOR RESPONSIBLE FOR THE ELECTRICAL PORTION SHALL PROVIDE AND INSTALL ALL INCIDENTAL EQUIPMENT AND MATERIALS RELATED TO THEIR WORK AND REQUIRED BY THE COMMUNICATIONS CABLING DOCUMENTS. FOR EXAMPLE, INSULATING BUSHINGS FOR CONDUIT ENDS SHALL BE PROVIDED BY THE ELECTRICAL CONTRACTOR.
- THE CONTRACTOR RESPONSIBLE FOR THE CABLING PORTION SHALL PROVIDE AND INSTALL ALL INCIDENTAL EQUIPMENT AND MATERIALS RELATED TO THEIR WORK AND REQUIRED BY THE COMMUNICATION CABLING DOCUMENTS. FOR EXAMPLE, CABLE TIES NECESSARY FOR CABLE MANAGEMENT SHALL BE PROVIDED BY THE CABLING CONTRACTOR.
- FOR THE INFRASTRUCTURE PORTION, ANY AND ALL DEVIATIONS FROM THE CONTRACT DOCUMENTS REQUIRED BY FIELD CONDITIONS SHALL BE RESOLVED THROUGH THE RFI (REQUEST FOR INFORMATION) PROCESS TO AVOID INADEQUATE OR INCORRECT INFRASTRUCTURE FOR USE BY THE CABLING CONTRACTOR.
- THE CABLING CONTRACTOR SHALL NOTE THAT SECURITY DRAWINGS REQUIRING CAT6 CABLING TO BE RUN BY THE STRUCTURED CABLING CONTRACTOR.
- CONDUITS AND OTHER RACEWAYS USED FOR ANY PURPOSE, INCLUDING WIRING AND CABLING FOR BUILDING WITHIN ARCHITECTURAL SHAFTS AND ENCLOSURES INDICATED ON THE DRAWING OR CONCEALED WITHIN THE CONCRETE STRUCTURE, EXCEPT WHERE ROUTING IS SPECIFICALLY SHOWN OR DETAILED TO BE EXPOSED ON THE DRAWINGS, THE CONTRACTOR SHALL COORDINATE ROUTING OF RACEWAY WITHIN CONCRETE SLABS, BEAMS, AND COLUMNS WITH THE SUBCONTRACTORS. RACEWAY CONCEALED IN STRUCTURE SHALL NOT EXCEED 1" DIAMETER AND ROUTING OF SUCH RACEWAY SHALL BE MODIFIED TO COMPLY WITH THE CONCEALMENT AND SPACING REQUIREMENTS INDICATED ON THE STRUCTURAL DRAWINGS. RACEWAY SHALL NOT BE VISIBLE FROM THE FINISHED SPACE.
- PROVIDE A PROPERLY SIZED PULLBOX IN CONDUIT PATHWAYS WHERE CONDUIT WOULD EXCEED 100' OF CONTINUOUS PATHWAY OR 180 DEGREES OF BEND BETWEEN PULLBOXES OR THE ENDS OF THE CONDUIT PATHWAY.

SERVER ROOM EQUIPMENT

SERVER ROOM EQUIPMENT PROVIDED AS PART OF CUSTOMIZED SOLUTION THAT INCLUDES CABINETS, TERMINATION ACCESSORIES, CABLE MANAGEMENT, HOT AISLE CONTAINMENT, UPS AND BATTERY CABINET AS WELL AS OTHER HARDWARE AND ACCESSORIES. APC QUOTE/PART NUMBER ISX0001852536-0005

SOLUTION NUMBER : ISX0001852536-0005
DESIGN NAME : ISXD DESIGN 1
DESIGN NOTES FOR ISXD DESIGN 1

FOR MORE INFORMATION SEE BOM MATERIALS FILE INCLUDED WITH THE TELECOM DRAWINGS OR/AND CONTACT APC REPRESENTATIVE :
JIMMY JACK - TEL: 803 833 3046
JJACK@CRITICALCOMPONENTS.NET

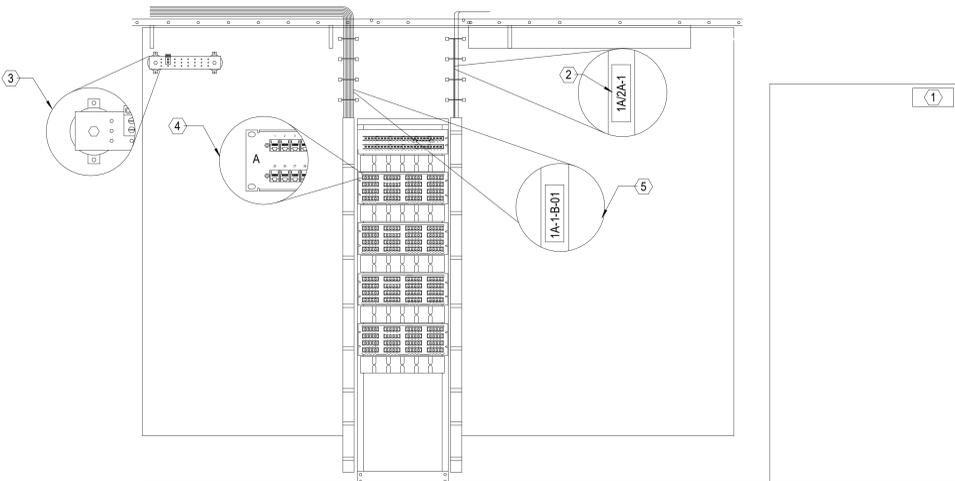

DRAWING SYMBOL	NAME	BACKBOX SIZE	MOUNTING HEIGHT AFF	CONDUIT SIZE	FACEPLATE TYPE	TERMINATION	PORT TYPE QUANTITIES			CABLING TYPE	CABLING COLOR	JACK COLOR	NOTES	GENERAL NOTES
							VOICE	DATA	COAX					
◁#D	UNIVERSAL DATA OUTLET	2G	18"	1"	SINGLE GANG 2-PORT	RJ-45		#		CAT 6	BLUE	BLUE	# INDICATED ON FLOOR PLANS REPRESENTS QUANTITY OF DATA CABLE DROPS REQUIRED	1. ALL INFORMATION IS TYPICAL AS INDICATED IN THIS MATRIX UNLESS OTHERWISE NOTED ELSEWHERE. 2. ALL OUTLETS SHALL BE LOCATED ADJACENT TO POWER RECEPTACLES WHERE APPLICABLE. 3. FINAL HEIGHT AND MOUNTING LOCATIONS SHALL BE COORDINATED WITH THE ARCHITECTURAL ELEVATIONS. 4. ALL OUTLET CONDUITS SHALL BE ROUTED TO THE NEAREST ACCESSIBLE CEILING SPACE IN THE CORRIDOR, UON. 5. PROVIDE BLANK MODULES FOR ALL UNUSED PORTS. 6. REAM AND BUSH ALL CONDUIT ENDS. 7. PROVIDE SINGLE GANG PLASTER RING FOR DOUBLE GANG BOXES WITH SINGLE GANG FACEPLATES. 8. PROVIDE DOUBLE GANG PLASTER RING FOR DOUBLE GANG BOXES WITH DOUBLE GANG FACEPLATES. 9. REFER TO FACEPLATE DETAILS FOR OUTLET PORT CONFIGURATION
◁#D	UNIVERSAL DATA OUTLET - ABOVE COUNTER	2G	SEE NOTE	1"	SINGLE GANG 2-PORT	RJ-45		#		CAT 6	BLUE	BLUE	MOUNT AT 8"-12" ABOVE COUNTER TOP COORDINATE WITH ELECTRICAL # INDICATED ON FLOOR PLANS REPRESENTS QUANTITY OF DATA CABLE DROPS REQUIRED.	
◁W	STANDARD WALL PHONE OUTLET	1G	48"	1"	WALL PHONE FACEPLATE	RJ-45		1		CAT 6	BLUE	BLUE		
◁DP	AV DISPLAY OUTLET	SEE NOTE	PER ARCH. ELEVATIONS	1"	SINGLE GANG 4-PORT	RJ-45		2		CAT 6	BLUE	BLUE	FURNISH AND INSTALL RECESSED BACKBOX PER DETAIL 4/T-501.	
A PT	POKE THRU - MODULAR FURNITURE INFEEED	NA	FLOOR	1.5"	SEE DETAIL	RJ-45		SEE NOTES		CAT 6	BLUE	BLUE	REFER TO ELECTRICAL DETAIL SHEET. ROUTE DATA CABLES TO DESK AS INDICATED.	
B PT	POKE THRU - SHARED DATA / ELECTRICAL	NA	FLOOR	1.25"	DATA ADAPTER PLATE	RJ-45		2		CAT 6	BLUE	BLUE	TERMINATE DATA CABLES IN POKE-THRU. COORDINATE WITH ELECTRICAL.	
P	FLOOR BOX WITH UNIVERSAL DATA OUTLET	NA	FLOOR	1.25"	4-PORT INSERT	RJ-45		SEE NOTES		CAT 6	BLUE	BLUE	REFER TO ELECTRICAL DETAIL SHEET. ROUTE DATA CABLES TO DESK AS INDICATED.	
B PT 4	FLOOR BOX WITH UNIVERSAL DATA OUTLET	NA	FLOOR	1.25"	4-PORT INSERT	RJ-45		4		CAT 6	WHITE	WHITE	SEE DETAILS ON SHEET AS INDICATED.	
C FB	POKE THRU - SHARED AV DATA / ELECTRICAL	NA	FLOOR	1.25"	DATA ADAPTER PLATE	RJ-45		2		CAT 6	BLUE	BLUE	TERMINATE DATA CABLES IN POKE-THRU. COORDINATE WITH ELECTRICAL.	
D FB	POKE THRU - SHARED AV DATA / ELECTRICAL	NA	FLOOR	1.25"	DATA ADAPTER PLATE	RJ-45		2		CAT 6	BLUE	BLUE	TERMINATE DATA CABLES IN POKE-THRU. COORDINATE WITH ELECTRICAL.	
B FB	RAISED FLOOR BOX - SHARED DATA/ELECTICAL	NA	FLOOR	1.25"	DATA ADAPTER PLATE	RJ-45		4		CAT 6	BLUE	BLUE	RAISED FLOOR BOX. TYPE DESIGNATED (RAISED FLOOR BOX DATA AND POWER WHIP PROVIDED AND INSTALLED BY RAISED FLOOR MANUFACTURER); COORDINATE WITH ELECTRICAL	
AP	UNIVERSAL DATA OUTLET FOR WIRELESS ACCESS POINT	NA	CEILING	1"	2-PORT BISCUIT BOX	RJ-45		2		CAT 6A	BLUE	BLUE	SEE DETAIL ON SHEET T-501 FOR MORE INFORMATION. ACCESS POINT TO BE PROVIDED BY OWNER. COORDINATE EXACT LOCATION WITH VENDOR/OWNER PRIOR TO INSTALLATION.	
S	UNIVERSAL DATA OUTLET FOR INFORMACAST SPEAKER	NA	CEILING	1"	2-PORT BISCUIT BOX	RJ-45		1		CAT 6	BLUE	BLUE	INFORMACAST SPEAKERS TO BE FURNISHED AND INSTALLED BY OWNER	
PRJ	PROJECTOR OUTLET	NA	CEILING	1"	2-PORT BISCUIT BOX	RJ-45		1		CAT 6	BLUE	BLUE		
◁	MODULAR FURNITURE OUTLET(S)	NA	SEE NOTE	NA	2-PORT INSERT	RJ-45		2		CAT 6	BLUE	BLUE	COORDINATE WITH FURNITURE MANUFACTURER PRIOR TO INSTALLATION. PROVIDE A 1.5" FLEX CONDUIT BETWEEN FURNITURE AND WALL. SEE DETAIL ON SHEET T-501.	
◁	WALL FED MODULAR FURNITURE OUTLET(S)	NA	SEE NOTE	2"	2-PORT INSERT	RJ-45		1		CAT 6	BLUE	BLUE	COORDINATE WITH FURNITURE MANUFACTURER PRIOR TO INSTALLATION. PROVIDE A 2" FLEX CONDUIT BETWEEN FURNITURE AND WALL.	
◁	VIDEO SURVEILLANCE CAMERA (OWNER FURNISHED)	2G	AS NOTED	SEE FLOOR PLANS	1-PORT BISCUIT BOX	RJ-45		1		CAT-6	BLUE	BLUE	CAT-6 FOR INDOOR OR BUILDING ATTACHED CAMERAS. HYBRID CABLING FOR SITE CAMERAS.	

STANDARD ABBREVIATIONS


- APC/AFF/AFG/ARF - ABOVE FINISHED CEILING/FLOOR/GRADE/RAISED FLOOR
- AP - ACCESS POINT
- ARCH - ARCHITECT/ARCHITECTURAL
- BCKBD - BACKBOARD
- BFC - BELOW FINISHED CEILING
- C - CONDUIT
- CONN - CONNECTION
- CKT - CIRCUIT
- CLG - CEILING
- EC - ELECTRICAL CONTRACTOR
- EMT - ELECTRICAL METALLIC TUBING
- EQUIP - EQUIPMENT
- EXIST - EXISTING
- F - FIBER
- FA - FIRE ALARM
- FOC - FIBER OPTIC CABLING
- G - GROUND
- HC - HORIZONTAL CROSS-CONNECT
- IDC - INSTALLATION DISPLACEMENT CONNECTOR
- IDS - INTRUSION DETECTION SYSTEM
- JB - JUNCTION BOX
- MM - MULTI-MODE
- MTD - MOUNTED
- NIC - NOT IN CONTRACT
- NTS - NOT TO SCALE
- OC - ON CENTER
- OFCI - OWNER FURNISHED, CONTRACTOR INSTALLED
- OSP - OUTSIDE PLANT
- PNL - PANEL
- PR - PAIR
- SPEC - SPECIFICATION
- RR - RISER RATED
- SM - SINGLE MODE
- ST - STRAND
- SW - SWITCH
- TGB - TELECOM GROUNDING BUS BAR
- TMGB - TELECOM MAIN GROUNDING BUS BAR
- WP - WEATHERPROOF
- UON - UNLESS OTHERWISE NOTED
- XFM - TRANSFORMER

LABELING REQUIREMENTS - ANSI-TIA 606-C

EQUIPMENT LOCATION AND SIZE ARE OUT OF SCALE FOR CLARITY. PORTIONS OF CABLE MANAGEMENT NOT SHOWN FOR CLARITY.

- ROOM IDENTIFIER** - PROVIDE A PLASTIC ENGRAVED LABEL WITH TEXT 2" HIGH. FORMAT SHALL BE "####-N" WHERE #### REPRESENTS THE ROOM NUMBER OF THE TELECOMMUNICATIONS SPACE. FOR EXAMPLE : A1020 = AMENITIES BUILDING FLOOR TELECOM ROOM
- BACKBONE CABLE** - PROVIDE A MACHINE PRINTED LABEL SECURED WITH SHRINK WRAP TO EACH BACKBONE CABLE. FORMAT SHALL BE "####1/####2 - N" WHERE ####1 IS THE ORIGINATION TS AND ####2 IS THE TERMINATION TS AND N IS THE CABLE NUMBER. FOR EXAMPLE : A1020/A2020-1" = CABLE 1 ROUTED BETWEEN A1020 ON FIRST FLOOR AND A2020 ON THE SECOND FLOOR.
- GROUND BUS** - PROVIDE A MACHINE PRINTED LABEL PERMANENTLY FIXED TO THE BUS BAR. FORMAT SHALL BE "####-TGB" WHERE FS IS THE TS THAT CONTAINS THE TGB. FOR EXAMPLE : A1020-TGB" = TELECOM SPACE A1020 TELECOM GROUNDING BUS BAR.
- PATCH PANELS** - PROVIDE MACHINE PRINTED LABELS PERMANENTLY FIXED TO THE PATCH PANEL. FORMAT SHALL BE "AN" WHERE A IS THE PATCH PANEL ALPHA NUMERIC ID AND N IS THE PATCH PANEL'S PORT NUMBER. FOR EXAMPLE "A07" = PATCH PANEL A PORT POSITION 07.
- HORIZONTAL CABLE** - PROVIDE MACHINE PRINTED LABEL SECURED WITH SHRINK WRAP TO EACH END OF EVERY HORIZONTAL CABLE. WHERE THE CABLE IS HOMERUN, FORMAT SHALL "####-N-A-N" WHERE #### IS THE TS IDENTIFIER AND N-A-N IS THE TERMINATION LOCATION. FOR EXAMPLE "A1020-1-B-01" = A1020, RACK 1, PATCH PANEL B, PORT 01. WHERE THE CABLE IS RUN TO A CONSOLIDATION POINT, FORMAT SHALL "FS-N-N". WHERE FS IS THE TS IDENTIFIER AND N-N IS THE TERMINATION LOCATION. FOR EXAMPLE "A1020-1-01" = A1020, CONSOLIDATION POINT 1, PORT 01.

LOW VOLTAGE SYMBOLS LEGEND

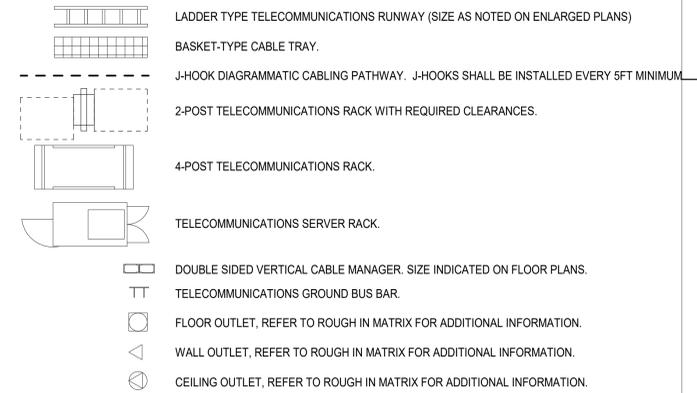

CAPE FEAR FD STONEWATER



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NHC Government Center 7702-190810

**NEW HANOVER COUNTY
GOVERNMENT CENTER**
GOVERNMENT CENTER DRIVE
WILMINGTON, NC 28403

A	DATE	DESCRIPTION
A	2020.08.18	T1- SCHEMATIC DESIGN
B	2020.10.16	T1- DESIGN DEVELOPMENT
C	2020.12.16	GMP SET
D	2020.12.22	ADDENDUM #1
E	2021.01.08	ADDENDUM #2

SHEET NAME:
TELECOM LEGEND AND NOTES

DATE: 2020.12.16
CURRENT: 2021.01.08

ADDENDUM #2

SHEET:

T-001

GMP SET

Newcomb & Boyd
CONSULTANTS AND ENGINEERS
Consulting Engineering Group
5425 Page Rd
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Durham, NC 27703
T 919 783-7812
Contact: Paul J. Kitchens
N&B PROJECT: 19N342
Firm License No. F-0312

THE NEW HANOVER COUNTY
ENGINEERING DEPARTMENT
100 SOUTH MARKET STREET
WILMINGTON, NC 28401

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RESPONSIBILITY MATRIX

	SUPPLIED BY					INSTALLED BY					DESIGN INFORMATION				NOTES			
	GENERAL CONTRACTOR	ELECTRICAL CONTR.	LOW VOLTAGE CONTR.	OWNER	APC BY SCHNEIDER ELECTRIC TOWER PROVIDER	NOT APPLICABLE (N/A)	GENERAL CONTRACTOR	ELECTRICAL CONTR.	LOW VOLTAGE CONTR.	OWNER	APC BY SCHNEIDER ELECTRIC TOWER PROVIDER	NOT APPLICABLE (N/A)	CIVIL (C)	ELECTRICAL (E)		LOW VOLTAGE (T / SC)	ARCHITECT (A)	NOT APPLICABLE (N/A)
FIBER BACKBONE CABLING																		
SERVICE PROVIDER FIBER CABLES				X				X							X			
INTERIOR OM4 MULTIMODE FIBER CABLES		X					X							X				SEE TELECOM T-601 FOR QUANTITY AND DETAILS
FIBER TERMINATION COMPONENTS AND CONSUMABLES		X					X							X				
TERMINATION HARDWARE (FIBER ENCLOSURES, SPLICE CASSETTES, ETC.)		X					X							X				
FIBER TESTING		X					X							X				
FIBER PATCH CORDS		X					X							X				
HORIZONTAL DATA CABLING																		
CAT-6 CABLE TO DATA DROPS		X					X							X				
CAT-6A TERMINATION TO WAP'S		X					X							X				
CAT-6 CABLE TO SECURITY DEVICES (CAMERAS, ETC.)		X					X							X				
CAT-6 TERMINATION (PATCH PANELS, JACKS, ETC.)		X					X							X				
CAT-6A PATCH CORDS		X					X							X				
CAT-6A CABLE TESTING		X					X							X				
TELECOMMUNICATIONS SPACES																		
IT ROOM SHELL (WALLS, FLOORING)	X					X								X				
PLYWOOD BACKBOARD	X					X								X				
CABLE RUNWAY		X					X							X				
TWO-POST NETWORK RACKS		X					X							X				
VERTICAL WIRE MANAGERS		X					X							X				
HORIZONTAL WIRE MANAGERS		X					X							X				
TELECOMMUNICATIONS GROUNDING		X					X							X				
ELECTRICAL RECEPTACLES	X					X							X					
SERVER ROOM EQUIPMENT (EQUIPMENT CABINETS, IN-ROW COOLING, PDU'S, ETC)				X				X						X				SOLUTION NUMBER : ISX0001852536-0005
PATHWAYS																		
UNDERGROUND SERVICE PROVIDER TELECOMMUNICATIONS PATHWAYS	X					X							X	X				
UNDERGROUND TOWER CONDUITS					X				X				X	X				
BACKBOX AND CONDUIT FOR INTERIOR DATA DROPS	X					X								X				
FIRESTOPPED CONDUITS SLEEVES	X					X								X				
J-HOOKS FOR DATA CABLING		X					X							X				
BACKBOX AND CONDUIT FOR SECURITY DEVICES	X					X							X	X				
CABLING PATHWAY / CABLE TRAY (TELECOM. ROOMS)		X					X							X				
ADDITIONAL ELECTRONICS AND EQUIPMENT																		
NETWORK SWITCHES			X				X								X			
NETWORK SWITCH INTEGRATOR		X					X								X			
WIRELESS ACCESS POINTS AND ASSOCIATED MOUNTS		X					X								X			
PHONE SYSTEM INCLUDING PHONE SETS, PROGRAMMING, CONFIGURATION, ETC.		X					X								X			
RACK-MOUNT UPS AND BATTERY PACK		X					X						X					
TELCOM ROOMS VERTICAL PDU AND ASSOCIATED RACK MOUNTING BRACKET		X					X						X					
SECURITY CAMERA SYSTEM - CAMERAS & EQUIPMENT		X					X							X				
ELECTRONIC SECURITY WIRING AND EQUIPMENT		X					X							X				
COMMUNICATIONS TOWER & ASSOCIATED DUCTBANKS/CABLING		X					X							X				
INFORMACAST SPEAKERS			X	X			X	X						X				



CAPE FEAR FD STONEWATER



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NHC Government Center 7702-190810

NEW HANOVER COUNTY
GOVERNMENT CENTER
GOVERNMENT CENTER DRIVE
WILMINGTON, NC 28403
LS3P PROJECT: 7702-190810


A	DATE	DESCRIPTION
A	2020.08.18	TI- SCHEMATIC DESIGN
B	2020.10.16	TI- DESIGN DEVELOPMENT
C	2020.12.16	GMP SET
E	2021.01.08	ADDENDUM #2

SHEET NAME:
TELECOM RESPONSIBILITY MATRIX

DATE: 2020.12.16
CURRENT: 2021.01.08
ADDENDUM #2

SHEET: T-002

Newcomb & Boyd
CONSULTANTS AND ENGINEERS
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Contact: Paul J. Kitchens
N&B PROJECT: 19N342
Firm License No. F-0312

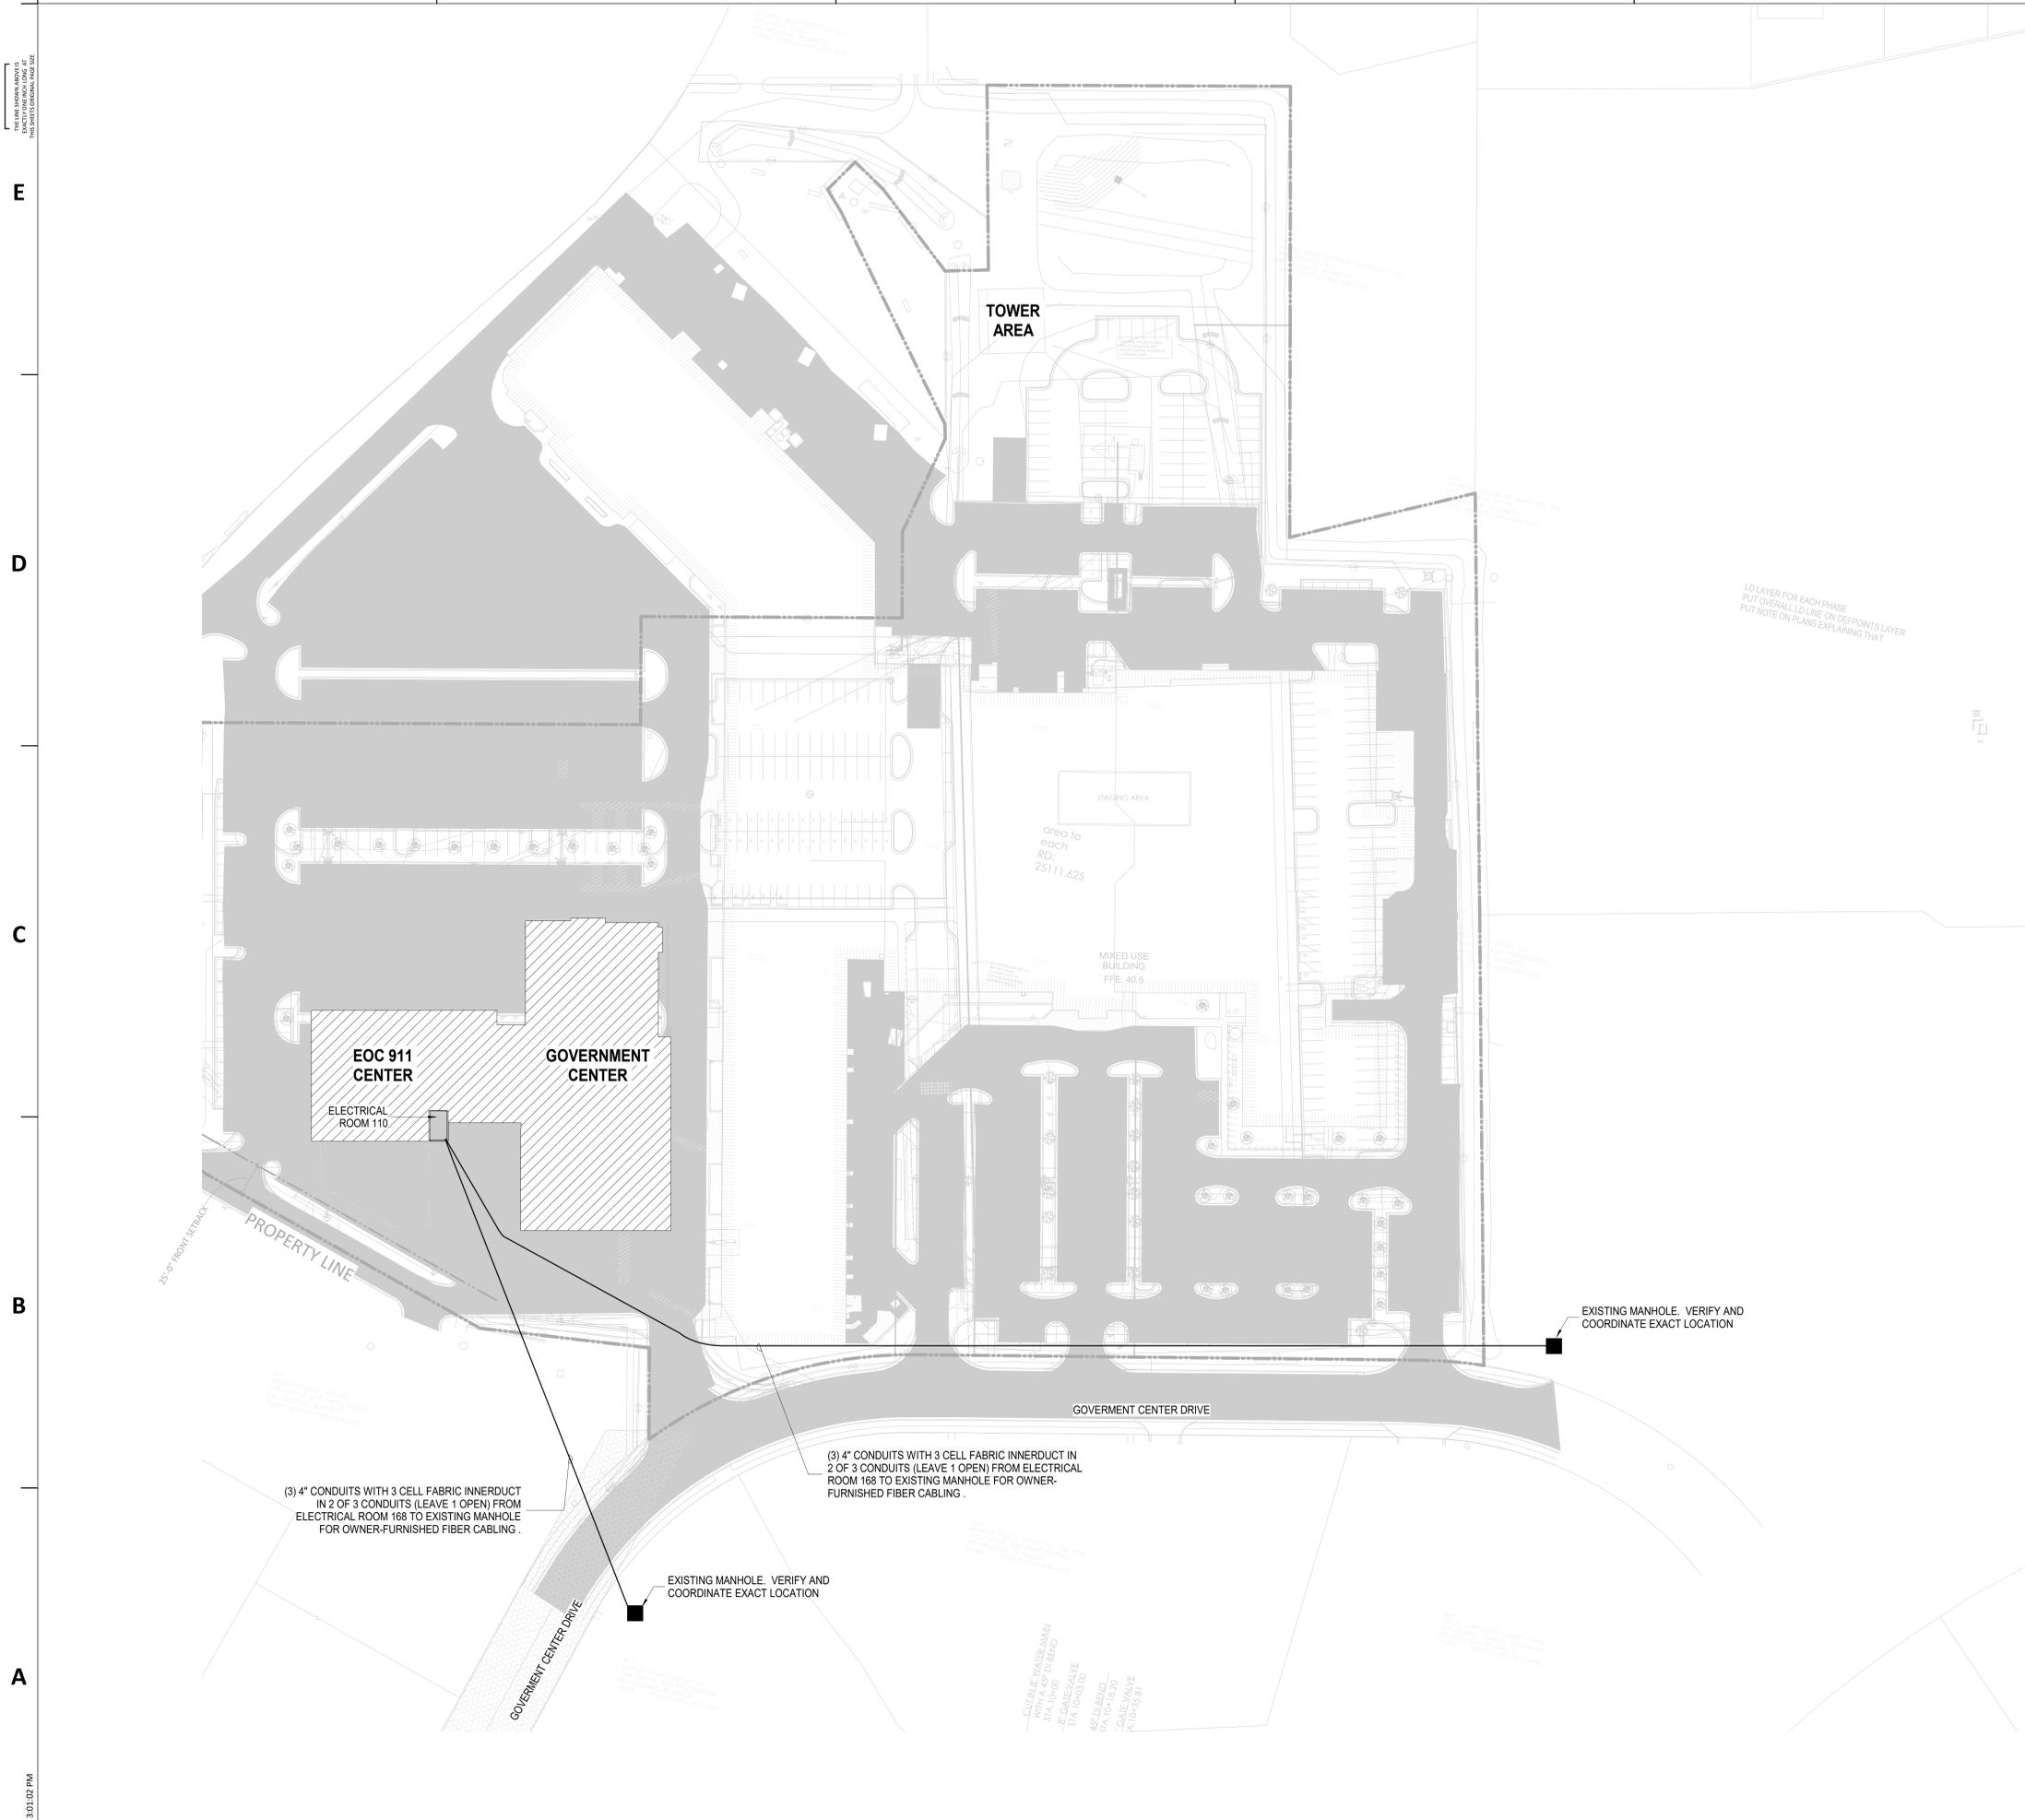

GENERAL NOTES:

1. REFER TO CIVIL PLANS FOR LOCATIONS OF OTHER UTILITIES. FIELD VERIFY AND COORDINATE LOCATIONS OF EXISTING UTILITIES PRIOR TO INSTALLATION.
2. UNDERGROUND CONDUIT ROUTES SHOWN ARE DIAGRAMMATIC AND FINAL ROUTES SHOULD BE COORDINATED WITH IN-FIELD CONDITIONS AND SURROUNDING UTILITIES IDENTIFIED ON THE CIVIL PLANS.
3. CONDUITS ENTERING INTO THE EXISTING MANHOLE SHALL TERMINATE IN THE LOWEST AVAILABLE WINDOW AND ALWAYS SLOPE TOWARDS INTO THE MANHOLE STRUCTURE TO PREVENT WATER BACK-FLOW INTO THE BUILDING.
4. CONDUITS ENTERING INTO THE BUILDING SHALL SLOPE AWAY FROM THE BUILDING ENTRANCE ROOM AND TOWARD THE UNDERGROUND MANHOLE / HAND HOLE STRUCTURES.



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NHC Government Center 7702-190810

**NEW HANOVER COUNTY
GOVERNMENT CENTER**
GOVERNMENT CENTER DRIVE
WILMINGTON, NC 28403
LS3P PROJECT: 7702-190810

A	DATE	DESCRIPTION
A	2020.08.18	TI-SCHEMATIC DESIGN
B	2020.10.16	TI-DESIGN DEVELOPMENT
C	2020.12.16	GMP SET
D	2021.01.22	ADDENDUM #1
E	2021.01.08	ADDENDUM #2

SHEET NAME:
TELECOM - SITE PLAN

DATE: 2020.12.16
CURRENT: 2021.01.08
ADDENDUM #2

SHEET:
T-100

GMP SET

Newcomb & Boyd
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THE USER ASSUMES ALL RESPONSIBILITY FOR THE ACCURACY OF THE INFORMATION SHOWN ON THIS DRAWING.

E

D

C

B

A



GENERAL NOTES:

1. ALL HORIZONTAL CABLING ON THIS SHEET SHALL TERMINATE IN HORIZONTAL CABLING RACK IN COMM ROOM 103.
2. CONTRACTOR MUST COORDINATE AND VERIFY AV OUTLET LOCATIONS WITH AV DRAWINGS AND TERMINATE ALL AV CABLING ON THIS SHEET IN AV CABINET ROOM 151.
3. COORDINATE OUTLET IN FURNITURE WITH FURNITURE PROVIDER AND ELECTRICAL DRAWINGS. OUTLET MAY BE MOUNTED IN COMMUNICATIONS RACEWAY IF PROVIDED WITH FURNITURE.
4. AV TOUCH PANEL NEEDS 1 DROP @ 48" AFF. DROP SHOULD BE TERMINATED IN A MALE RJ45 AND INSTALLED WITHIN THE AV BOX (T1 OR T2). COORDINATE WITH AV AND ARCHITECTURAL DRAWINGS.



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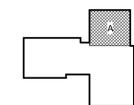
NHC Government Center 7702-190810

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 GOVERNMENT CENTER DRIVE
 WILMINGTON, NC 28403

LS3P PROJECT: 7702-190810

A	DATE	DESCRIPTION
A	2020.08.18	TI-SCHEMATIC DESIGN
B	2020.10.16	TI-DESIGN DEVELOPMENT
C	2020.12.16	GMP SET
E	2021.01.08	ADDENDUM #2

KEY PLAN:




SHEET NAME:
**TELECOM FLOOR
 PLAN - LEVEL 1 - AREA A**

DATE: 2020.12.16
 CURRENT: 2021.01.08

ADDENDUM #2

SHEET:
T-101A

Newcomb & Boyd
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 Firm License No. F-0312

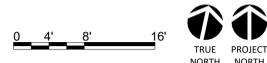

1/7/2021 3:01:08 PM
 1 T-101A TELECOM TI FLOOR PLAN - PARTIAL - LEVEL 1 - AREA A

1/8" = 1'-0"

1 2 3 4 5 6

GMP SET

THE USER ASSUMES ALL LIABILITY FOR ANY DAMAGE TO OR LOSS OF DATA OR INFORMATION CAUSED BY THE USE OF THIS DRAWING.

E

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GENERAL NOTES:

1. ALL HORIZONTAL CABLING ON THIS SHEET SHALL TERMINATE IN HORIZONTAL CABLING RACK IN COMM ROOM 103.
2. CONTRACTOR MUST COORDINATE AND VERIFY AV OUTLET LOCATIONS WITH AV DRAWINGS AND TERMINATE ALL AV CABLING ON THIS SHEET IN AV CABINET ROOM 151.
3. COORDINATE OUTLET IN FURNITURE WITH FURNITURE PROVIDER AND ELECTRICAL DRAWINGS. OUTLET MAY BE MOUNTED IN COMMUNICATIONS RACEWAY IF PROVIDED WITH FURNITURE.
4. AV TOUCH PANEL NEEDS 1 DROP @ 48" AFF. DROP SHOULD BE TERMINATED IN A MALE RJ45 AND INSTALLED WITHIN THE AV BOX (T1 OR T2). COORDINATE WITH AV AND ARCHITECTURAL DRAWINGS.

TELCOM KEY NOTES:

- ① (4) 4" FIRESTOPPED SLEEVES



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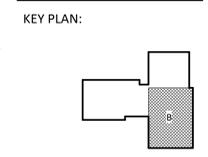
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**NEW HANOVER COUNTY
 GOVERNMENT CENTER**
 GOVERNMENT CENTER DRIVE
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 LS3P PROJECT: 7702-190810

DATE	DESCRIPTION
A 2020.08.18	TI- SCHEMATIC DESIGN
B 2020.10.16	TI- DESIGN DEVELOPMENT
C 2020.12.16	GMP SET
E 2021.01.08	ADDENDUM #2




SHEET NAME:
**TELCOM FLOOR
 PLAN - LEVEL 1 - AREA
 B**

DATE: 2020.12.16
 CURRENT: 2021.01.08
 ADDENDUM #2

SHEET:
T-101B

GMP SET

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 N&B PROJECT: 19N342
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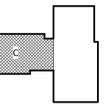
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NHC Government Center 7702-190810

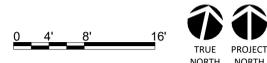**NEW HANOVER COUNTY
GOVERNMENT CENTER**
GOVERNMENT CENTER DRIVE
WILMINGTON, NC 28403
LS3P PROJECT: 7702-190810

A	DATE	DESCRIPTION
A	2020.08.18	TI- SCHEMATIC DESIGN
B	2020.10.16	TI- DESIGN DEVELOPMENT
C	2020.12.16	GMP SET
D	2020.12.22	ADDENDUM #1
E	2021.01.08	ADDENDUM #2

KEY PLAN:



SHEET NAME:
TELECOM FLOOR
PLAN - LEVEL 1 - AREA
C

DATE: 2020.12.16
CURRENT: 2021.01.08
ADDENDUM #2

SHEET:
T-101C

GMP SET

GENERAL NOTES:


- ALL HORIZONTAL CABLING ON THIS SHEET SHALL TERMINATE IN HORIZONTAL CABLING CABINETS IN SERVER ROOM 206.
- CONTRACTOR MUST COORDINATE AND VERIFY AV OUTLET LOCATIONS WITH AV DRAWINGS AND TERMINATE ALL AV CABLING ON THIS SHEET IN AV CABINET ROOM 151.
- COORDINATE OUTLET IN FURNITURE WITH FURNITURE PROVIDER AND ELECTRICAL DRAWINGS. OUTLET MAY BE MOUNTED IN COMMUNICATIONS RACEWAY IF PROVIDED WITH FURNITURE.
- AV TOUCH PANEL NEEDS 1 DROP @ 48" AFF. DROP SHOULD BE TERMINATED IN A MALE RJ45 AND INSTALLED WITHIN THE AV BOX (T1 OR T2). COORDINATE WITH AV AND ARCHITECTURAL DRAWINGS.

TELECOM KEY NOTES:


- (6) 4" CONDUITS FROM SERVER ROOM ABOVE FOR LEVEL 1 HORIZONTAL DISTRIBUTION
- UNDERGROUND CONDUITS PATHWAY TO FLOOR ABOVE. (6) 4" CONDUITS FOR SERVICE PROVIDER FIBER.
- (2) 4" CONDUITS FOR FIBER REDUNDANCY TO TOWER AREA. FOR REFERENCE ONLY. TOWER CONDUITS FURNISHED AND INSTALLED BY TOWER PROVIDER.
- (6) 4" FIRESTOPPED SLEEVES

TELECOM OUTLET - FACEPLATE REQUIREMENT (911 CALL CENTER 167 ONLY)

 <p>WALL FED MODULAR FURNITURE OUTLET(S) 2 FACEPLATES: 1- 2 PORT 1- 6 PORT</p>	<ol style="list-style-type: none"> (1) 2-PORT FACEPLATE FOR (2) CAT 6 DATA COLOR BLUE TO COUNTY SERVER ROOM 206. (1) 6-PORT FACEPLATE AS FOLLOWS: <ul style="list-style-type: none"> (2) CAT 6 DATA COLOR WHITE FOR AT&T SERVICES TO COMM ROOM 208. (3) CAT 6 DATA COLOR WHITE FOR MOTOROLA SERVICES TO COMM ROOM 208. (1) CAT 6 DATA COLOR WHITE FOR CALL RECORDING TO COMM ROOM 208. 	<p>COORDINATE WITH ARCHITECT AND FURNITURE MANUFACTURER PRIOR TO INSTALLATION. PROVIDE A 2" FLEX CONDUIT BETWEEN FURNITURE AND WALL. SEE DETAIL ON SHEET T-501.</p>
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Contact: Paul J. Kitchens
N&B PROJECT: 19N342
Firm License No. F-0312

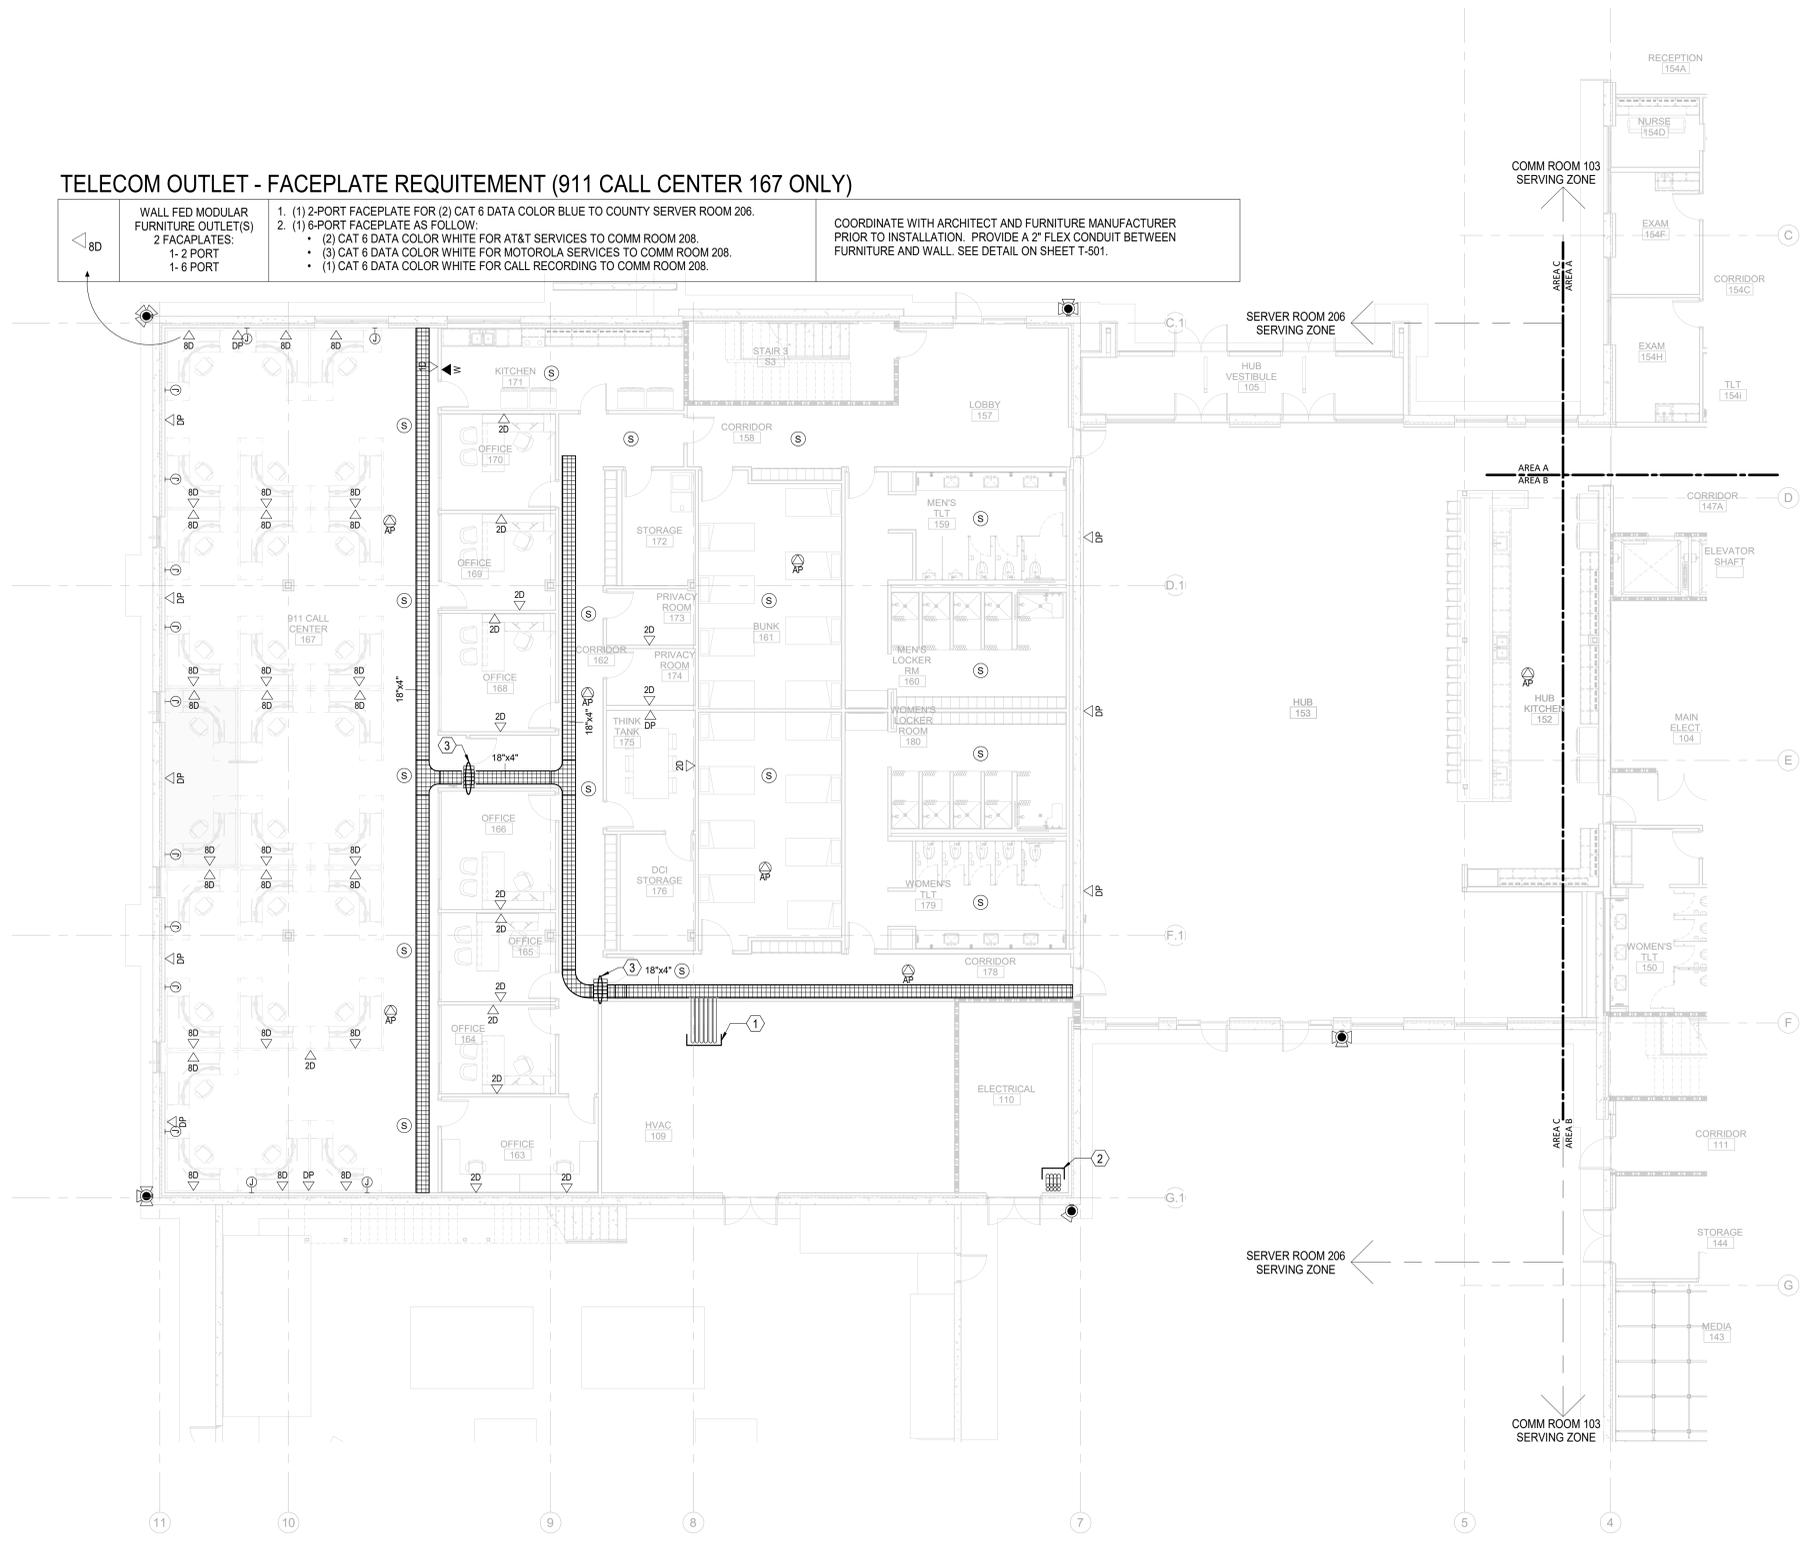

THE DATE SHOWN INDICATES
THE DATE OF THE ORIGINAL ISSUE
AND ALL SUBSEQUENT ISSUES.

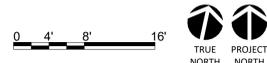
E

D

C

B

A

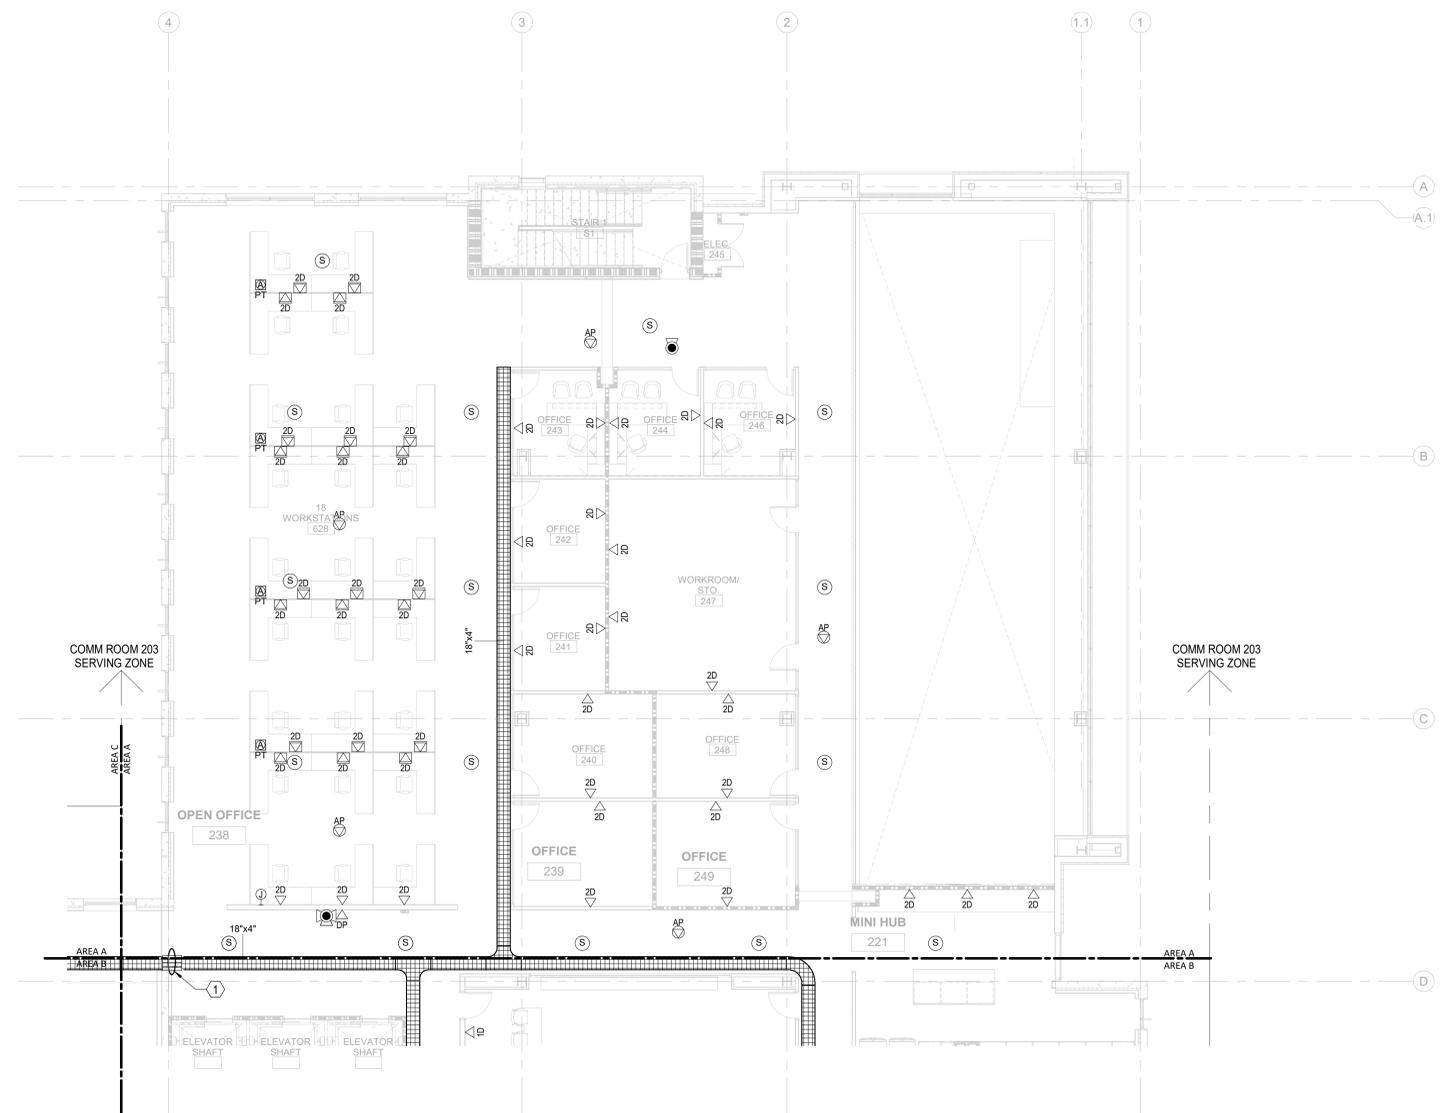

GENERAL NOTES:

1. ALL HORIZONTAL CABLING ON THIS SHEET SHALL TERMINATE IN HORIZONTAL CABLING RACK IN COMM ROOM 203.
2. CONTRACTOR MUST COORDINATE AND VERIFY AV OUTLET LOCATIONS WITH AV DRAWINGS AND TERMINATE ALL AV CABLING ON THIS SHEET IN AV CABINET ROOM 151 VIA COMM ROOM 203 VERTICAL PATHWAY.
3. COORDINATE OUTLET IN FURNITURE WITH FURNITURE PROVIDER AND ELECTRICAL DRAWINGS. OUTLET MAY BE MOUNTED IN COMMUNICATIONS RACEWAY IF PROVIDED WITH FURNITURE.
4. AV TOUCH PANEL NEEDS 1 DROP @ 48" AFF. DROP SHOULD BE TERMINATED IN A MALE RJ45 AND INSTALLED WITHIN THE AV BOX (T1 OR T2). COORDINATE WITH AV AND ARCHITECTURAL DRAWINGS.

TELCOM KEY NOTES:

- (1) (6) 4" FIRESTOPPED SLEEVES



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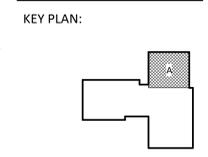
101 NORTH THIRD STREET, SUITE 500
WILMINGTON, NORTH CAROLINA 28401
TEL. 910.790.3111 FAX. 910.790.9901
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NHC Government Center 7702-190810

**NEW HANOVER COUNTY
GOVERNMENT CENTER**
GOVERNMENT CENTER DRIVE
WILMINGTON, NC 28403
LS3P PROJECT: 7702-190810

A	DATE	DESCRIPTION
A	2020.08.18	TI- SCHEMATIC DESIGN
B	2020.10.16	TI- DESIGN DEVELOPMENT
C	2020.12.16	GMP SET
E	2021.01.08	ADDENDUM #2




SHEET NAME:
**TELCOM FLOOR
PLAN - LEVEL 2 - AREA
A**

DATE: 2020.12.16
CURRENT: 2021.01.08
ADDENDUM #2

SHEET:
T-102A

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N&B PROJECT: 19N342
Firm License No. F-0312

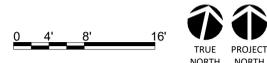

THE NEW HANOVER COUNTY
PLANNING AND ZONING DEPARTMENT
100 SOUTH GARDNER STREET
WILMINGTON, NC 28403

E

D

C

B

A



GENERAL NOTES:

1. ALL HORIZONTAL CABLING ON THIS SHEET SHALL TERMINATE IN HORIZONTAL CABLING RACK IN COMM ROOM 203.
2. CONTRACTOR MUST COORDINATE AND VERIFY AV OUTLET LOCATIONS WITH AV DRAWINGS AND TERMINATE ALL AV CABLING ON THIS SHEET IN AV CABINET ROOM 151 VIA COMM ROOM 203 VERTICAL PATHWAY.
3. COORDINATE OUTLET IN FURNITURE WITH FURNITURE PROVIDER AND ELECTRICAL DRAWINGS. OUTLET MAY BE MOUNTED IN COMMUNICATIONS RACEWAY IF PROVIDED WITH FURNITURE.
4. AV TOUCH PANEL NEEDS 1 DROP @ 48" AFF. DROP SHOULD BE TERMINATED IN A MALE RJ45 AND INSTALLED WITHIN THE AV BOX (T1 OR T2). COORDINATE WITH AV AND ARCHITECTURAL DRAWINGS.

TELCOM KEY NOTES:

- ① (6) 4" FIRESTOPPED SLEEVES



CAPE FEAR FD STONEWATER



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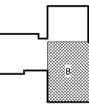
**NEW HANOVER COUNTY
GOVERNMENT CENTER**

GOVERNMENT CENTER DRIVE
WILMINGTON, NC 28403

LS3P PROJECT: 7702-190810

A	DATE	DESCRIPTION
A	2020.08.18	TI-SCHEMATIC DESIGN
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E	2021.01.08	ADDENDUM #2

KEY PLAN:



SHEET NAME:
TELECOM FLOOR
PLAN - LEVEL 2 - AREA
B

DATE: 2020.12.16
CURRENT: 2021.01.08
ADDENDUM #2

SHEET:
T-102B

GMP SET

Newcomb & Boyd
CONSULTANTS AND ENGINEERS
Consulting Engineering Group
5425 Page Rd
Suite 215
Durham, NC 27703
T 919 783-7812
Contact: Paul J. Kitchens
N&B PROJECT: 19N342
Firm License No. F-0312




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T-102B
TELECOM TI FLOOR PLAN - PARTIAL - LEVEL 2 - AREA B

1/8" = 1'-0"

1/7/2021 3:01:37 PM

TELECOM OUTLET - FACEPLATE REQUIREMENT (CONF. JCC 287, COMMAND 283 AND CONF. 285 ONLY)

◁ 8D	WALL FED MODULAR 2 FACEPLATES: 1- 2 PORT 1- 6 PORT	1. (1) 2-PORT FACEPLATE FOR (2) CAT 6 DATA COLOR BLUE TO COUNTY SERVER ROOM 206. 2. (1) 6-PORT FACEPLATE AS FOLLOW: • (2) CAT 6 DATA COLOR WHITE FOR AT&T SERVICES TO COMM ROOM 208. • (3) CAT 6 DATA COLOR WHITE FOR MOTOROLA SERVICES TO COMM ROOM 208. • (1) CAT 6 DATA COLOR WHITE FOR CALL RECORDING TO COMM ROOM 208.	COORDINATE WITH ARCHITECT AND FURNITURE MANUFACTURER PRIOR TO INSTALLATION.
◁ B 4 PT	FLOOR BOX WITH UNIVERSAL DATA OUTLET	1. (2) CAT 6 DATA COLOR WHITE FOR AT&T SERVICES TO COMM ROOM 208. 2. (2) CAT 6 DATA COLOR WHITE FOR MOTOROLA SERVICES TO COMM ROOM 208.	TERMINATE DATA CABLES IN POKE-THRU. COORDINATE WITH ELECTRICAL.

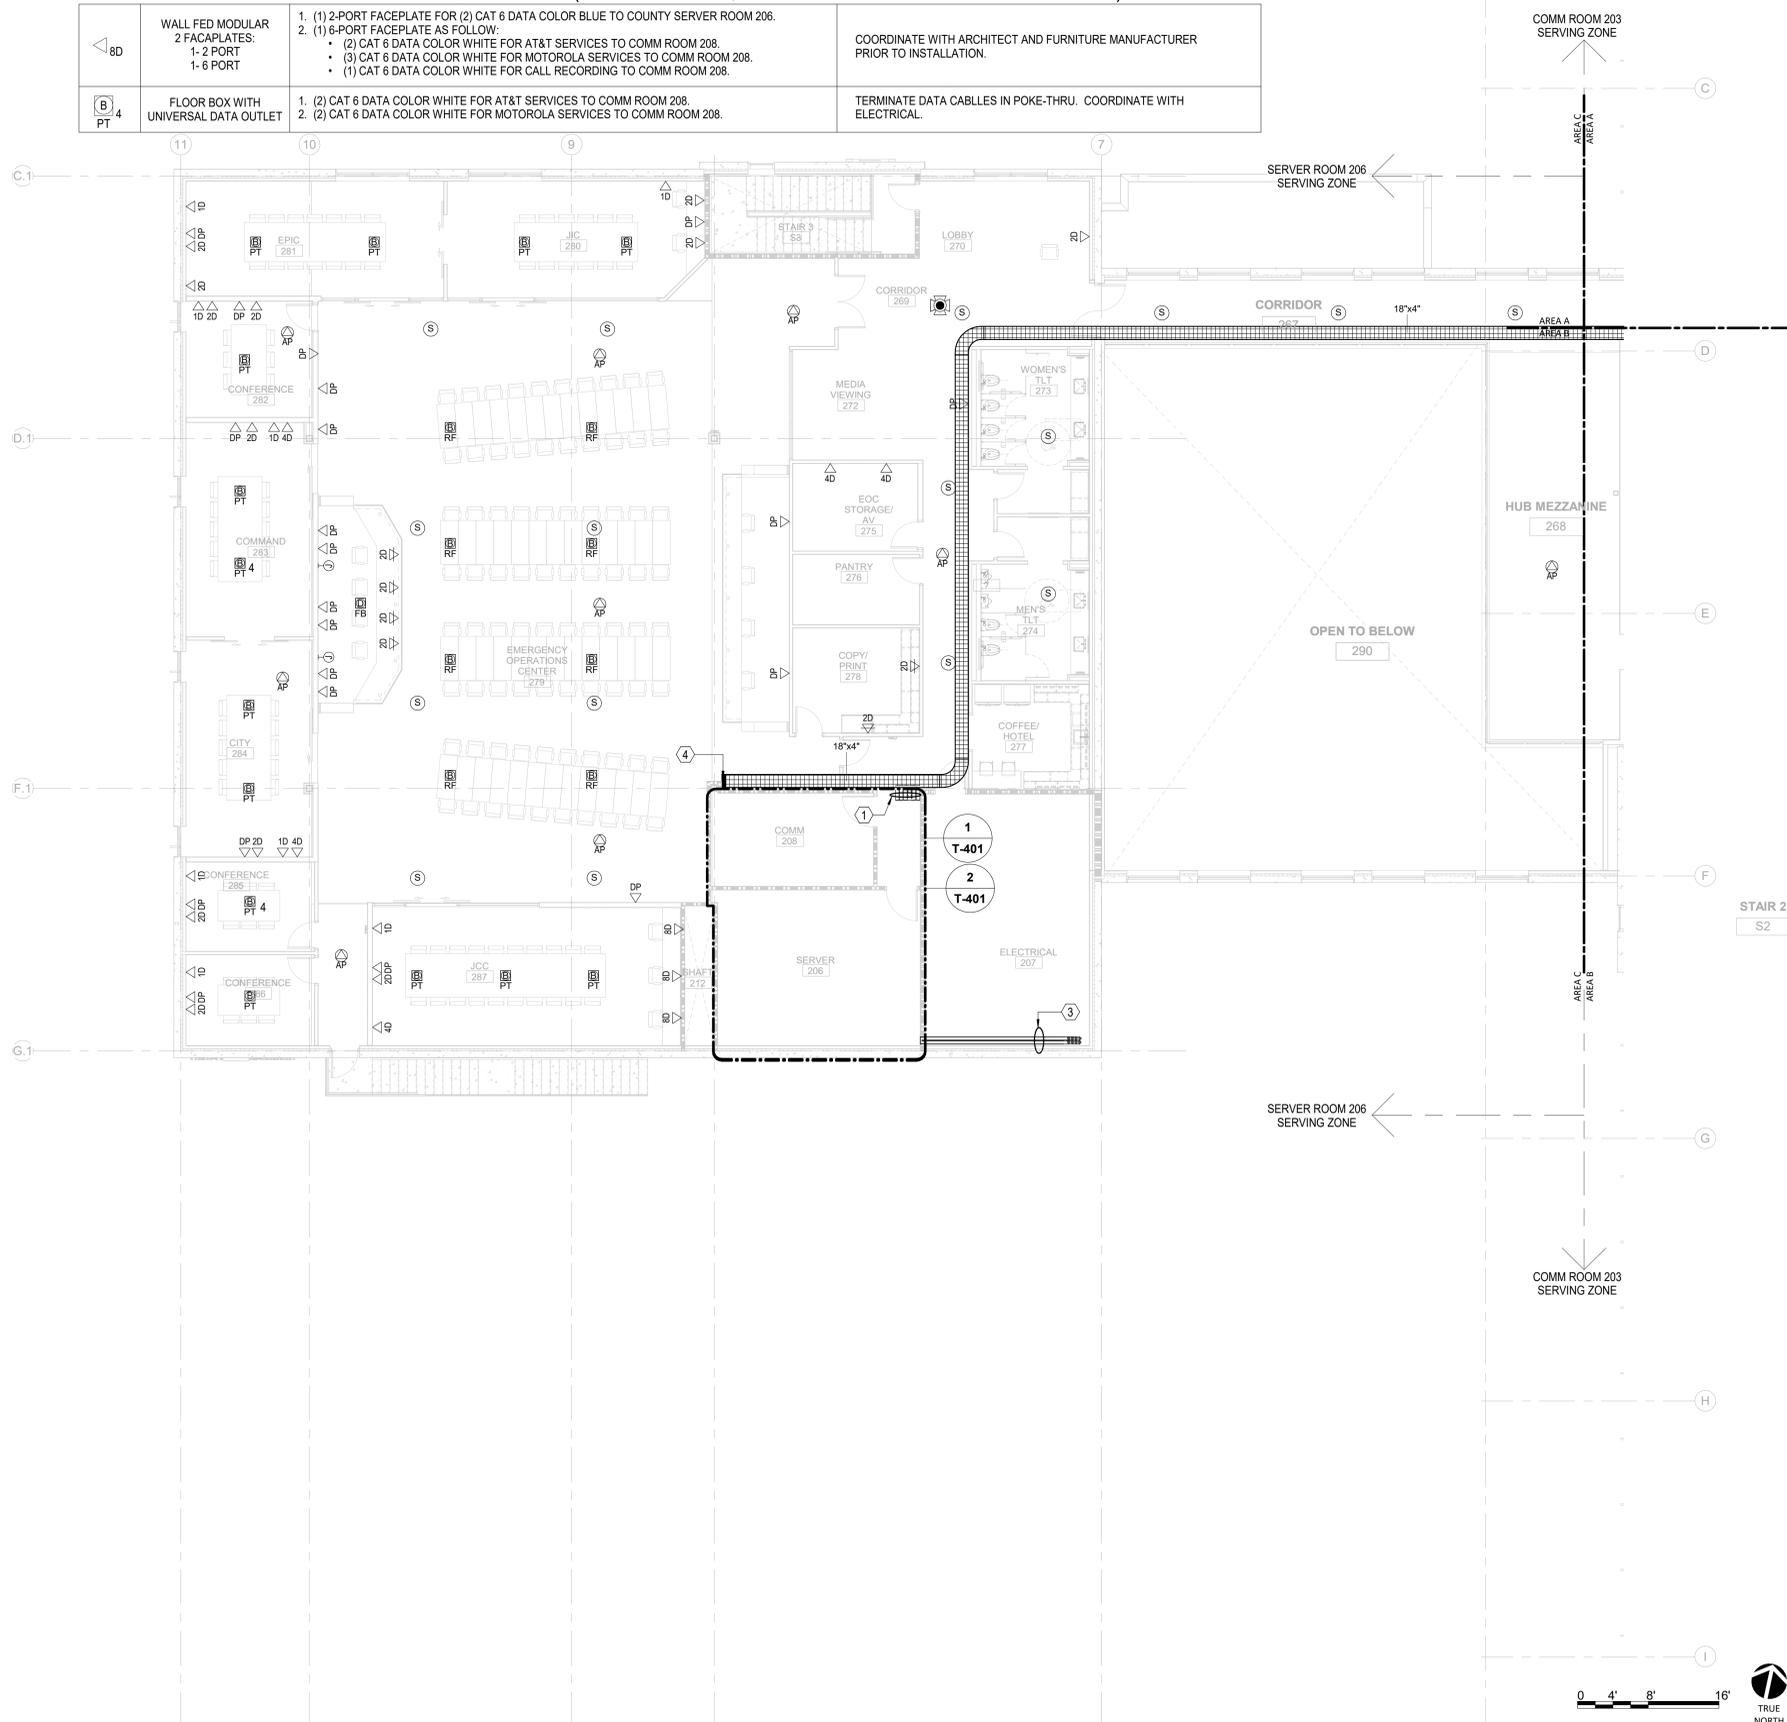

GENERAL NOTES:

1. ALL HORIZONTAL CABLING ON THIS SHEET SHALL TERMINATE IN HORIZONTAL CABLING CABINETS IN SERVER ROOM 206.
2. CONTRACTOR MUST COORDINATE AND VERIFY AV OUTLET LOCATIONS WITH AV DRAWINGS AND TERMINATE ALL AV CABLING ON THIS SHEET IN AV CABINET EOC STORAGE/AV ROOM 275.
3. COORDINATE OUTLET IN FURNITURE WITH FURNITURE PROVIDER AND ELECTRICAL DRAWINGS. OUTLET MAY BE MOUNTED IN COMMUNICATIONS RACEWAY IF PROVIDED WITH FURNITURE.
4. AV TOUCH PANEL NEEDS 1 DROP @ 48" AFF. DROP SHOULD BE TERMINATED IN A MALE RJ45 AND INSTALLED WITHIN THE AV BOX (T1 OR T2). COORDINATE WITH AV AND ARCHITECTURAL DRAWINGS.

KEYNOTES (THIS SHEET ONLY)

- ① (6) 4" FIRESTOPPED SLEEVES FOR HORIZONTAL DISTRIBUTION
- ② (4) 4" FIRESTOPPED SLEEVES
- ③ UNDERGROUND CONDUITS PATHWAY FROM FIRST FLOOR. (6) 4" CONDUITS FOR SERVICE PROVIDER FIBER.
-(2) 4" CONDUITS FOR FIBER REDUNDANCY TO TOWER AREA. SEE TELECOM SITE PLAN FOR DETAILS. FOR REFERENCE ONLY. FURNISHED AND INSTALLED BY TOWER PROVIDER.
- ④ IN-WALL VERTICAL RUNS DOWN TO RAISE FLOOR FOR HORIZONTAL DISTRIBUTION. CONTRACTOR MUST COORDINATE WITH VENDOR AND ARCHITECT.



CAPE FEAR FD STONEWATER



101 NORTH THIRD STREET, SUITE 500
 WILMINGTON, NORTH CAROLINA 28401
 TEL. 910.790.3111 FAX. 910.790.9901
 WWW.LS3P.COM

NOT FOR
 CONSTRUCTION


NHC Government Center 7702-190810

**NEW HANOVER COUNTY
 GOVERNMENT CENTER**
 GOVERNMENT CENTER DRIVE
 WILMINGTON, NC 28403

LS3P PROJECT: 7702-190810

A	DATE	DESCRIPTION
A	2020.08.18	TI- SCHEMATIC DESIGN
B	2020.10.16	TI- DESIGN DEVELOPMENT
C	2020.12.16	GMP SET
D	2020.12.22	ADDENDUM #1
E	2021.01.08	ADDENDUM #2

KEY PLAN:

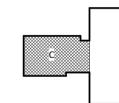

SHEET NAME:
**TELECOM FLOOR
 PLAN - LEVEL 2 - AREA
 C**

DATE: 2020.12.16
 CURRENT: 2021.01.08

ADDENDUM #2

SHEET:
T-102C

Newcomb & Boyd
 CONSULTANTS AND ENGINEERS
 Consulting Engineering Group
 5425 Page Rd
 Suite 215
 Durham, NC 27703
 T 919 783-7812
 Contact: Paul J. Kitchens
 N&B PROJECT: 19N342
 Firm License No. F-0312



1/8" = 1'-0"

THE USER ASSUMES ALL LIABILITY FOR THE USE OF THIS DRAWING FOR ANY PURPOSE OTHER THAN THAT AUTHORIZED BY THE CONTRACT.


E

D

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GENERAL NOTES:

1. ALL HORIZONTAL CABLING ON THIS SHEET SHALL TERMINATE IN HORIZONTAL CABLING RACK IN SERVER ROOM 303.
2. CONTRACTOR MUST COORDINATE AND VERIFY AV OUTLET LOCATIONS WITH AV DRAWINGS AND TERMINATE ALL AV CABLING ON THIS SHEET IN AV CABINET ROOM 151 VIA COMM ROOM 303 VERTICAL PATHWAY.
3. COORDINATE OUTLET IN FURNITURE WITH FURNITURE PROVIDER AND ELECTRICAL DRAWINGS. OUTLET MAY BE MOUNTED IN COMMUNICATIONS RACEWAY IF PROVIDED WITH FURNITURE.
4. AV TOUCH PANEL NEEDS 1 DROP @ 48" AFF. DROP SHOULD BE TERMINATED IN A MALE RJ45 AND INSTALLED WITHIN THE AV BOX (T1 OR T2). COORDINATE WITH AV AND ARCHITECTURAL DRAWINGS.

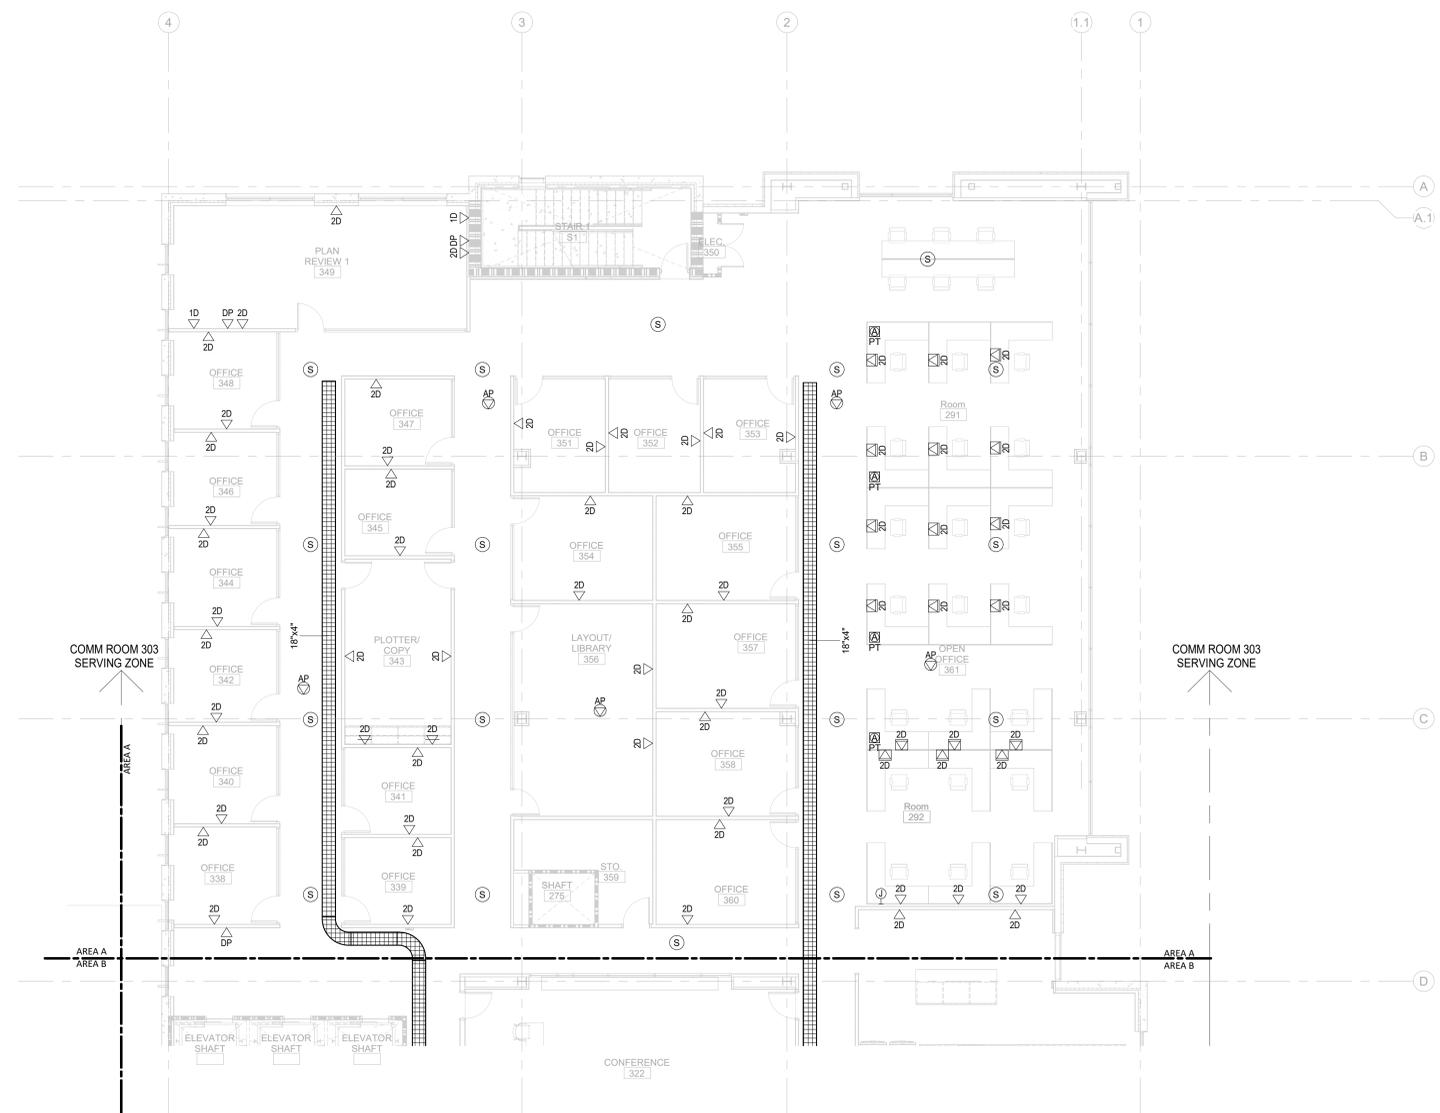

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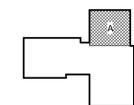
NOT FOR CONSTRUCTION

NHC Government Center 7702-190810

**NEW HANOVER COUNTY
 GOVERNMENT CENTER**
 GOVERNMENT CENTER DRIVE
 WILMINGTON, NC 28403
 LS3P PROJECT: 7702-190810

DATE	DESCRIPTION
A 2020.08.18	TI-SCHEMATIC DESIGN
B 2020.10.16	TI-DESIGN DEVELOPMENT
C 2020.12.16	GMP SET
E 2021.01.08	ADDENDUM #2

KEY PLAN:




SHEET NAME:
 TELECOM FLOOR
 PLAN - LEVEL 3 - AREA A

DATE: 2020.12.16
 CURRENT: 2021.01.08

ADDENDUM #2

SHEET:
T-103A

Newcomb & Boyd
 CONSULTANTS AND ENGINEERS
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 5425 Page Rd
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 Durham, NC 27703
 T 919 783-7812
 Contact: Paul J. Kitchens
 N&B PROJECT: 19N342
 Firm License No. F-0312

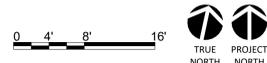

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E

D

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GENERAL NOTES:

1. ALL HORIZONTAL CABLING ON THIS SHEET SHALL TERMINATE IN HORIZONTAL CABLING RACK IN SERVER ROOM 303.
2. CONTRACTOR MUST COORDINATE AND VERIFY AV OUTLET LOCATIONS WITH AV DRAWINGS AND TERMINATE ALL AV CABLING ON THIS SHEET IN AV CABINET ROOM 151 VIA COMM ROOM 303 VERTICAL PATHWAY.
3. COORDINATE OUTLET IN FURNITURE WITH FURNITURE PROVIDER AND ELECTRICAL DRAWINGS. OUTLET MAY BE MOUNTED IN COMMUNICATIONS RACEWAY IF PROVIDED WITH FURNITURE.
4. AV TOUCH PANEL NEEDS 1 DROP @ 48" AFF. DROP SHOULD BE TERMINATED IN A MALE RJ45 AND INSTALLED WITHIN THE AV BOX (T1 OR T2). COORDINATE WITH AV AND ARCHITECTURAL DRAWINGS.



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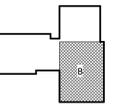
NOT FOR CONSTRUCTION

NHC Government Center 7702-190810

**NEW HANOVER COUNTY
 GOVERNMENT CENTER**
 GOVERNMENT CENTER DRIVE
 WILMINGTON, NC 28403
 LS3P PROJECT: 7702-190810

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B	2020.10.16 TI-DESIGN DEVELOPMENT
C	2020.12.16 GMP SET
D	2020.12.22 ADDENDUM #1
E	2021.01.08 ADDENDUM #2

KEY PLAN:



SHEET NAME:
**TELECOM FLOOR
 PLAN - LEVEL 3 - AREA
 B**

DATE: 2020.12.16
 CURRENT: 2021.01.08
 ADDENDUM #2

SHEET:
T-103B

GMP SET

Newcomb & Boyd
 CONSULTANTS AND ENGINEERS
 Consulting Engineering Group
 5425 Page Rd
 Suite 215
 Durham, NC 27703
 T 919 783-7812
 Contact: Paul J. Kitchens
 N&B PROJECT: 19N342
 Firm License No. F-0312



1/7/2021 3:01:56 PM
 1 T-103B TELECOM TI FLOOR PLAN - PARTIAL - LEVEL 3 - AREA B

1/8" = 1'-0"

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THE USER ASSUMES ALL RESPONSIBILITY FOR THE ACCURACY OF THE INFORMATION SHOWN ON THIS DRAWING.


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GENERAL NOTES:

1. ALL HORIZONTAL CABLING ON THIS SHEET SHALL TERMINATE IN HORIZONTAL CABLING RACK IN SERVER ROOM 403.
2. CONTRACTOR MUST COORDINATE AND VERIFY AV OUTLET LOCATIONS WITH AV DRAWINGS AND TERMINATE ALL AV CABLING ON THIS SHEET IN AV CABINET ROOM 151 VIA COMM ROOM 403 VERTICAL PATHWAY. COORDINATE WITH AV CONTRACTOR IF PATCHING IS REQUIRED DUE TO DISTANCE LIMITATION.
3. COORDINATE OUTLET IN FURNITURE WITH FURNITURE PROVIDER AND ELECTRICAL DRAWINGS. OUTLET MAY BE MOUNTED IN COMMUNICATIONS RACEWAY IF PROVIDED WITH FURNITURE.
4. AV TOUCH PANEL NEEDS 1 DROP @ 48" AFF. DROP SHOULD BE TERMINATED IN A MALE RJ45 AND INSTALLED WITHIN THE AV BOX (T1 OR T2). COORDINATE WITH AV AND ARCHITECTURAL DRAWINGS.



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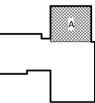
NHC Government Center 7702-190810

**NEW HANOVER COUNTY
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 GOVERNMENT CENTER DRIVE
 WILMINGTON, NC 28403

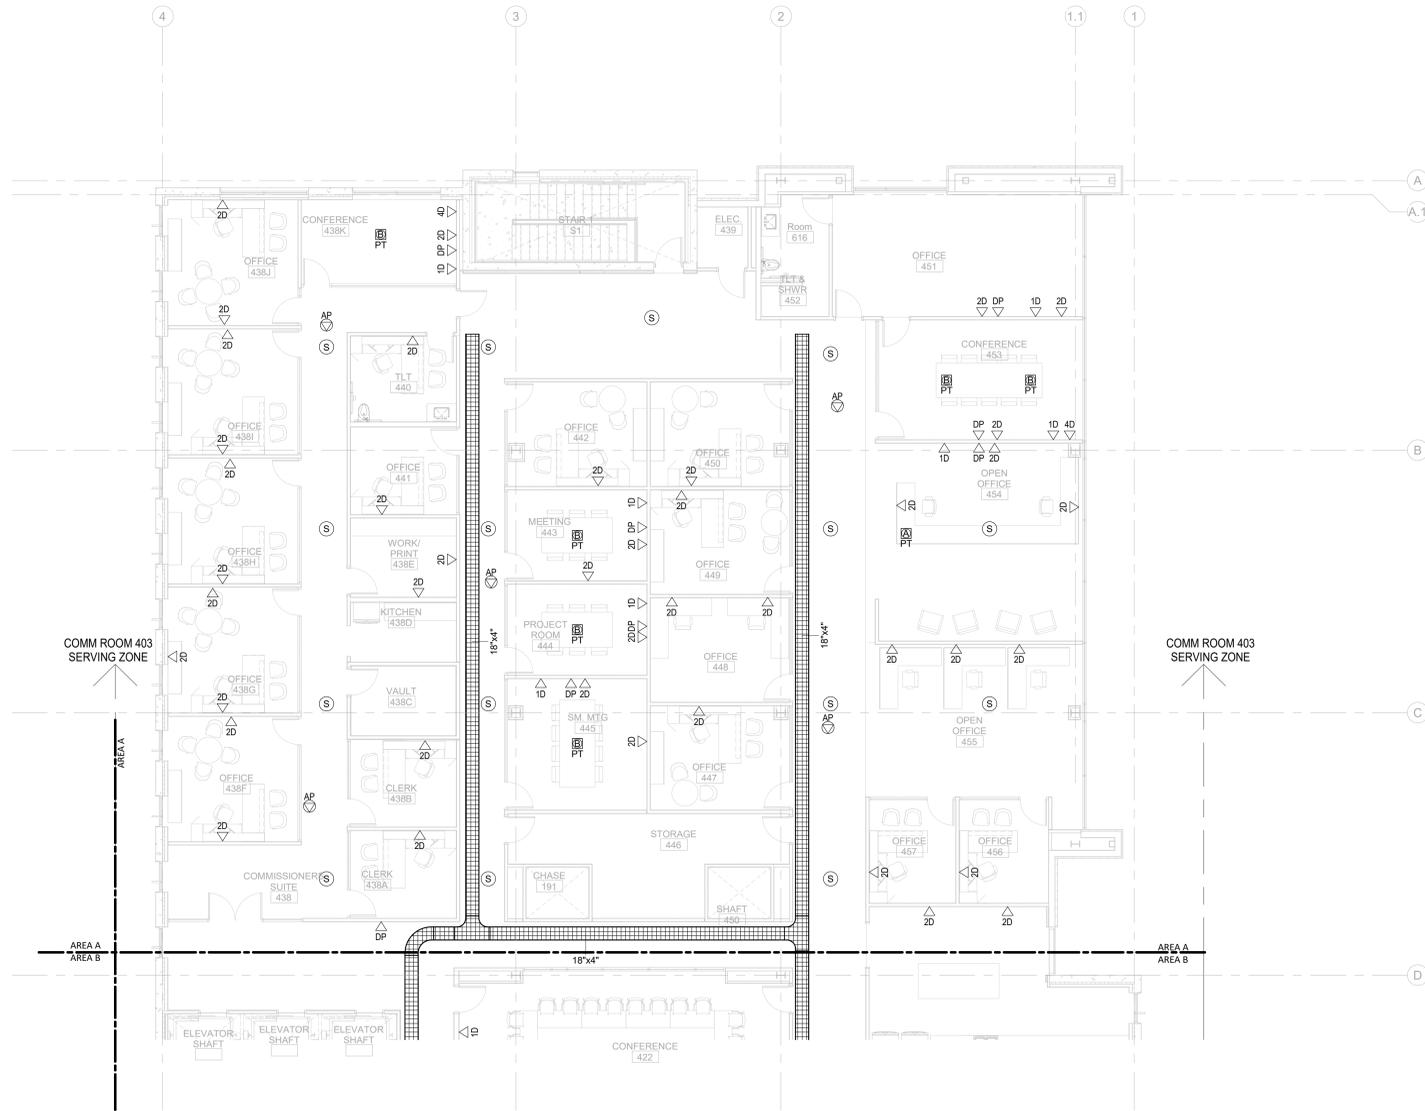LS3P PROJECT: 7702-190810

A	DATE	DESCRIPTION
A	2020.08.18	TI-SCHEMATIC DESIGN
B	2020.10.16	TI-DESIGN DEVELOPMENT
C	2020.12.16	GMP SET
E	2021.01.08	ADDENDUM #2

KEY PLAN:



SHEET NAME:
**TELECOM FLOOR
 PLAN - LEVEL 4 - AREA
 A**

DATE: 2020.12.16
 CURRENT: 2021.01.08

ADDENDUM #2

SHEET:
T-104A

Newcomb & Boyd
 CONSULTANTS AND ENGINEERS
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 5425 Page Rd
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 T 919 783-7812
 Contact: Paul J. Kitchens
 N&B PROJECT: 19N342
 Firm License No. F-0312



1/8" = 1'-0"

1/7/2021 3:02:03 PM
 1 T-104A TELECOM TI FLOOR PLAN - PARTIAL - LEVEL 4 - AREA A

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GMP SET

THE USER ASSUMES ALL RESPONSIBILITY FOR THE ACCURACY OF THE INFORMATION SHOWN ON THIS DRAWING.


E

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GENERAL NOTES:

1. ALL HORIZONTAL CABLING ON THIS SHEET SHALL TERMINATED IN HORIZONTAL CABLING RACK IN SERVER ROOM 403.
2. CONTRACTOR MUST COORDINATE AND VERIFY AV OUTLET LOCATIONS WITH AV DRAWINGS AND TERMINATE ALL AV CABLING ON THIS SHEET IN AV CABINET ROOM 151 VIA COMM ROOM 403 VERTICAL PATHWAY. COORDINATE WITH AV CONTRACTOR IF PATCHING IS REQUIRED DUE TO DISTANCE LIMITATION.
3. COORDINATE OUTLET IN FURNITURE WITH FURNITURE PROVIDER AND ELECTRICAL DRAWINGS. OUTLET MAY BE MOUNTED IN COMMUNICATIONS RACEWAY IF PROVIDED WITH FURNITURE.
4. AV TOUCH PANEL NEEDS 1 DROP @ 48" AFF. DROP SHOULD BE TERMINATED IN A MALE RJ45 AND INSTALLED WITHIN THE AV BOX (T1 OR T2). COORDINATE WITH AV AND ARCHITECTURAL DRAWINGS.



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NHC Government Center 7702-190810

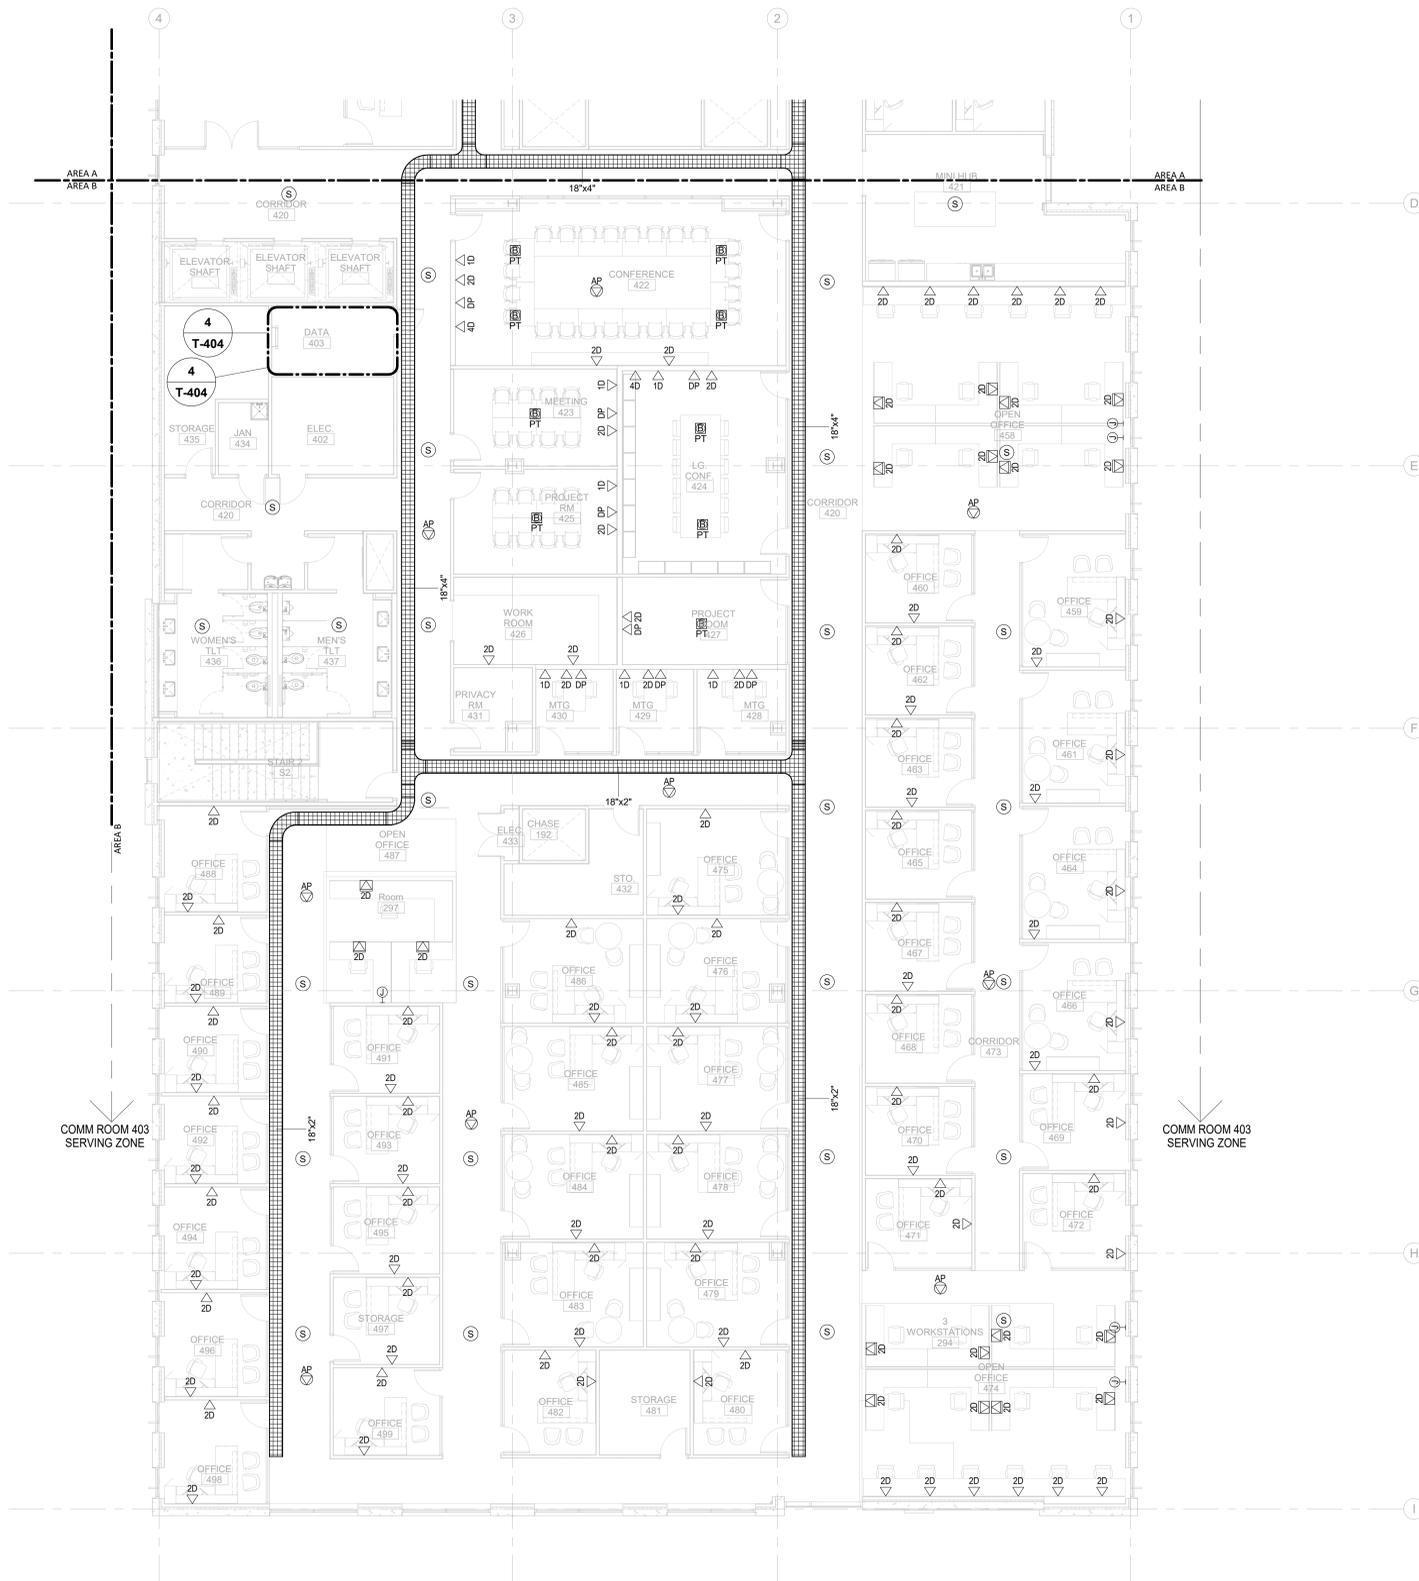
**NEW HANOVER COUNTY
GOVERNMENT CENTER**

GOVERNMENT CENTER DRIVE
WILMINGTON, NC 28403

LS3P PROJECT: 7702-190810

A	DATE	DESCRIPTION
A	2020.08.18	TI-SCHEMATIC DESIGN
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C	2020.12.16	GMP SET
D	2020.12.22	ADDENDUM #1
E	2021.01.08	ADDENDUM #2

KEY PLAN:

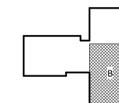

SHEET NAME:
TELECOM FLOOR
PLAN - LEVEL 4 - AREA
B

DATE: 2020.12.16

CURRENT: 2021.01.08

ADDENDUM #2

SHEET:

T-104B

GMP SET

Newcomb & Boyd
CONSULTANTS AND ENGINEERS
Consulting Engineering Group
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Suite 215
Durham, NC 27703
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Contact: Paul J. Kitchens
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Firm License No. F-0312



1/8" = 1'-0"

1
T-104B
TELECOM TI FLOOR PLAN - PARTIAL - LEVEL 4 - AREA B

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NHC Government Center 7702-190810

**NEW HANOVER COUNTY
GOVERNMENT CENTER**
GOVERNMENT CENTER DRIVE
WILMINGTON, NC 28403

LS3P PROJECT: 7702-190810

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A	2020.08.18	TI- SCHEMATIC DESIGN
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C	2020.12.16	GMP SET
D	2020.12.22	ADDENDUM #1
E	2021.01.08	ADDENDUM #2

SHEET NAME:
TELECOM - 911 EQUIP.
& SERVER ROOM
PART PLANS

DATE: 2020.12.16
CURRENT: 2021.01.08
ADDENDUM #2

SHEET:
T-401

GMP SET


Newcomb & Boyd
CONSULTANTS AND ENGINEERS
Consulting Engineering Group
5425 Page Rd
Suite 215
Durham, NC 27703
T 919 783-7812
Contact: Paul J. Kitchens
N&B PROJECT: 19N342
Firm License No. F-0312

GENERAL NOTES (THIS SHEET ONLY)


1. AT ALL VERTICAL SLEEVE LOCATIONS, FURNISH AND INSTALL 24"W CABLE RUNWAY MOUNTED VERTICALLY TO ALLOW FOR PROPER SUPPORT OF CABLES TO FLOOR BELOW.

KEYNOTES (THIS SHEET ONLY)

- 1) 0.75" PLYWOOD BACKBOARD, FIRE RATED
- 2) 18"W CABLE RUNWAY
- 3) (6) 4" FIRESTOPPED SLEEVES FOR HORIZONTAL DISTRIBUTION
- 4) (4) 4" FIRESTOPPED SLEEVES FOR HORIZONTAL DISTRIBUTION
- 5) SECURITY PANEL BY OWNER'S SECURITY INTEGRATOR
- 6) (6) 4" CONDUITS FROM SERVER ROOM TO FLOOR BELOW FOR LEVEL 1 HORIZONTAL DISTRIBUTION
- 7) UNDERGROUND CONDUITS PATHWAY FROM FIRST FLOOR. (6) 4" CONDUITS FOR SERVICE PROVIDER FIBER.
- (2) 4" CONDUITS FOR FIBER REDUNDANCY TO TOWER AREA. SEE TELECOM SITE PLAN FOR DETAILS. FOR REFERENCE ONLY. FURNISHED AND INSTALLED BY TOWER PROVIDER.
- 8) TELECOMMUNICATION GROUNDING BAR
- 9) CABINET INSTALLED BY FURNISHED BY AT&T.

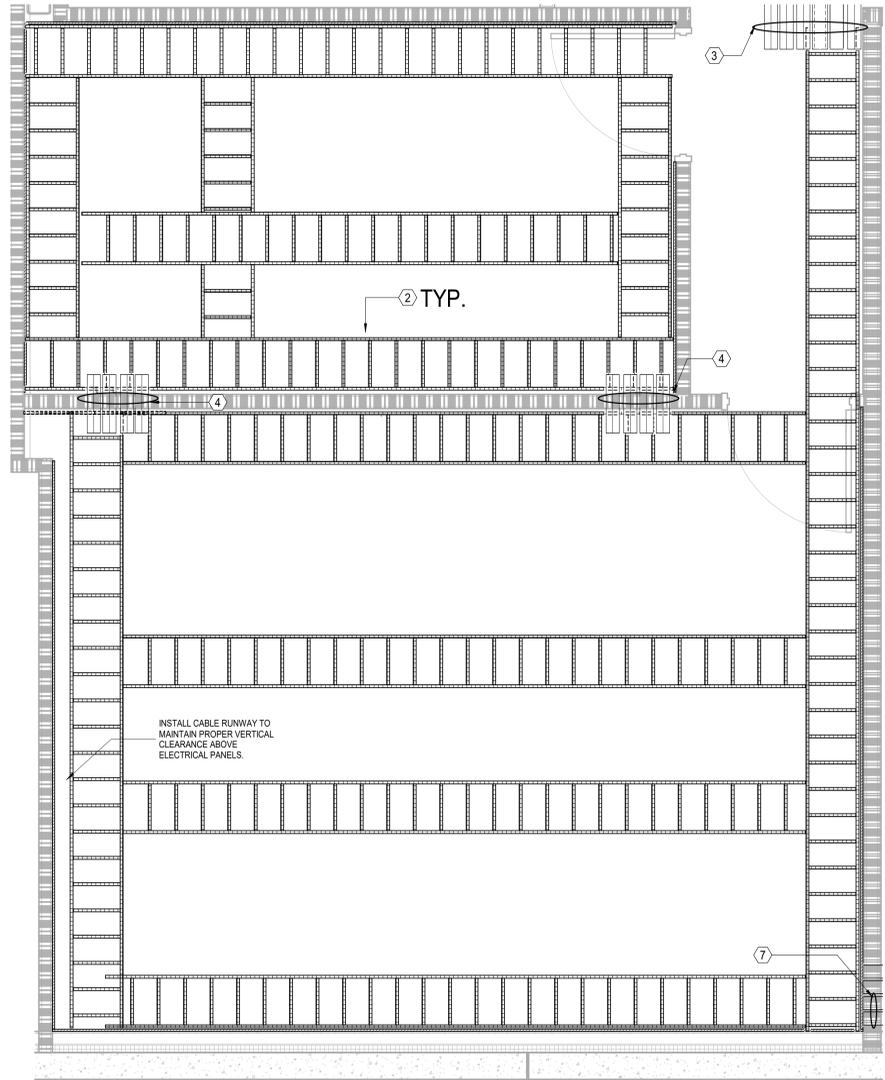

2
T-401 TELECOM - 911 EQUIP. & SERVER ROOM PART PLANS - ABOVE 7' 6" 1/2" = 1'-0"

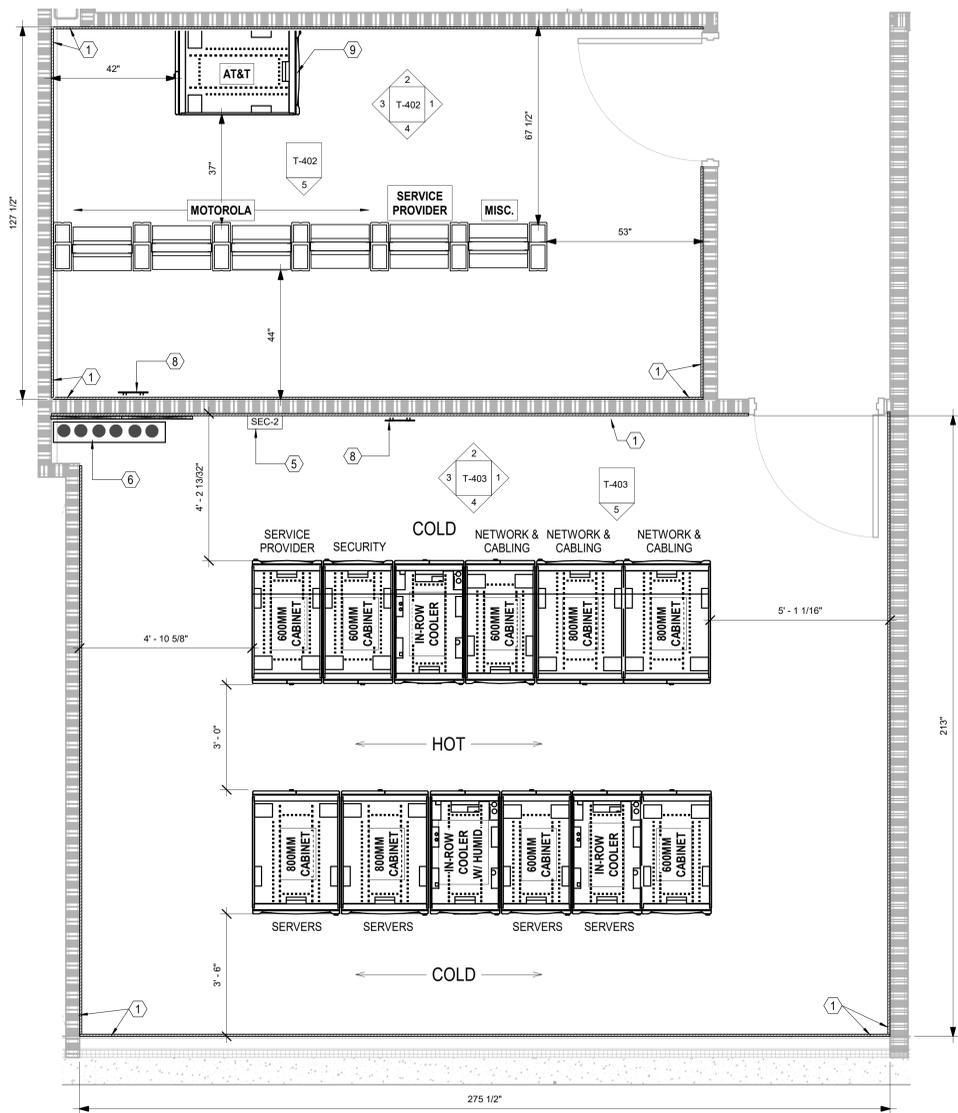

1
T-401 TELECOM - 911 EQUIP. & SERVER ROOM PART PLANS - BELOW 7' 6" 1/2" = 1'-0"

SERVER ROOM EQUIPMENT

SERVER ROOM EQUIPMENT PROVIDED AS PART OF CUSTOMIZED SOLUTION THAT INCLUDES CABINETS, TERMINATION ACCESSORIES, CABLE MANAGEMENT, HOT AISLE CONTAINMENT, UPS AND BATTERY CABINET AS WELL AS OTHER HARDWARE AND ACCESSORIES. APC QUOTE/PART NUMBER ISX0001852536-0005

SOLUTION NUMBER : ISX0001852536-0005
DESIGN NAME : ISXD DESIGN 1
DESIGN NOTES FOR ISXD DESIGN 1

FOR MORE INFORMATION SEE BOM MATERIALS FILE INCLUDED WITH THE TELECOM DRAAWINGS OR/AND CONTACT APC REPRESENTATIVE :
JIMMY JACK - TEL: 803 833 3046
JJACK@CRITICALCOMPONENTS.NET

1/7/2021 3:02:13 PM



CAPE FEAR FD STONEWATER



101 NORTH THIRD STREET, SUITE 500
WILMINGTON, NORTH CAROLINA 28401
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NHC Government Center 7702-190810

NEW HANOVER COUNTY
GOVERNMENT CENTER
GOVERNMENT CENTER DRIVE
WILMINGTON, NC 28403
LS3P PROJECT: 7702-190810

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A	2020.08.18	TI- SCHEMATIC DESIGN
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C	2020.12.16	GMP SET
D	2020.12.22	ADDENDUM #1
E	2021.01.08	ADDENDUM #2

SHEET NAME:
**TELECOM - 911
EQUIPMENT ROOM
ELEVATIONS**

DATE: 2020.12.16
CURRENT: 2021.01.08
ADDENDUM #2


SHEET:
T-402

GMP SET


Newcomb & Boyd
CONSULTANTS AND ENGINEERS
Consulting Engineering Group
5425 Page Rd
Suite 215
Durham, NC 27703
T 919 783-7812
Contact: Paul J. Kitchens
N&B PROJECT: 19N342
Firm License No. F-0312

KEYNOTES (THIS SHEET ONLY)


- ① 0.75" PLYWOOD BACKBOARD, FIRE RATED
- ② 18"W CABLE RUNWAY
- ③ (4) 4" FIRESTOPPED SLEEVES FOR HORIZONTAL DISTRIBUTION
- ④ TELECOMMUNICATION GROUNDING BAR
- ⑤ 2RU WIRE MANAGER
- ⑥ 48 PORT PATCH PANEL FOR MOTOROLA CABLES HORIZONTAL DISTRIBUTION

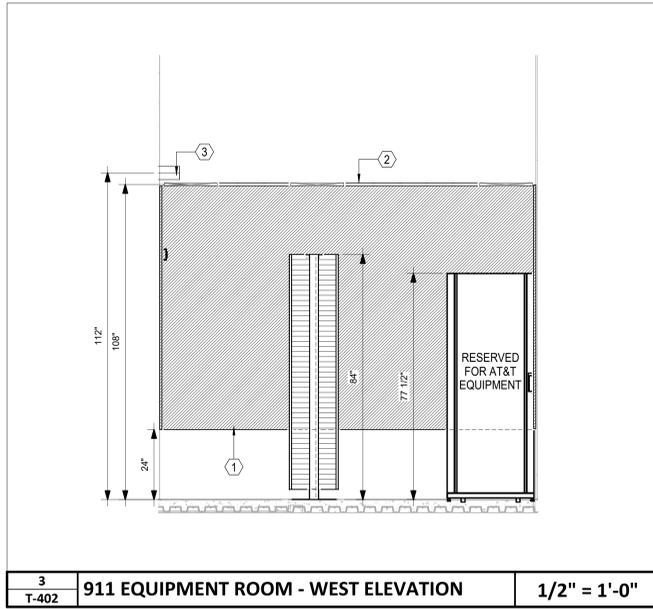


3 T-402 911 EQUIPMENT ROOM - WEST ELEVATION 1/2" = 1'-0"

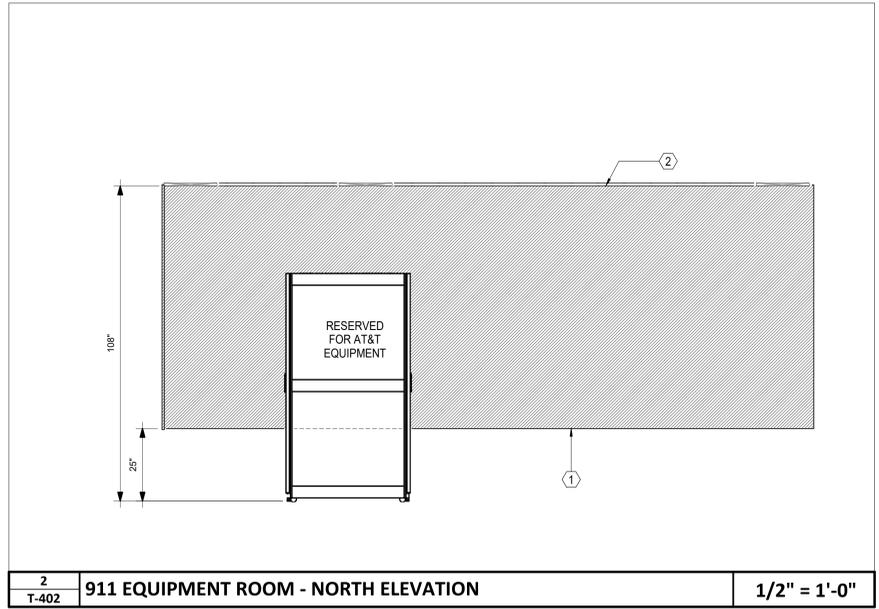


2 T-402 911 EQUIPMENT ROOM - NORTH ELEVATION 1/2" = 1'-0"

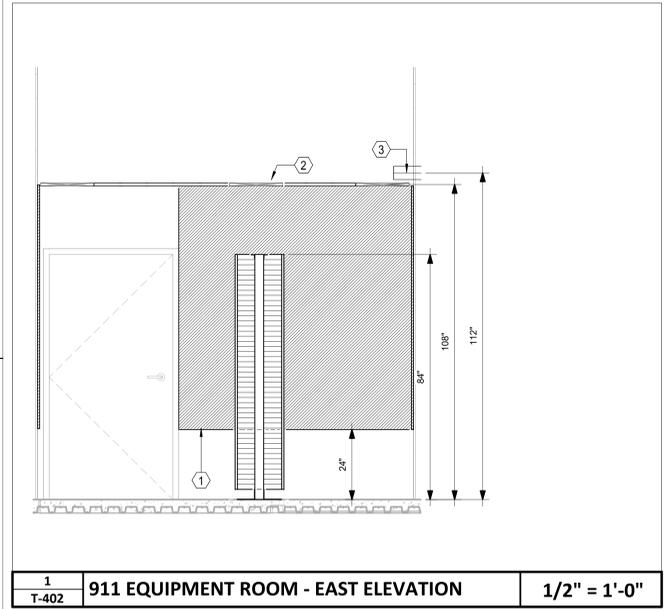

1 T-402 911 EQUIPMENT ROOM - EAST ELEVATION 1/2" = 1'-0"

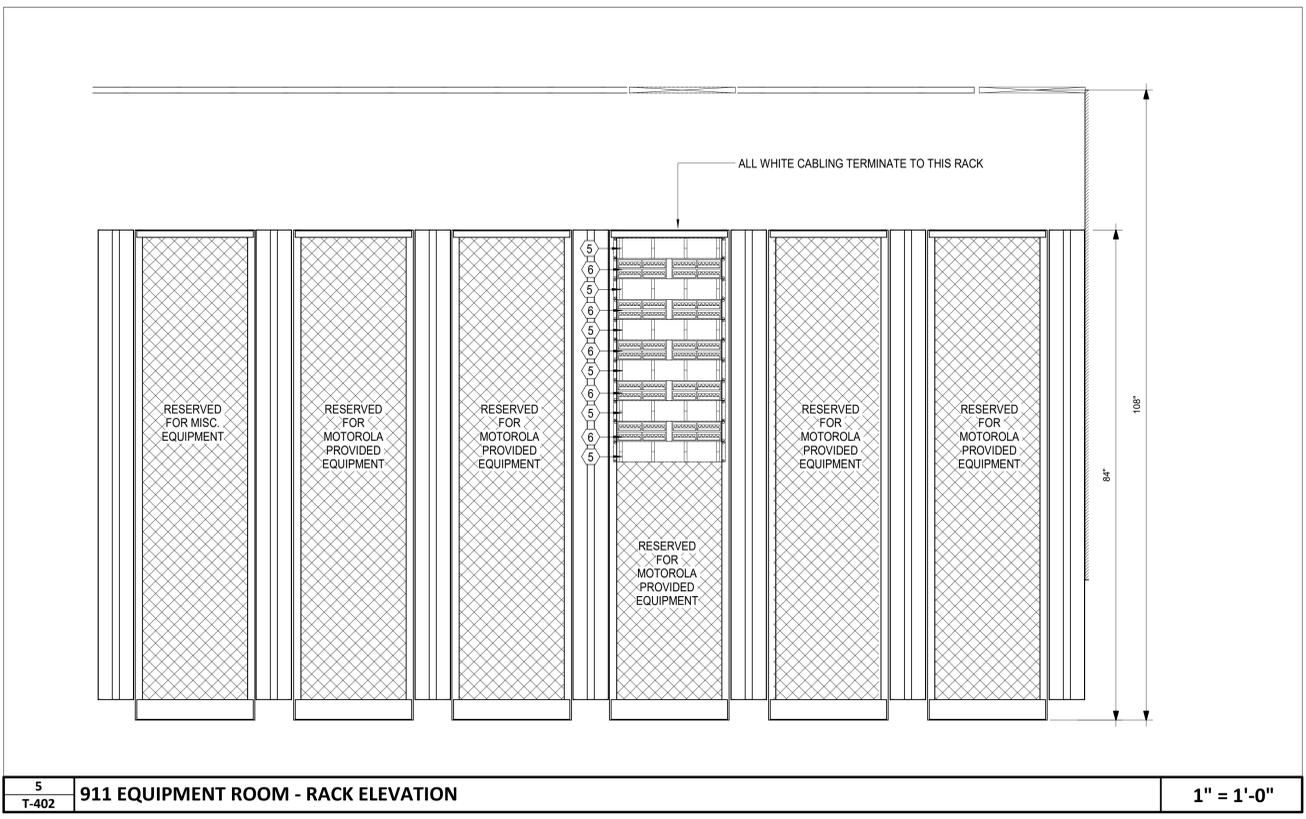

5 T-402 911 EQUIPMENT ROOM - RACK ELEVATION 1" = 1'-0"

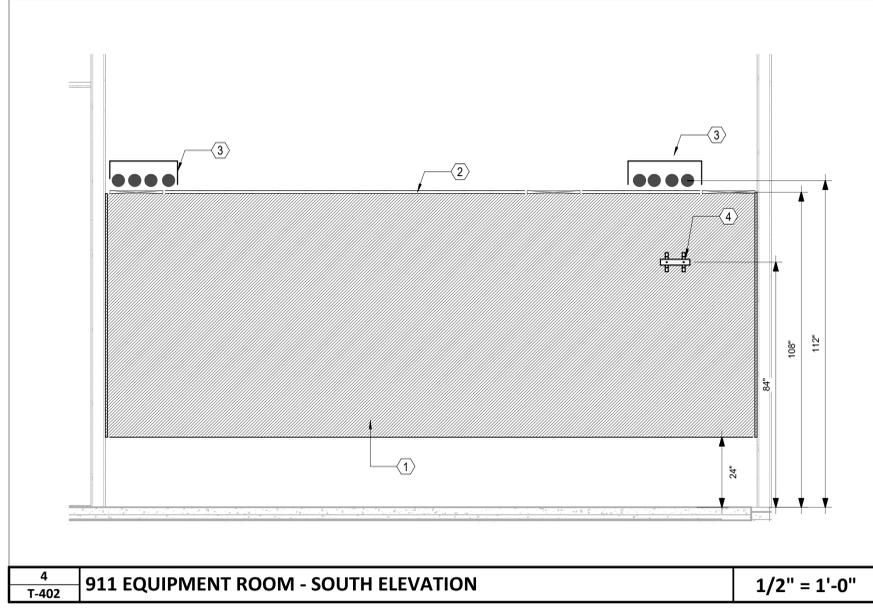

4 T-402 911 EQUIPMENT ROOM - SOUTH ELEVATION 1/2" = 1'-0"



E
D
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1 2 3 4 5 6



1/7/2021 3:02:19 PM

THE USER SHALL VERIFY ALL DIMENSIONS AND CONDITIONS BEFORE CONSTRUCTION.


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GENERAL NOTES (THIS SHEET ONLY)

1. AT ALL VERTICAL SLEEVE LOCATIONS, FURNISH AND INSTALL 24" W CABLE RUNWAY MOUNTED VERTICALLY TO ALLOW FOR PROPER SUPPORT OF CABLES.

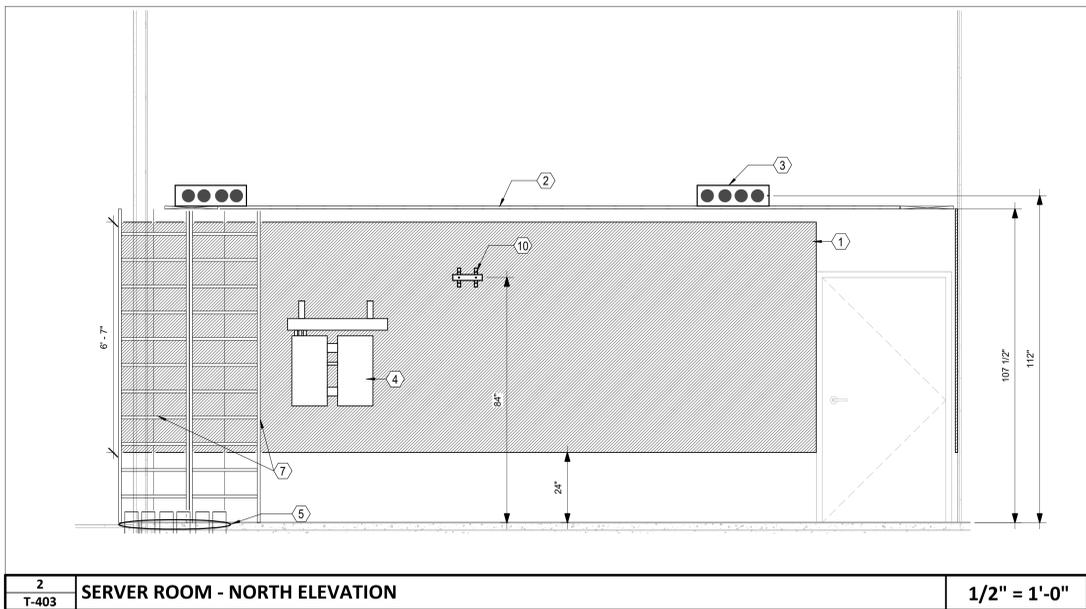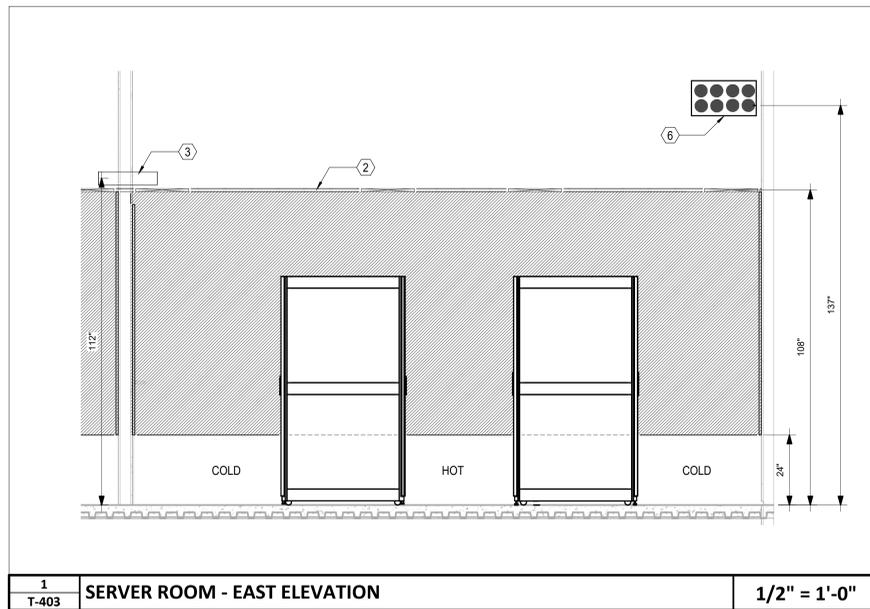KEYNOTES (THIS SHEET ONLY)

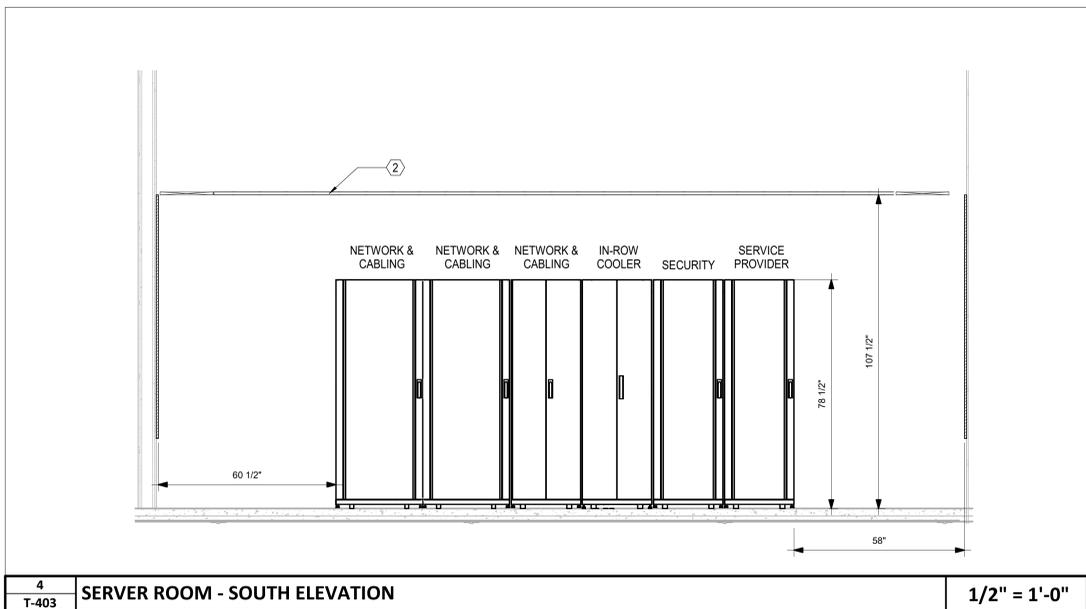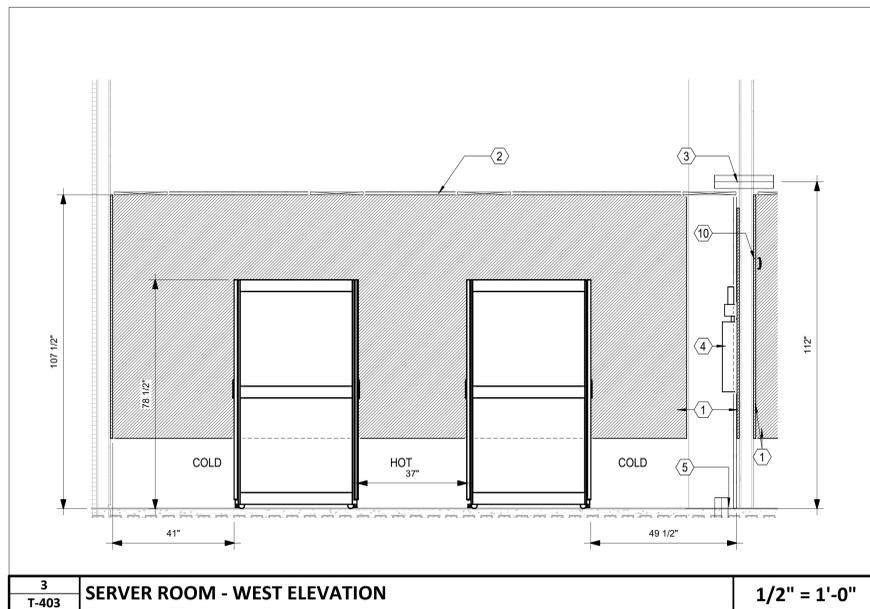- 1 0.75" PLYWOOD BACKBOARD, FIRE RATED, FIRE RATED
- 2 18"W CABLE RUNWAY
- 3 (4) 4" FIRESTOPPED SLEEVES
- 4 SECURITY PANEL BY OWNER'S SECURITY INTEGRATOR
- 5 (6) 4" CONDUITS FROM SERVER ROOM TO FLOOR BELOW FOR LEVEL 1 HORIZONTAL DISTRIBUTION
- 6 UNDERGROUND CONDUITS PATHWAY FROM FIRST FLOOR. (6) 4" CONDUITS FOR SERVICE PROVIDER FIBER. (2) 4" CONDUITS FOR FIBER REDUNDANCY TO TOWER AREA. SEE TELECOM SITE PLAN FOR DETAILS.
- 7 24" W VERTICAL CABLE RUNWAY
- 8 2RU WIRE MANAGER
- 9 48 PORT PATCH PANEL FOR HORIZONTAL DISTRIBUTION
- 10 TELECOMMUNICATION GROUNDING BAR
- 11 48 PORT PATCH PANEL FOR CAT6A WIRELESS ACCESS POINT CABLES HORIZONTAL DISTRIBUTION

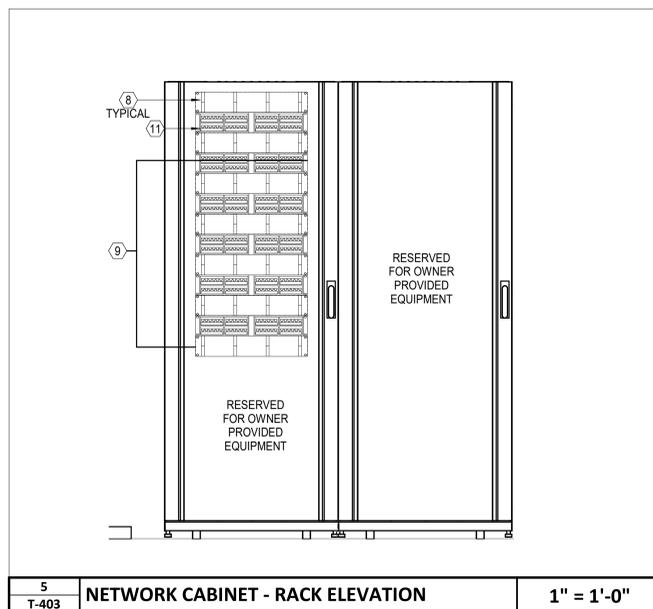

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NHC Government Center 7702-190810

**NEW HANOVER COUNTY
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GOVERNMENT CENTER DRIVE
WILMINGTON, NC 28403
LS3P PROJECT: 7702-190810

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D	2020.12.22	ADDENDUM #1
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SHEET NAME:
**TELECOM - SERVER
ROOM ELEVATIONS**

DATE: 2020.12.16
CURRENT: 2021.01.08

ADDENDUM #2

SHEET:


T-403

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5425 Page Rd
Suite 215
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T 919 783-7812
Contact: Paul J. Kitchens
N&B PROJECT: 19N342
Firm License No. F-0312


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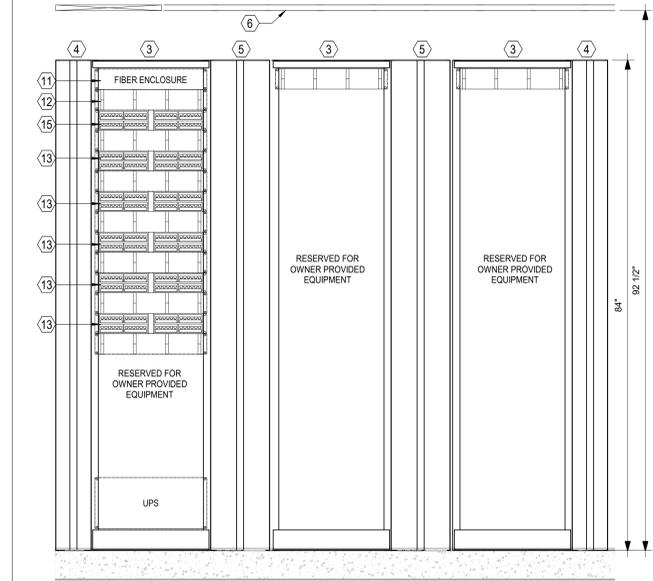
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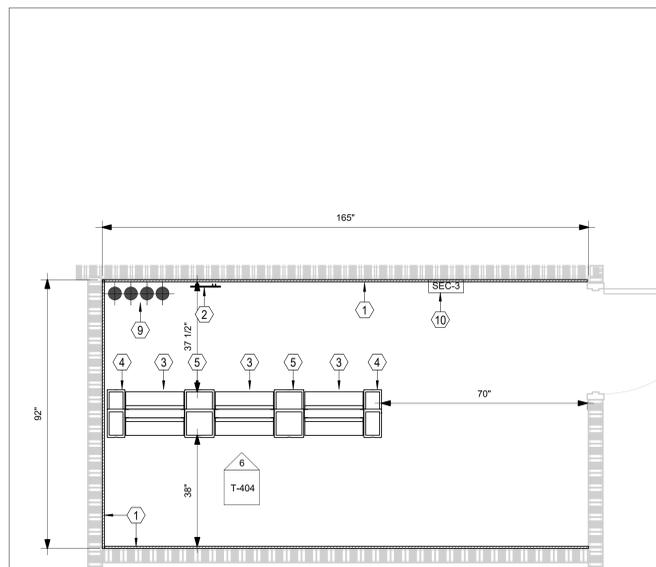
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T-404 LEVEL 2 COMM ROOM 203 PART PLAN - BELOW 7' 6 1/2" = 1'-0"




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T-404 LEVEL 2 COMM ROOM 203 PART PLAN - ABOVE 7' 6 1/2" = 1'-0"

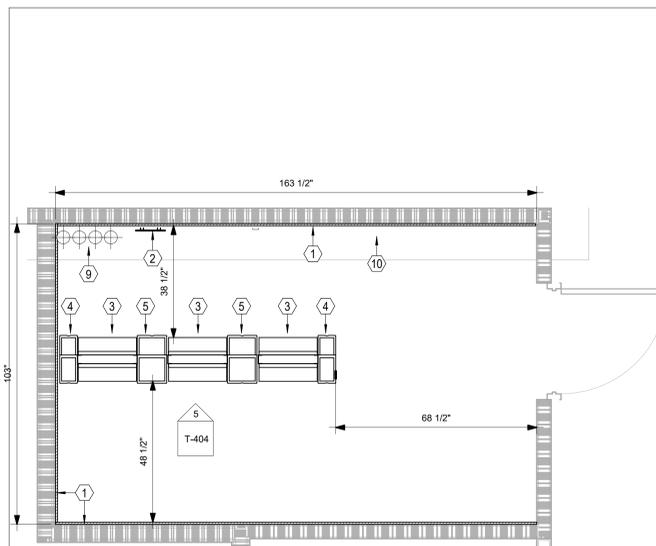


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T-404 LEVEL 2 COMM ROOM 203 - RACK ELEVATION 1" = 1'-0"

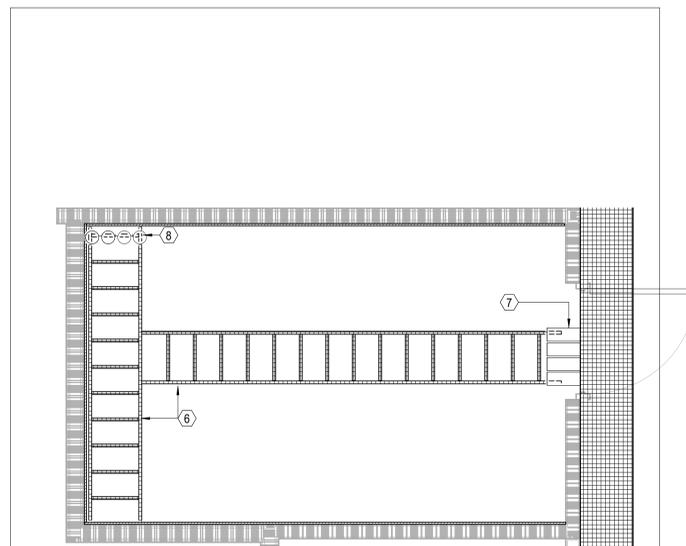

3
T-404 LEVEL 1, 3 & 4 COMM ROOM PART PLAN - BELOW 7' 6 1/2" = 1'-0"

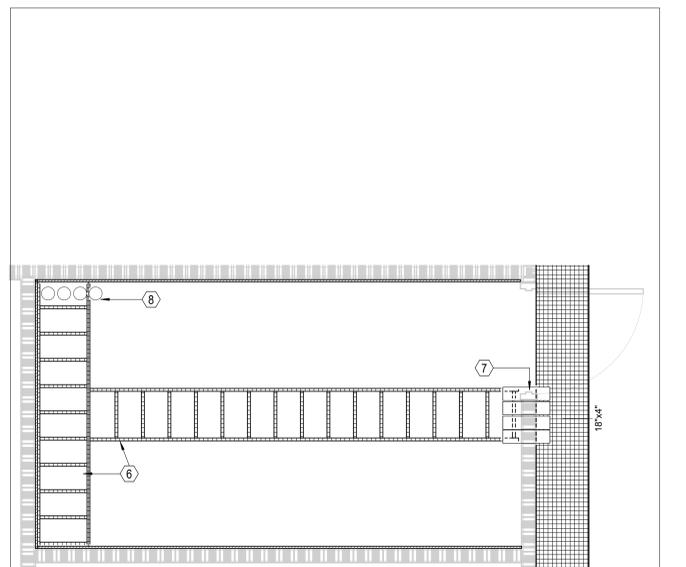

4
T-404 LEVEL 1, 3 & 4 COMM ROOM PART PLAN - ABOVE 7' 6 1/2" = 1'-0"

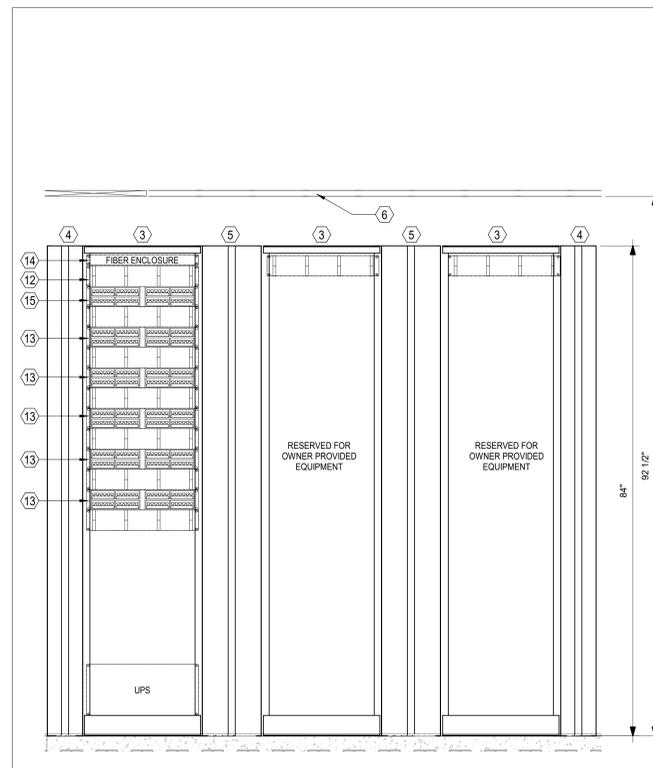

6
T-404 LEVEL 1, 3 & 4 COMM ROOM - RACK ELEVATION 1" = 1'-0"

GENERAL NOTES (THIS SHEET ONLY)

- AT ALL VERTICAL SLEEVE LOCATIONS, FURNISH AND INSTALL 12"W CABLE RUNWAY MOUNTED VERTICALLY TO ALLOW FOR PROPER SUPPORT OF CABLES.

KEYNOTES (THIS SHEET ONLY)

- 0.75" PLYWOOD BACKBOARD, FIRE RATED FIRE RATED
- TELECOMMUNICATIONS GROUNDING BAR
- 2-POST EQUIPMENT RACK
- 6" VERTICAL WIRE MANAGER
- 10" VERTICAL WIRE MANAGER
- 18"W CABLE RUNWAY
- (4) 4" FIRESTOPPED SLEEVES
- 4" FIRESTOPPED SLEEVES TO COMM ROOM ABOVE
- 4" FIRESTOPPED SLEEVES TO COMM ROOM BELOW
- SECURITY PANEL BY OWNER'S SECURITY INTEGRATOR
- 2RU FIBER PATCH PANEL FOR 72 STRAND SINGLEMODE FIBER FROM SERVER 206 TO PROVIDE 12 STRAND
- SINGLEMODE TO COMM ROOM 103, 303 AND 403, 2RU WIRE MANAGER (TYPICAL)
- 48 PORT PATCH PANEL FOR HORIZONTAL DISTRIBUTION
- 1RU FIBER PATCH PANEL FOR 12 STRAND SINGLEMODE FIBER FROM COMM ROOM 203
- 48 PORT PATCH PANEL FOR CAT6A WIRELESS ACCESS POINT CABLES HORIZONTAL DISTRIBUTION



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LS3P PROJECT: 7702-190810

DATE	DESCRIPTION
A 2020.08.18	TI- SCHEMATIC DESIGN
B 2020.10.16	TI- DESIGN DEVELOPMENT
C 2020.12.16	GMP SET
E 2021.01.08	ADDENDUM #2

SHEET NAME:
 TELECOM - COMM
 ROOM PART PLANS

DATE: 2020.12.16
 CURRENT: 2021.01.08

ADDENDUM #2

SHEET:

T-404

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C	2020.12.16	GMP SET
E	2021.01.08	ADDENDUM #2

SHEET NAME:
TELECOM RISER
DIAGRAM

DATE: 2020.12.16
CURRENT: 2021.01.08

ADDENDUM #2


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T-601

GMP SET


GOVERNMENT CENTER

ROOF

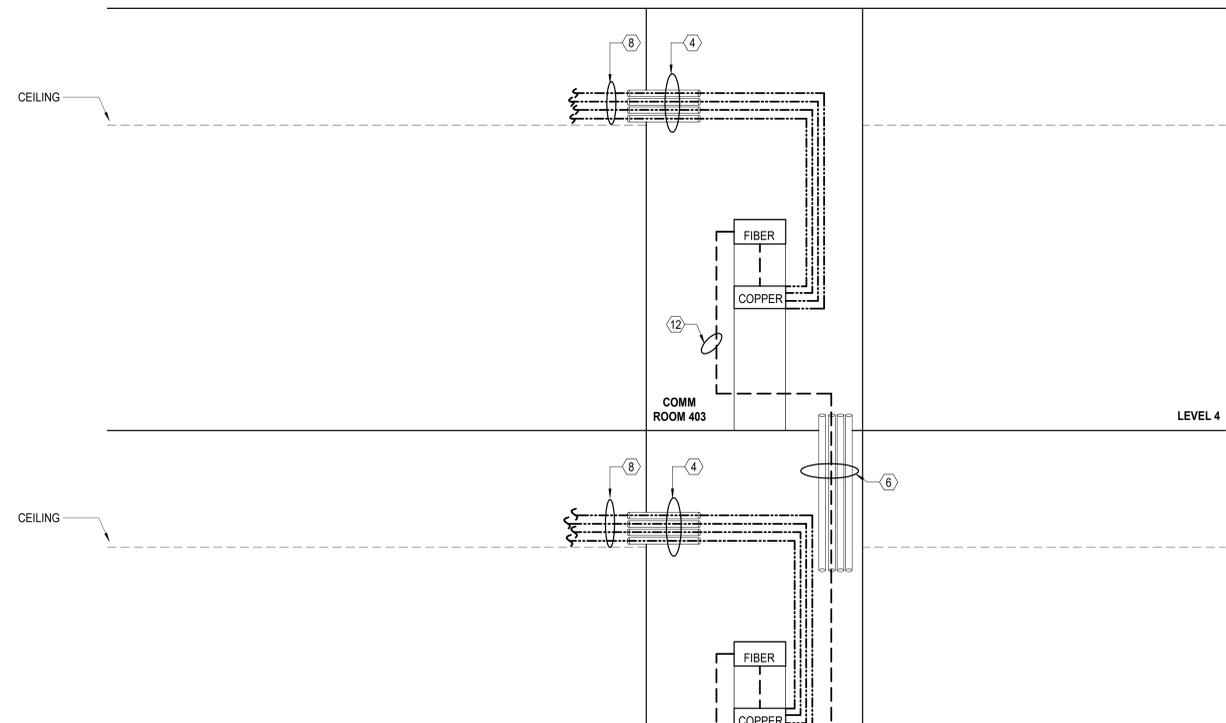

EOC 911 CENTER

EOC ROOF

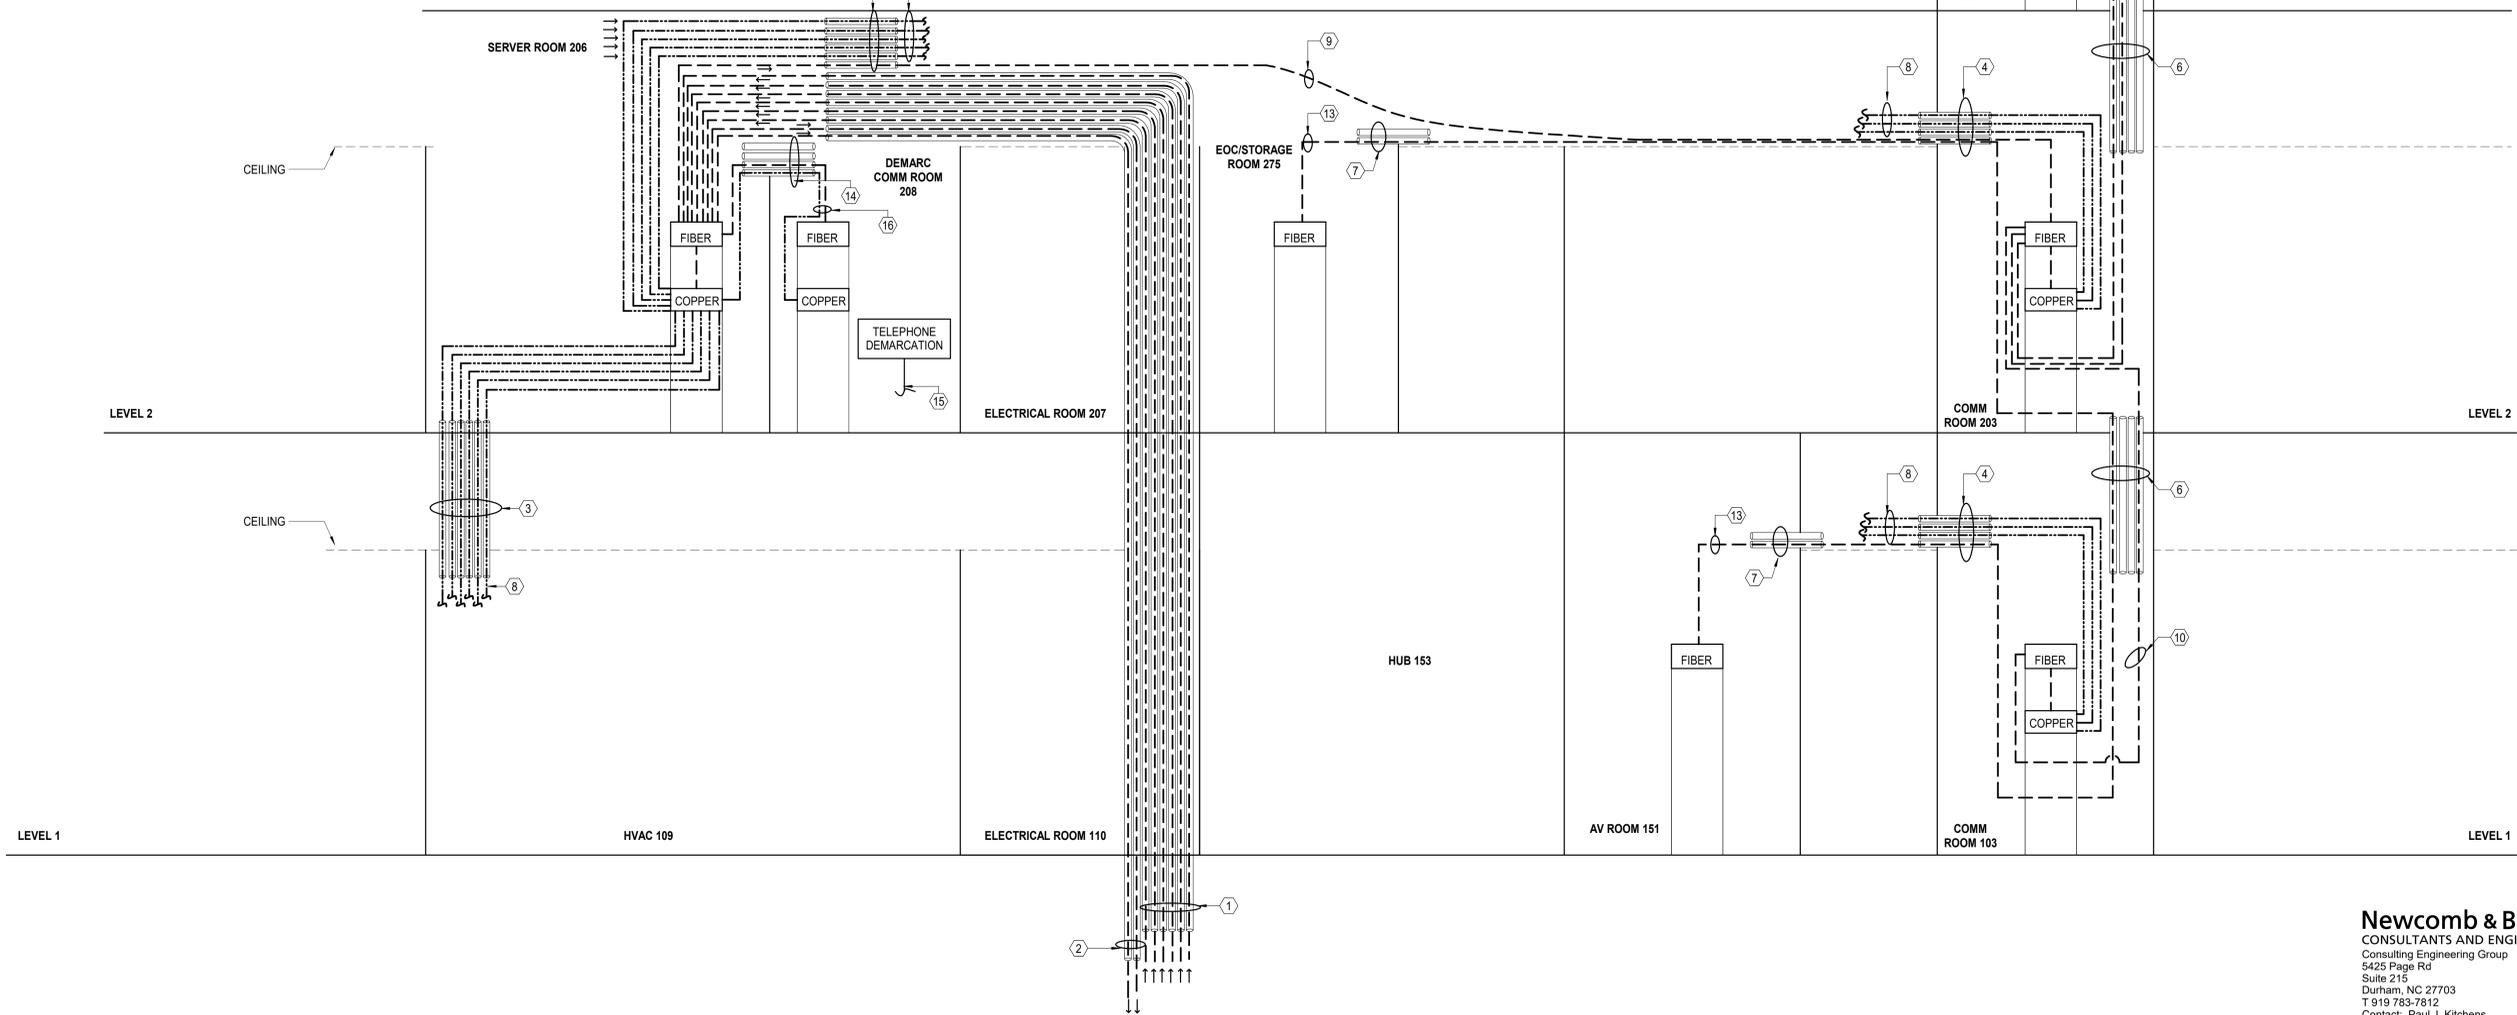

GENERAL NOTES (THIS SHEET ONLY)

1. AT ALL VERTICAL SLEEVE LOCATIONS, FURNISH AND INSTALL 12"W CABLE RUNWAY MOUNTED VERTICALLY TO ALLOW FOR PROPER SUPPORT OF CABLES.

KEYNOTES (THIS SHEET ONLY)

- 1 (6) 4" CONDUITS FOR SERVICE PROVIDER FIBER TO EXISTING MANHOLES. CONTRACTOR MUST VERIFY AND COORDINATE EXACT LOCATIONS. SEE TELECOM SITE PLAN FOR DETAILS.
- 2 (2) 4" CONDUITS FOR FIBER REDUNDANCY FROM SERVER ROOM 206 TO TOWER AREA. FOR REFERENCE ONLY. TOWER CONDUITS FURNISHED AND INSTALLED BY TOWER PROVIDER.
- 3 (6) 4" CONDUITS FROM SERVER ROOM 206 TO FLOOR BELOW FOR LEVEL 1 HORIZONTAL DISTRIBUTION CABLES VIA HVAC ROOM 109 CEILING TO BASKET TRAY IN CORRIDOR 178
- 4 (4) 4" FIRESTOPPED SLEEVES FOR HORIZONTAL DISTRIBUTION
- 5 (6) 4" FIRESTOPPED SLEEVES FOR HORIZONTAL DISTRIBUTION
- 6 (4) 4" FIRESTOPPED SLEEVES TO COMM ROOM ABOVE
- 7 AUDIOVISUAL FIRESTOPPED SLEEVES BY OTHERS. SEE AUDIOVISUAL DRAWINGS FOR DETAILS.
- 8 HORIZONTAL DISTRIBUTION CABLES (TYPICAL)
- 9 72 STRAND OM4 MULTIMODE FIBER FROM SERVER ROOM 206 TO COMM ROOM 203
- 10 12 STRAND OM4 MULTIMODE FIBER FROM COMM 203 TO FLOOR BELOW TO COMM 103.
- 11 12 STRAND OM4 MULTIMODE FIBER FROM COMM 203 TO FLOOR ABOVE TO COMM ROOM 303.
- 12 12 STRAND OM4 MULTIMODE FIBER FROM COMM 203 TO FLOOR ABOVE TO COMM ROOM 403.
- 13 12 STRAND OM4 MULTIMODE FIBER FROM AV ROOM SERVER ROOM 151 TO EOC/STORAGE ROOM 275. SEE AV DRAWINGS FOR DETAILS.
- 14 (8) 4" FIRESTOPPED SLEEVES FOR HORIZONTAL DISTRIBUTION FROM DEMARC ROOM 208 TO SERVER ROOM 206
- 15 TELEPHONE SERVICE PROVIDER CABLING. COORDINATE WITH SERVICE PROVIDER AND OWNER.
- 16 SERVICE PROVIDER CABLING. COORDINATE WITH SERVICE PROVIDER AND BUILDING OWNER PRIOR TO ORDERING.

THE NEW HANOVER COUNTY, NORTH CAROLINA, IS A MEMBER OF THE UNITED STATES OF AMERICA.

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B	2020.10.16	TI- DESIGN DEVELOPMENT
C	2020.12.16	GMP SET
E	2021.01.08	ADDENDUM #2

SHEET NAME:
TELECOM
GROUNDING RISER
DIAGRAM

DATE: 2020.12.16
CURRENT: 2021.01.08


ADDENDUM #2

SHEET:
T-602

GMP SET


GOVERNMENT CENTER

ROOF

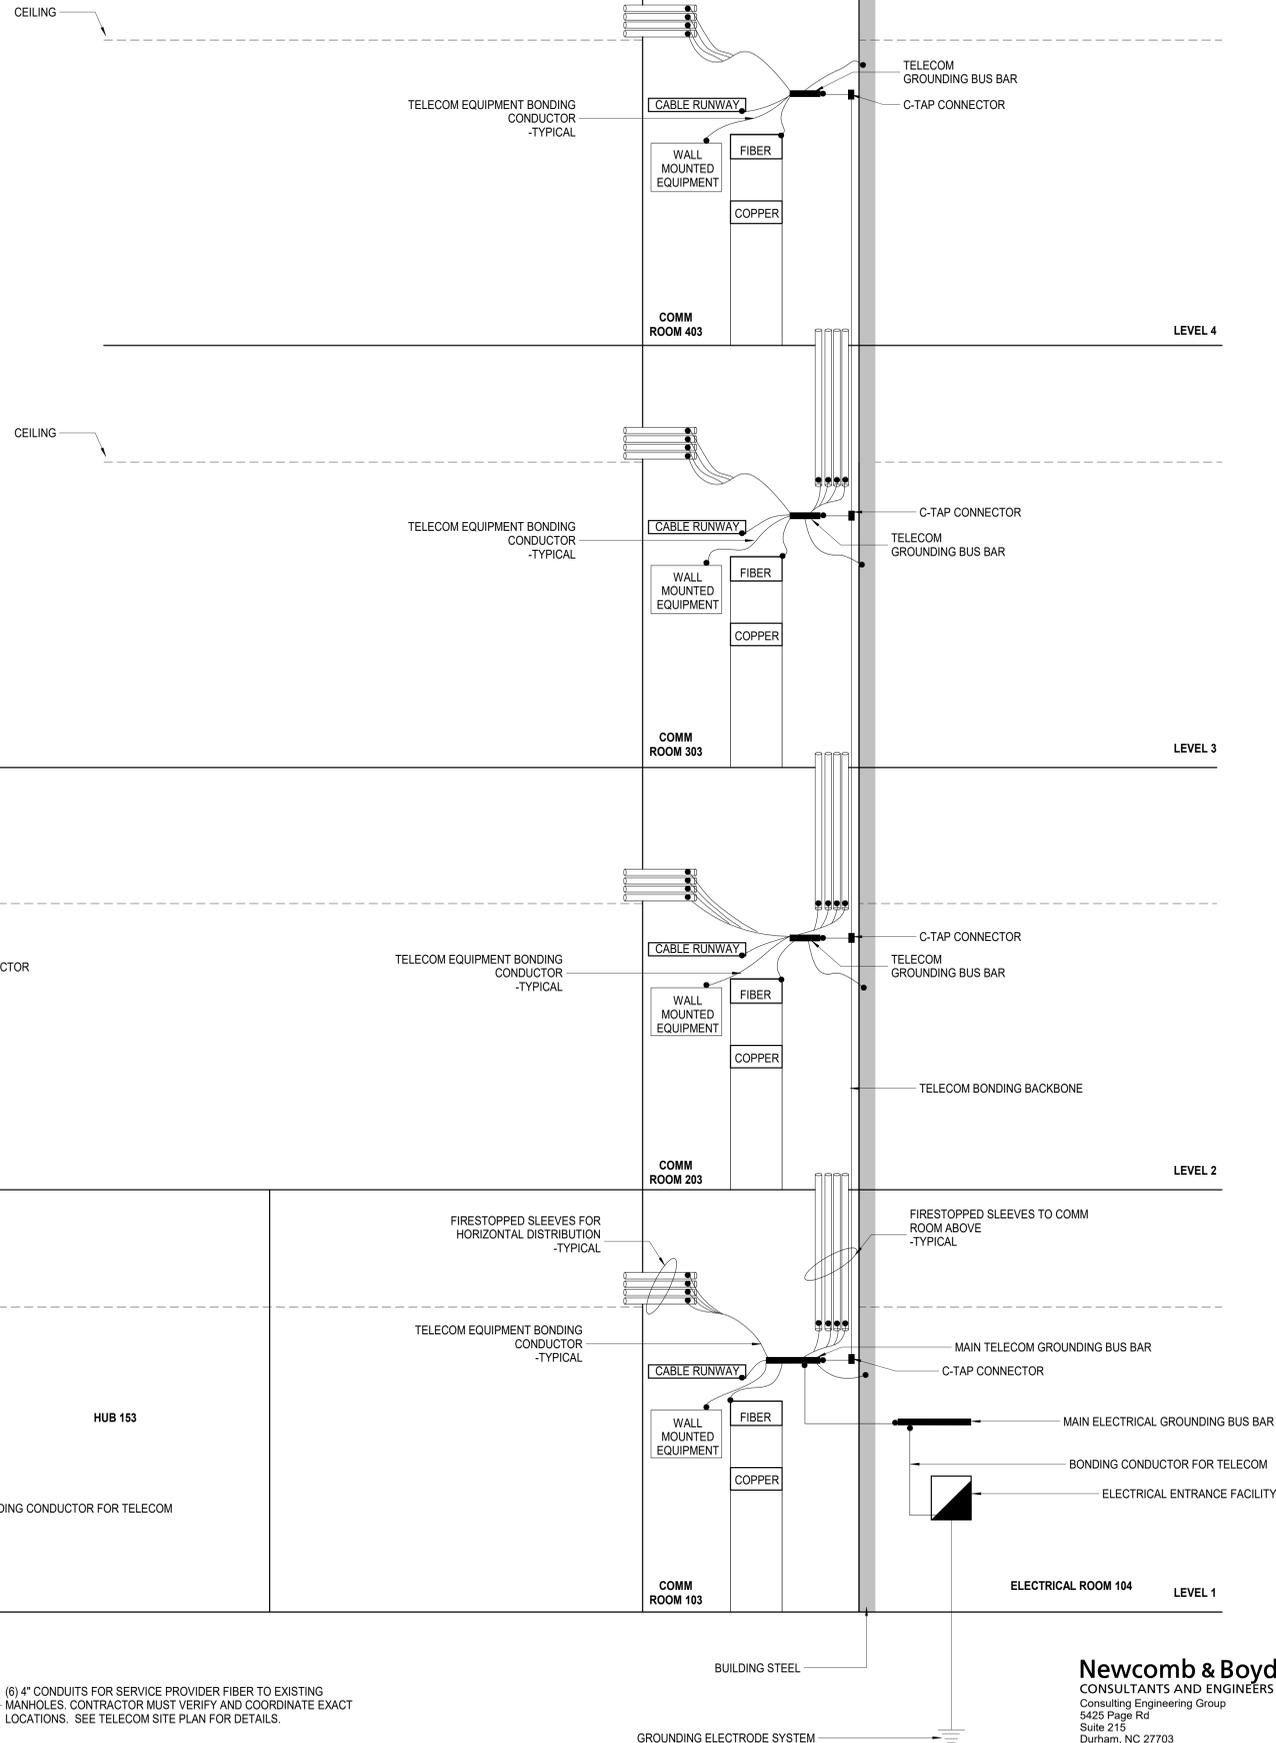

EOC 911 CENTER

EOC ROOF

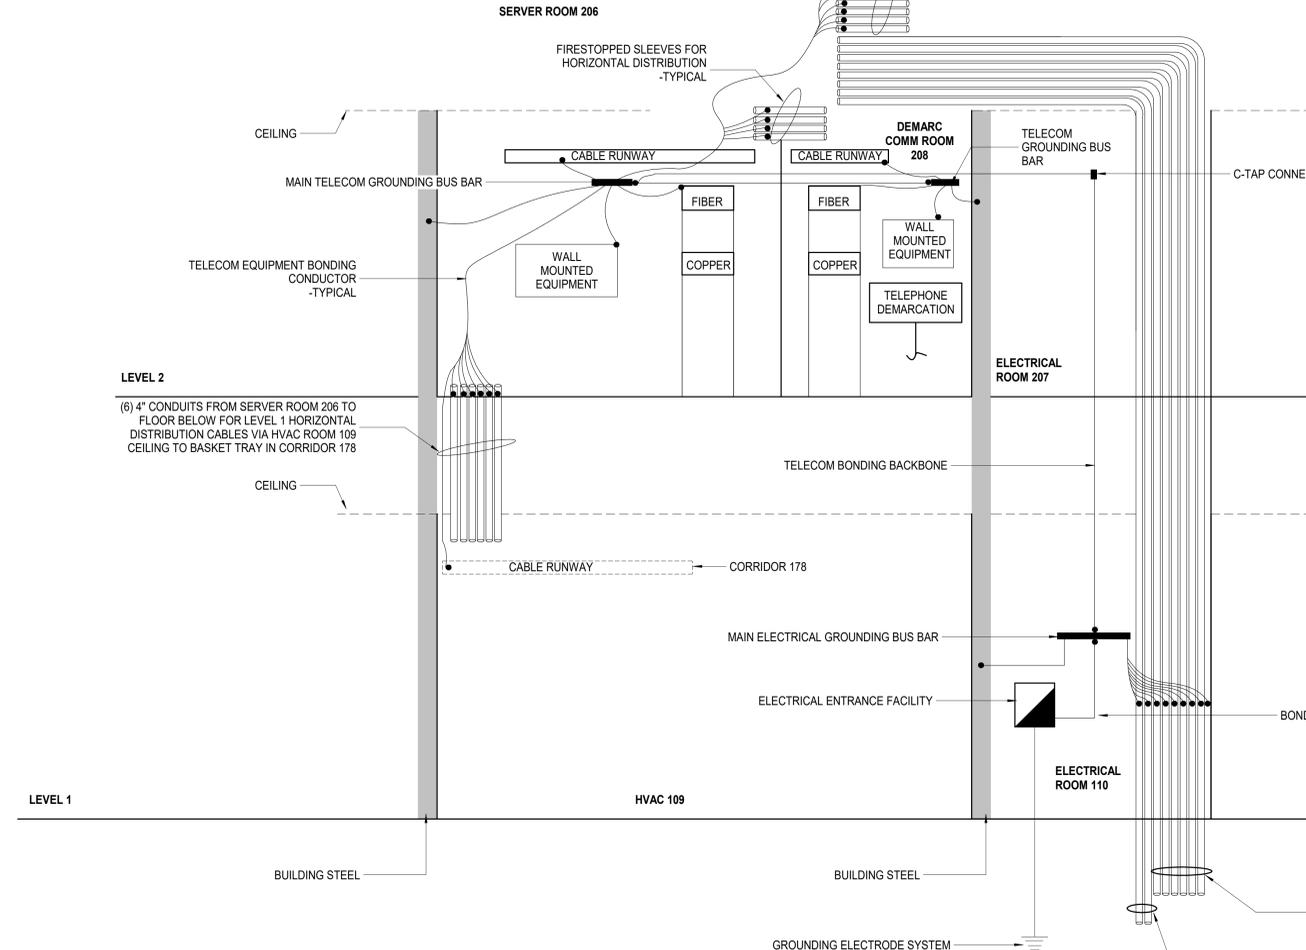

- GENERAL NOTES:
1. CONNECT TELECOM BUS BAR TO ELECTRICAL PRIMARY BONDING BUSBAR WITH IRREVERSIBLE BOND. SEE ELECTRICAL PLANS FOR ADDITIONAL INFORMATION. COORDINATE WITH ELECTRICAL DRAWINGS.
 2. SEE T-502 DETAIL 4 FOR MORE DETAILS.

1
T-602
TELECOM GROUNDING RISER DIAGRAM (DIAGRAMMATIC)

1/7/2021 3:02:45 PM

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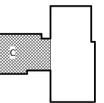
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LS3P PROJECT: 7702-190810

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A	2020.08.18	TI-SCHEMATIC DESIGN
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C	2020.12.16	GMP SET
D	2020.12.22	ADDENDUM #1
E	2021.01.08	ADDENDUM #2

KEY PLAN:



SHEET NAME:
AUDIO VISUAL FLOOR
PLAN - LEVEL 2 - AREA
C


DATE: 2020.12.16
CURRENT: 2021.01.08

ADDENDUM #2

SHEET:

AV-102C

GMP SET

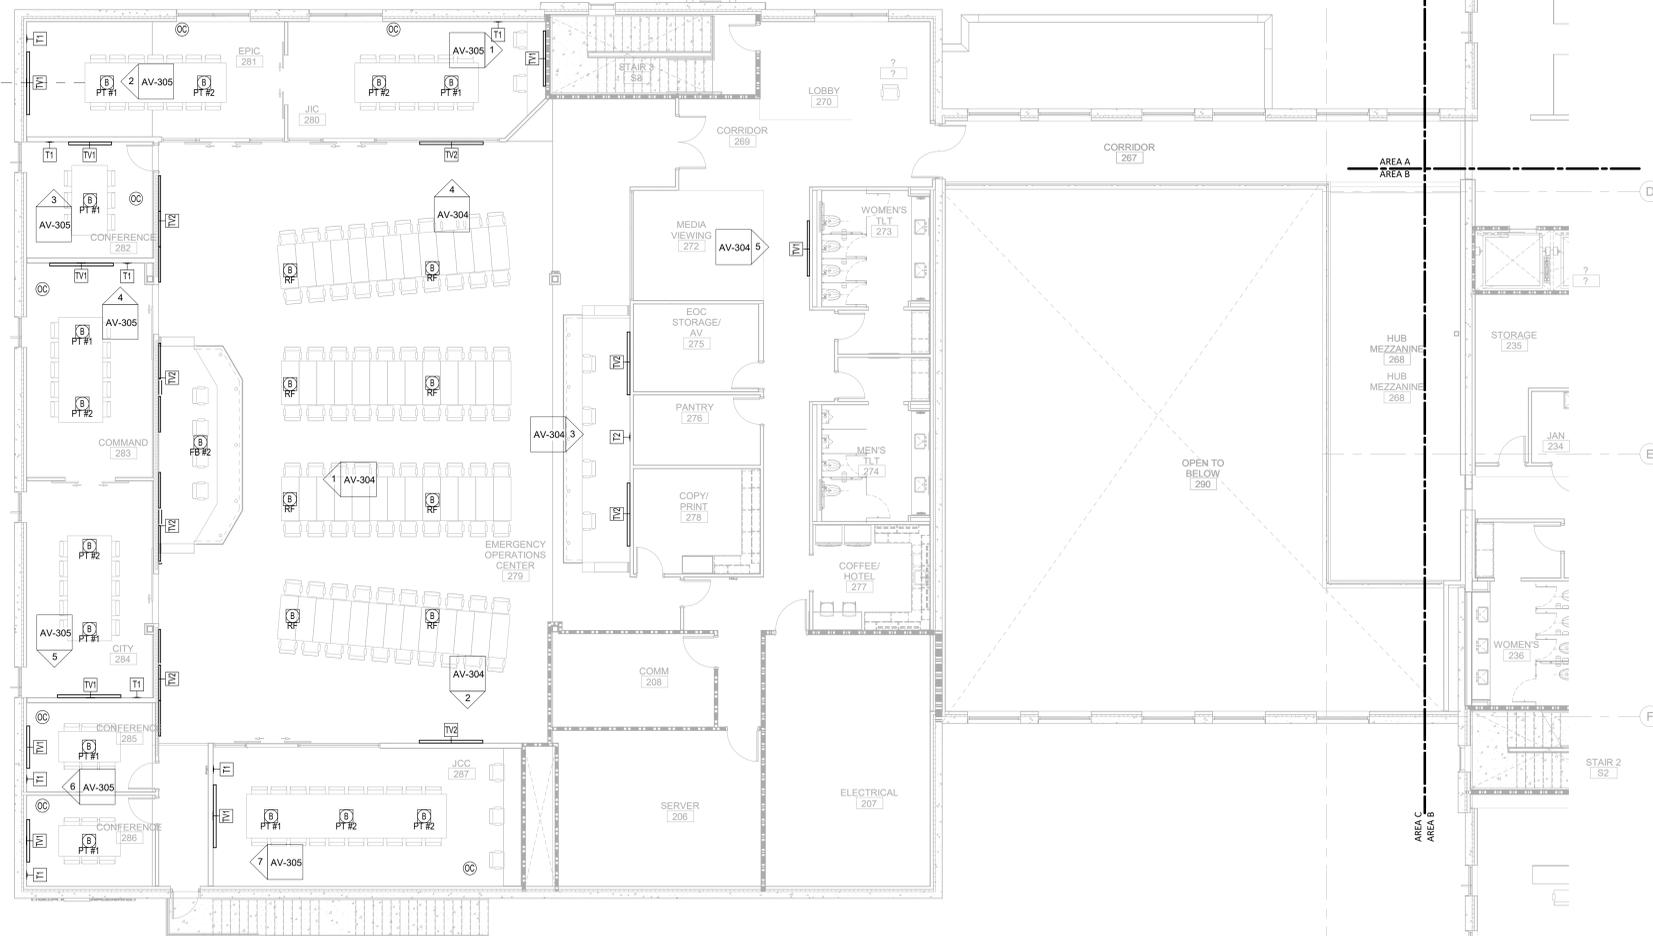

THE USER ASSUMES ALL RESPONSIBILITY FOR THE ACCURACY OF THE INFORMATION SHOWN ON THIS DRAWING.

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D


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1 AV-102C AUDIO VISUAL TI FLOOR PLAN - PARTIAL - LEVEL 2 - AREA C



1/8" = 1'-0"

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E	2021.01.08	ADDENDUM #2

SHEET NAME:
AUDIO VISUAL RCP
LEVEL 1 - LOBBY

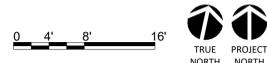DATE: 2020.12.16
CURRENT: 2021.01.08


ADDENDUM #2

SHEET:

AV-122

GMP SET

- NOTE:
1. PROVIDE CUSTOM TILE GRID FOR 24"X96" ACOUSTICAL CEILING TILE AS INDICATED ON THE ARCHITECTURAL DRAWINGS.
 2. PROVIDE ROUGH-IN KIT QSC ADMR6 FOR ALL SPEAKER LOCATIONS LOCATED IN AN INACCESSIBLE CEILING. VERIFY MAKE AND MODEL OF ROUGH IN KIT WITH ARCHITECT PRIOR TO INSTALLATION.
 3. SPEAKER IS N.I.C
 4. PROVIDE 1.0" CONDUIT PATHWAY BETWEEN CEILING SPEAKER LOCATIONS IN AN INACCESSIBLE CEILING.

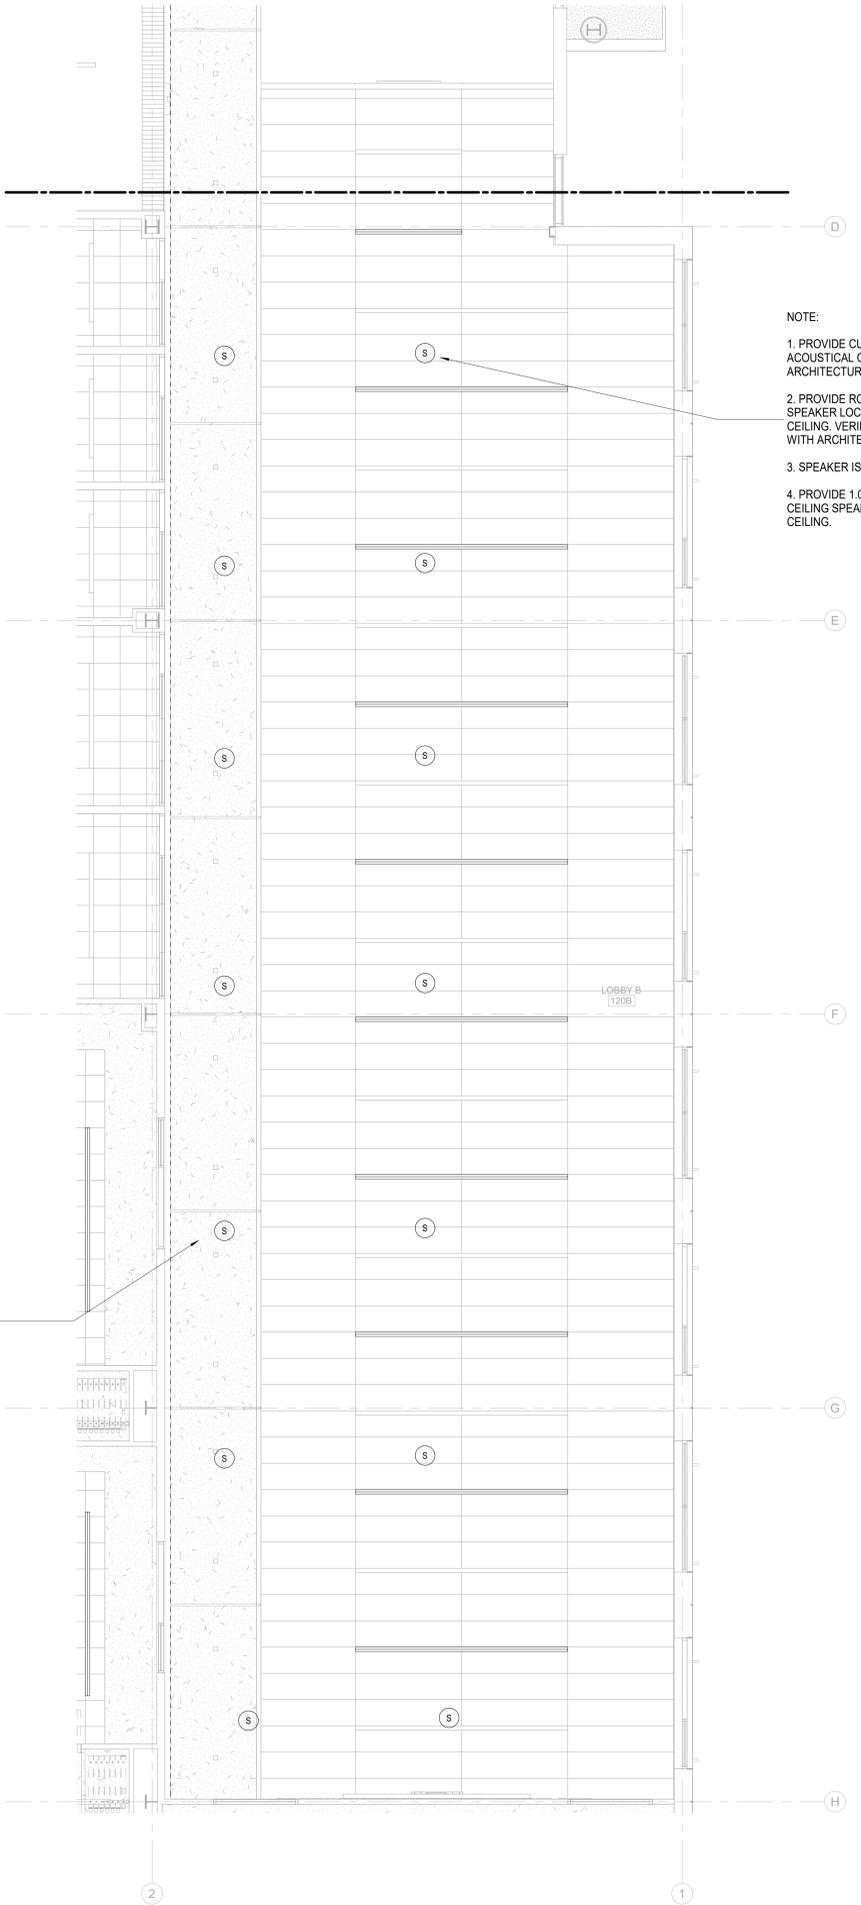


PROVIDE 1.25" CONDUIT FROM THIS LOCATION TO AV ROOM 151.

2 AV-122 AUDIO VISUAL LEVEL 1 LOBBY B 120B RCP DETAILS

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- NOTE:
1. PROVIDE CUSTOM TILE GRID FOR 48"X96" CEILING TILE SIZE AND TYPE AS INDICATED ON ARCHITECTURAL DRAWINGS.
 2. SPEAKER IS N.I.C
 3. PROVIDE ROUGH-IN KIT QSC AD-MR6 FOR ALL SPEAKER LOCATIONS LOCATED IN AN INACCESSIBLE CEILING. VERIFY MAKE AND MODEL OF ROUGH IN KIT WITH ARCHITECT PRIOR TO INSTALLATION.
 4. PROVIDE 1.0" CONDUIT PATHWAY BETWEEN CEILING SPEAKER LOCATIONS IN AN INACCESSIBLE CEILING.

PROVIDE 1.25" CONDUIT FROM THIS LOCATION TO THE AV ROOM 151.

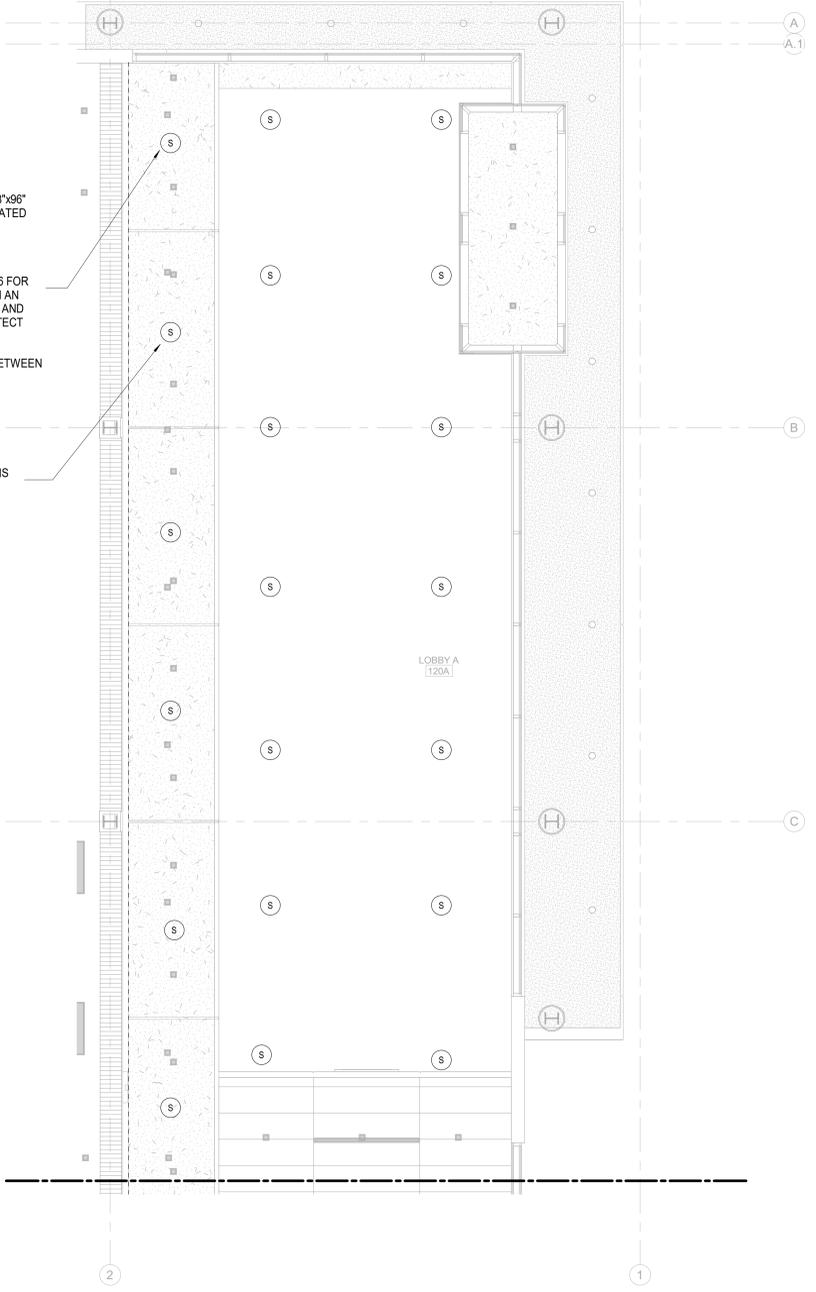

1 AV-122 AUDIO VISUAL LEVEL 1 LOBBY A 120A RCP DETAILS

3/16" = 1'-0"

3/16" = 1'-0"

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THE USER SHALL VERIFY ALL DIMENSIONS AND CONDITIONS PRIOR TO CONSTRUCTION.


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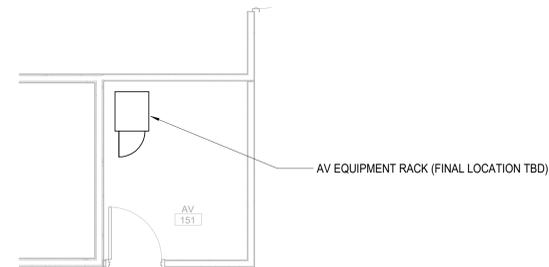
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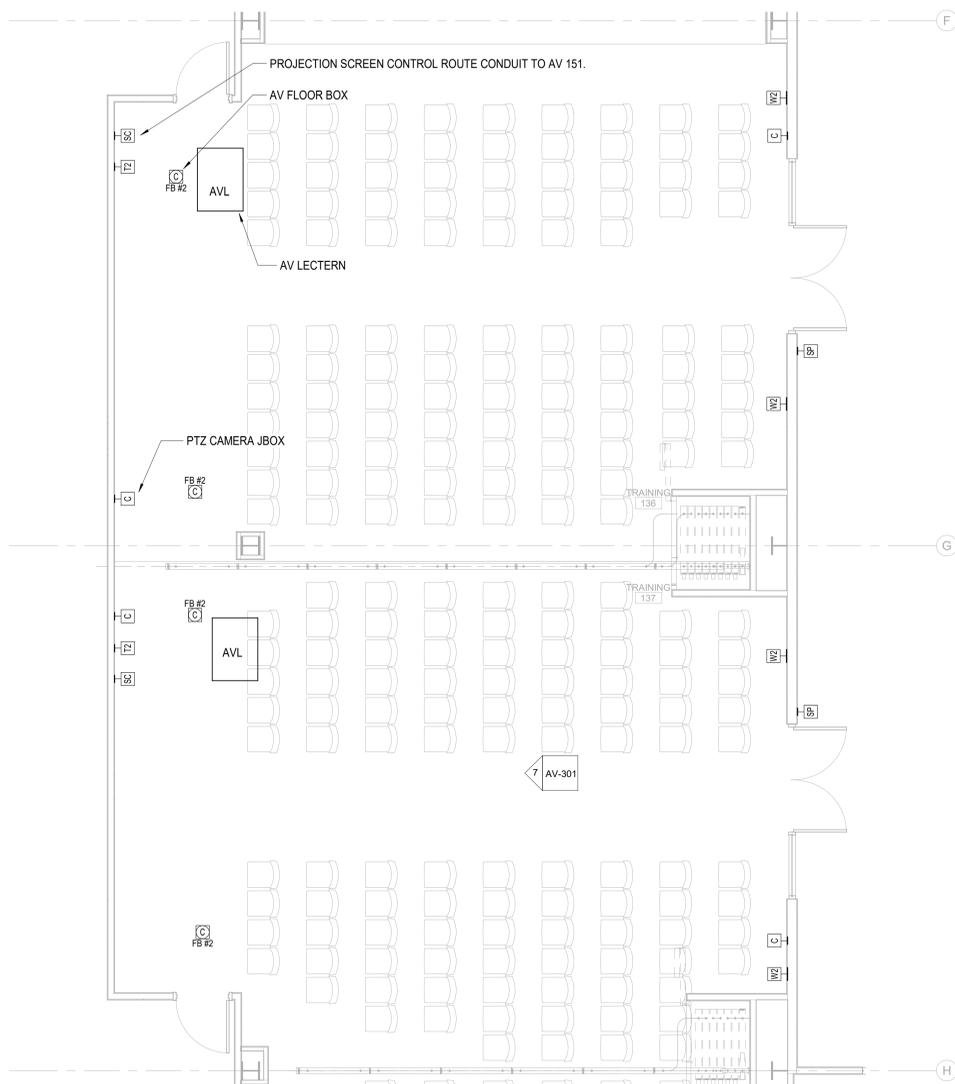
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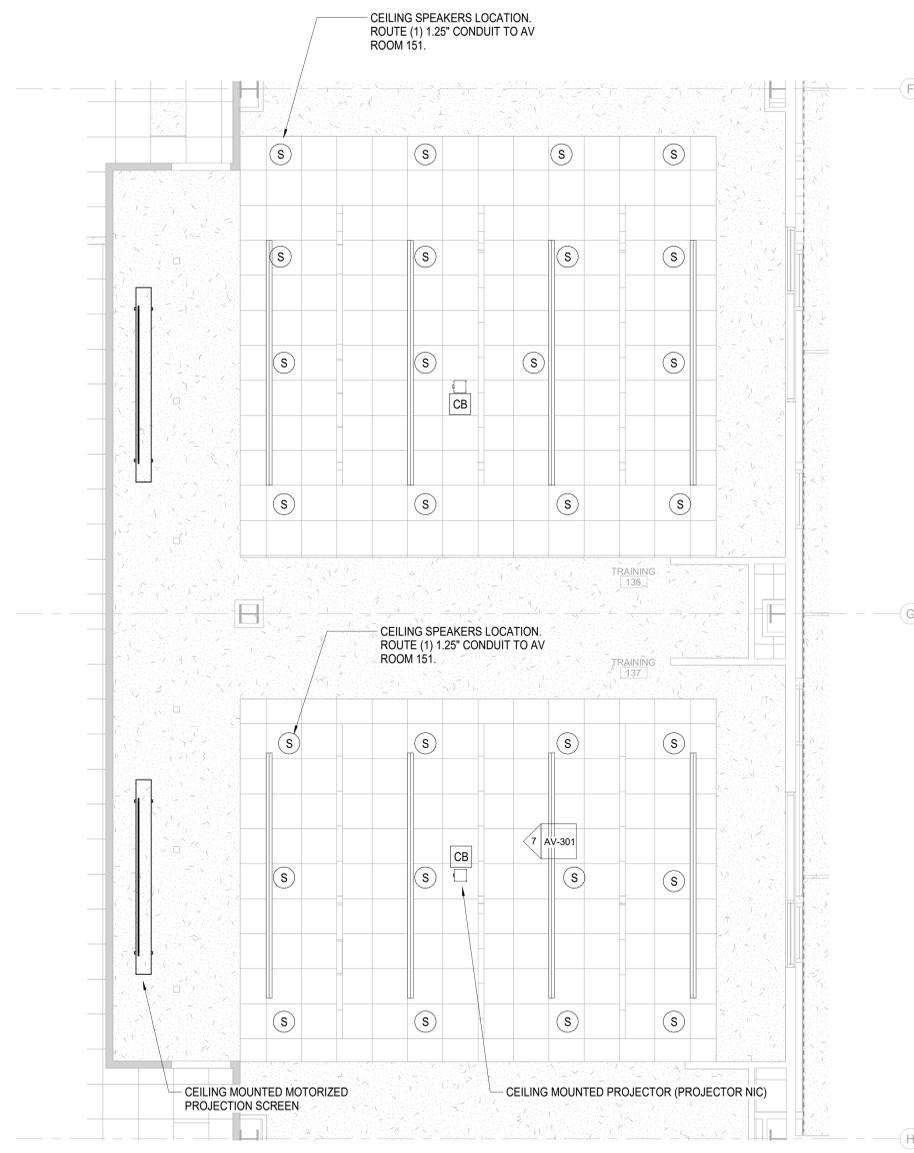
1 AV SERVER RM 145 - ENLARGED PLAN
AV-201/ 1/4" = 1'-0"



2 AV ROOM 151 - ENLARGED PLAN
AV-201/ 1/4" = 1'-0"



3 AV TRAINING ROOM(S) 136/137 - ENLARGED PLAN
AV-201/ 1/4" = 1'-0"

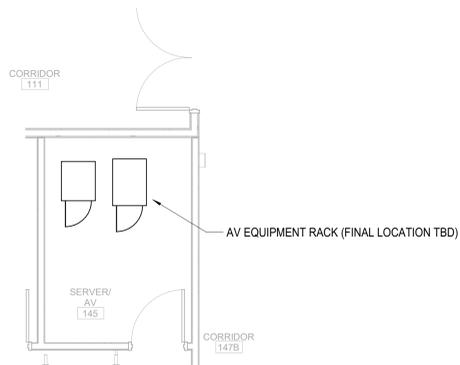

4 AV TRAINING ROOM(S) 136/137 - ENLARGED RCP PLAN
AV-201/ 1/4" = 1'-0"



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A	DATE	DESCRIPTION
A	2020.08.18	TI- SCHEMATIC DESIGN
B	2020.10.16	TI- DESIGN DEVELOPMENT
C	2020.12.16	GMP SET
E	2021.01.08	ADDENDUM #2

SHEET NAME:
AUDIO VISUAL
ENLARGED PLANS

DATE: 2020.12.16
CURRENT: 2021.01.08

ADDENDUM #2

SHEET:
AV-201

GMP SET

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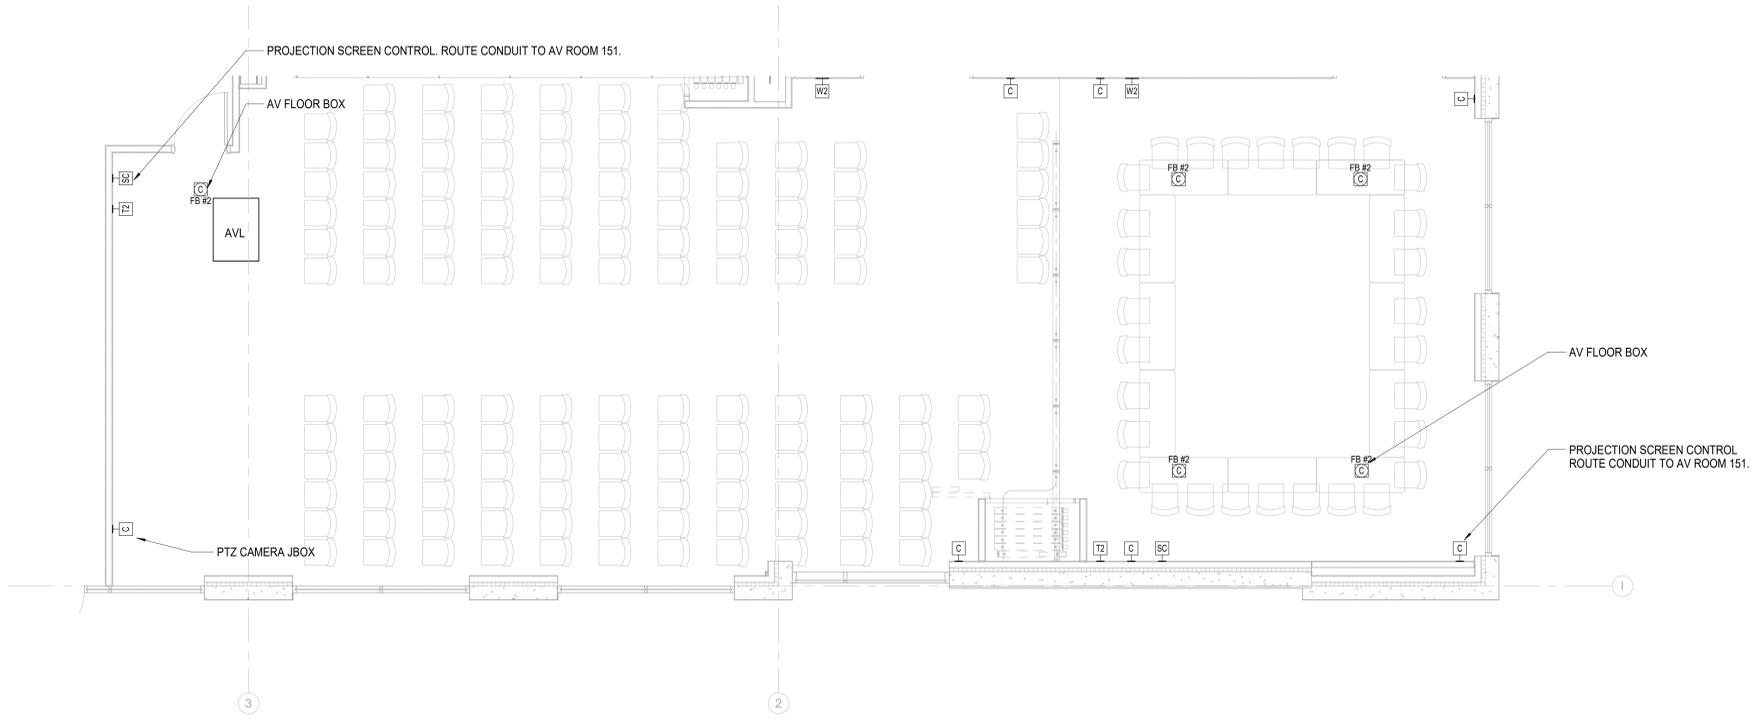
SHEET NAME:
AUDIO VISUAL
ENLARGED PLANS

DATE: 2020.12.16
CURRENT: 2021.01.08
ADDENDUM #2


SHEET:
AV-202

GMP SET

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N&B PROJECT: 19N342
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1 AV CONFERENCE ROOM(S) 138/139 - ENLARGED PLANS
AV-202 1/4" = 1'-0"



2 AV CONFERENCE ROOM(S) 138/139 - ENLARGED RCP PLANS
AV-202 1/4" = 1'-0"
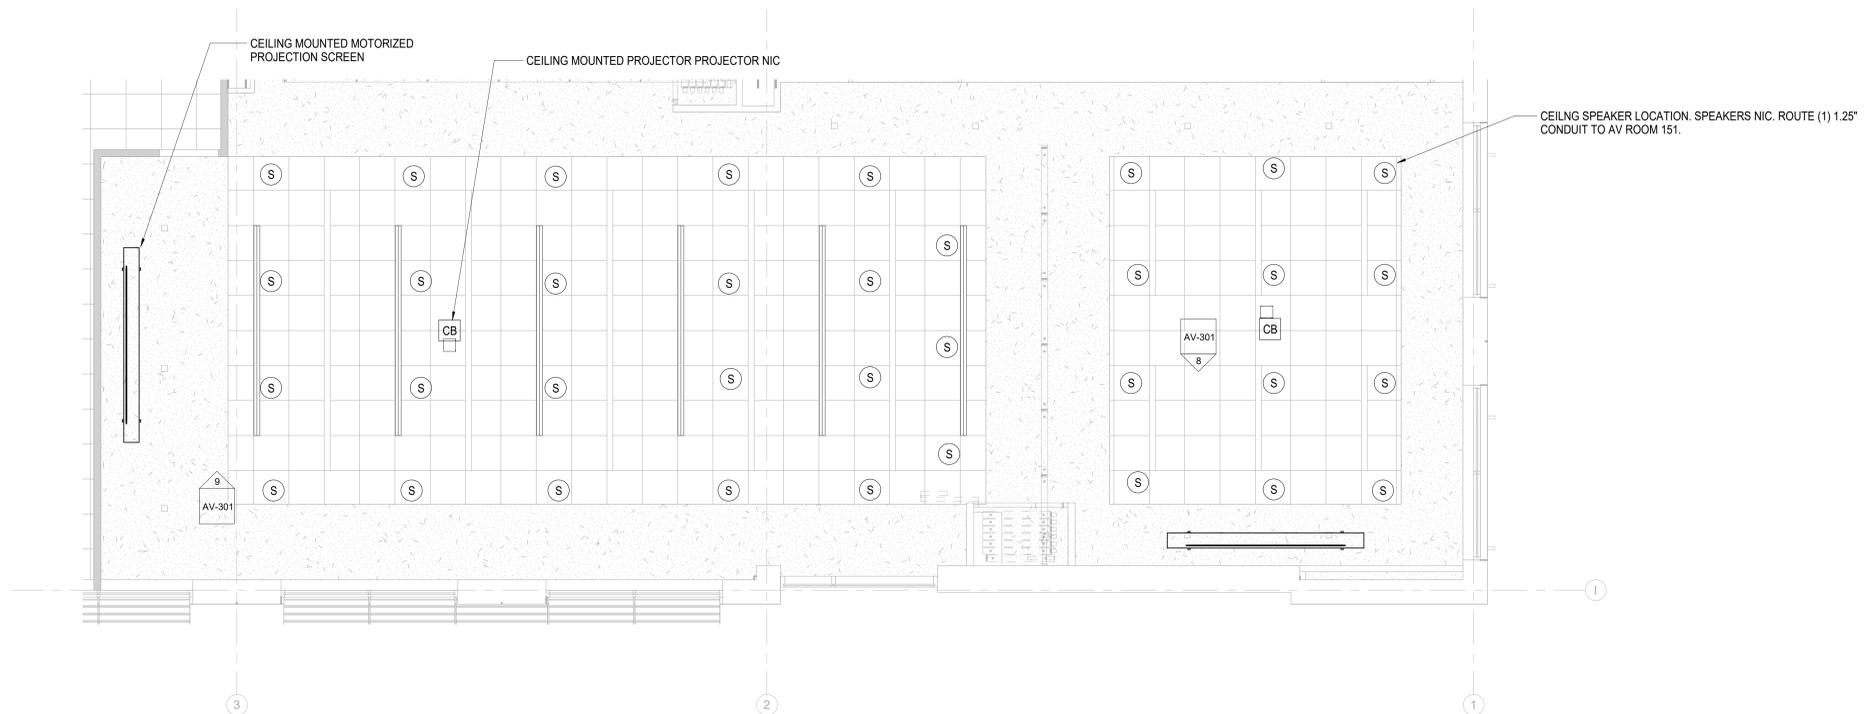
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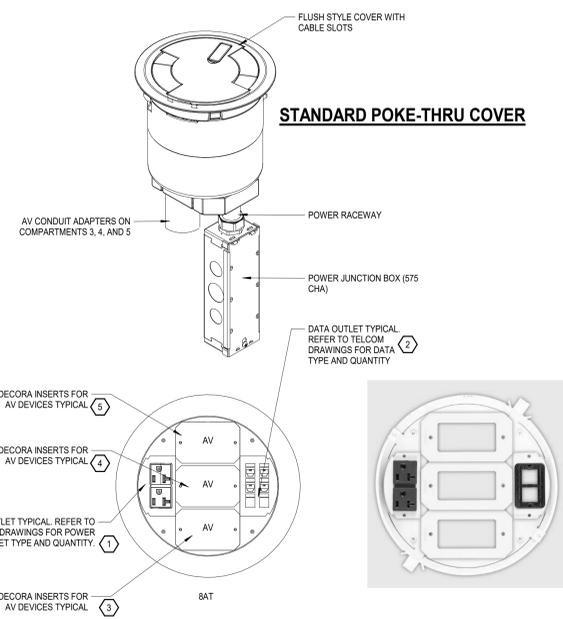
SHEET NAME:
AUDIO VISUAL
DETAILS

DATE: 2020.12.16
CURRENT: 2021.01.08


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SHEET: AV-401

GMP SET




- SELECTED CONDUIT ADAPTERS:**
- COMPARTMENT 1: 575CHA - BOTTOM HOUSING ASSEMBLY.
 - COMPARTMENT 2: 59THA - HALF-GANG PASS THROUGH HOUSING ASSEMBLY.
 - COMPARTMENT 3: 1125CHA - SINGLE COMPARTMENT 1 1/4" TRADE SIZE CONDUIT HOUSING ASSEMBLY.
 - COMPARTMENT 4 & 5: 1150CHA - DOUBLE COMPARTMENT 1 1/4" TRADE SIZE CONDUIT HOUSING ASSEMBLY.
- TYPE 1 CONDUIT ROUTING:**
- COMPARTMENT 1: TO ELECTRICAL PANEL. REFER TO ELECTRICAL DRAWINGS.
 - COMPARTMENT 2: REFER TO TELECOM DRAWINGS.
 - COMPARTMENT 3: 1.25" CONDUIT TO NEAREST CABLE TRAY.
 - COMPARTMENT 4 & 5: 1.25" CONDUIT TO TV# BOX IN SAME ROOM AS POKE THROUGH.
- TYPE 2 CONDUIT ROUTING:**
- COMPARTMENT 1: TO ELECTRICAL PANEL. REFER TO ELECTRICAL DRAWINGS.
 - COMPARTMENT 2: REFER TO TELECOM DRAWINGS.
 - COMPARTMENT 3: 1.25" CONDUIT TO NEAREST CABLE TRAY.
 - COMPARTMENT 4 & 5: 1.25" CONDUIT TO NEAREST CABLE TRAY.

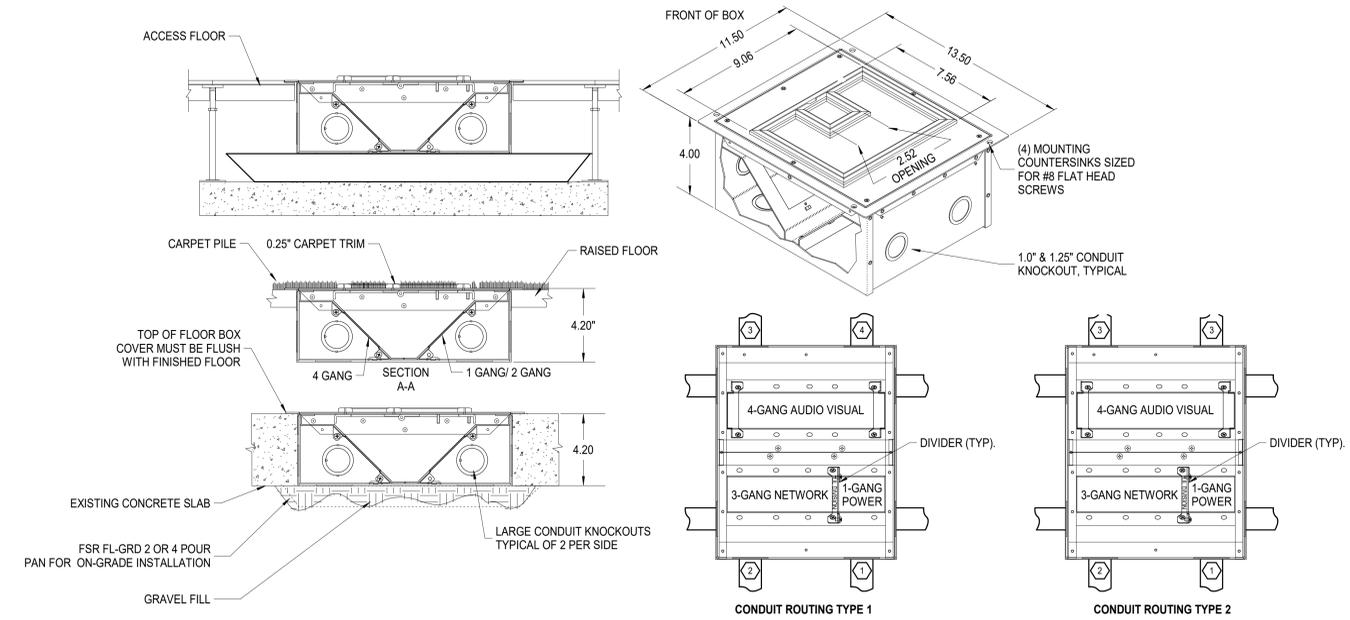

- NOTES (THIS DETAIL ONLY):**
- FLOOR BOX DIMENSIONS 10.0" (W) x 12.16" (L) x 4.0" (D).
 - FLOOR BOX HAS (8) CONDUIT KNOCKOUTS ON BOTTOM.
 - ALL KNOCKOUTS ARE FOR 0.75", 1.0" OR 1.25" CONDUIT.
 - ALL FLOOR BOXES TO HAVE FLAT COVER.
 - PROVIDE SIGNAL "DIVIDERS" AS REQUIRED.
 - BASIS OF DESIGN:
FOR RAISED FLOORS: FSR-FL540P
FOR SLAB ON GRADE: FSR-FL500P
- NOTE:**
FOLLOW MANUFACTURER'S INSTALLATION INSTRUCTIONS.
- CONDUIT ROUTING TYPE 1:**
- 1 TO ELECTRICAL PANEL. REFER TO ELECTRICAL DRAWINGS.
 - 2 TO DATA CLOSET. REFER TO TELECOM DRAWINGS.
 - 3 1.25" CONDUIT FOR AV TO NEAREST CABLE TRAY.
 - 4 1.25" CONDUIT TO TV# BOX IN SAME ROOM.
- CONDUIT ROUTING TYPE 2:**
- 1 TO ELECTRICAL PANEL. REFER TO ELECTRICAL DRAWINGS.
 - 2 TO DATA CLOSET. REFER TO TELECOM DRAWINGS.
 - 3 1.25" CONDUIT FOR AV TO NEAREST CABLE TRAY.


1 AV-401 SHARED FLOOR BOX - FSR 500P-4 DETAILS NTS

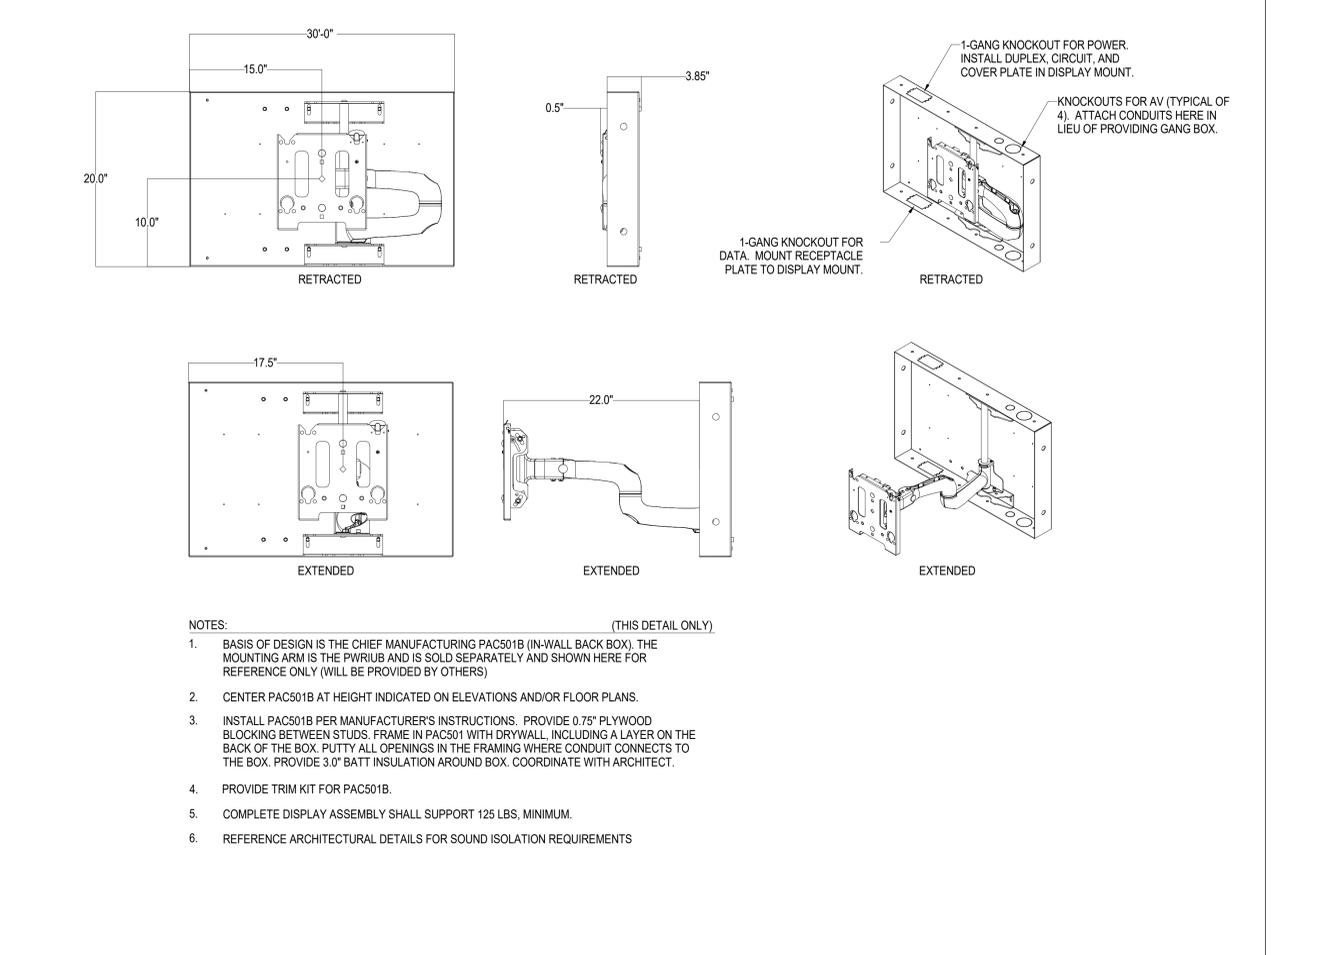

- NOTES:** (THIS DETAIL ONLY)
- BASIS OF DESIGN IS THE CHIEF MANUFACTURING PAC501B (IN-WALL BACK BOX). THE MOUNTING ARM IS THE PWRIUB AND IS SOLD SEPARATELY AND SHOWN HERE FOR REFERENCE ONLY (WILL BE PROVIDED BY OTHERS).
 - CENTER PAC501B AT HEIGHT INDICATED ON ELEVATIONS AND/OR FLOOR PLANS.
 - INSTALL PAC501B PER MANUFACTURER'S INSTRUCTIONS. PROVIDE 0.75" PLYWOOD BLOCKING BETWEEN STUDS. FRAME IN PAC501 WITH DRYWALL, INCLUDING A LAYER ON THE BACK OF THE BOX. PUTTY ALL OPENINGS IN THE FRAMING WHERE CONDUIT CONNECTS TO THE BOX. PROVIDE 3.0" BATTI INSULATION AROUND BOX. COORDINATE WITH ARCHITECT.
 - PROVIDE TRIM KIT FOR PAC501B.
 - COMPLETE DISPLAY ASSEMBLY SHALL SUPPORT 125 LBS. MINIMUM.
 - REFERENCE ARCHITECTURAL DETAILS FOR SOUND ISOLATION REQUIREMENTS.

3 AV-401 AV FLAT PANEL DISPLAY PAC501 MOUNT DETAILS NTS

2 AV-401 POKE-THRU WIREMOLD 8AT DETAILS NTS

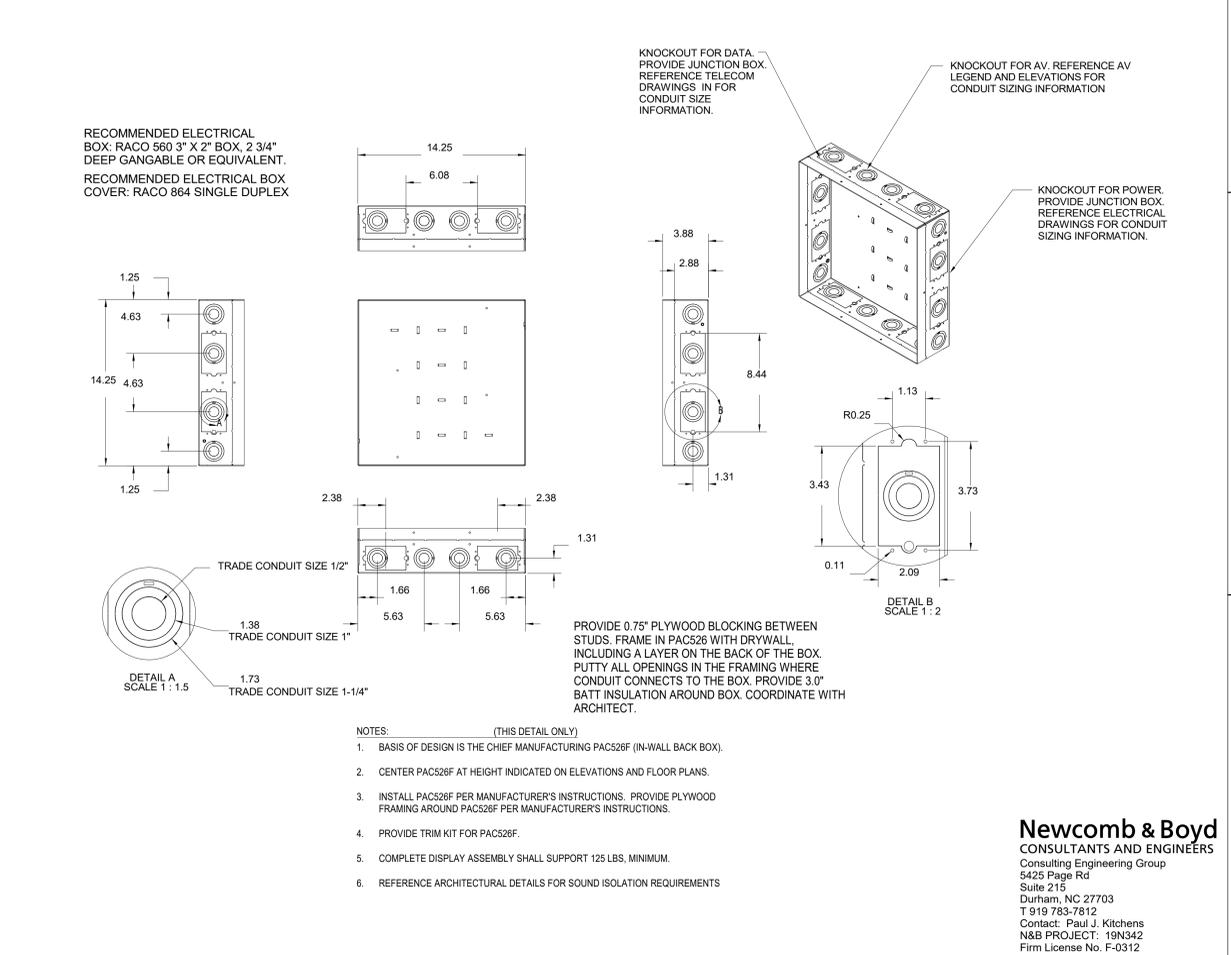

- RECOMMENDED ELECTRICAL BOX:** RACO 560 3" X 2" BOX, 2 3/4" DEEP GANGABLE OR EQUIVALENT.
RECOMMENDED ELECTRICAL BOX COVER: RACO 864 SINGLE DUPLEX
- TRADE CONDUIT SIZE 1/2"**
- TRADE CONDUIT SIZE 1"**
- TRADE CONDUIT SIZE 1-1/4"**
- NOTES:** (THIS DETAIL ONLY)
- BASIS OF DESIGN IS THE CHIEF MANUFACTURING PAC526F (IN-WALL BACK BOX).
 - CENTER PAC526F AT HEIGHT INDICATED ON ELEVATIONS AND FLOOR PLANS.
 - INSTALL PAC526F PER MANUFACTURER'S INSTRUCTIONS. PROVIDE PLYWOOD FRAMING AROUND PAC526F PER MANUFACTURER'S INSTRUCTIONS.
 - PROVIDE TRIM KIT FOR PAC526F.
 - COMPLETE DISPLAY ASSEMBLY SHALL SUPPORT 125 LBS. MINIMUM.
 - REFERENCE ARCHITECTURAL DETAILS FOR SOUND ISOLATION REQUIREMENTS.

4 AV-401 AV FLAT PANEL DISPLAY PAC526 MOUNT DETAIL NTS

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