

HAZARDOUS MATERIALS

THE BUILDING SURFACES MAY HAVE LEAD PAINT. ALL CONTRACTORS ARE REQUIRED TO COMPLY WITH OSHA REGULATIONS 29 CFR 1926.62 BY DEVELOPING A COMPLIANCE PLAN. THE PROJECT DOES NOT INCLUDE ABATEMENT OF ALL LEAD BASED TO LEAD CONTAINING PAINT IN THE BUILDING. WHERE NECESSARY, CONTRACTORS CAN USE GENERAL CONTRACTOR'S ENVIRONMENTAL CONTRACTOR TO REMEDIATE A SPOT OR LOCATION WHERE LEAD PAINT INTERFERES WITH CONSTRUCTION WORK. COST OF REMEDIATION WILL BE INVOICED AGAINST THE LEAD REMOVAL ALLOWANCE.

ALL ASBESTOS IS IDENTIFIED AND WILL BE ABATED AS PART OF THE PROJECT. ANY SUSPECTED AREAS MUST BE REPORTED TO THE ARCHITECT AND FURTHER INVESTIGATION WILL BE DONE BY THE ABATEMENT DESIGNER.

PENDER COUNTY
COURTHOUSE

PENDER COUNTY



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JOB # 19060



No.	Description	Date
1	Addendum No. 3	04-14-2020

PROJECT: 7702-185550
DATE: 3/29/20
DRAWN BY: XXXXX
CHECKED BY: M. CIARROCCA


ELECTRICAL-
SECOND
FLOOR
LIGHTING PLAN

E-113

BID DOCUMENTS

KEYED NOTES:

- 1 CONNECT TO LIGHTING CIRCUIT PREVIOUSLY SERVING SPACE.
- 2 FED FROM RECEPTACLE CIRCUIT IN THE ELEVATOR PIT. SEE E-101.
- 3 CONNECT EGRESS FIXTURE TO UN-SWITCHED LEG OF EXISTING ROOM CIRCUITRY.
- 4 EXISTING COMBO EXIT/EMERGENCY EXIT LIGHT.
- 5 EXISTING EXIT SIGN.
- 6 EXHAUST FAN WILL BE CONTROLLED BY NEW SWITCH LOCATED OUTSIDE CELL BLOCK. CONNECT EXHAUST FAN TO LIGHTING CIRCUIT SERVING SPACE.
- 7 CIRCUIT UNDER CABINET LIGHTS TO RECEPTACLE CIRCUIT IN SPACE.

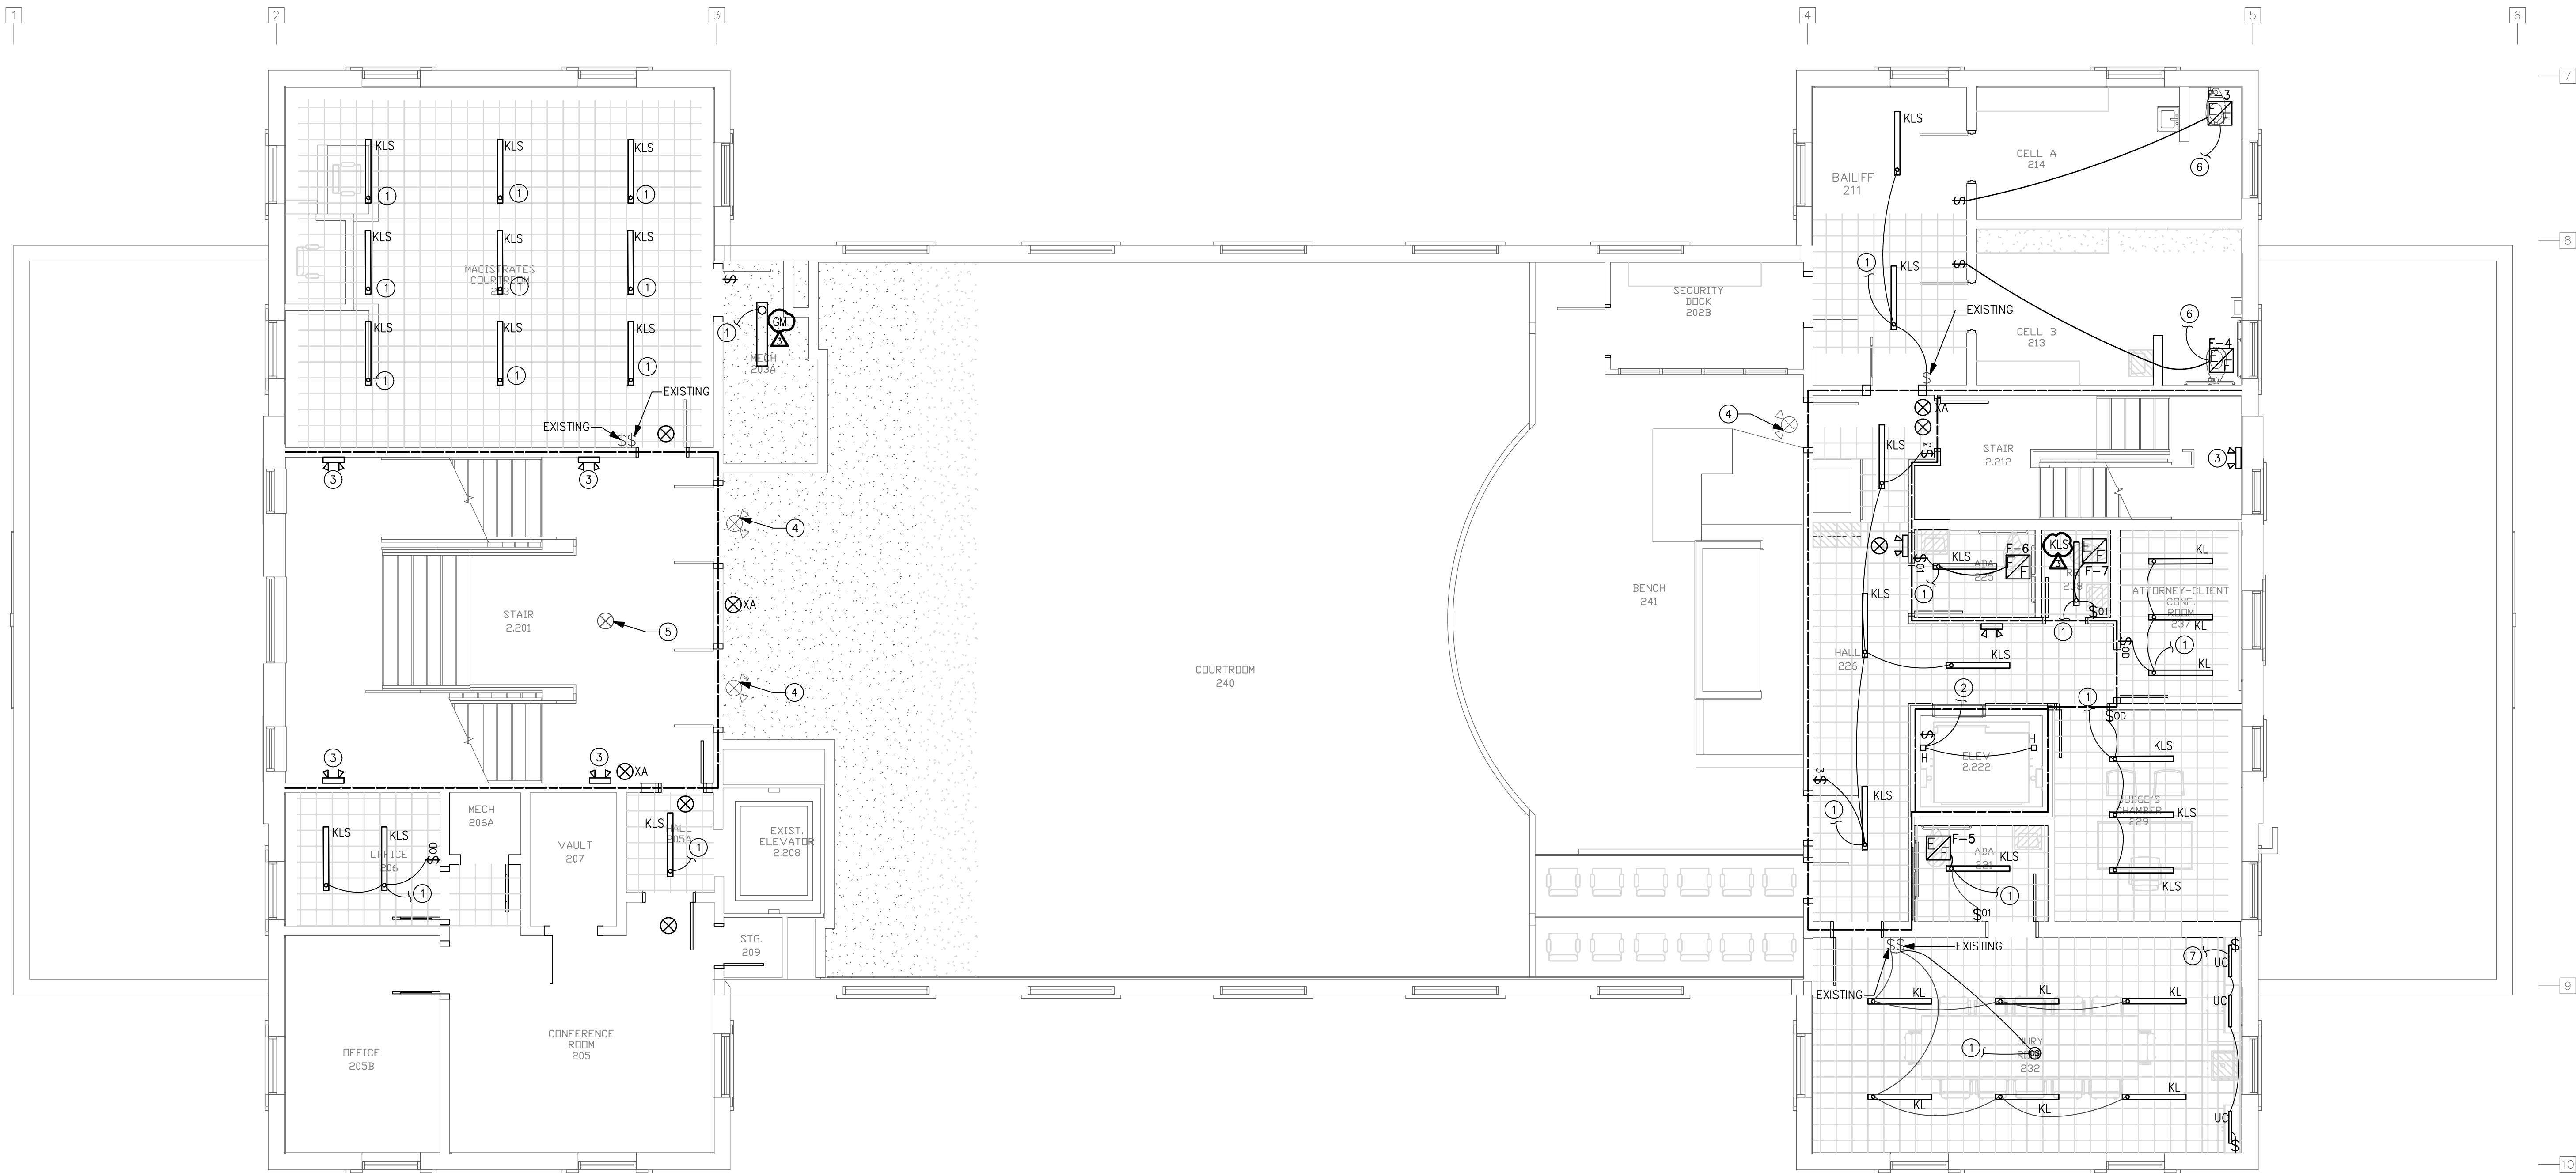

1 ELECTRICAL SECOND FLOOR LIGHTING PLAN
SCALE: 3/16" = 1'-0"

GRAPHIC SCALE: 3/16" = 1'-0"
0 2 4 8

